PROJECT NAME: NexusHaus LOCATION: Irvine, California OCCUPANCY: Residential CONSTRUCTION: Type V

THE UNIVERSITY OF

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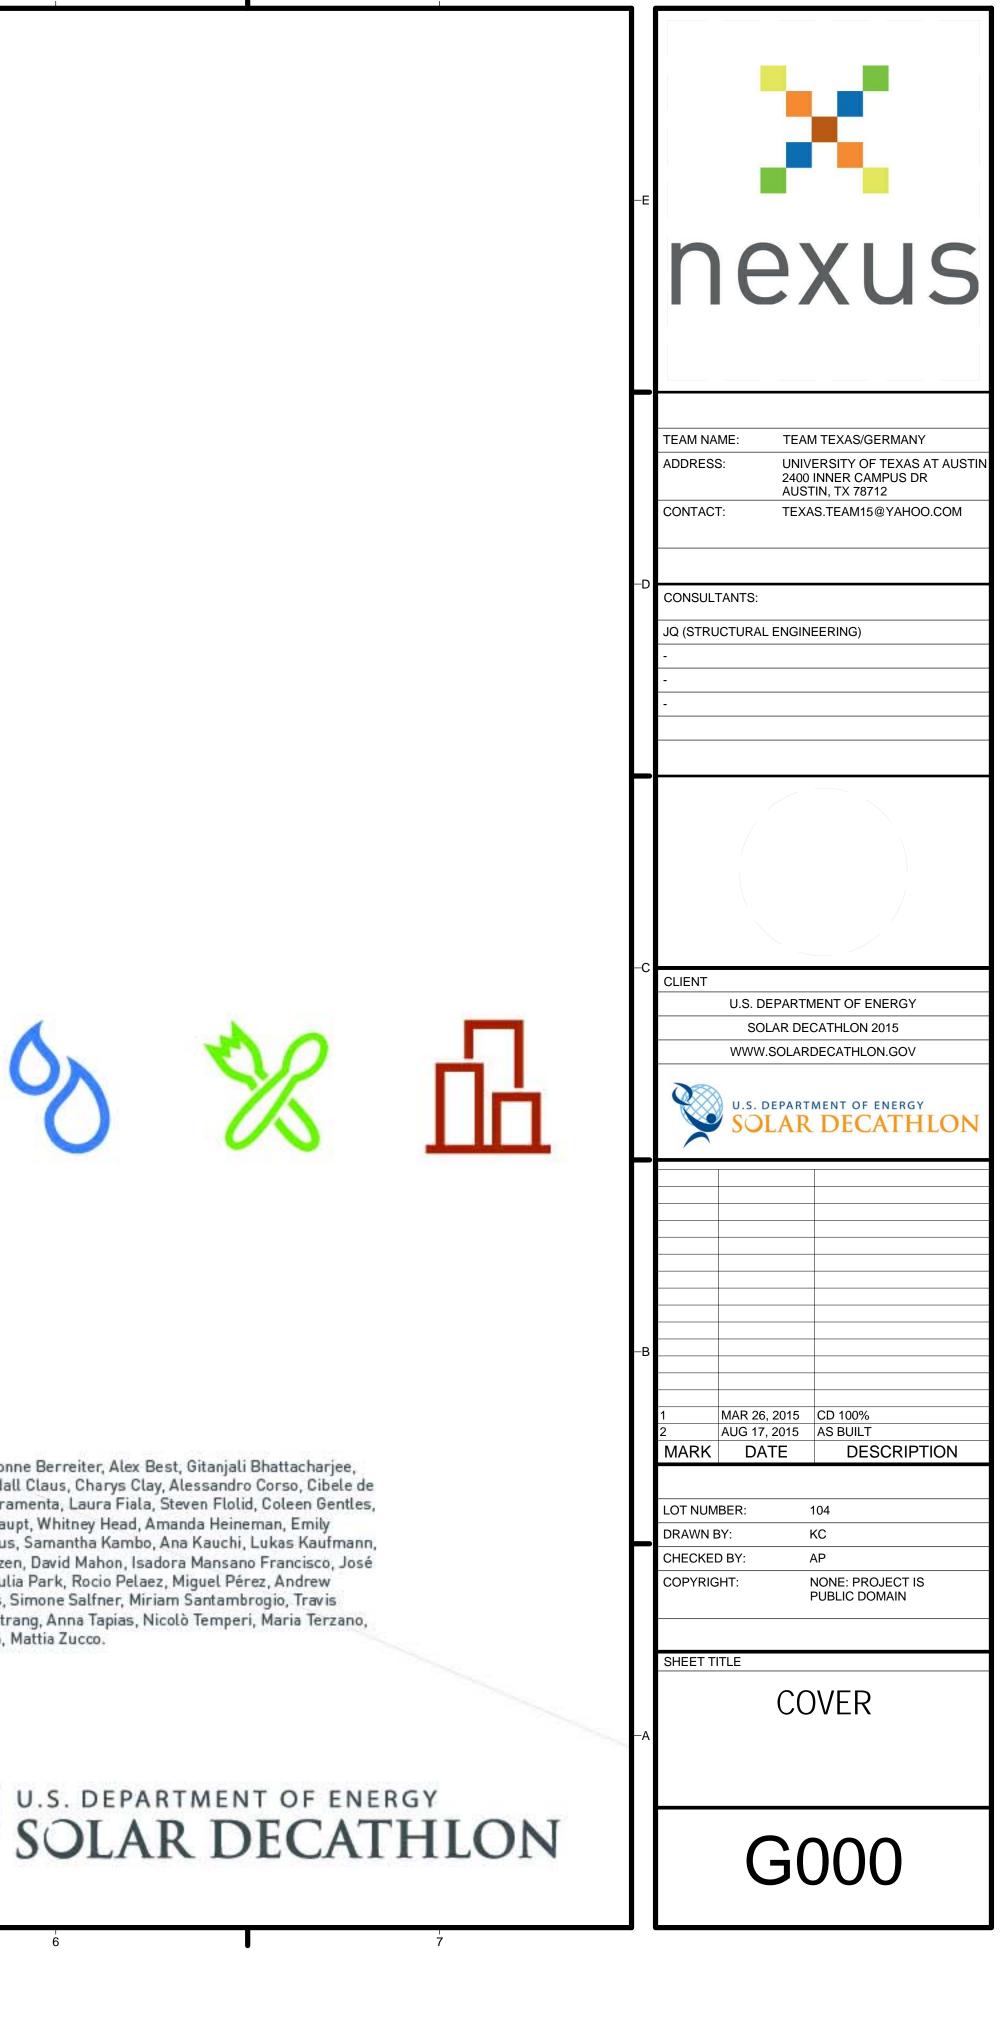
BUILDING TYPE: New Single Story Modular Home DESIGN TEAM: University of Texas at Austin + Technische Universität München

STUDENTS: Anthony Abousleiman, Leigh Ann, Moulay Anwar Sounny-Slitine, Yisvi Aroche, Holly Ashford, Zach Bakker, Bjorn Baudach, Jack Beadle, Charles Beckendorf, Kostas Belnanis, Sara Bensalem, Yvonne Berreiter, Alex Best, Gitanjali Bhattacharjee, Trond Bjarne Pettersen, Anna-Lea Boé, Chiara Bonsignori, Keslie Box, Zach Brown, Lori Broxton, Paloma Caballo, Ann Cai, Darren Cattle, Kristen Cetin, Aksornchan Chaianong, Yang Chen, Chi-Chih Chen, Kendall Claus, Charys Clay, Alessandro Corso, Cibele de Avila, Bruna De Ranieri Cavani Ferramenta, Cibele De Avila, Julian Debo, Sarah Dielenschneider, Christina Dotzler, Kathleen E Hetrick, Jeff Elliott, Irene Escudé Moreno, Astrid Eyskens, Trey Farmer, Bruna Ferramenta, Laura Fiala, Steven Flolid, Coleen Gentles, Luis Gerardo Camfos Alanis, Mira Gloser, Yenny Goss, Simon Gourley, Crystal Govea, Kelley Grabner, Kristina Grondahl, Alex Gross, Kaitlyn Gruener, Tess Haegele, Ariana Hallenbeck, Reese Hartridge, Claire Haupt, Whitney Head, Amanda Heineman, Emily Heitzwebel, Aaron Hobbins, Andrew Horne, Rongbo Hu, Caleb Hulsey, Jean-Baptiste Hurstel, Marta Ines Cot, Jessica Janzen, Cheng Jia, Kody Jones, Lauren Jones, Andreas Kacinari, Kelsey Kaiser, Caitlyn Kallus, Samantha Kambo, Ana Kauchi, Lukas Kaufmann, Daniel Kierdorf, Sara Kingman, Heidi Kleveland, Alexandra Krippner, Junji Kubo, Rachael Laughter, Ben Leiffheidt, Eneida Lila, Gabriela Lotuffo Olivera, Laura Louise Fiala, Rebecca Lynn Garner, Jessica M Janzen, David Mahon, Isadora Mansano Francisco, José Maria Arribas López, Jessica Martinez, Caitlin May, Ryan McKeeman, Molly McNamara, Thanos Metaxas, Sean Moore, Loren A Muirhead, Kerri Murphy, Vanessa O'Kelly, Frank Ordia, Ariel Padilla, Erica Pallo, Julia Park, Rocio Pelaez, Miguel Pérez, Andrew Philpott, Reece Poter, Abhishek Pratapa, Daniel Pyrek, Michael Rahmatoullin, David Rausch, Federico Rebecchini, Megan Recher, Elijah Reese, Joshue Rhodes, Bonnie Roberts, Rocio Romero Reolid, Haley Ross, Simone Salfner, Miriam Santambrogio, Travis Schneider, Max Seidl, Luca Sgubbi, Nishanth Shanmugham, Vivek Shastry, Josh Shen, Nari Shen, Alejandro Silveryra, Hayley Smith, Preethi Sreedhara, Kathleen Stanford, Alison Steele, Tyler Stewart, Marcus Strang, Anna Tapias, Nicolò Temperi, Maria Terzano, Coleman Tharpe, Andrea Tosi, Clemente Tudela Perdales, Kara Turner, Charles Upshaw, Miren Urena, Wolfgang Vidal, Mathew Watson, Henry Wen, Jordan Wennermark, Evyn Williams, Joann Xiao, Jingchen Yin, Mattia Zucco. FACULTY ADVISORS: Michael Garrison, Petra Liedl, Adam Pyrek, Werner Lang, Atila Novoselc

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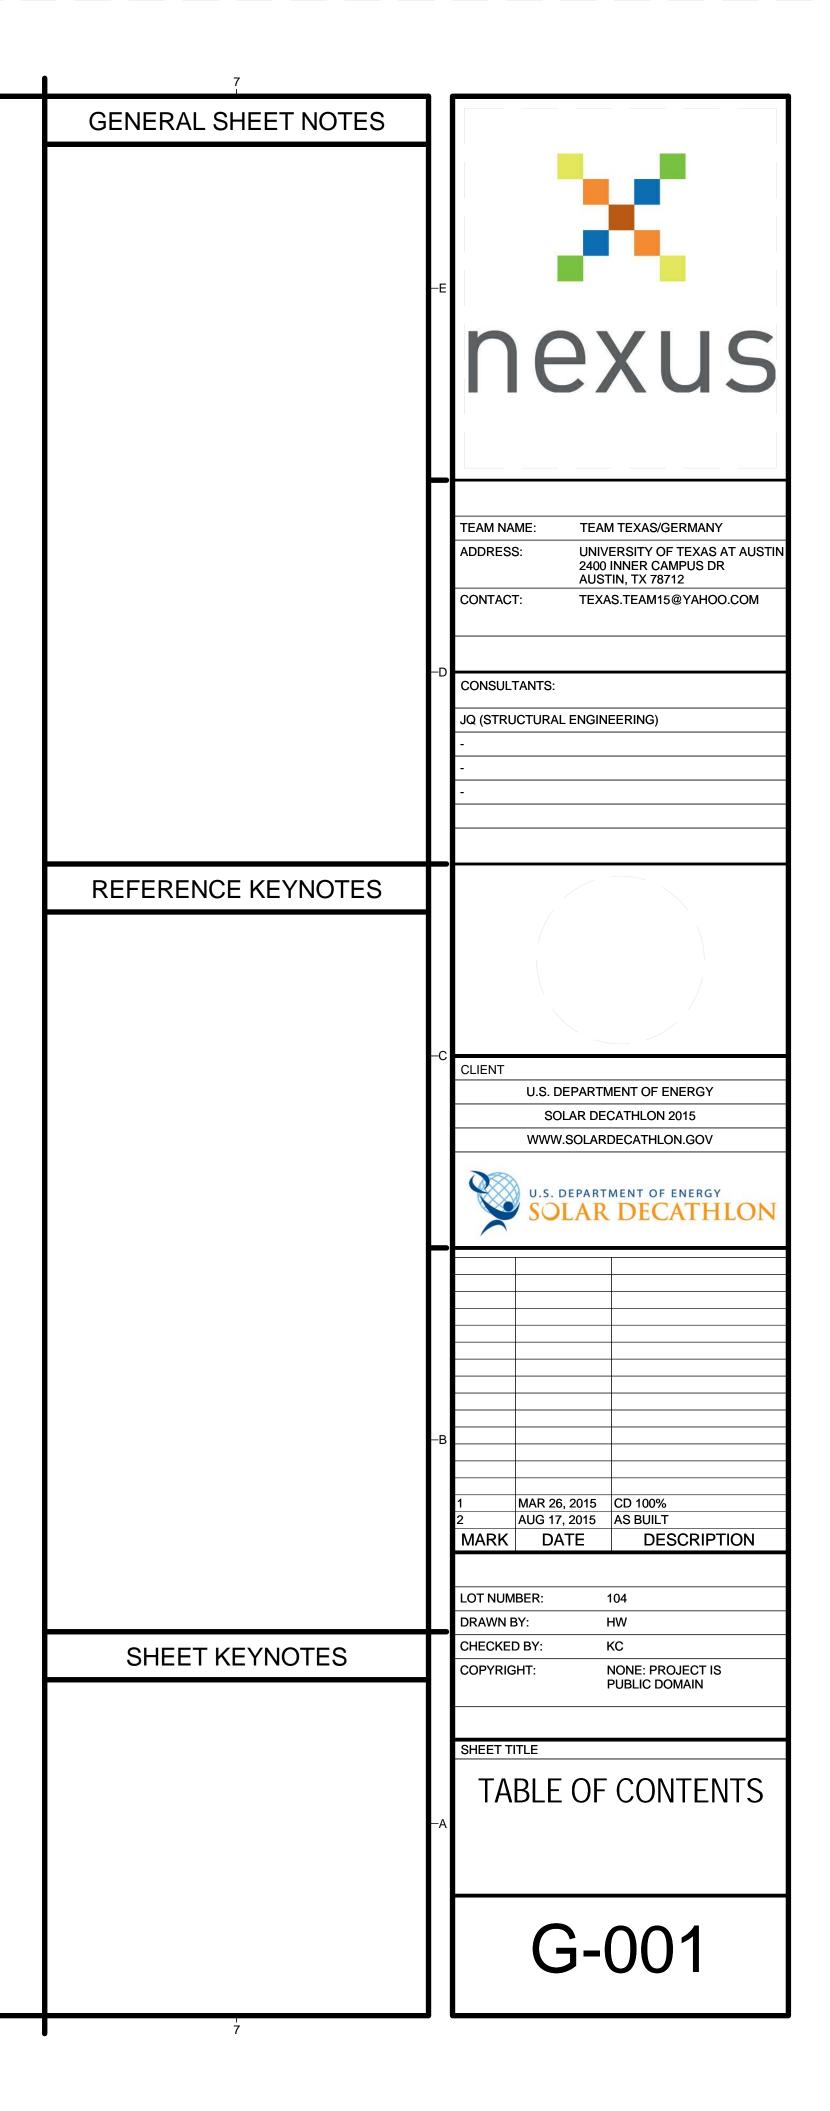




SHEET LIST				
SHT NO	SHEET NAME			
G000	COVER			
• • • • •				
G-001	TABLE OF CONTENTS			
G-002	GENERAL NOTES AND SYMBOLS			
G-101	FINISHED SQUARE FOOTAGE COMPLIANCE PLAN			
G-102				
G-103 G-201	ADA TOUR ROUTE COMPLIANCE PLAN SOLAR ENVELOPE COMPLIANCE ELEVATIONS			
G-201 G-202	SOLAR ENVELOPE COMPLIANCE ELEVATIONS			
G-202	SOLAR ENVELOPE COPIVILIANCE ELEVATIONS			
C-101	EXISTING LOT CONDITION			
C-201	GROUND CONTACT PLAN			
C-202	CIVIL SITE PLAN			
1 000				
L-602	AQUAPONICS			
-	STRUCTURAL DRAWINGS ISSUED UNDER A SEPERATE PACKAG			
A-111	FIRST FLOOR PLAN			
A-112	ROOF PLAN			
A-201	SITE ELEVATIONS			
A-202	SITE ELEVATIONS			
A-211	ELEVATIONS			
A-212	ELEVATIONS			
A-301	BUILDING SECTIONS			
A-302	BUILDING SECTIONS			
A-311	WALL SECTIONS			
A-312	WALL SECTIONS			
A-313	WALL SECTIONS			
A-511	EXTERIOR DETAILS			
A-512	EXTERIOR DETAILS			
A-531	WINDOW DETAILS			
A-541	DOOR DETAILS			
A-601	SCHEDULES			
I-001	INTERIOR SYMBOLS AND NOTES			
I-101	INTERIORS PLAN			
I-103	REFLECTED CEILING PLAN			
I-201	INTERIOR ELEVATIONS			
I-202	INTERIOR ELEVATIONS			
I-203	INTERIOR ELEVATIONS			
I-204	INTERIOR ELEVATIONS			
I-401	ENLARGED PLANS			
I-601	INTERIOR DESIGN SCHEDULES			
F-101	FIRE DETECTION AND ALARM			
P-001	SUPPLY + DRAINAGE SIZING CALCULATIONS AND			
	ABBREVIATIONS			
P-002	PLUMBING SCHEDULES			
P-003	PLUMBING SCHEDULES			
P-101	PLUMBING SITE PLAN			
P-102	DOMESTIC SUPPLY			
P-103	GREYWATER PLAN			
P-104	BLACKWATER PLAN			
P-105	RAINWATER PLAN			
P-201				
P-203	PLUMBING SECTION SUPPLY			


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P-301	PLUMBING FLOW DIAGRAM		
M-001	MECHANICAL SYMBOLS AND SCHEDULES		
M-002	MECHANICAL SCHEDULES		
M-101	HVAC AIR DISTRIBUTION PLAN		
M-201	HYDRONIC PIPING PLAN		
M-301	MECHANICAL SYSTEM ISOMETRIC		
M-601	HVAC SCHEMATIC DIAGRAM		
M-802	SKID DETAIL		
E-001	ELECTRICAL SYMBOLS, ABBREVIATIONS, AND NOTES		
E-002	SCHEDULES		
E-101	ELECTRICAL DISTRIBUTION PLAN		
E-102	ELECTRICAL LIGHTING PLAN		
E-103	PV CALCULATIONS AND DIAGRAMS		
E-601	ONE-LINE DIAGRAM		
E-602	THREE-LINE DIAGRAM		
O-001	OPERATIONS SYMBOLS AND NOTES		
O-101	ARRIVAL SEQUENCE PLAN DAY 1		
O-102	ARRIVAL SEQUENCE PLAN DAY 2		
O-103	ARRIVAL SEQUENCE PLAN DAY 3		
O-104	ARRIVAL SEQUENCE PLANS DAYS 4,5,6,7		
O-201	DEPARTURE SEQUENCE PLAN DAY 1		
O-202	DEPARTURE SEQUENCE PLAN DAY 2		
O-203	DEPARTURE SEQUENCE PLAN DAY 3		
O-204	DEPARTURE SEQUENCE PLAN DAY 4		

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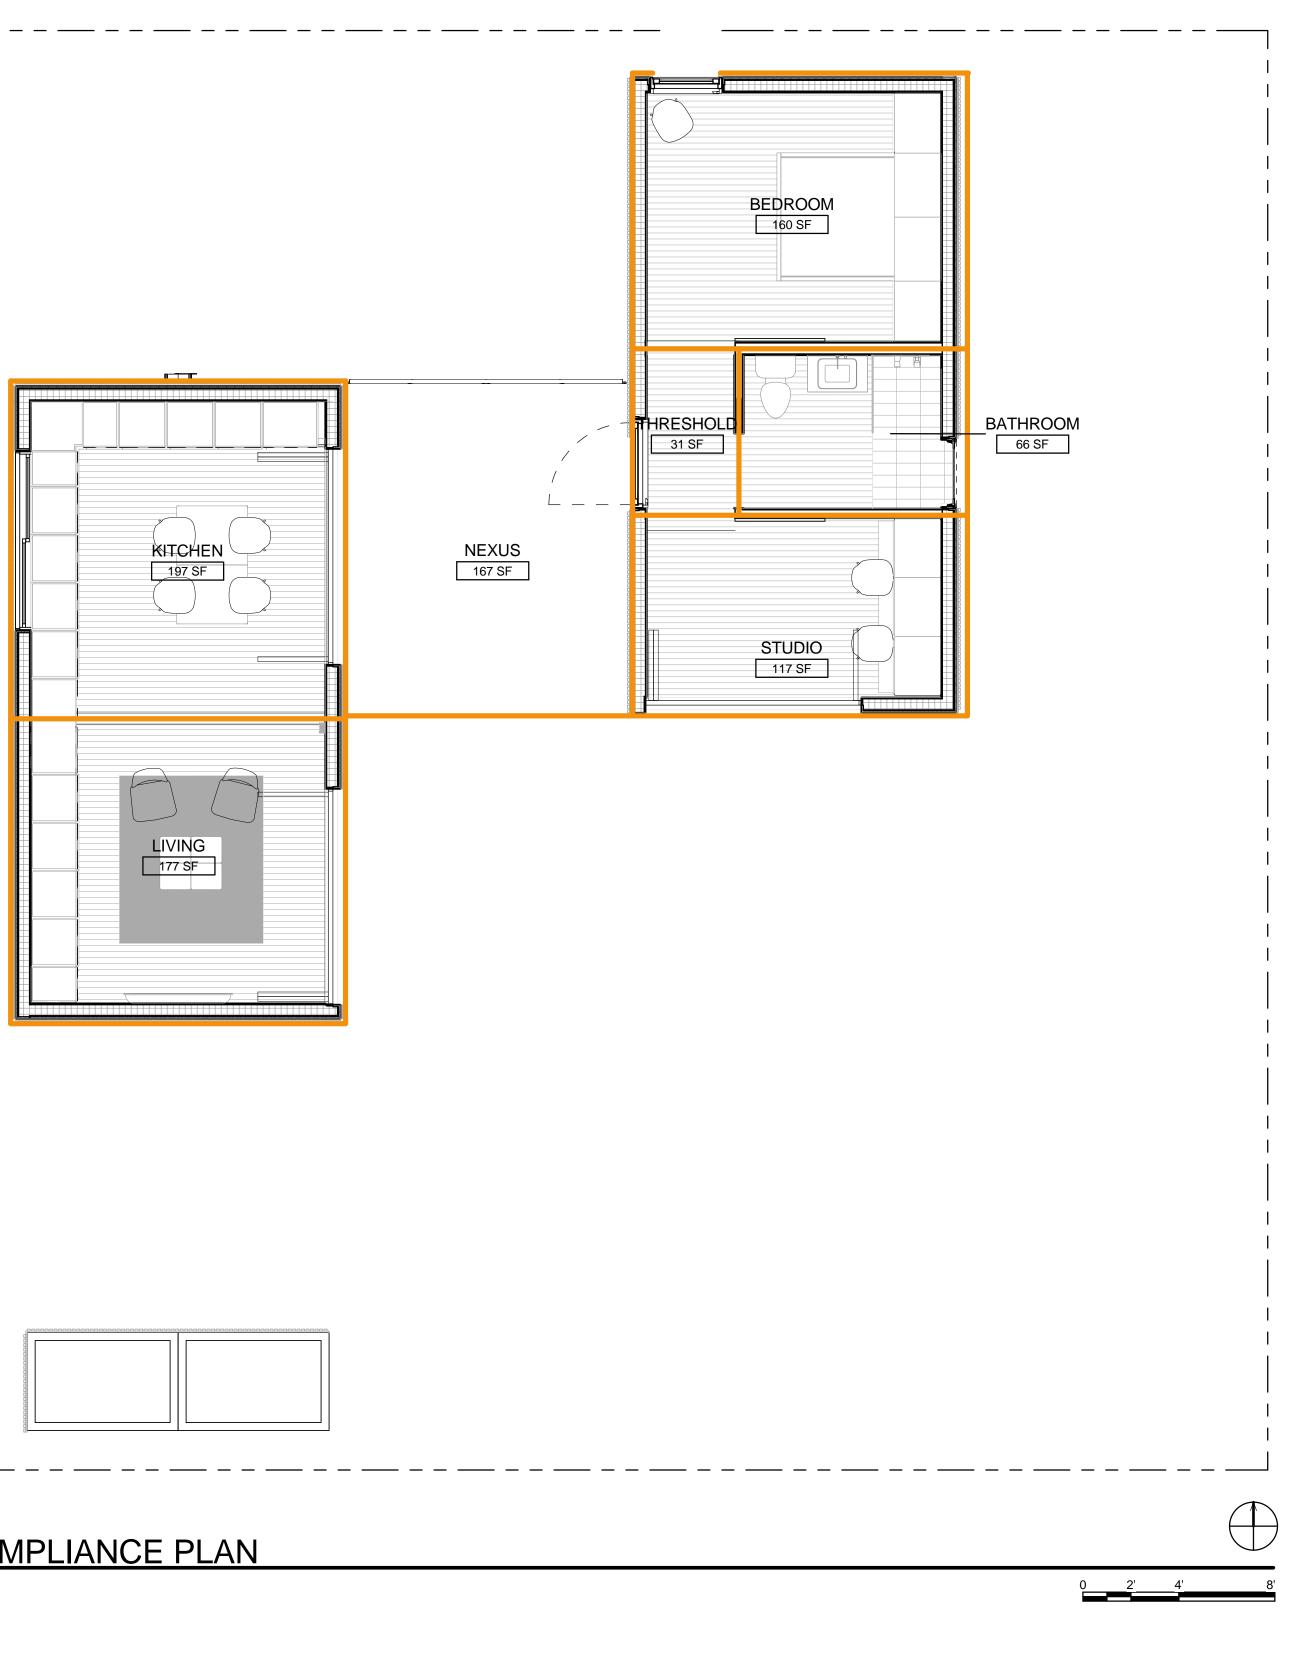
SY	MBOL LEGEND
MARK	DESCRIPTION
ROOM NAME 150 SF	AREA TAG
	BREAK TAG
1 A101 SIM	CALLOUT TAG
1i 1'-0" A.F.F.	CEILING TAG WITH HEIGHT
Ę_	CENTERLINE
5'-0" 卡	DIMENSION LINE
101	DOOR TAG
1 A101	EXTERIOR ELEVATION TAG
0 1' 2' 4'	GRAPHIC SCALE
0	GRID HEAD TAG
1 Ref	INTERIOR ELEVATION TAG
1 Ref	LEVEL HEAD TAG
	NORTH ARROW
	- PROPERTY LINE
	REVISION TAG
Room name	ROOM TAG
A4 A101	SECTION CUT TAG
	SOLAR ENEVELOPE LINE
•	SPOT ELEVATION
	TOUR ROUTE (MIN WIDTH 3'-0")
(1) View Name 1/8" = 1'-0"	VIEW TITLE
1L	WALL TAG
	WINDOW TAG
F	FIRE EXTINGUISHER


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AREA SCHEDULE					
Name	Number	Area	Percentage		
KITCHEN	1	197 SF	21%		
BEDROOM	2	160 SF	18%		
THRESHOLD	3	31 SF	3%		
BATHROOM	4	66 SF	7%		
STUDIO	5	117 SF	13%		
LIVING	6	177 SF	19%		
Area	7	Not Placed	0%		
NEXUS	10	167 SF	18%		
TOTAL SQ FO	OTAGE	915 SF			

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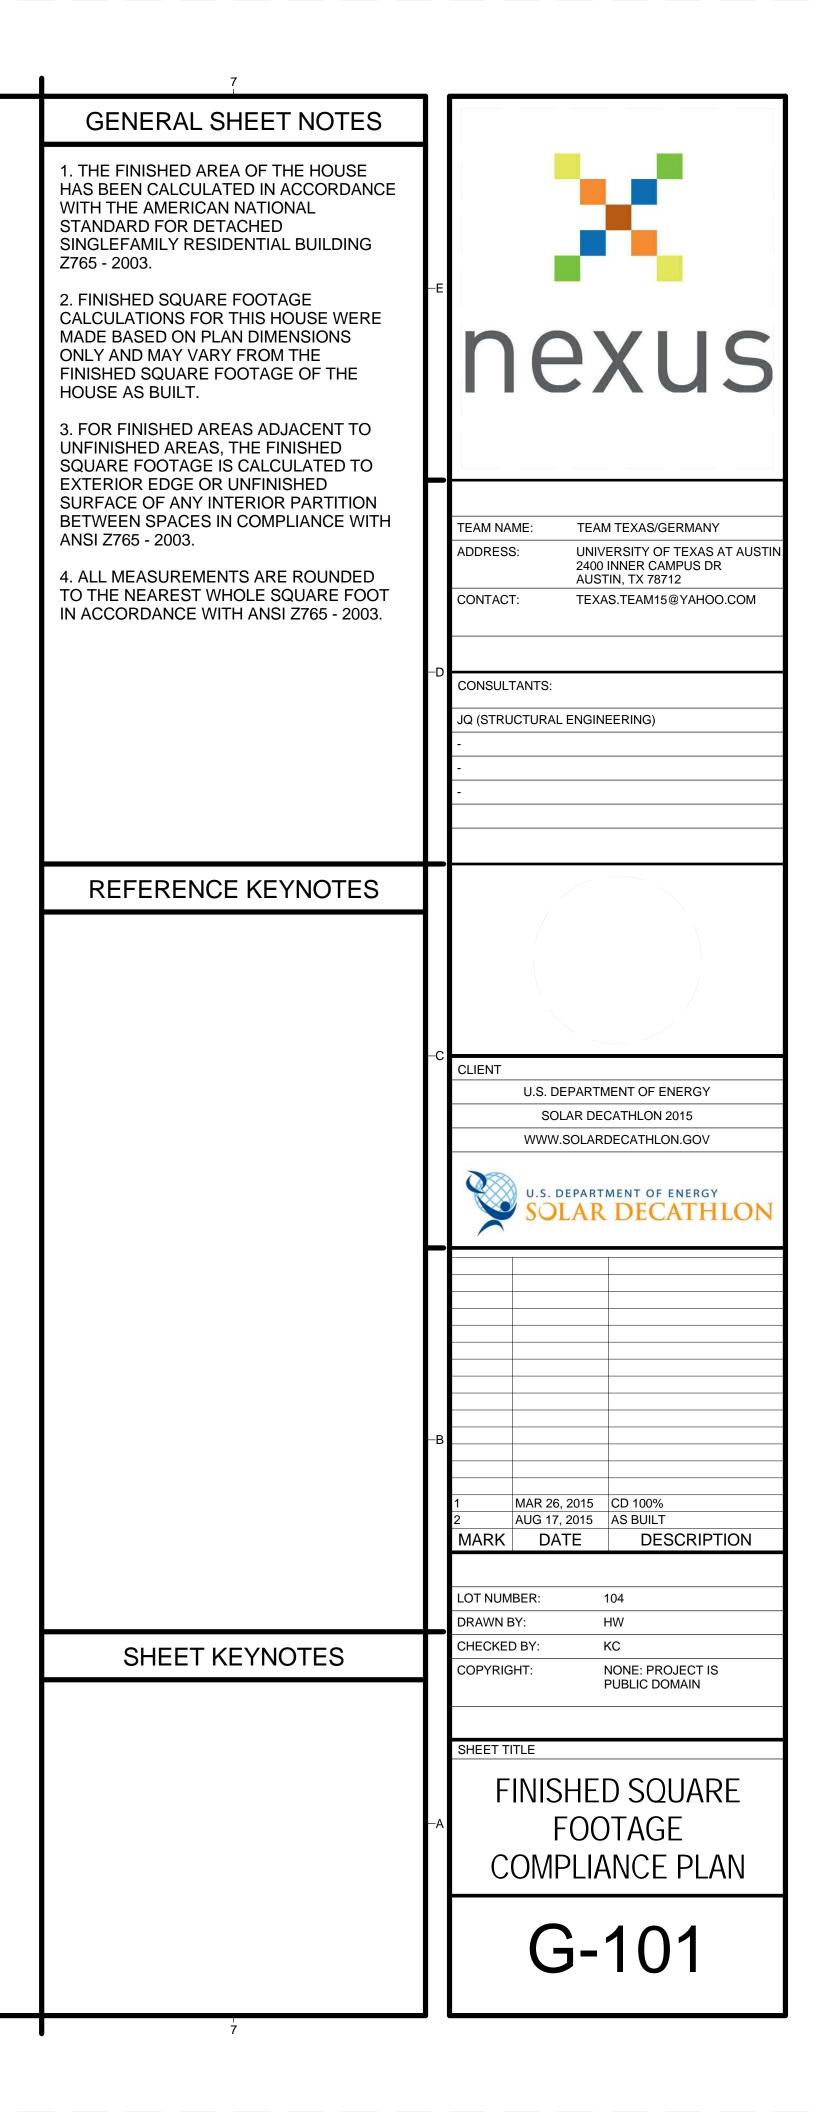


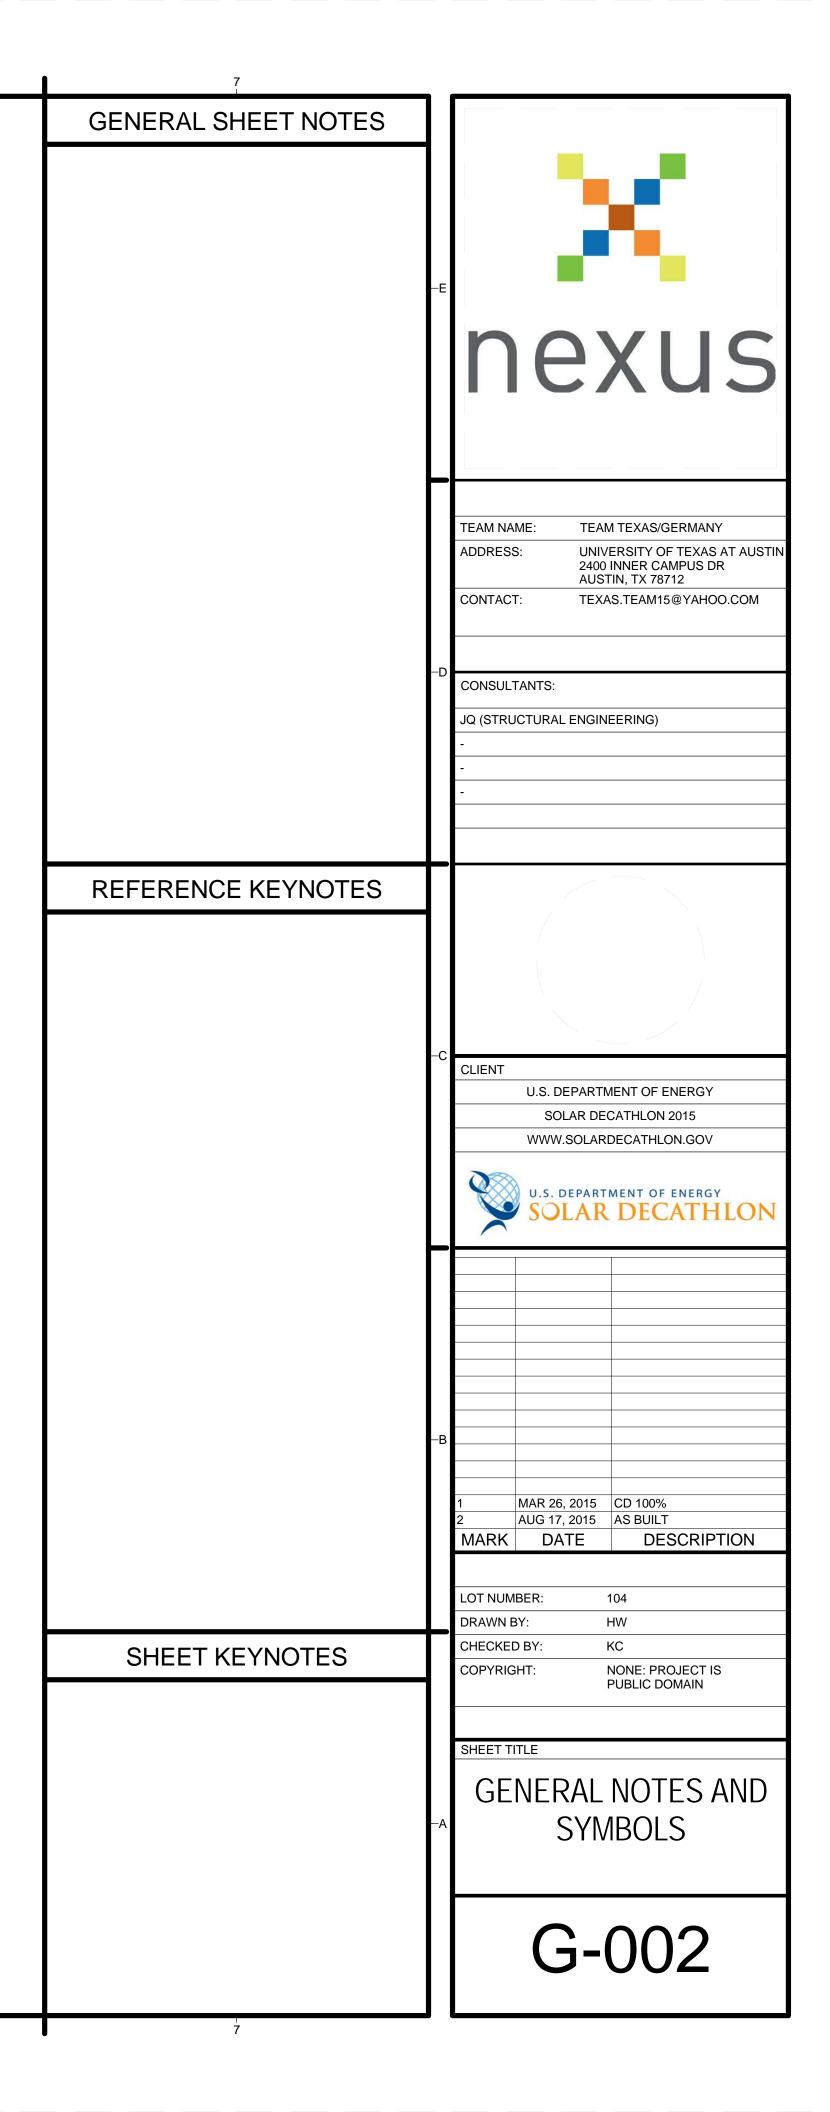



(A1) FINISHED SQUARE FOOTAGE COMPLIANCE PLAN


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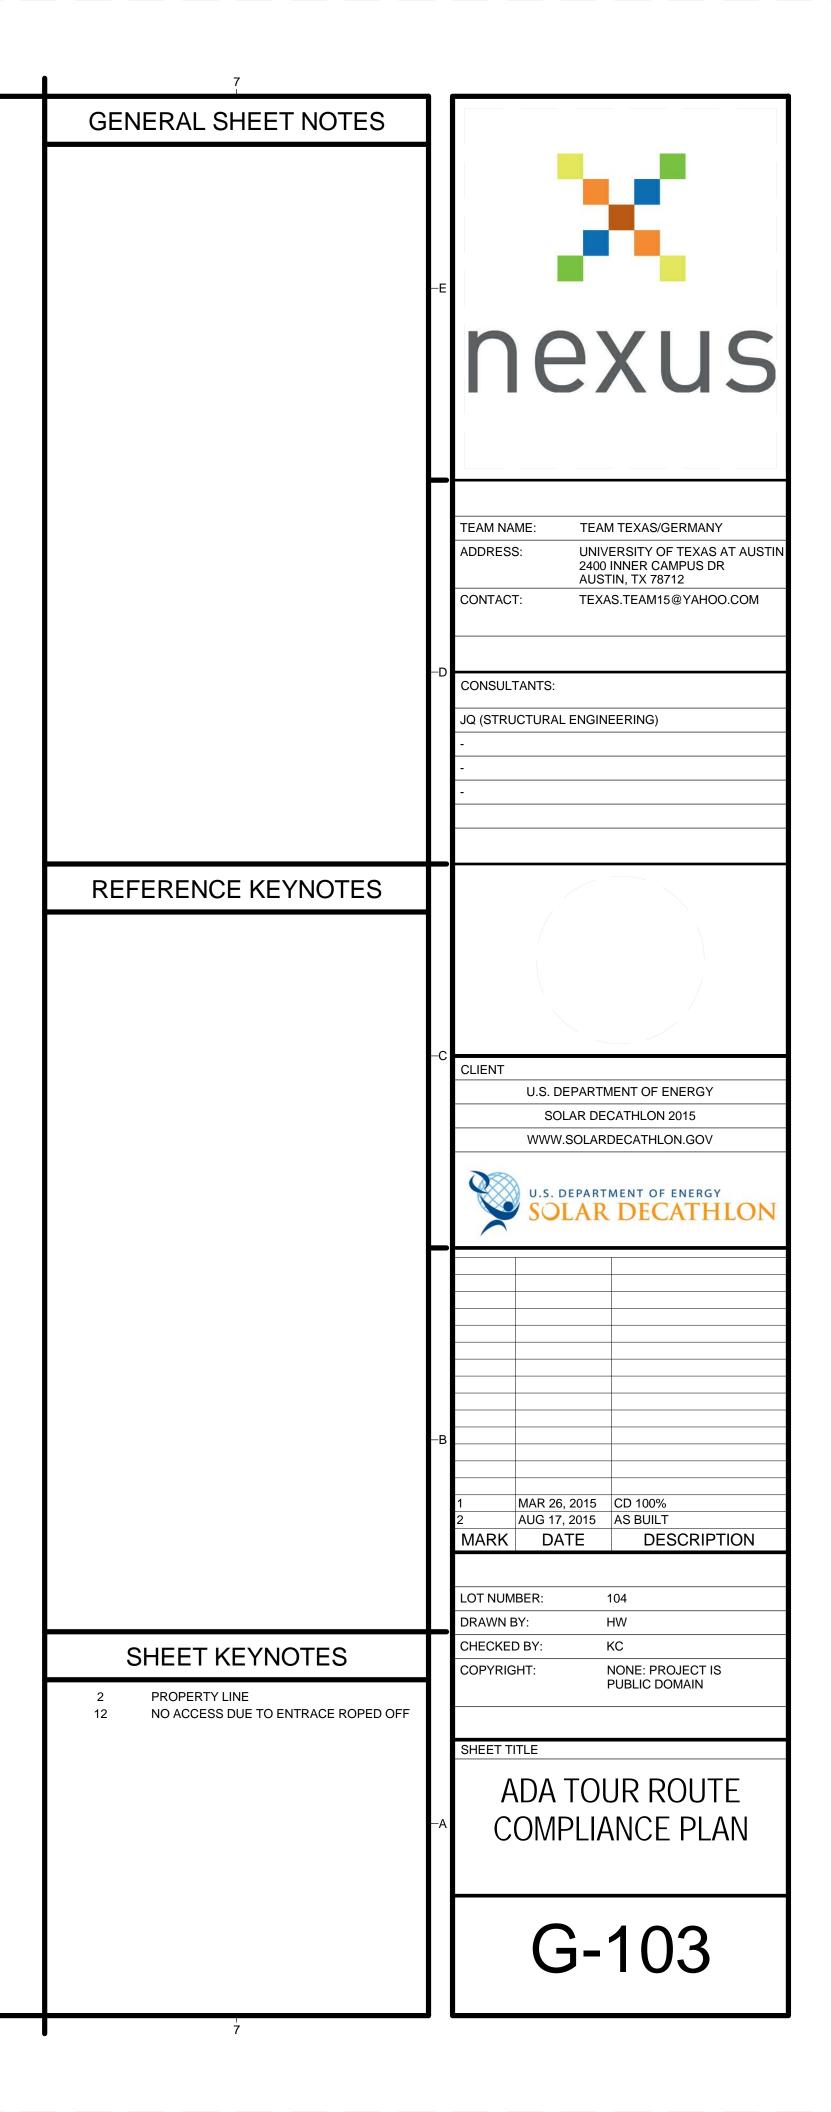
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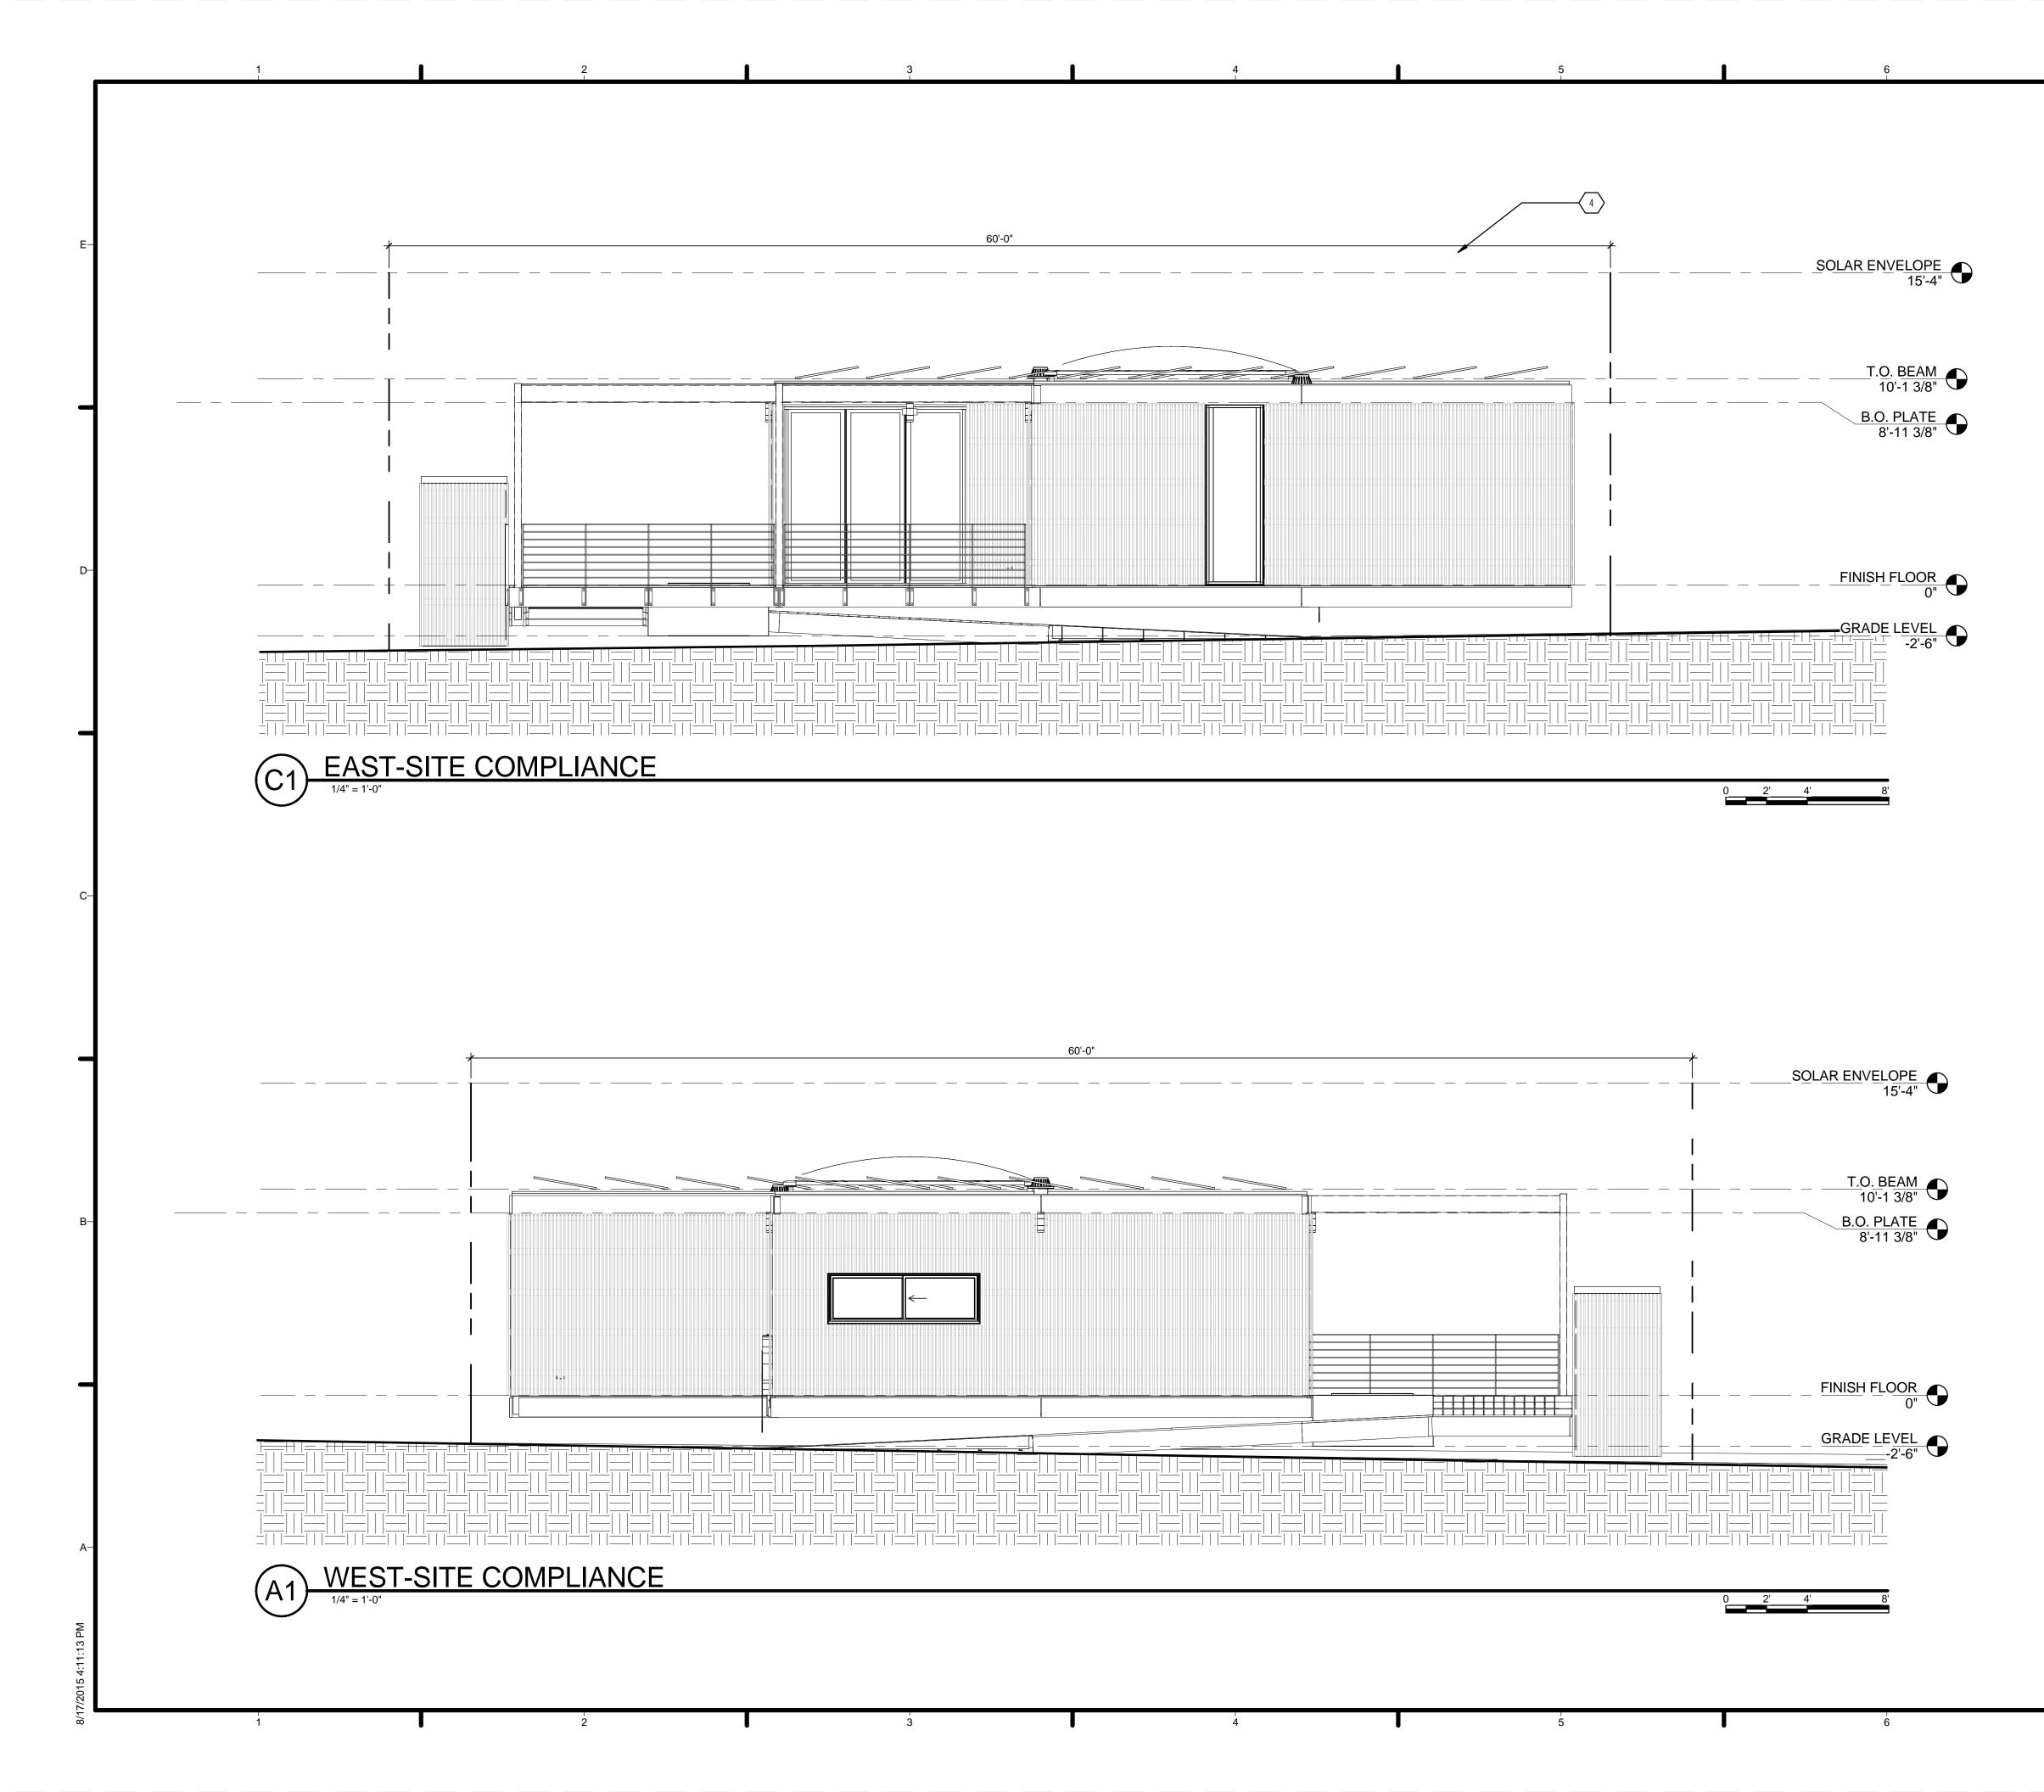


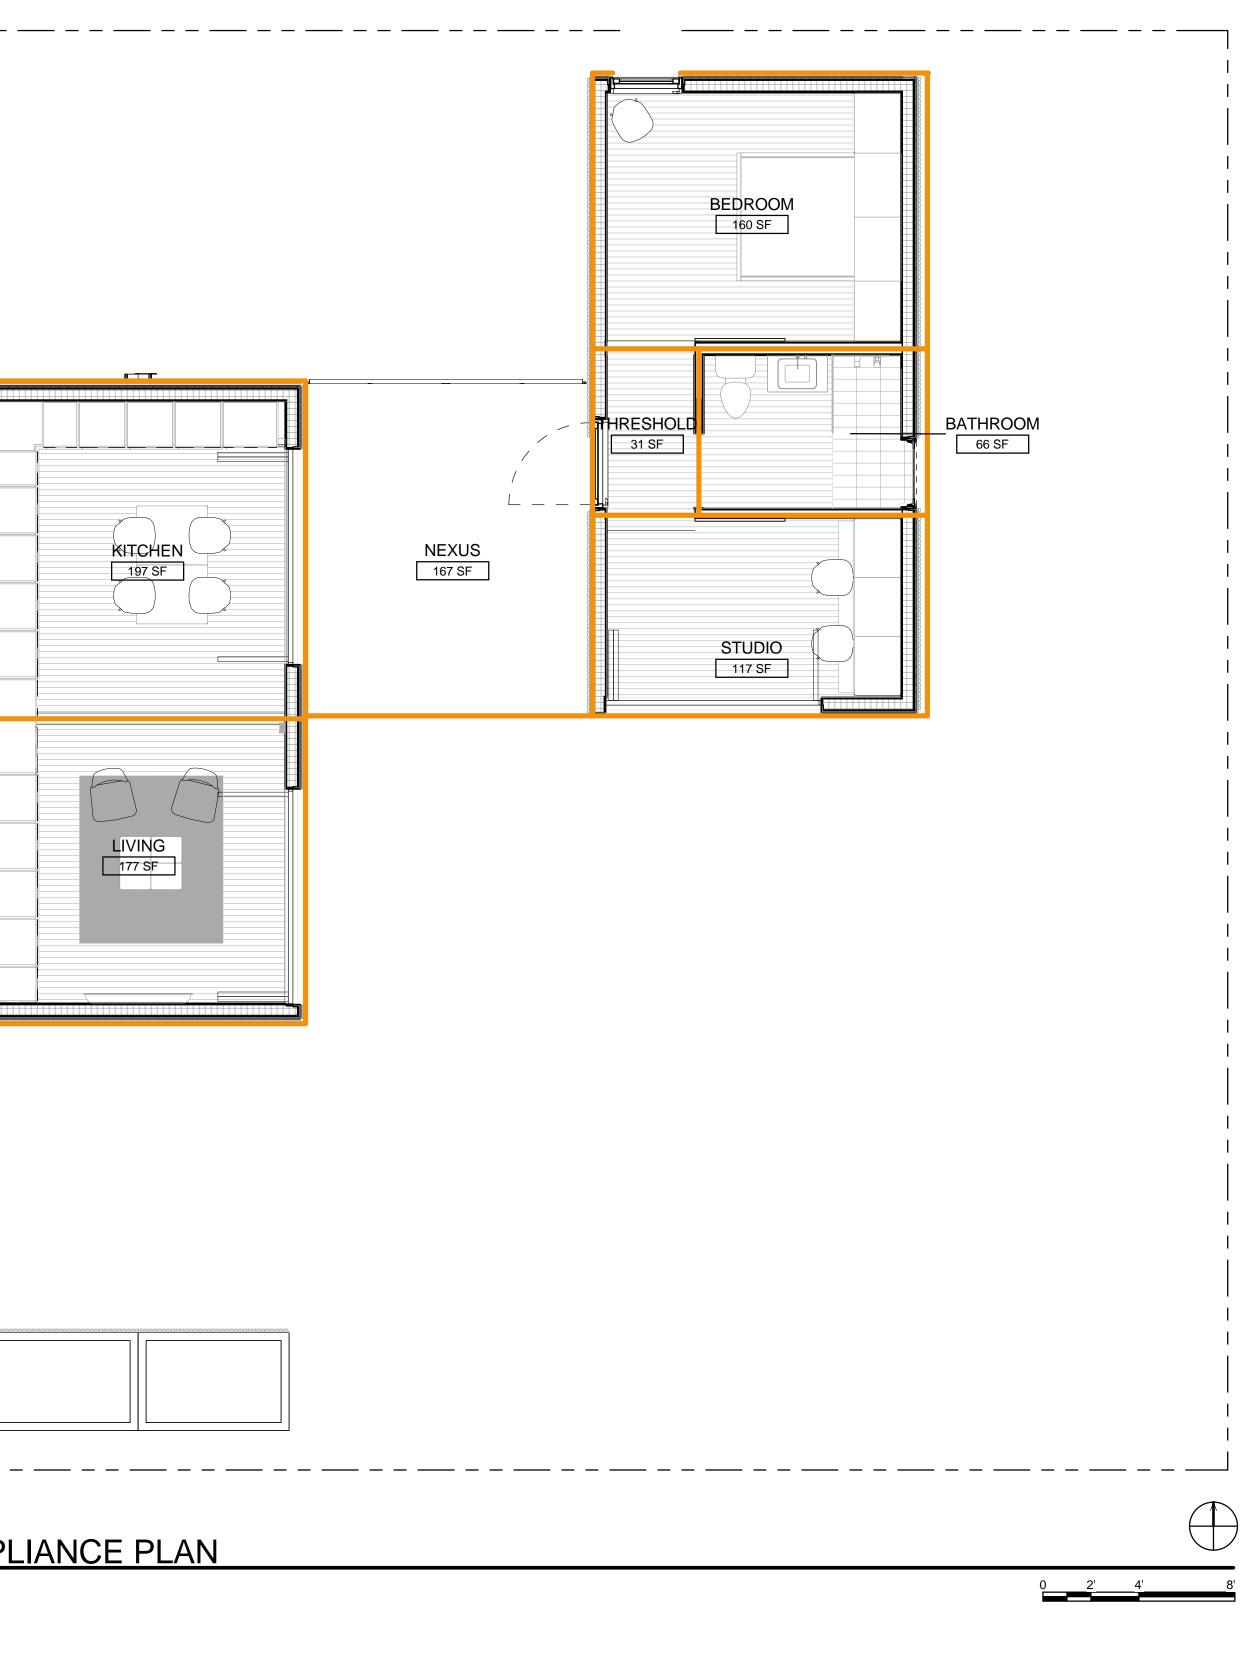




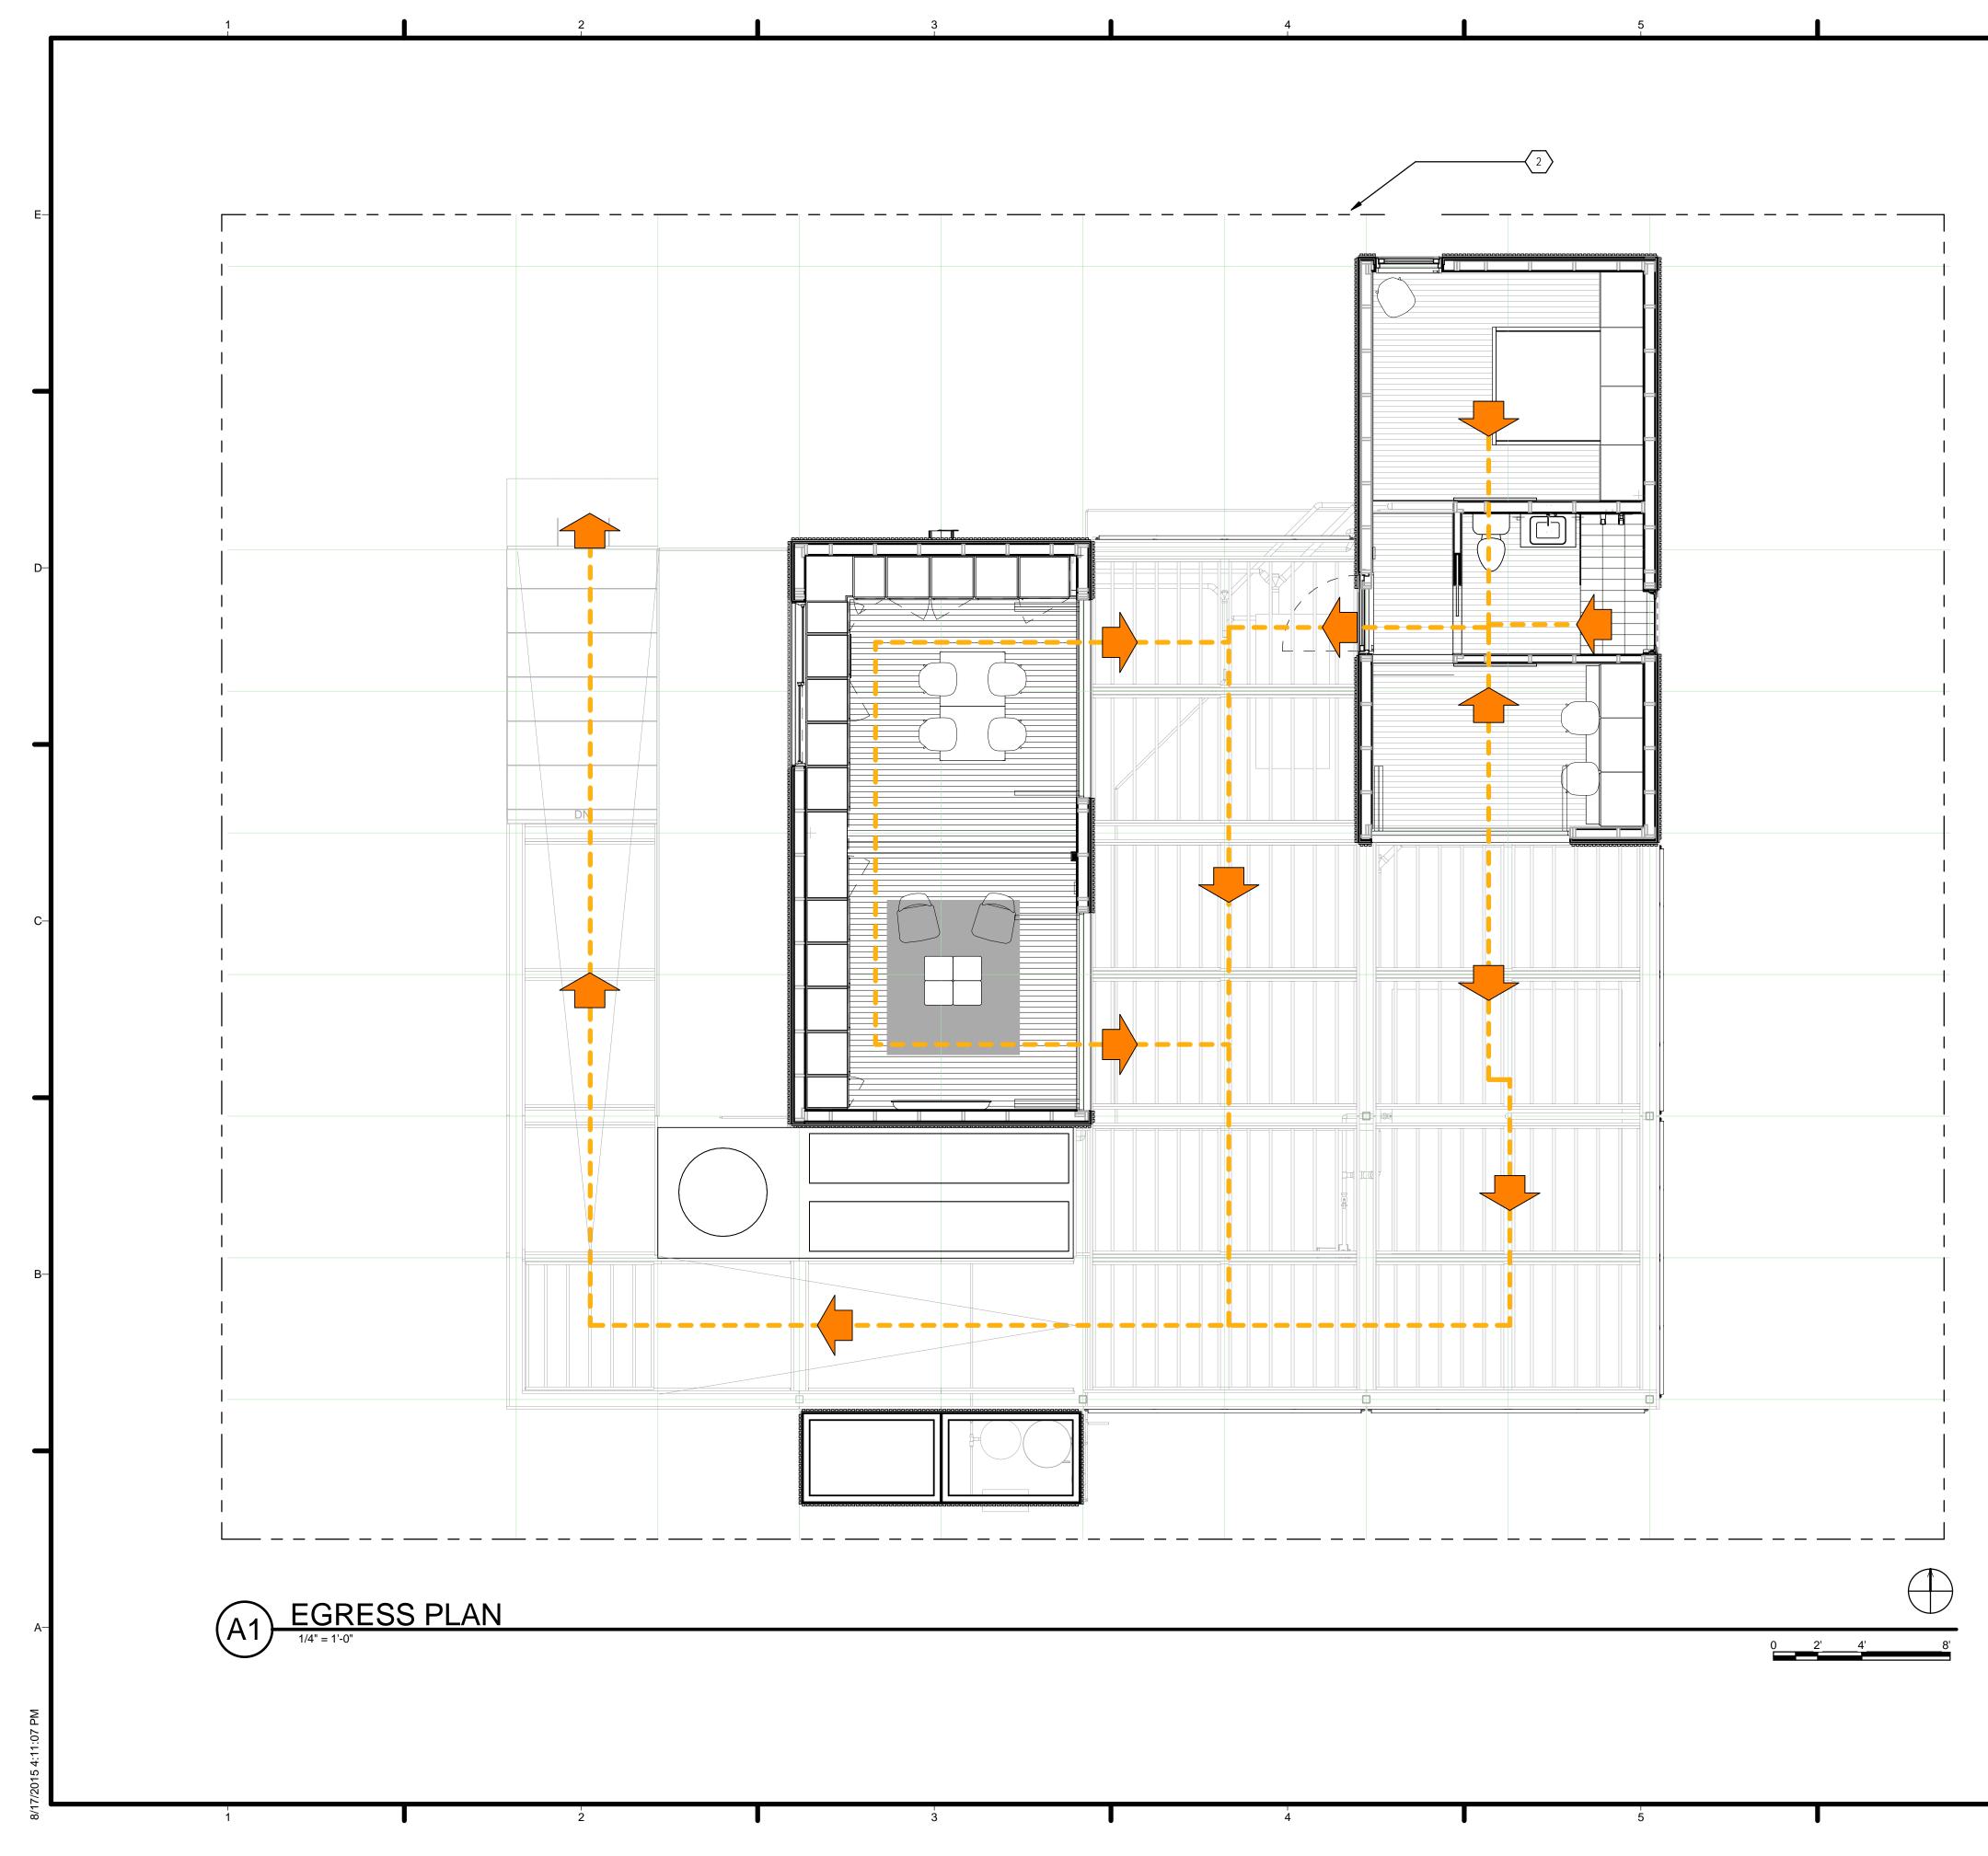


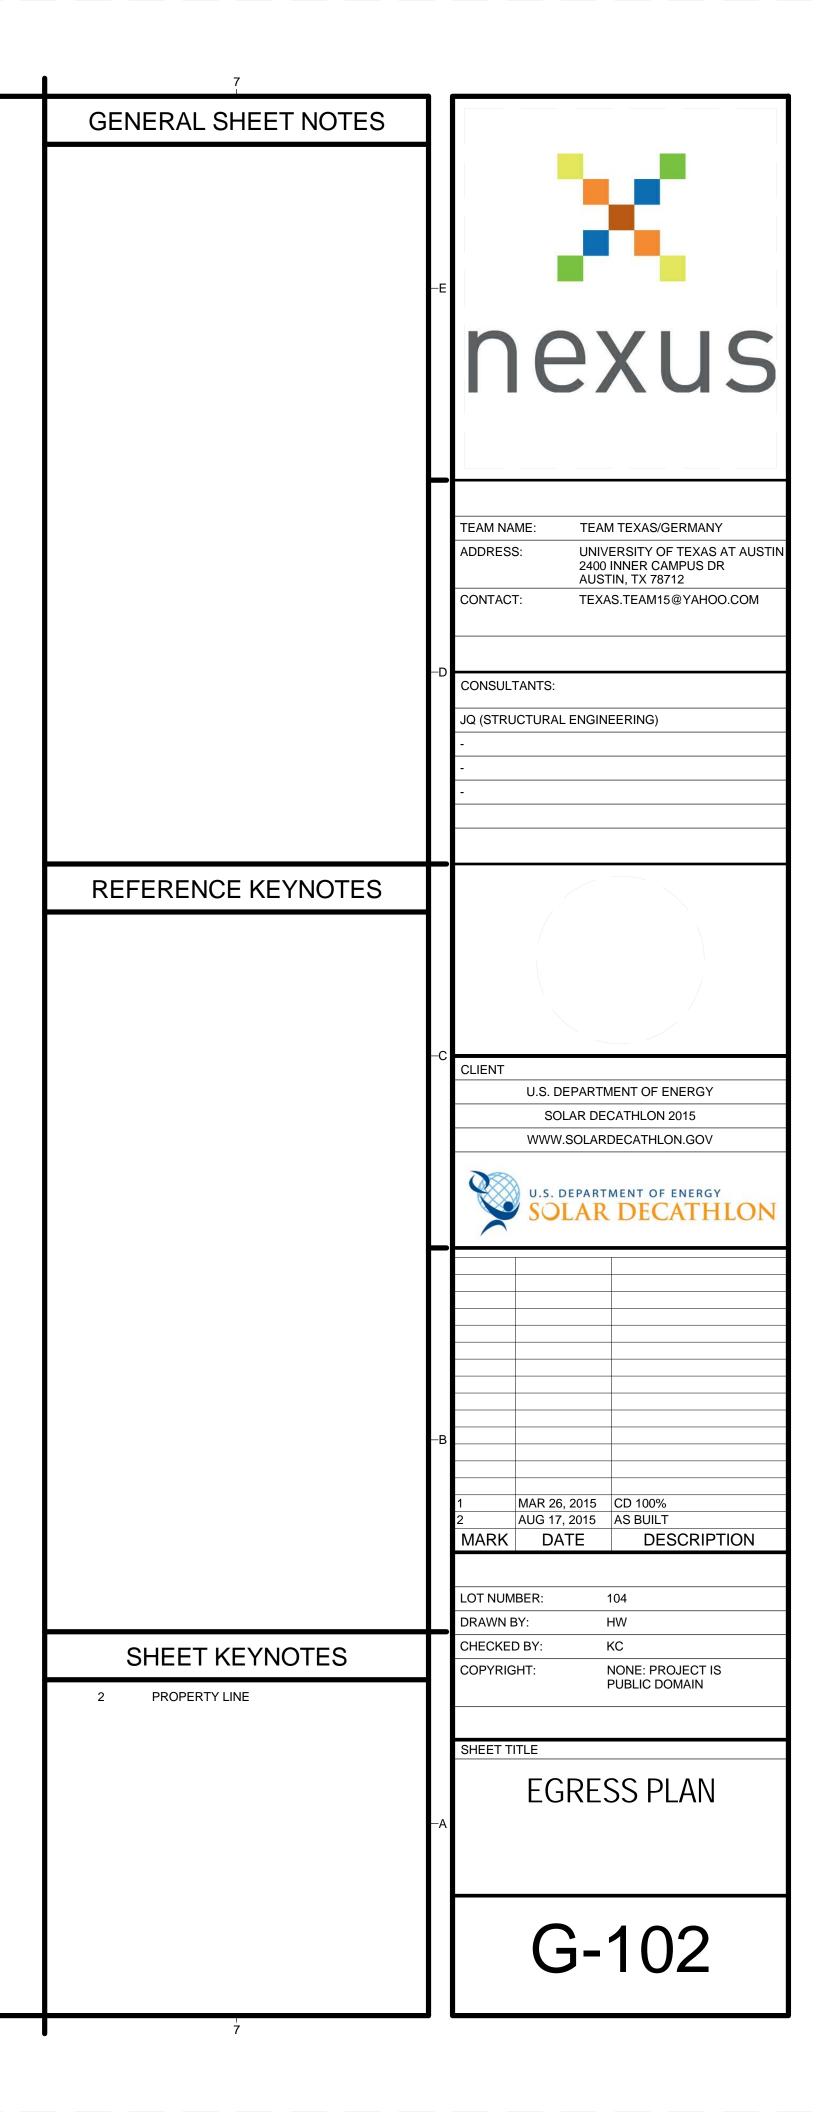


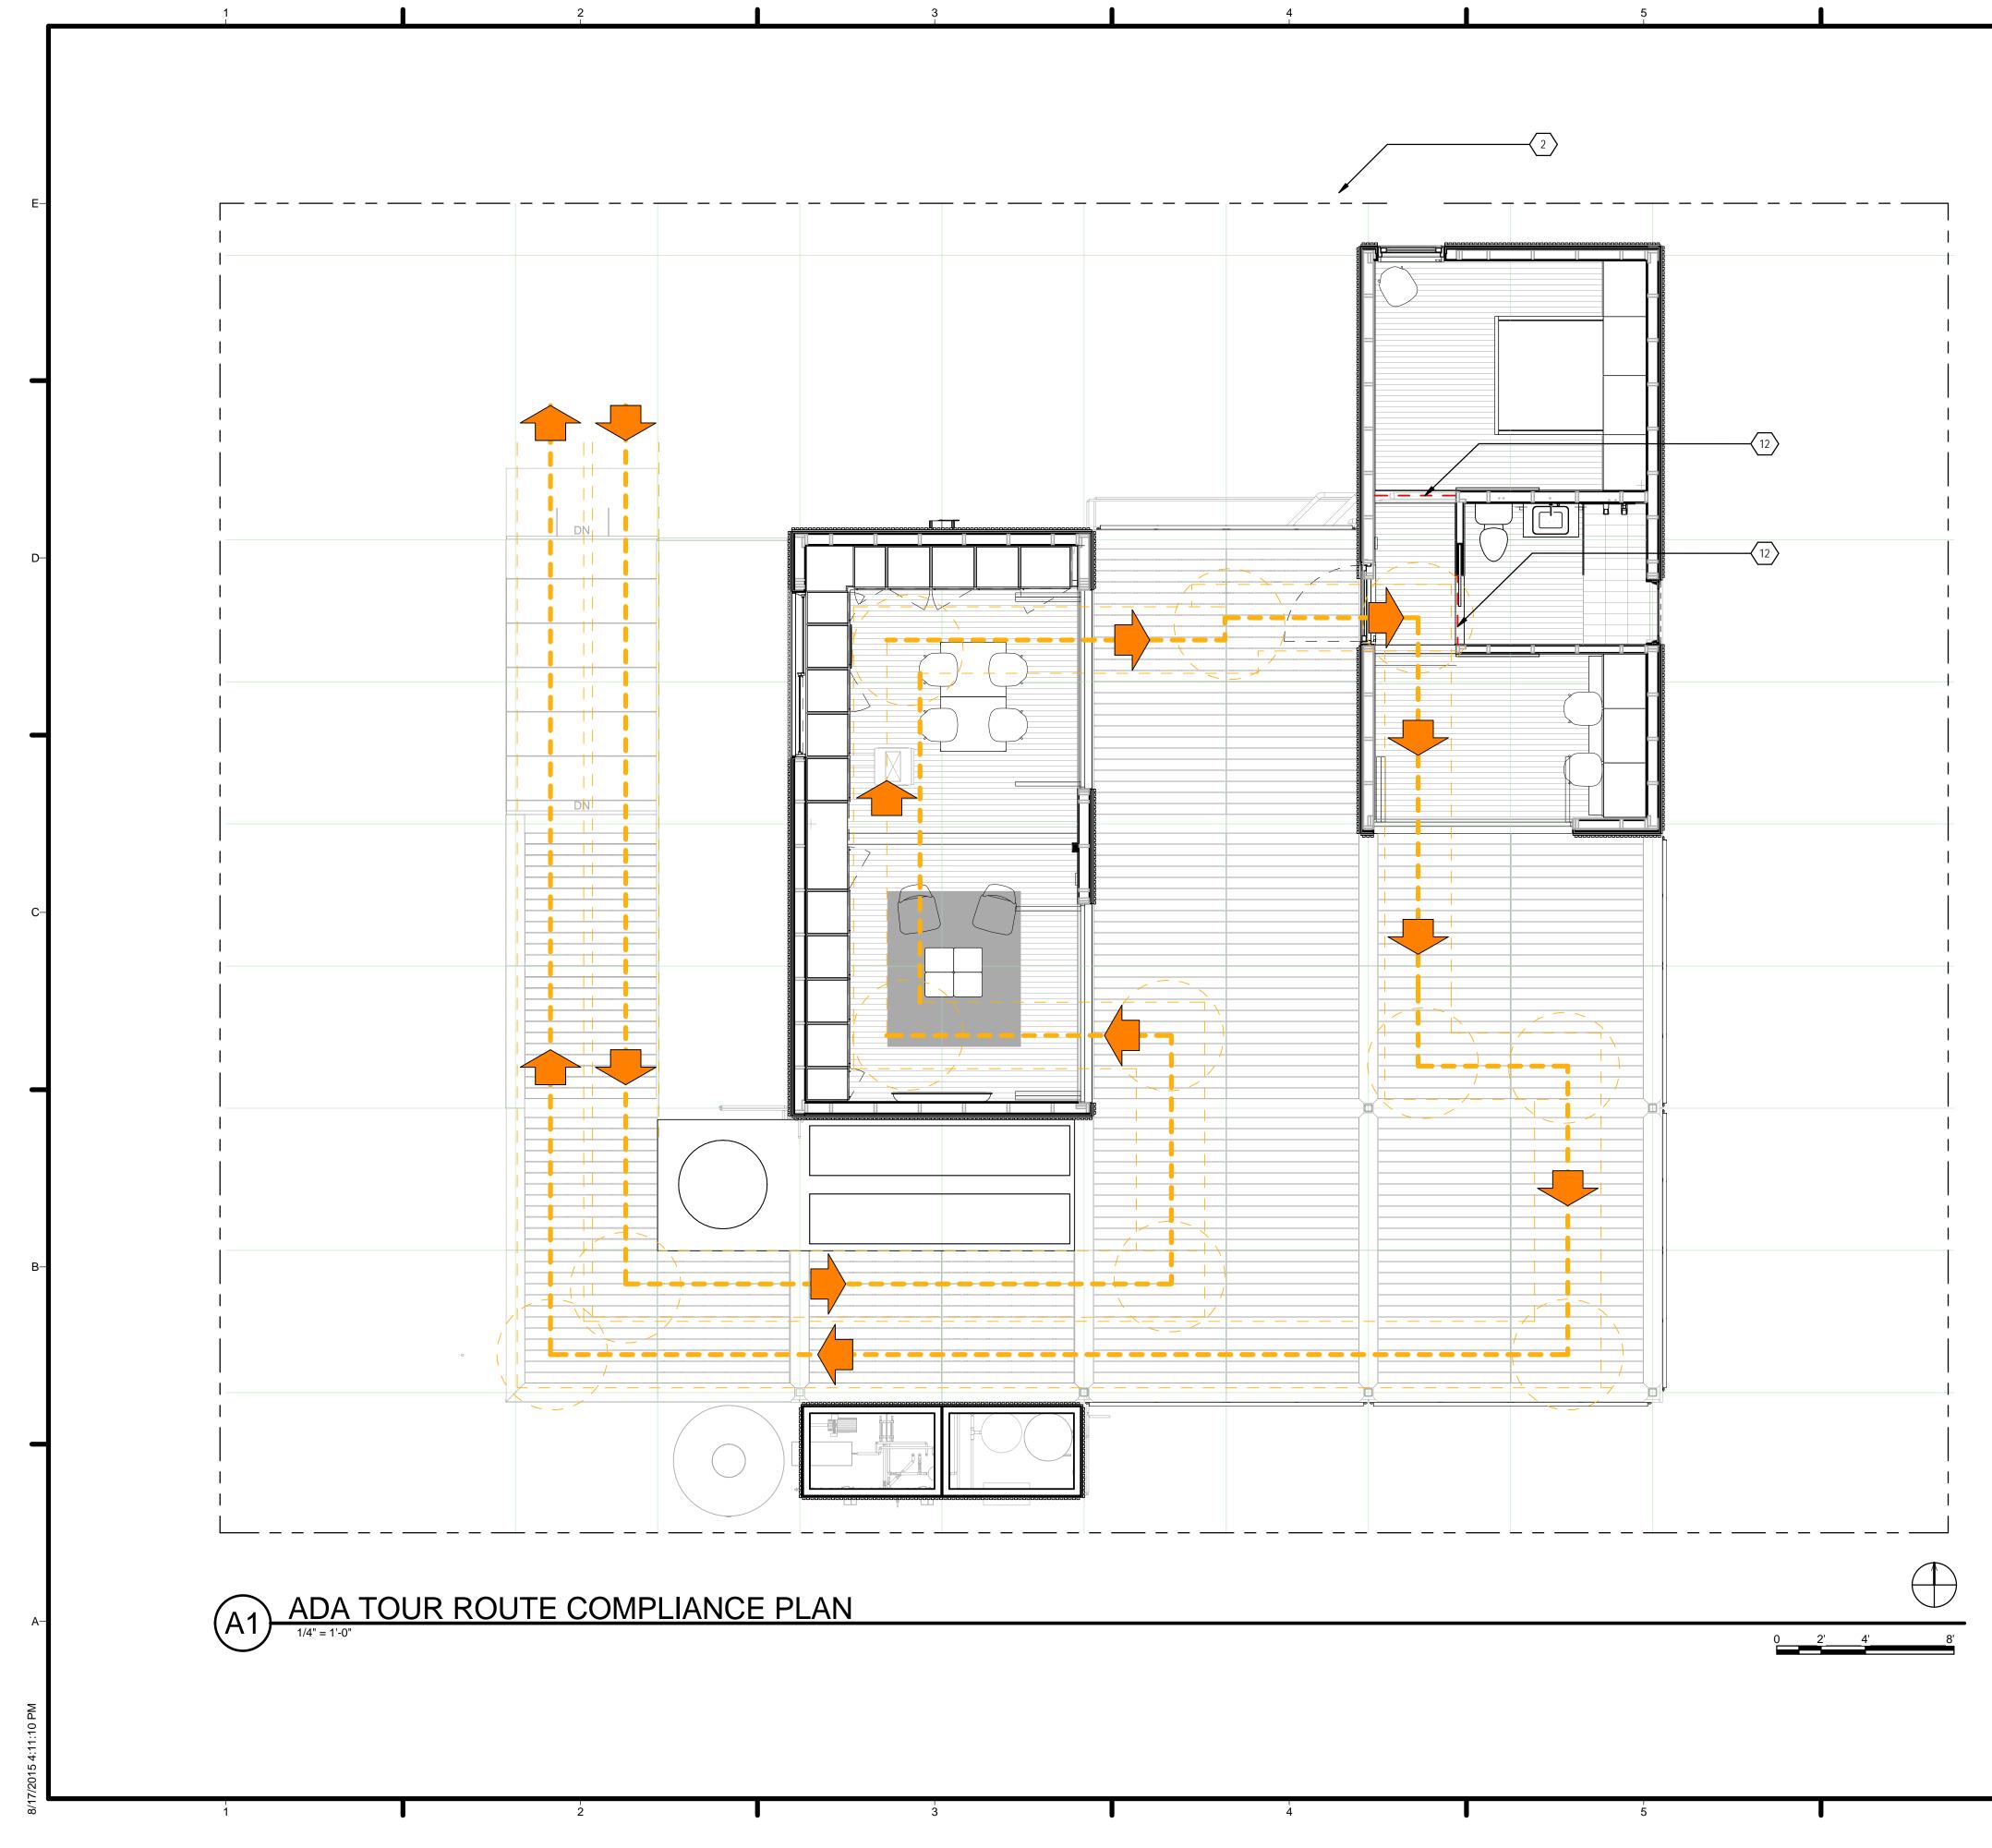


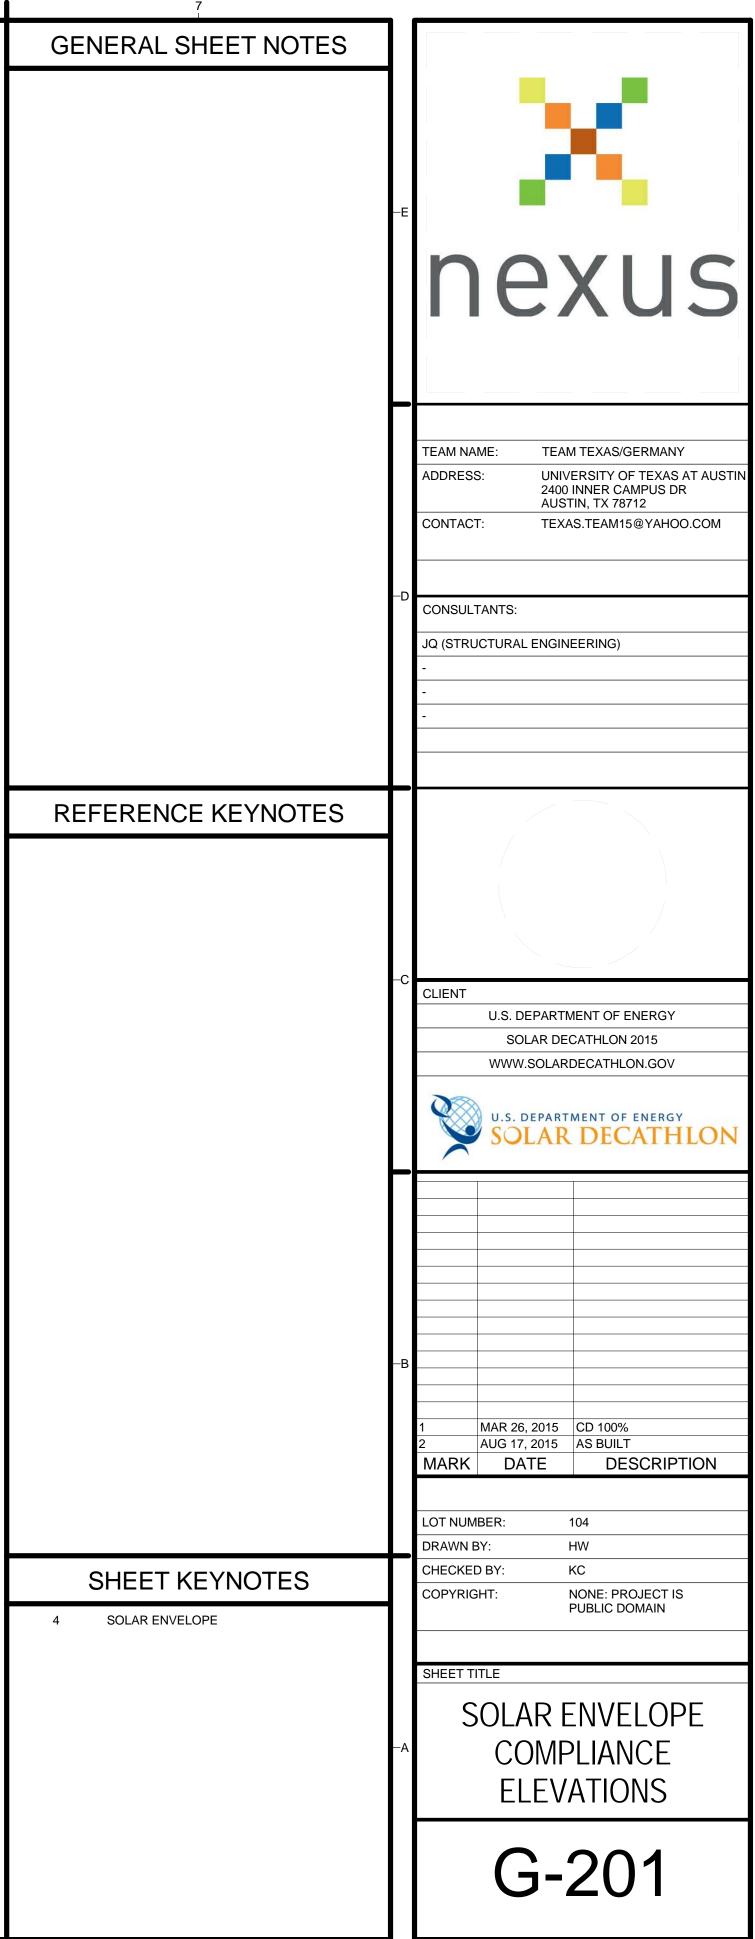





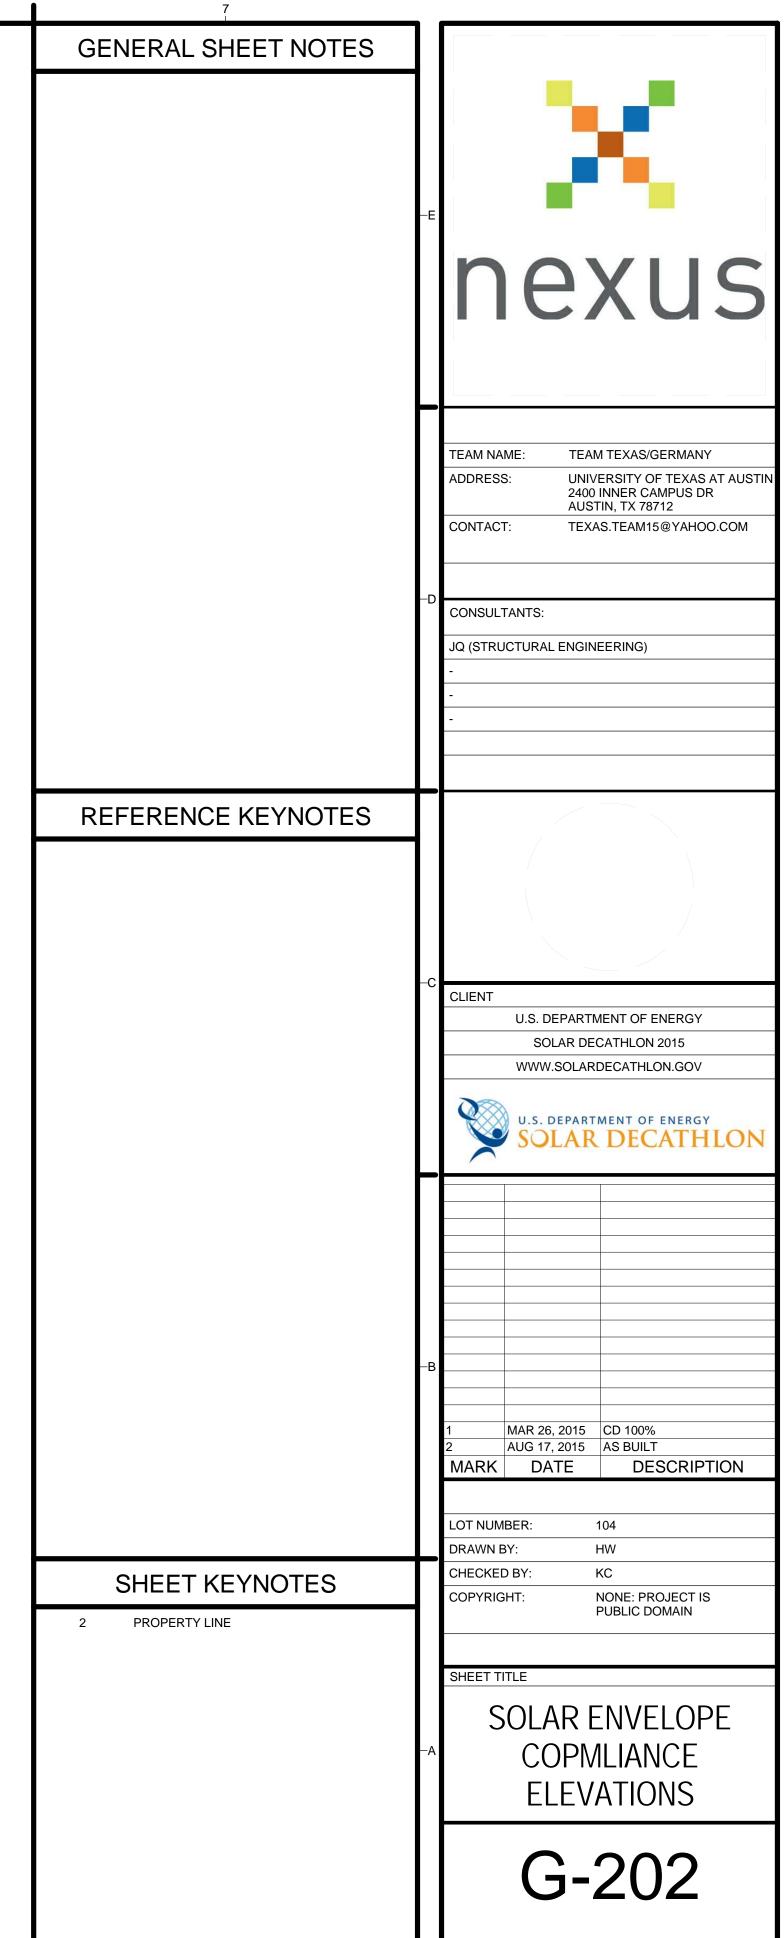


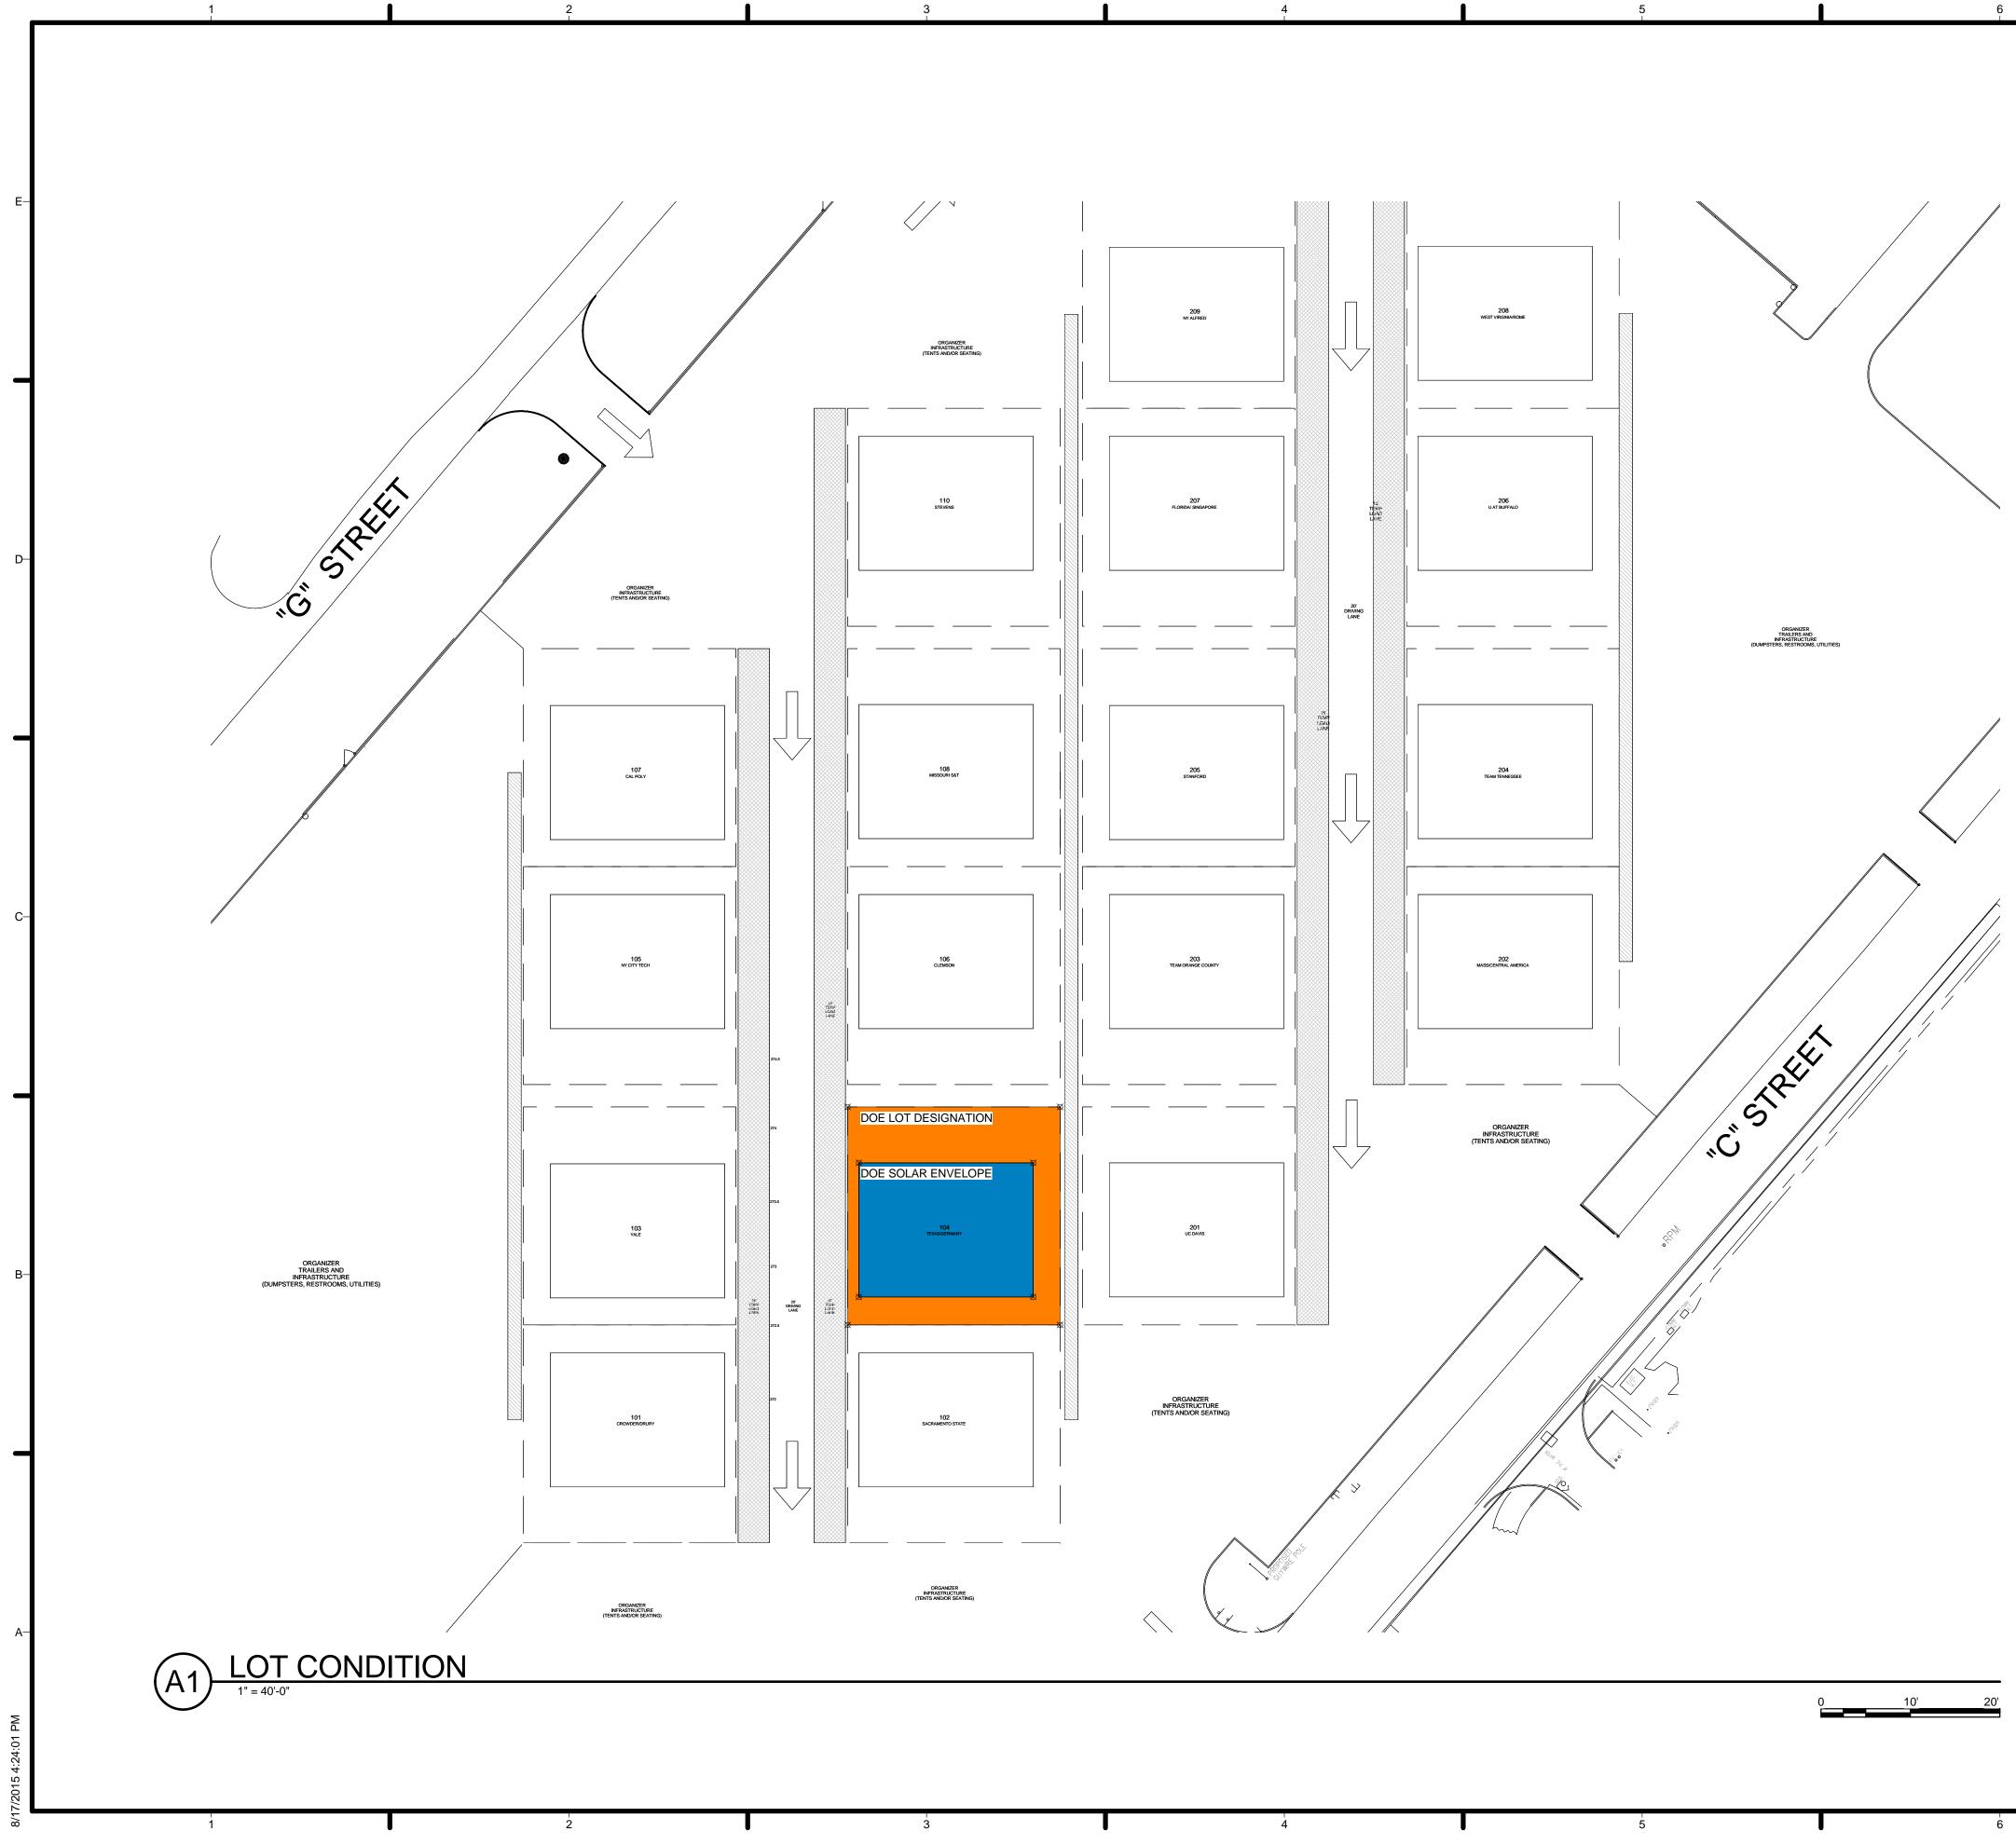


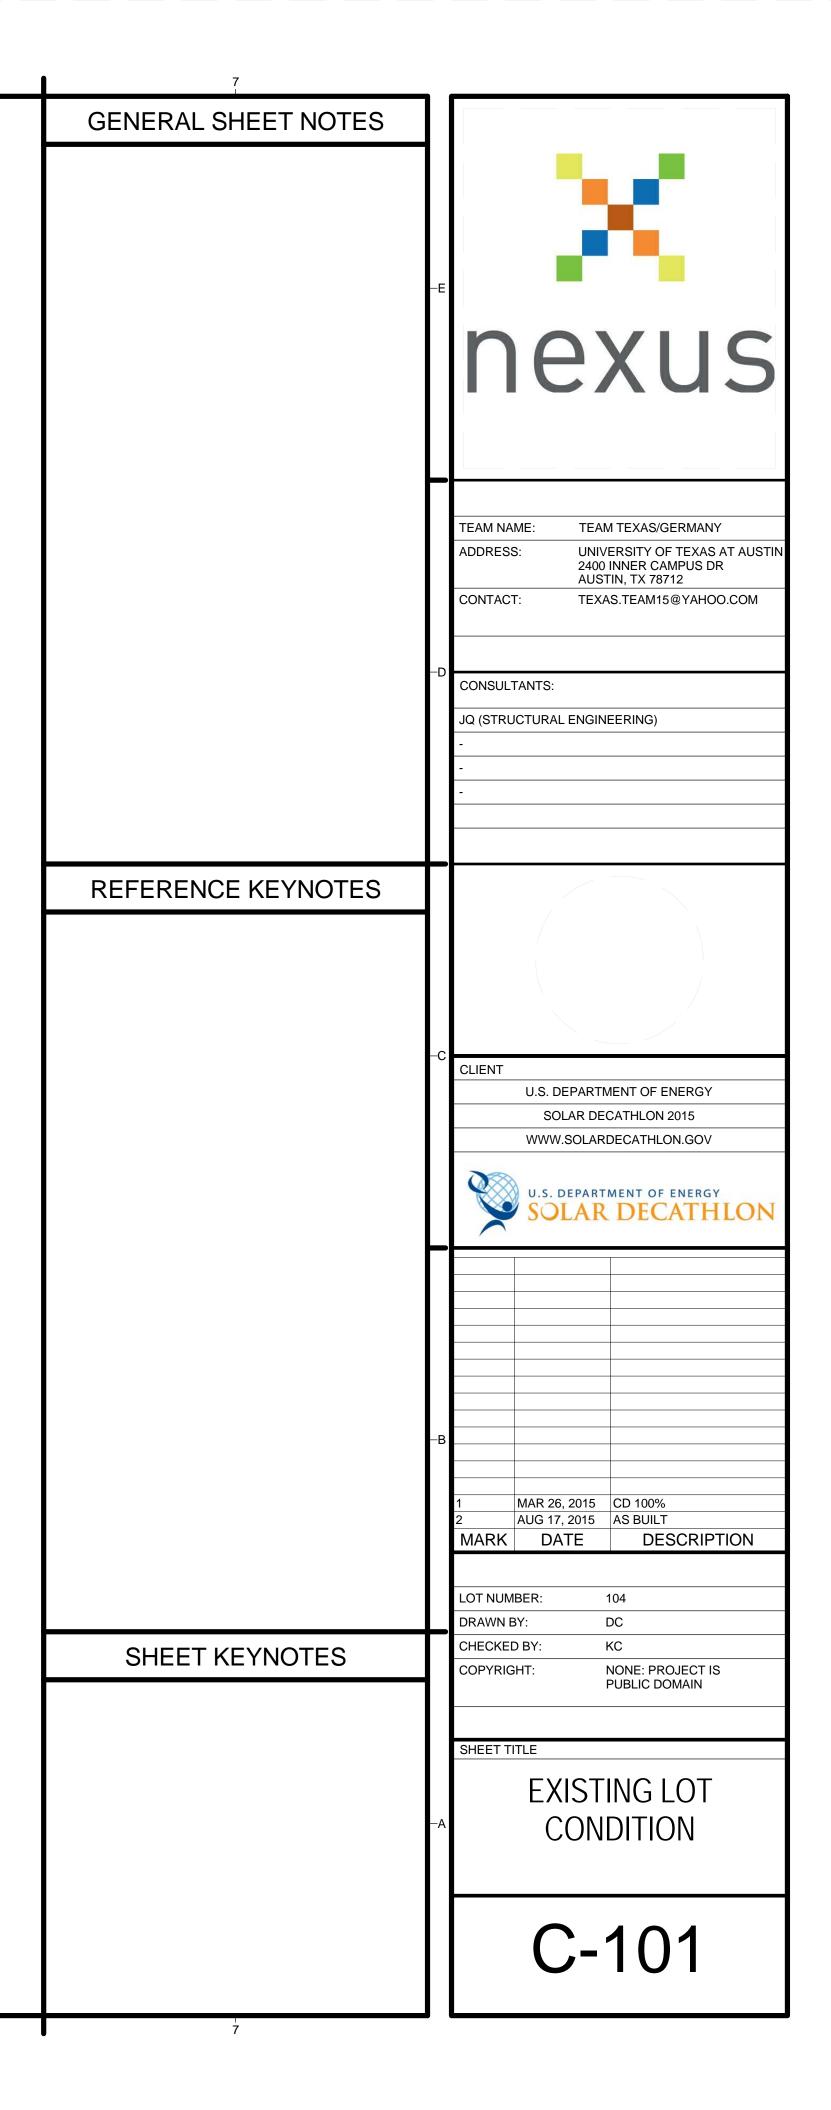


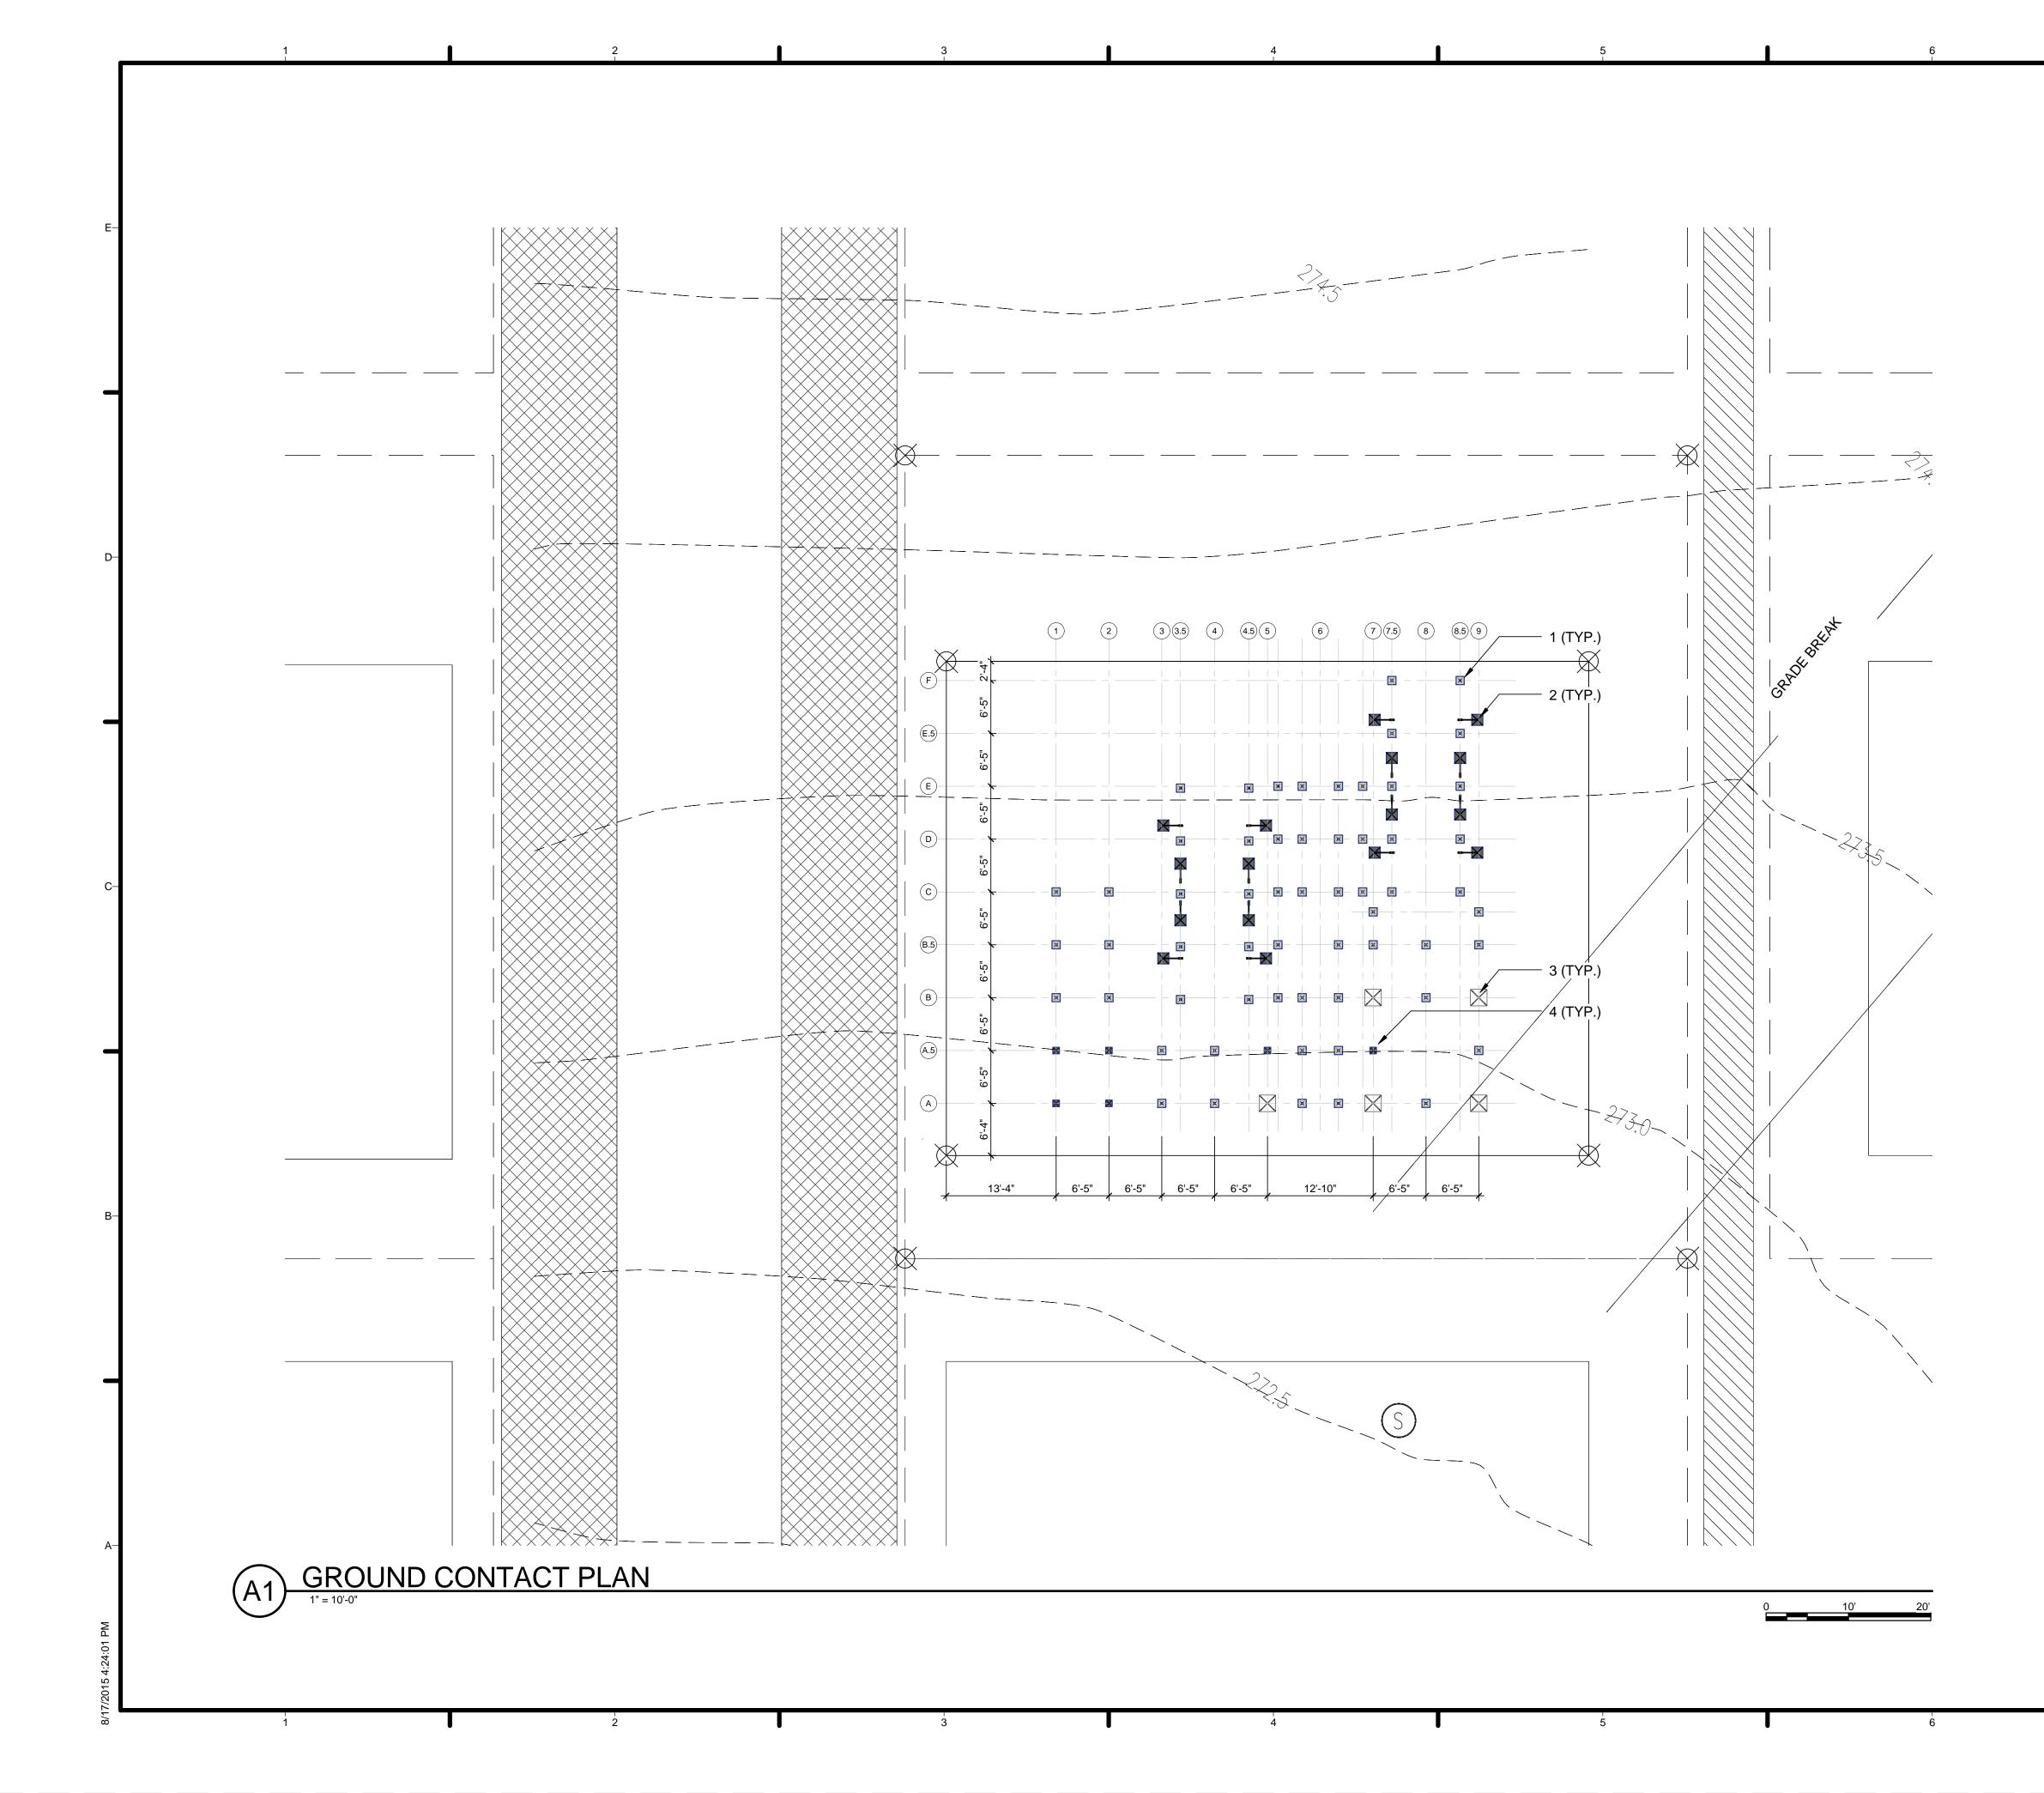


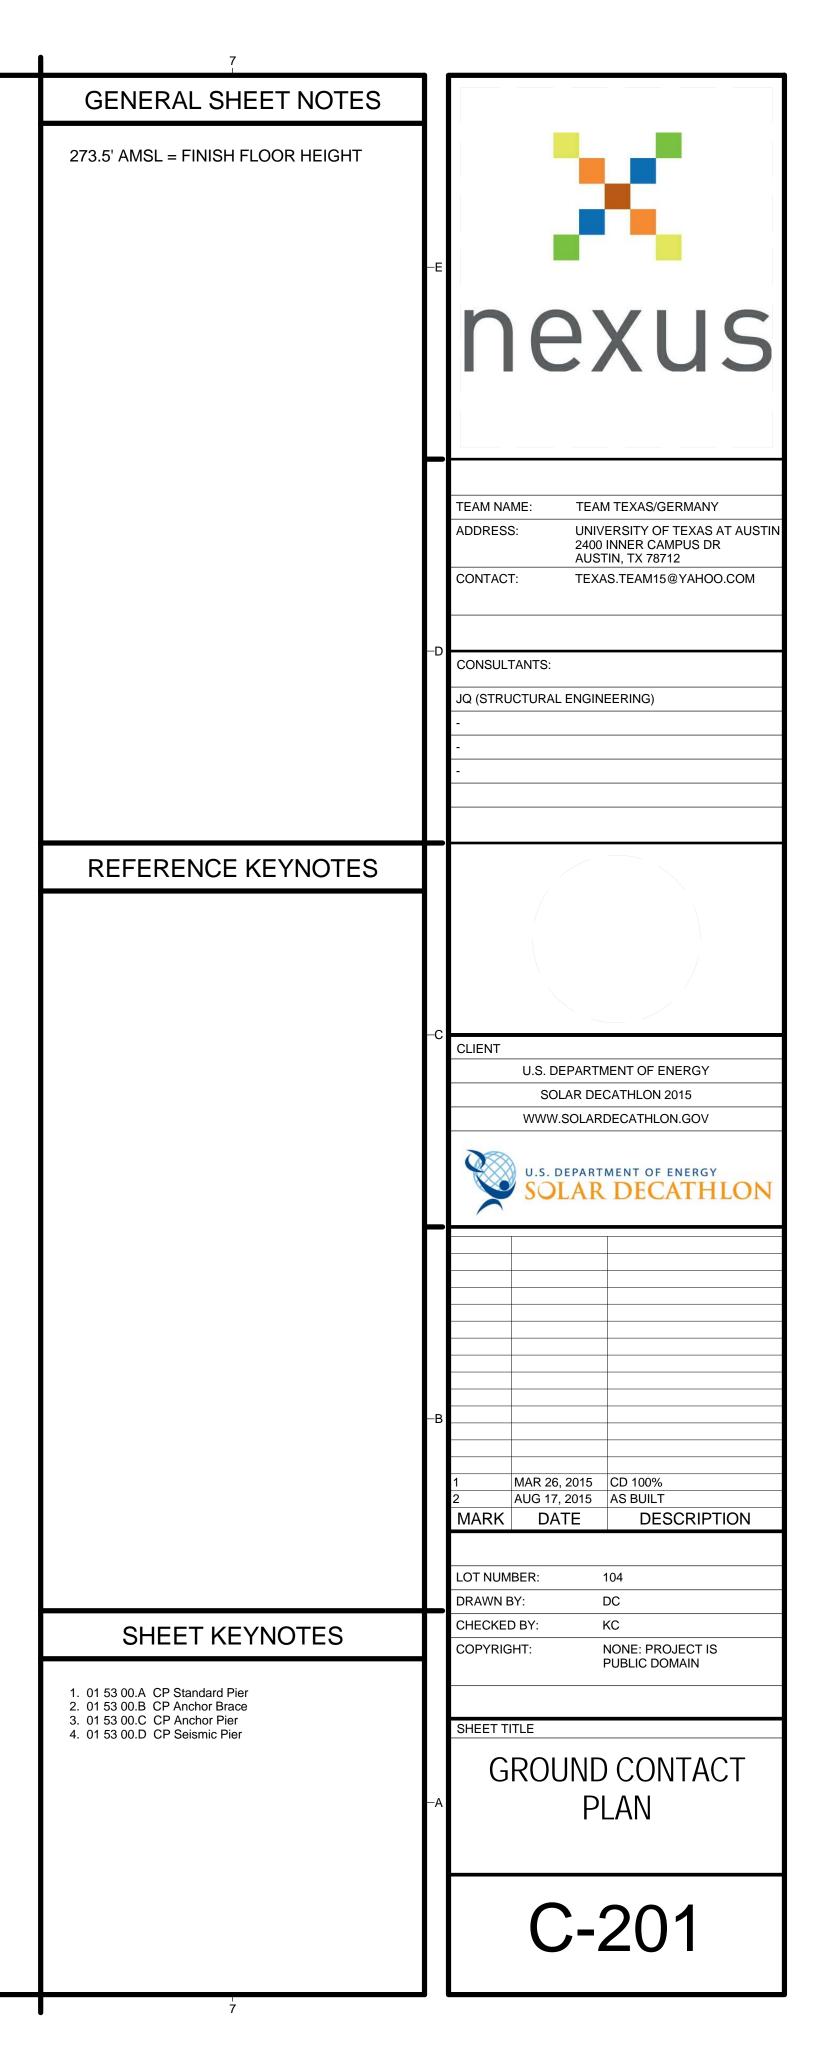


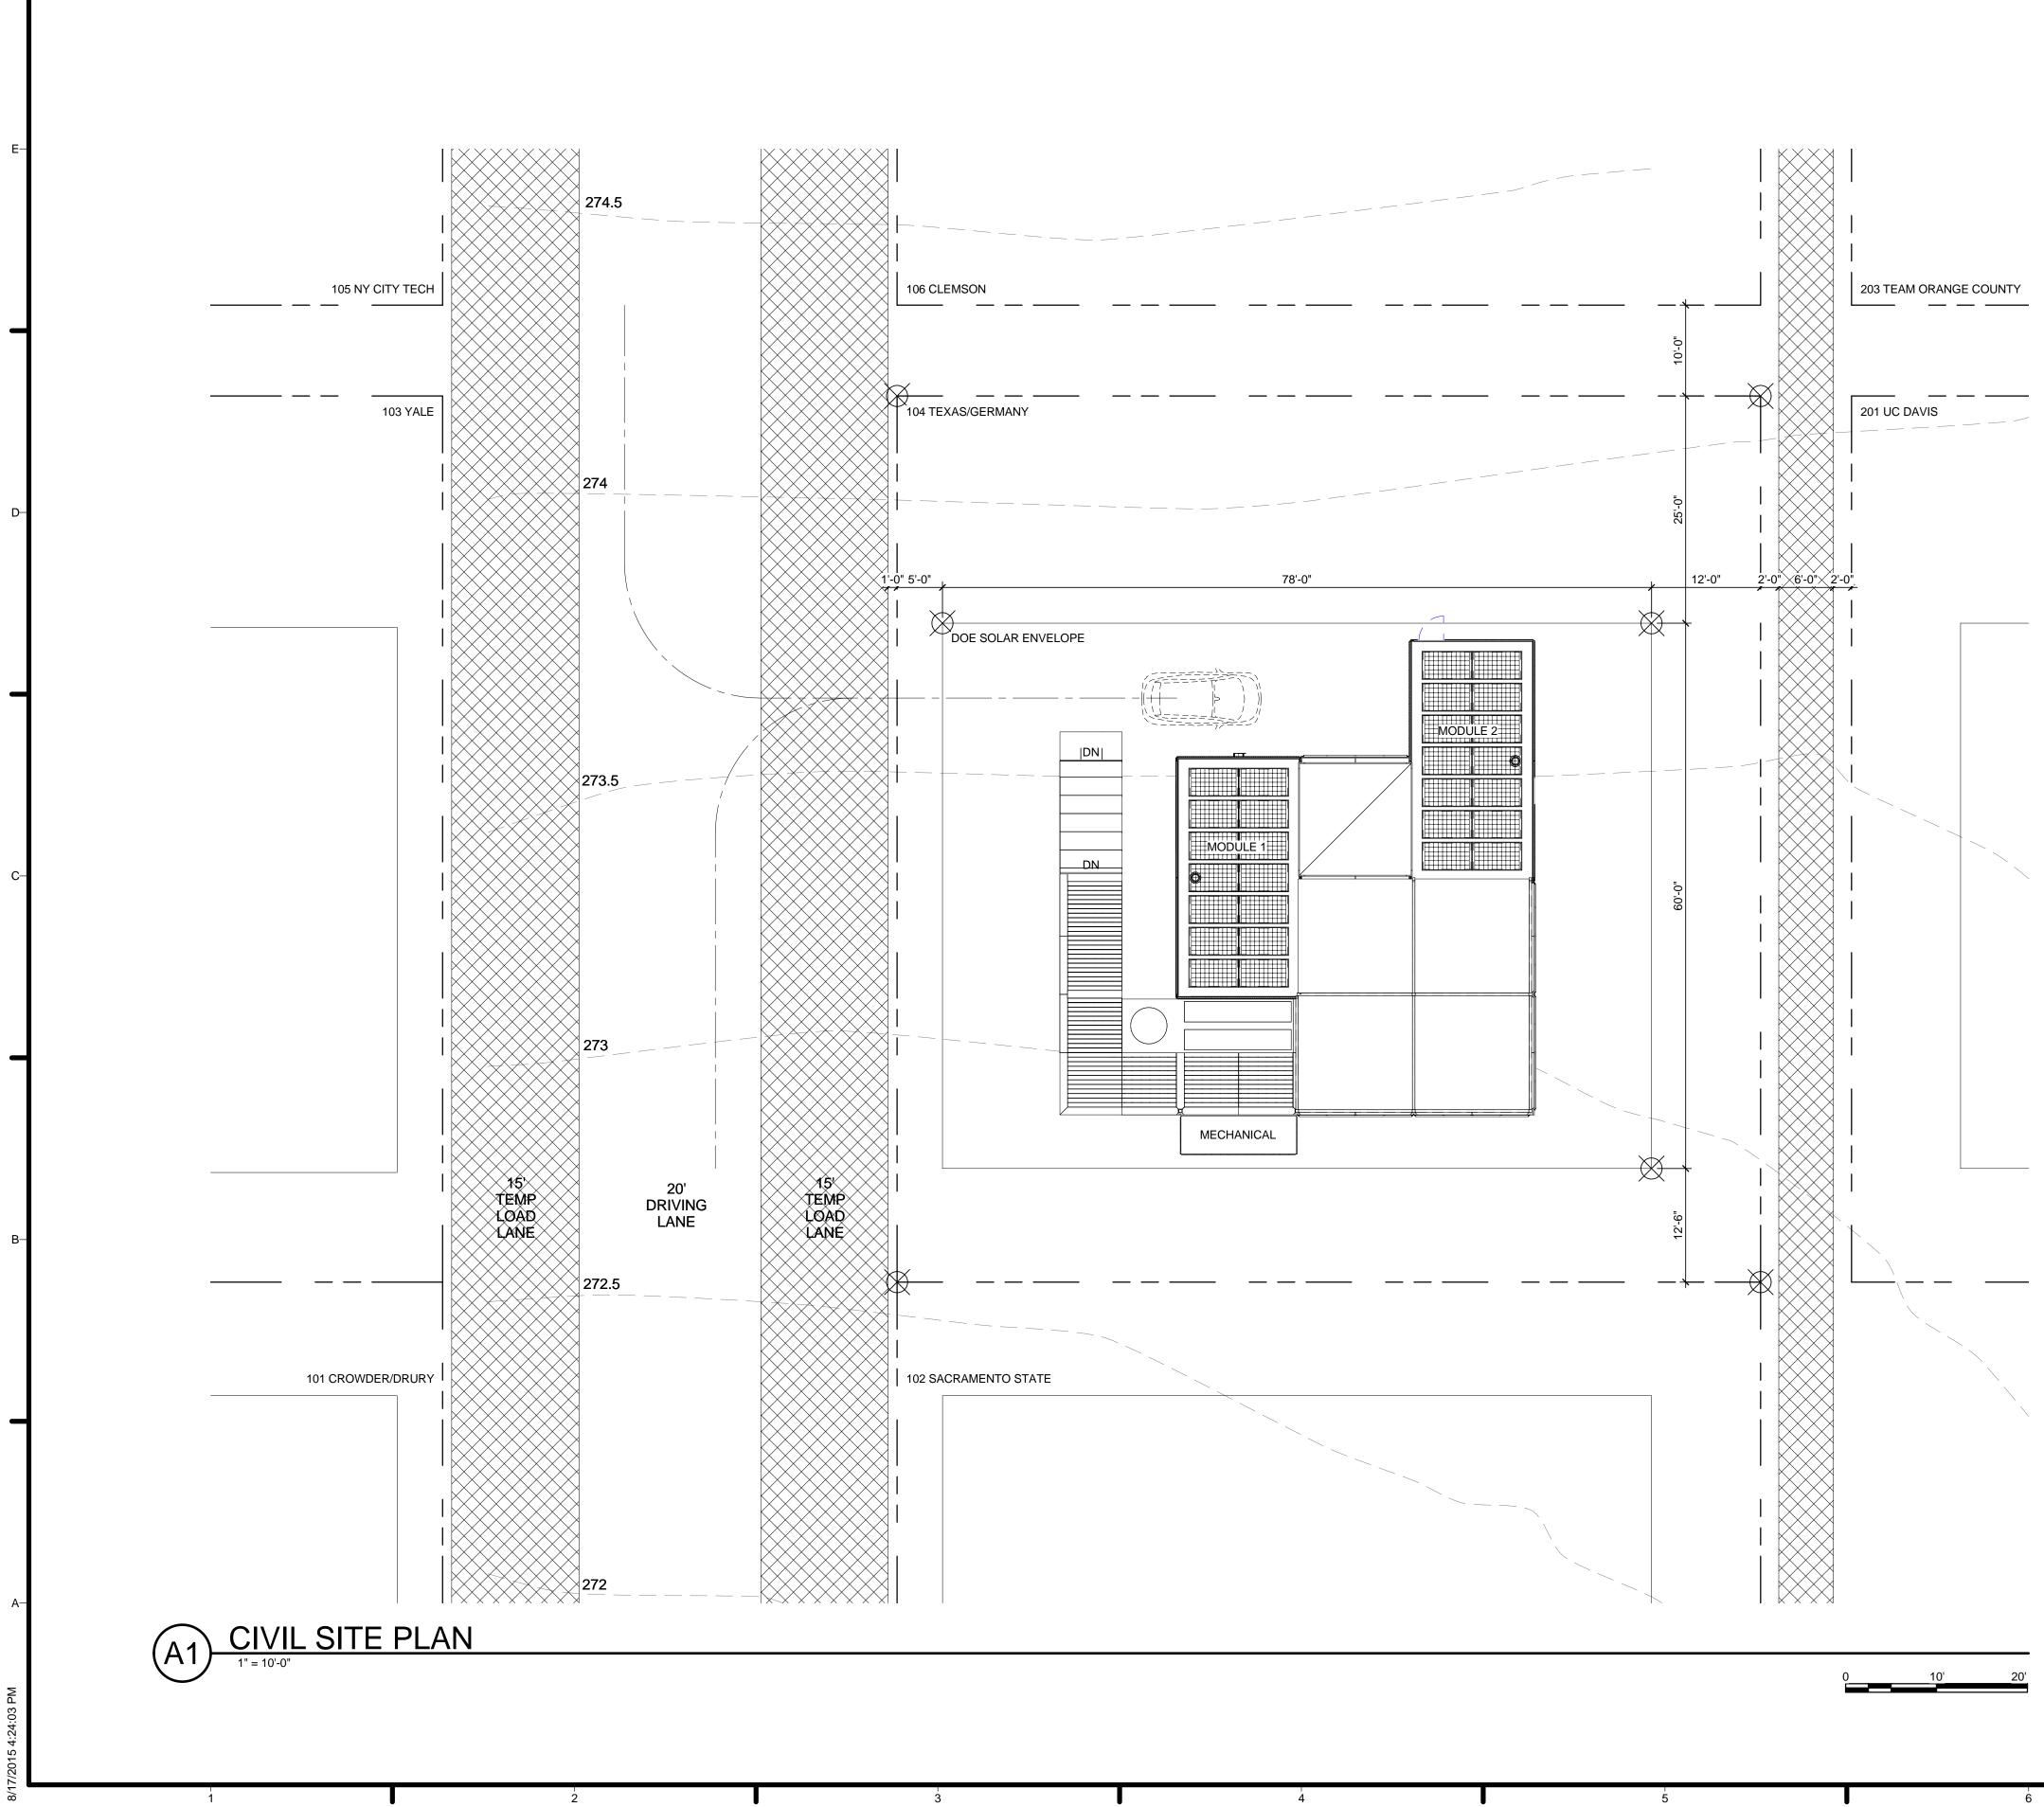


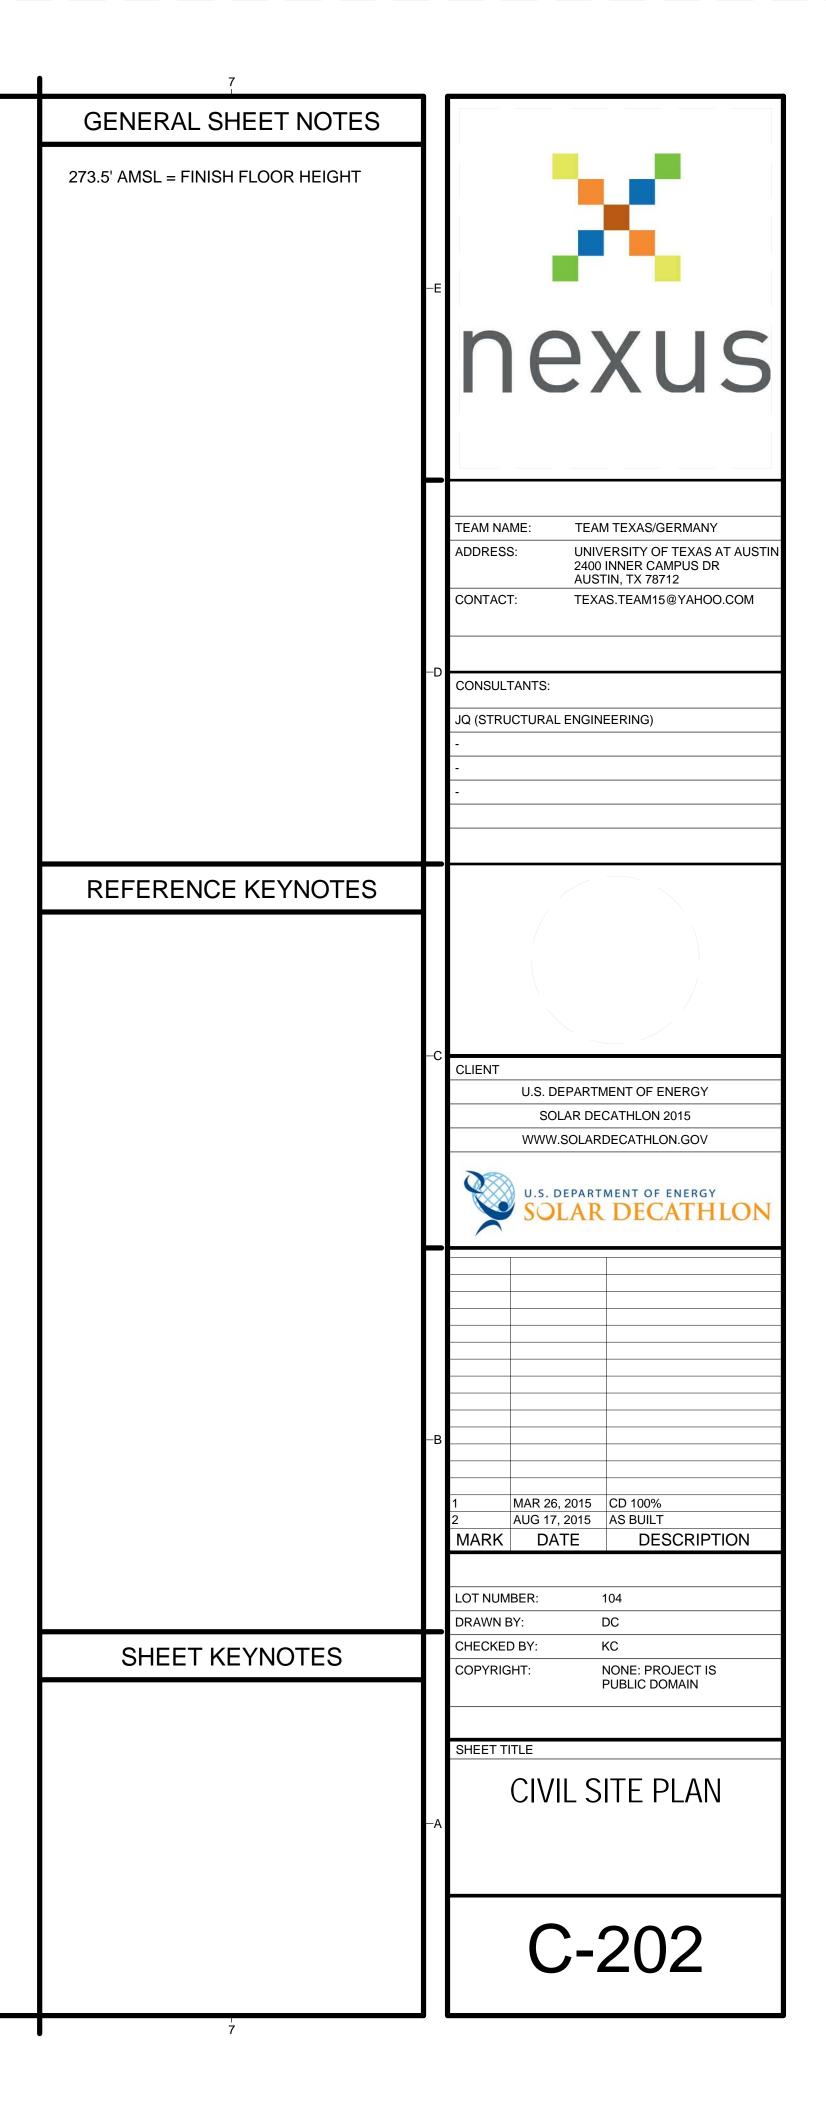


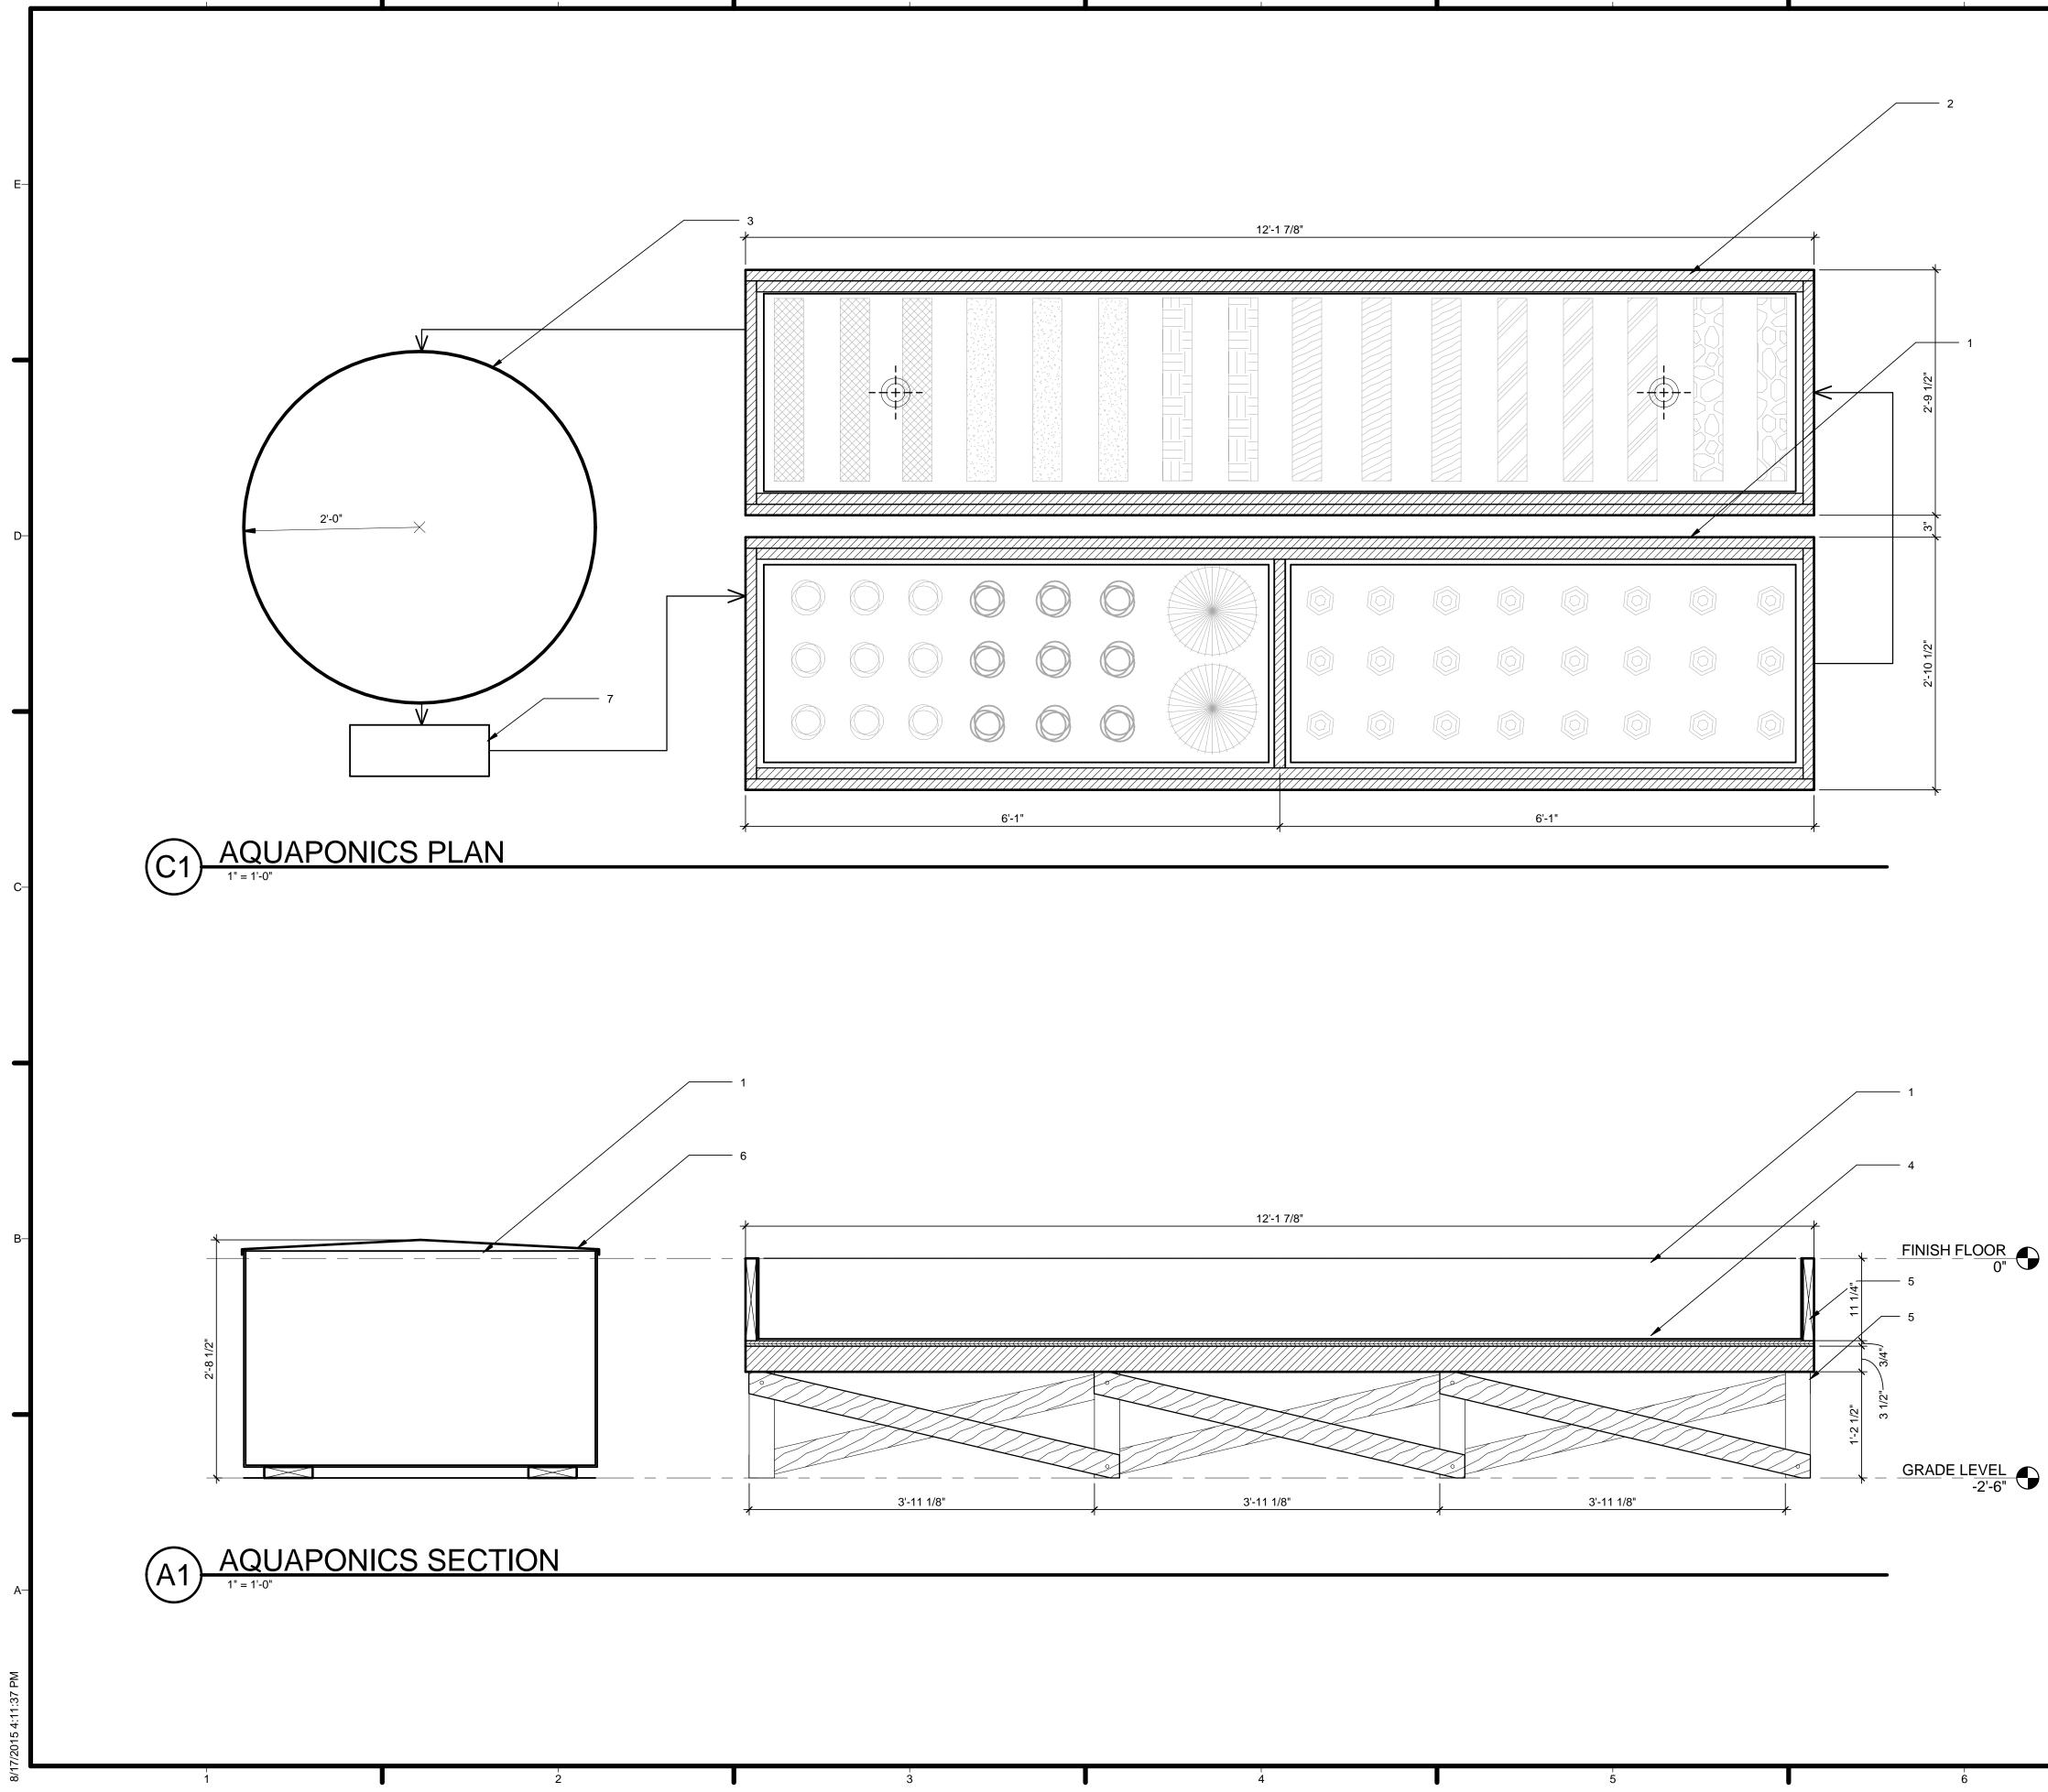


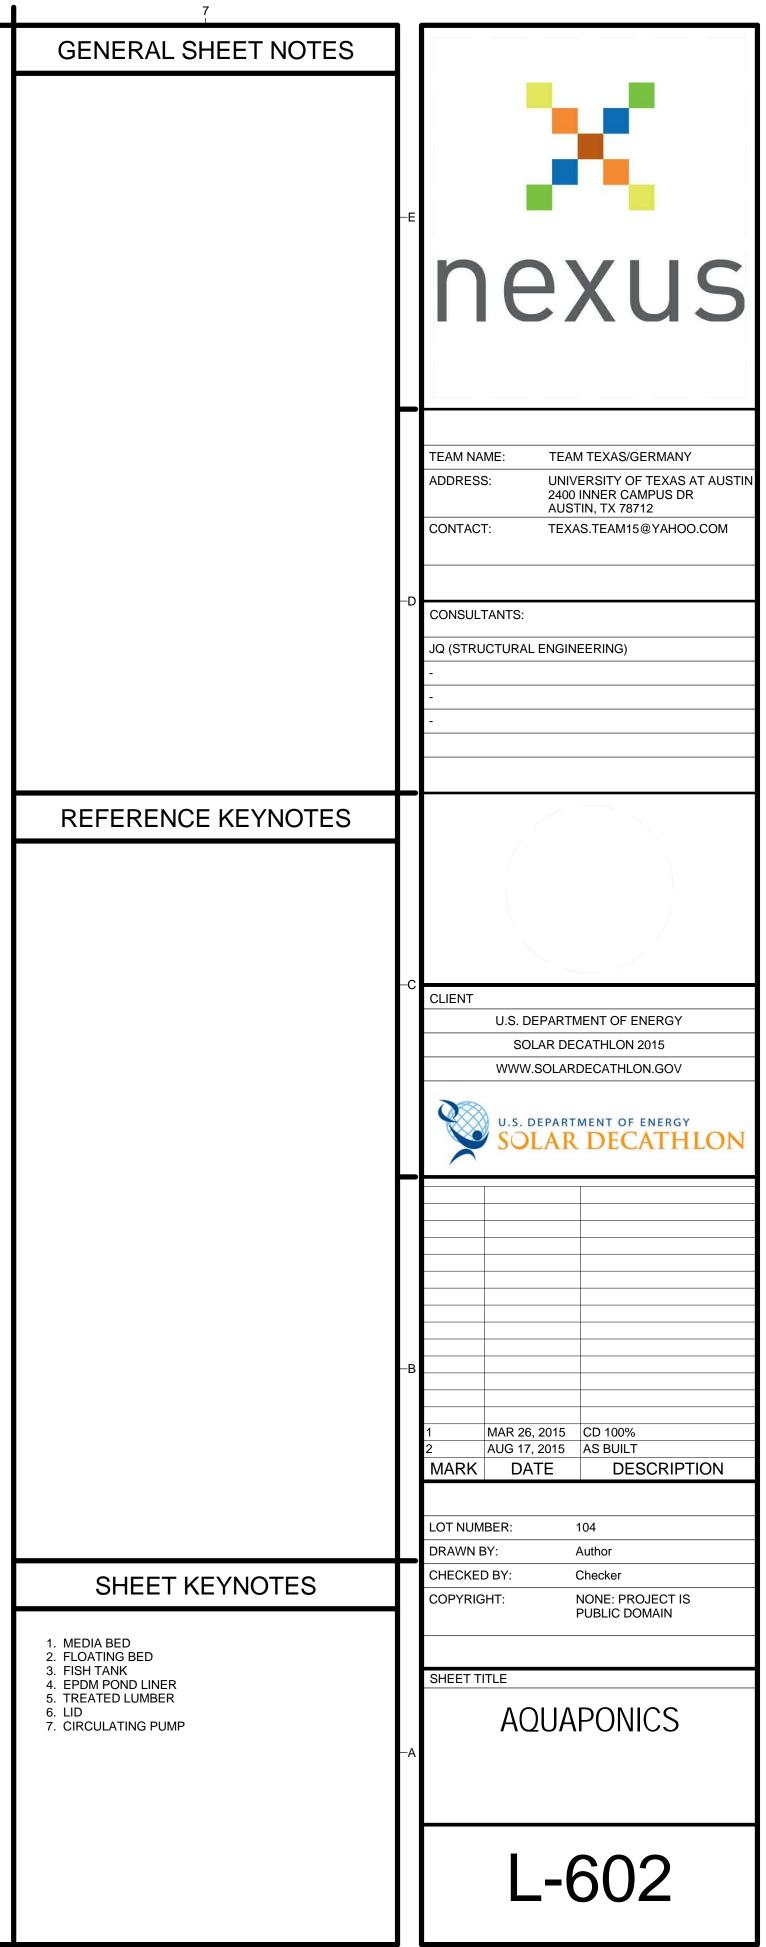


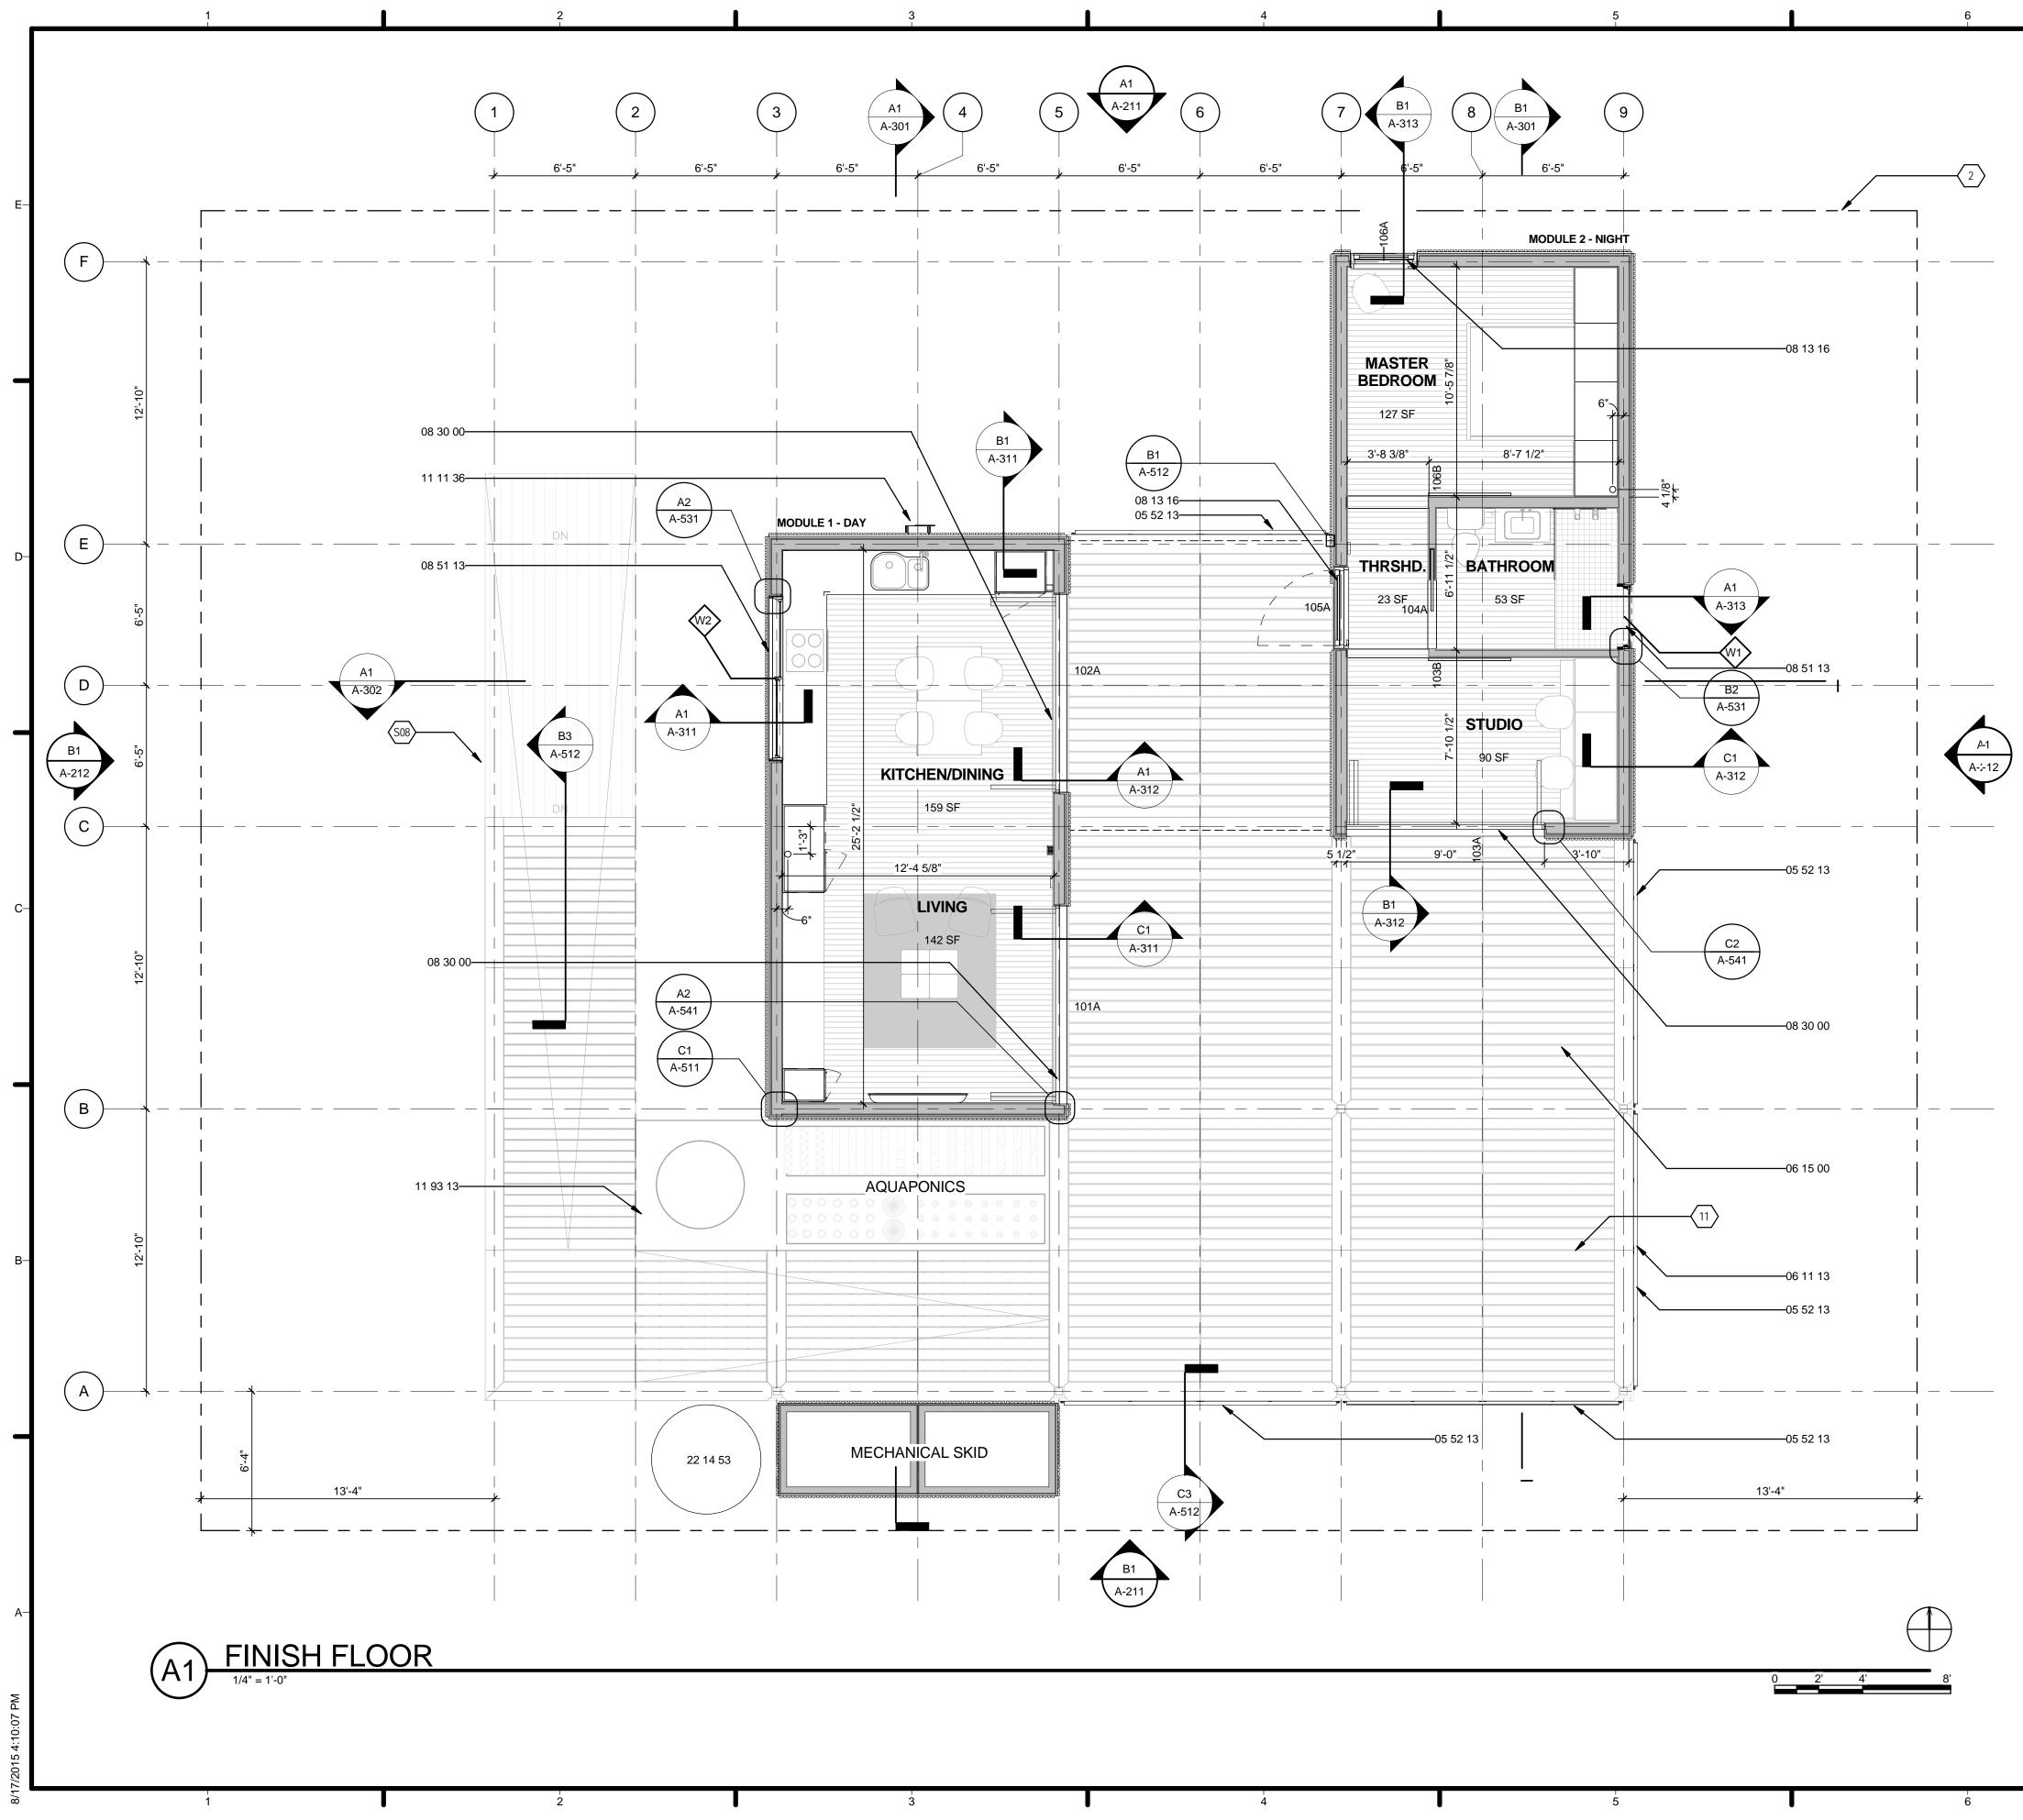

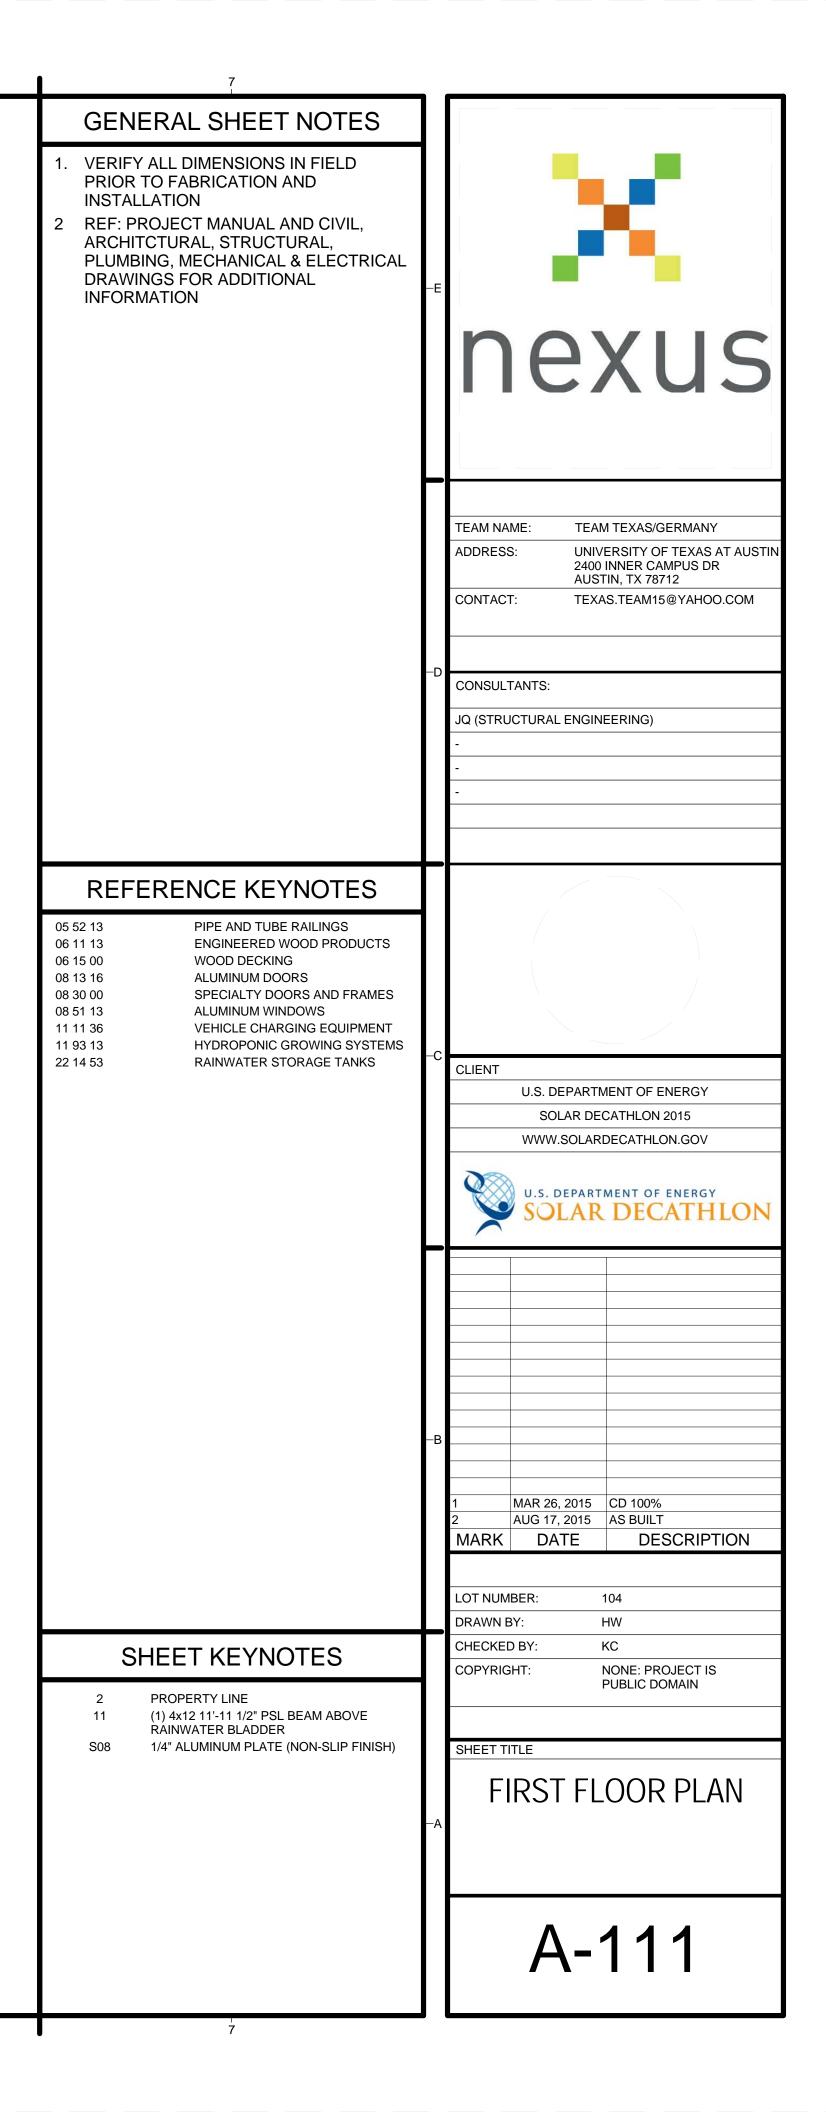


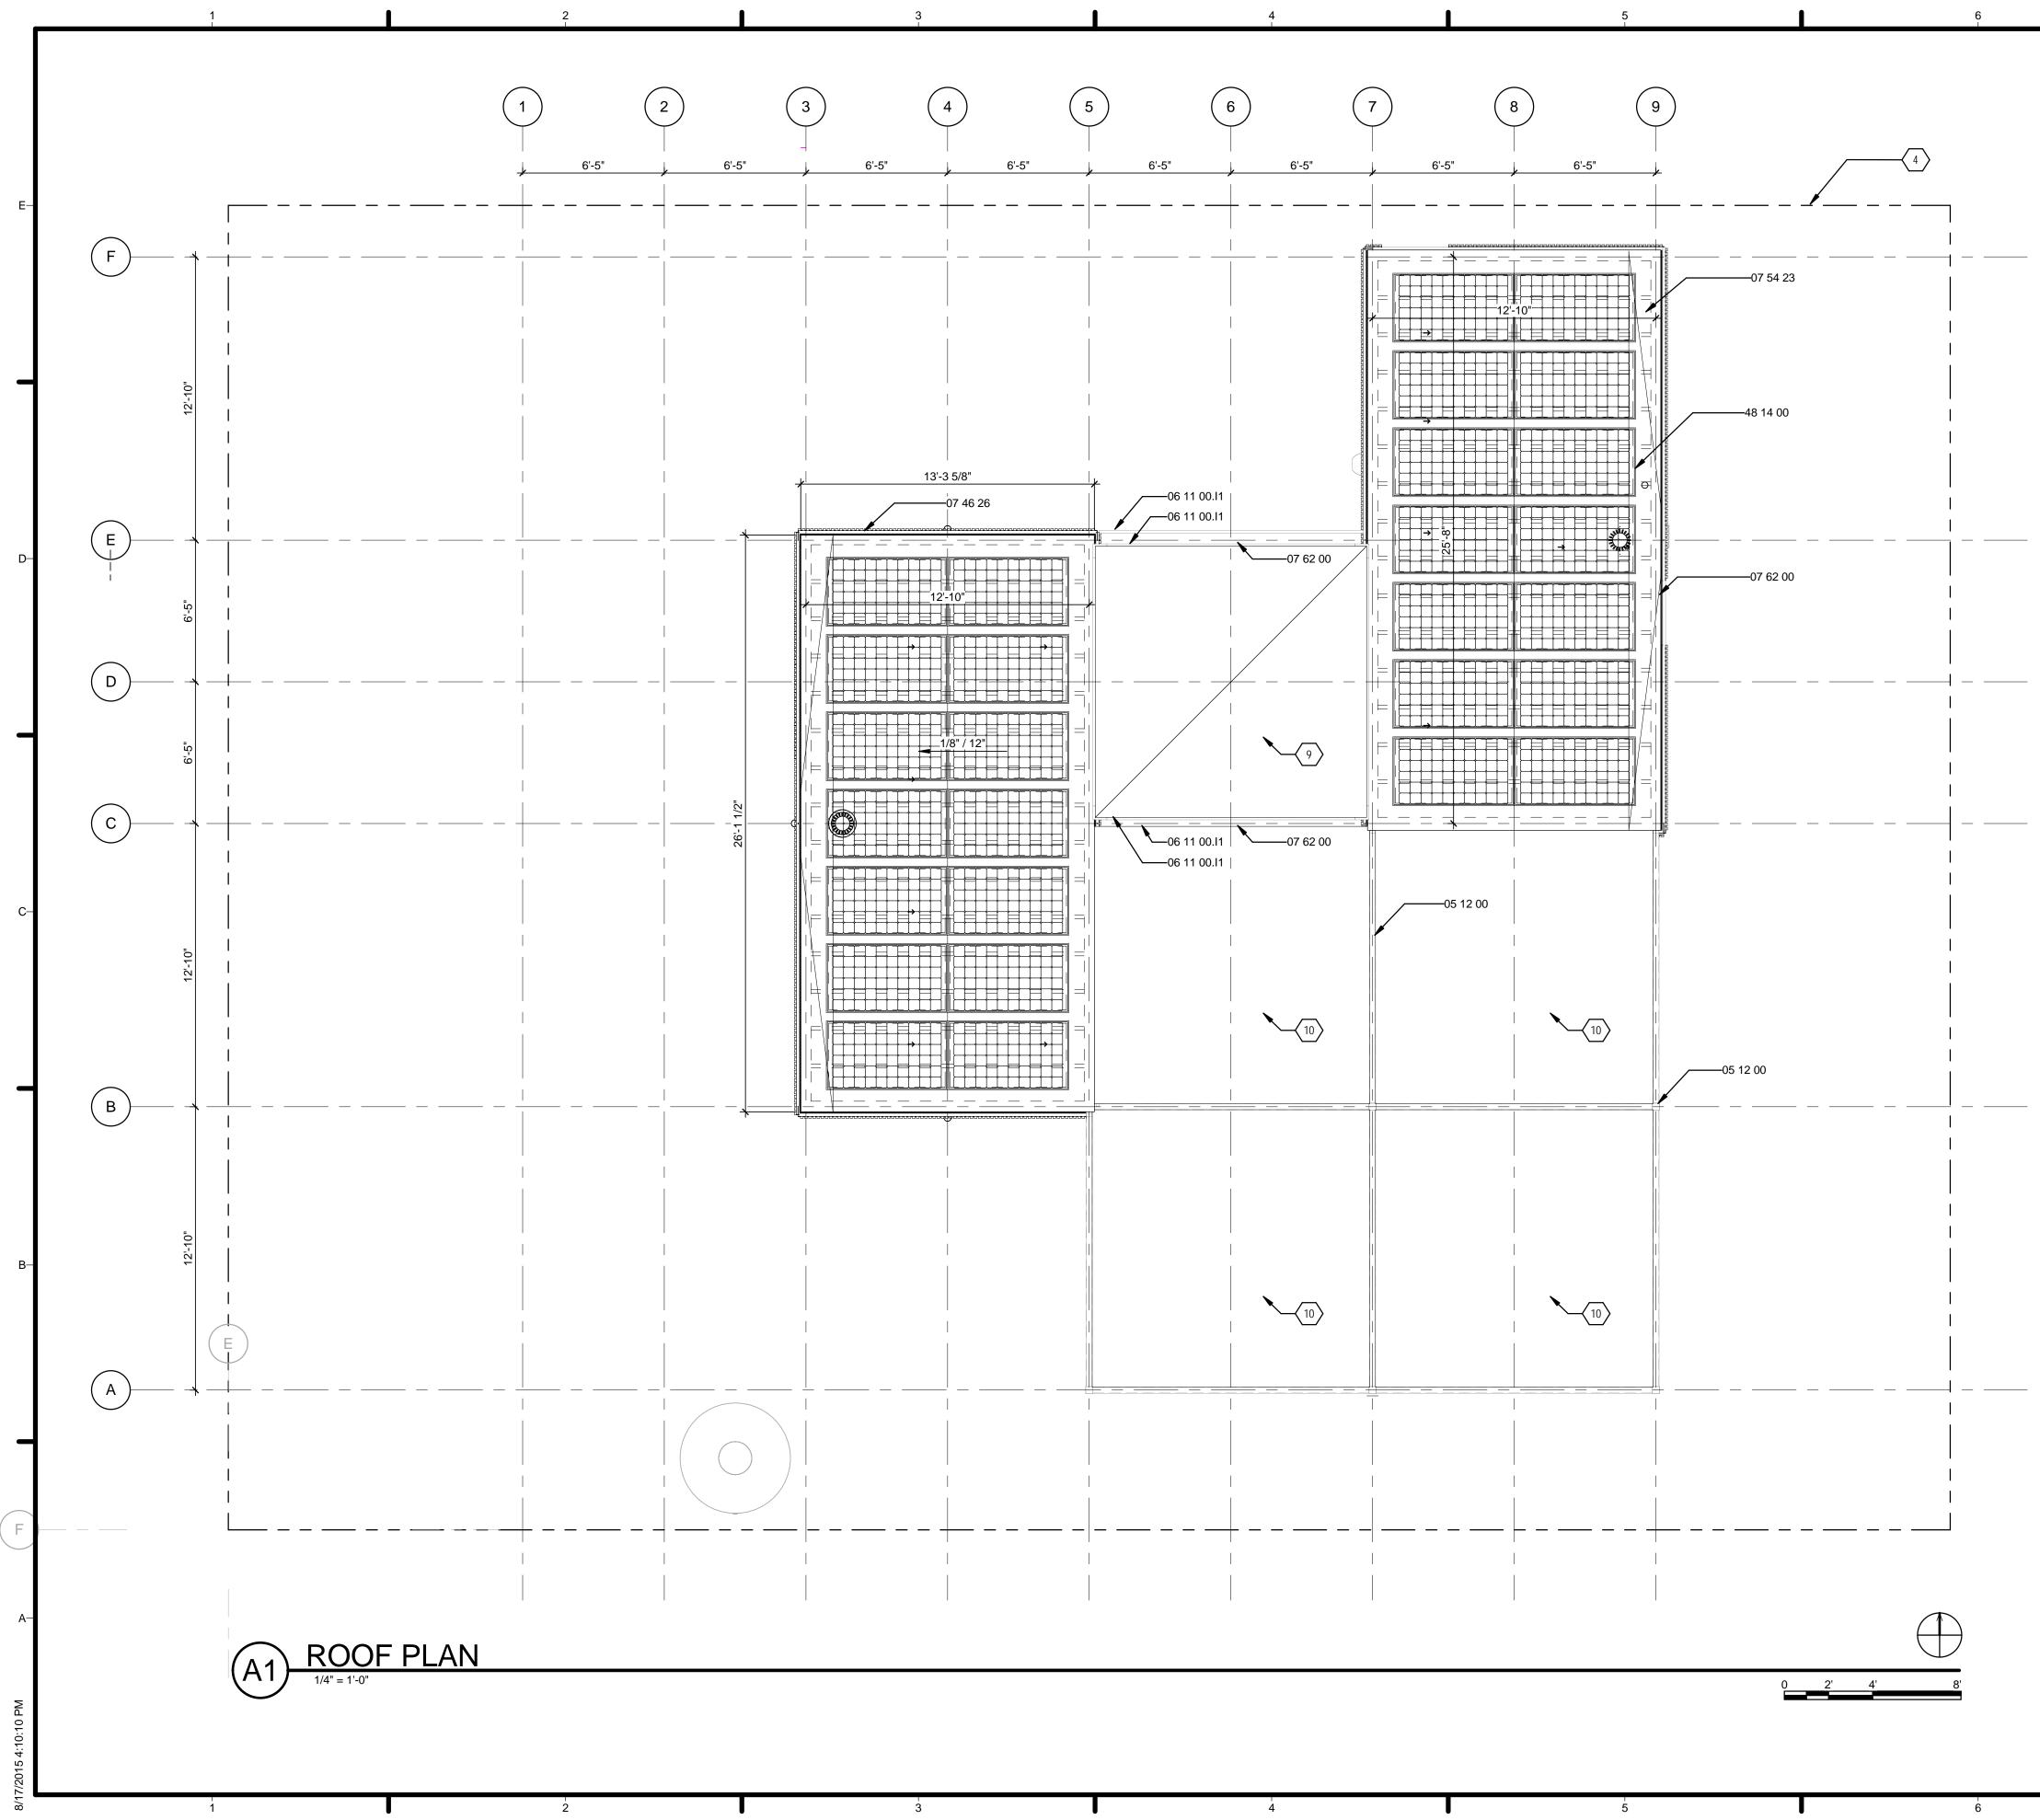


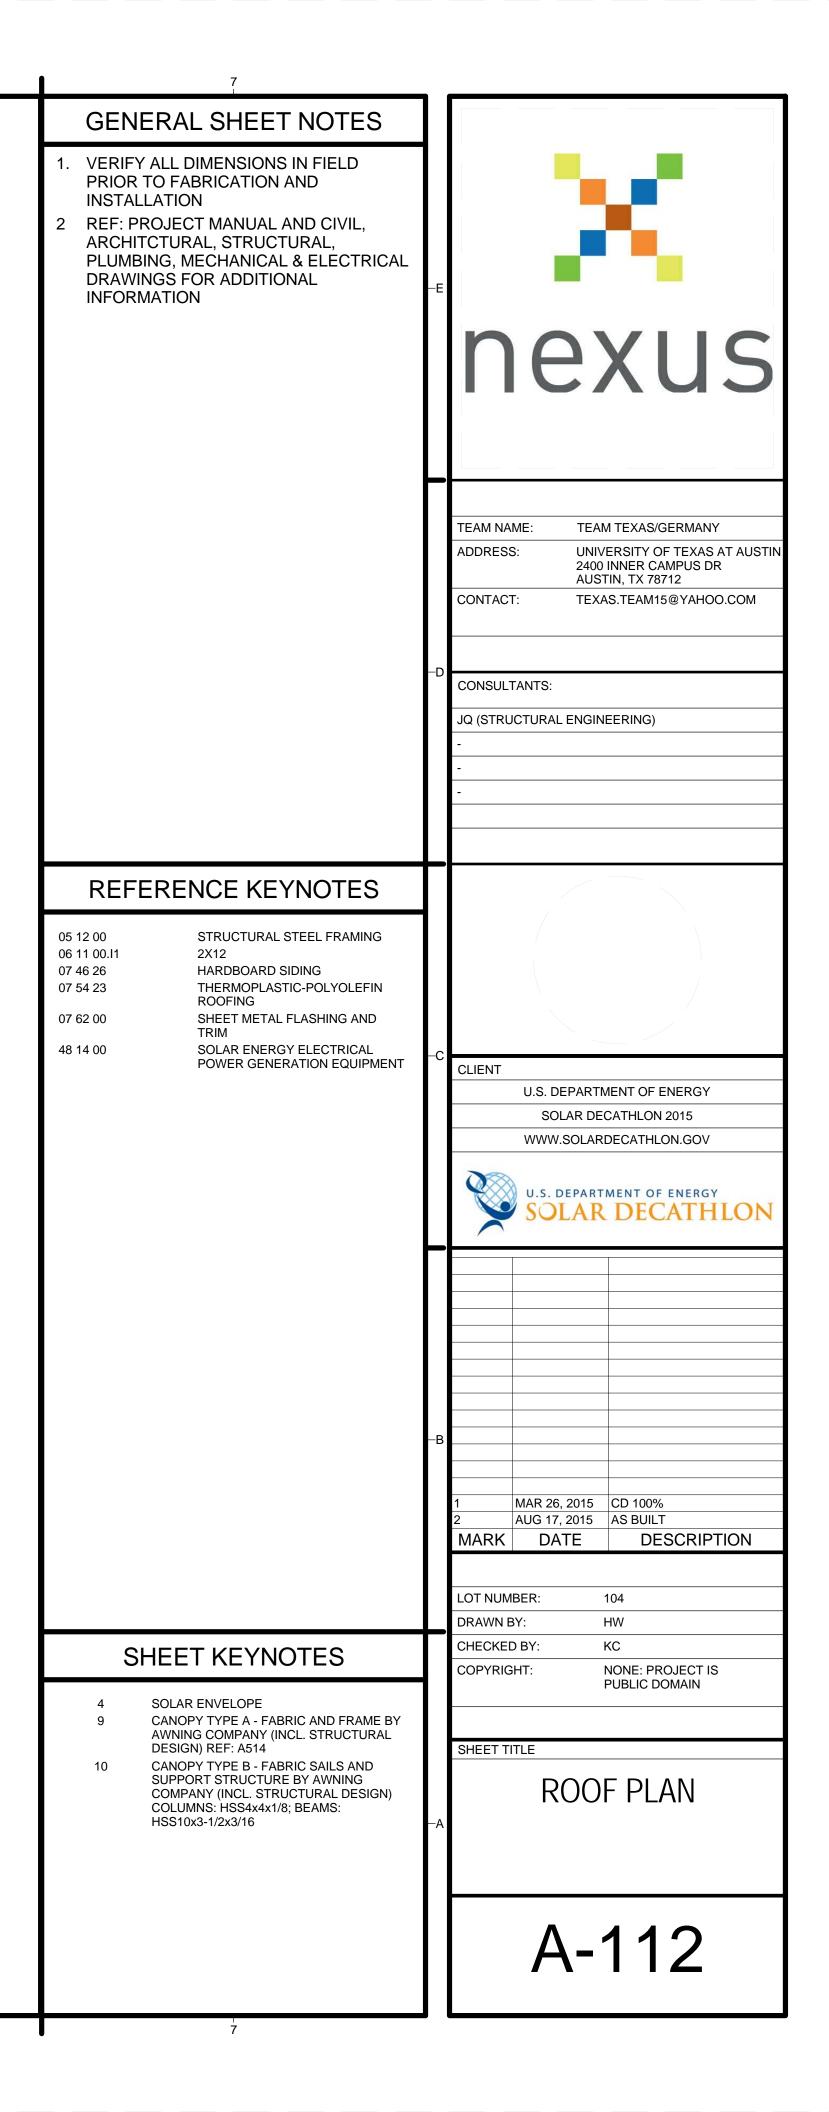


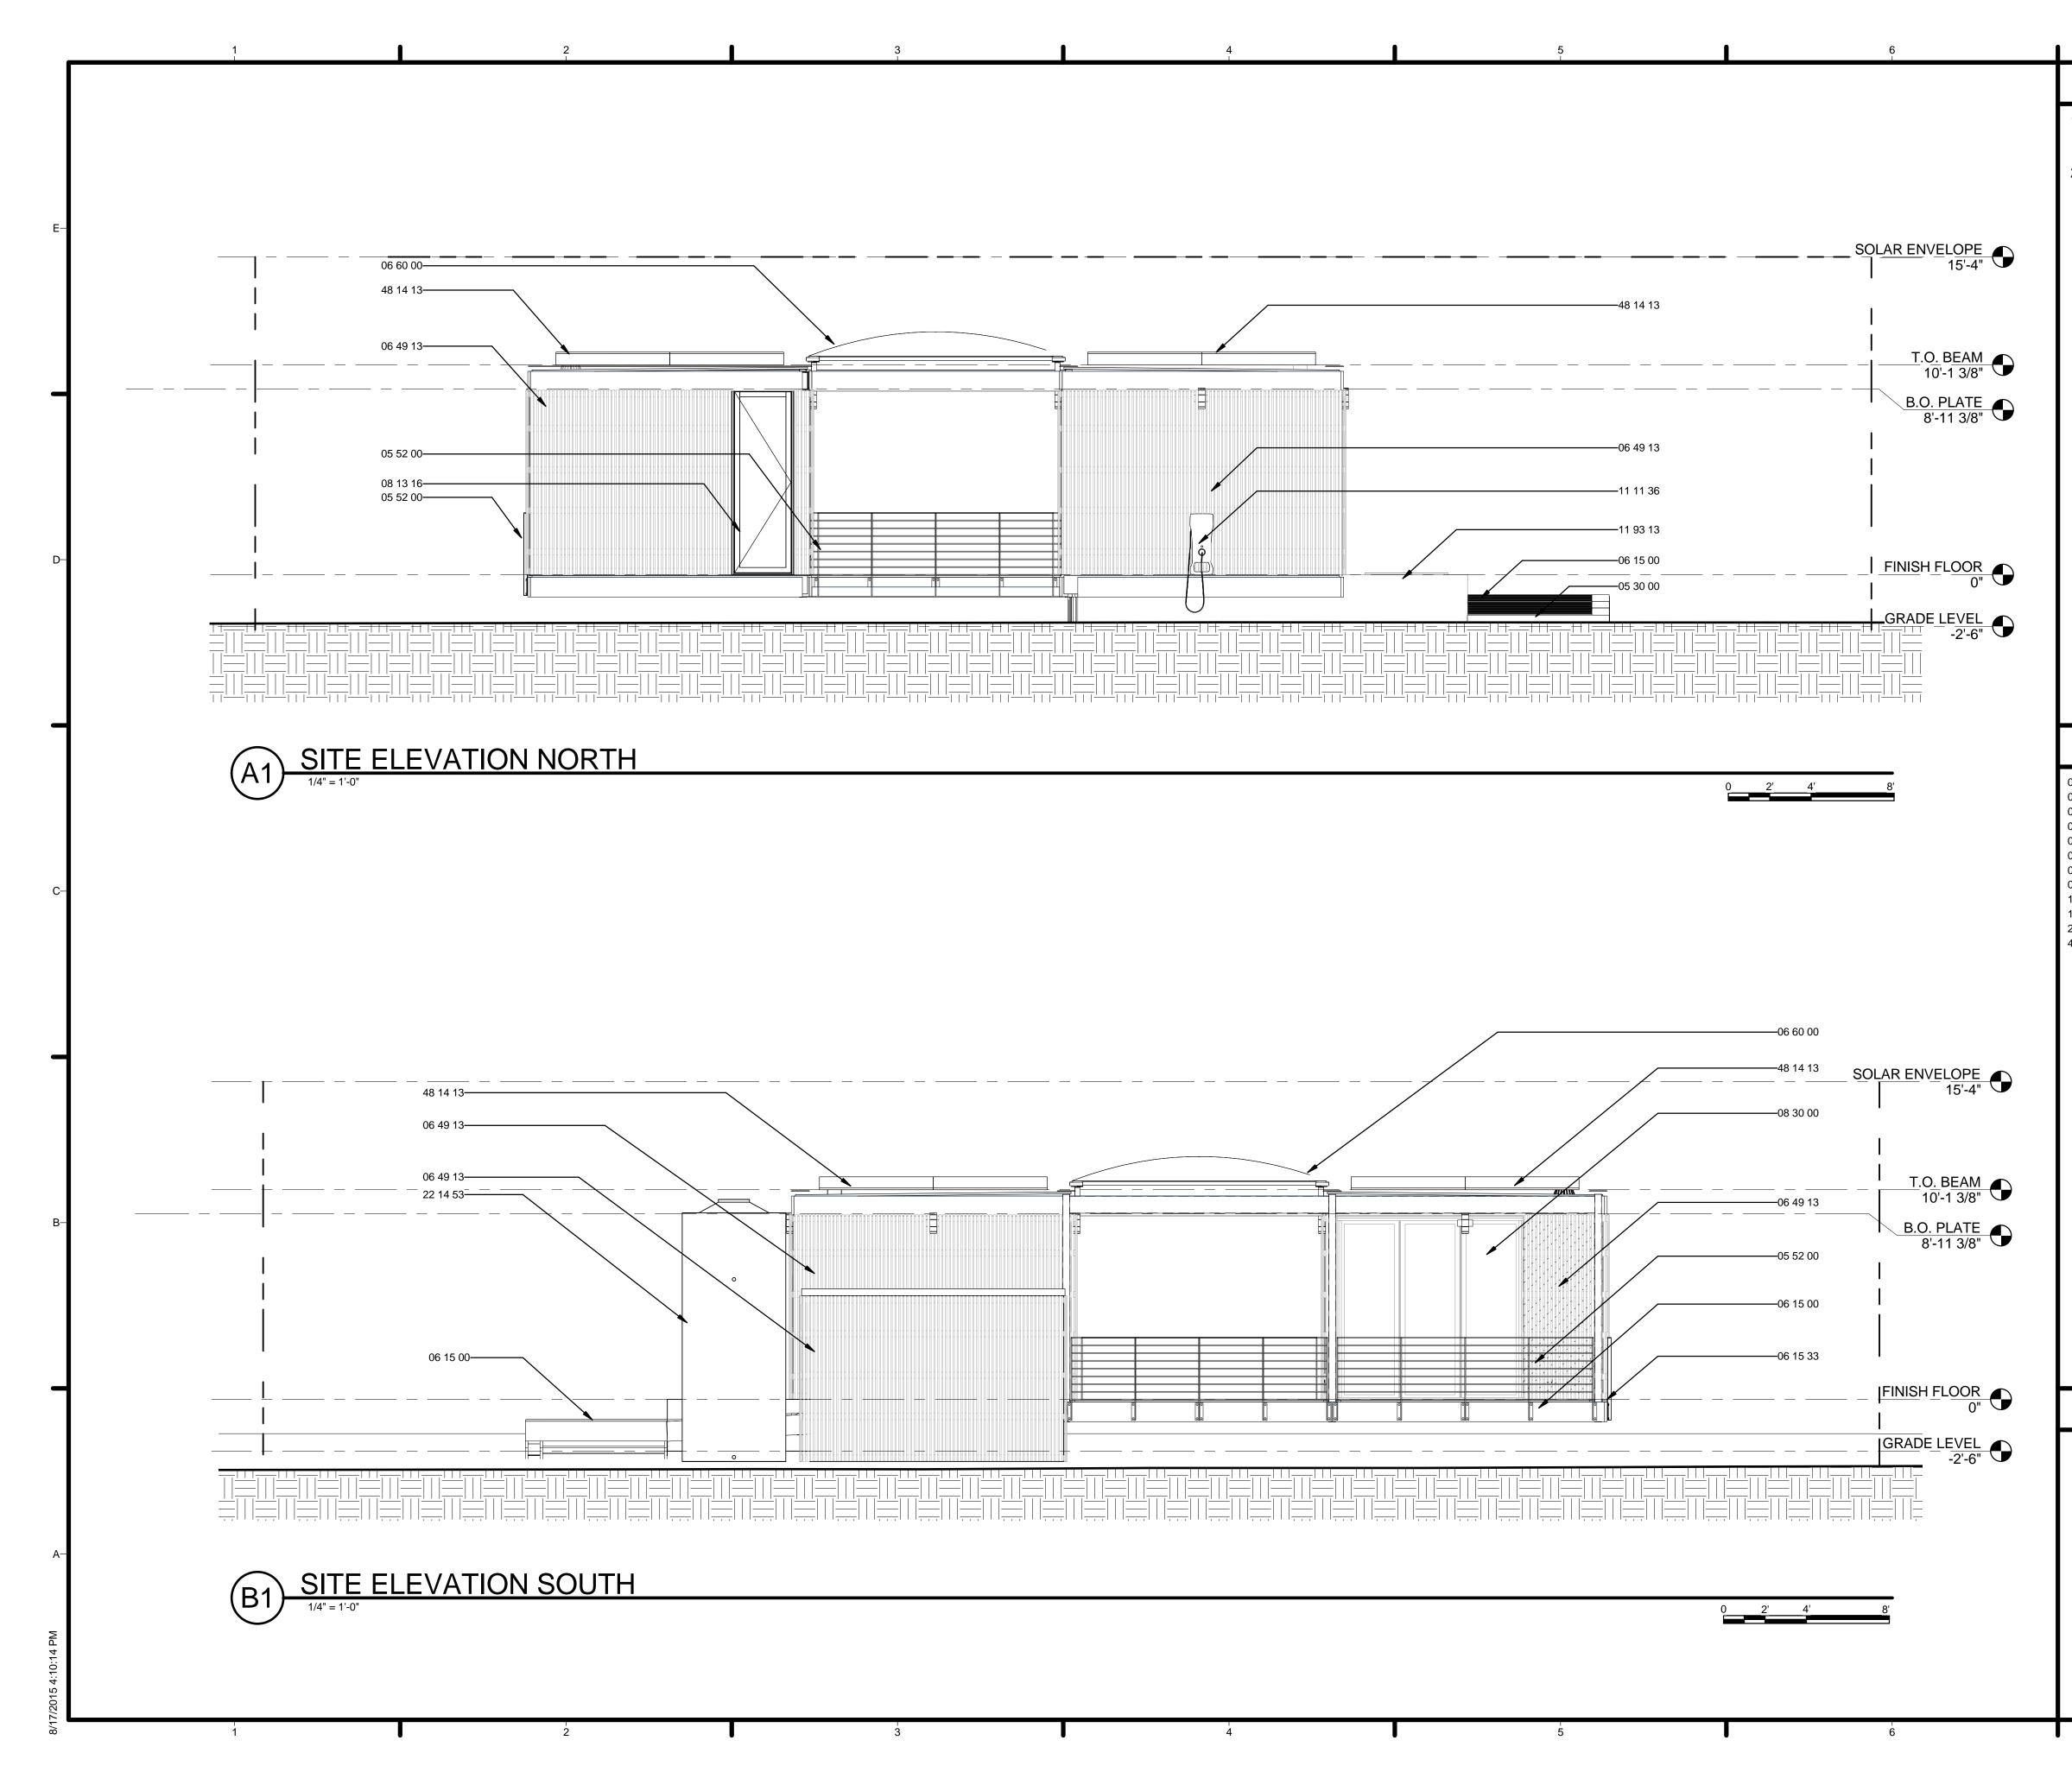


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GENERAL SHEET NOTES		
 VERIFY ALL DIMENSIONS IN FIELD PRIOR TO FABRICATION AND INSTALLATION REF: PROJECT MANUAL AND CIVIL, ARCHITCTURAL, STRUCTURAL, PLUMBING, MECHANICAL & ELECTRICAL DRAWINGS FOR ADDITIONAL INFORMATION 	–E	nexus
	-D	TEAM NAME: TEAM TEXAS/GERMANY ADDRESS: UNIVERSITY OF TEXAS AT AUSTIN 2400 INNER CAMPUS DR AUSTIN, TX 78712 CONTACT: TEXAS.TEAM15@YAHOO.COM CONSULTANTS: JQ (STRUCTURAL ENGINEERING) - - - - - - - - - - - -
REFERENCE KEYNOTES		
05 30 00METAL DECKING05 52 00METAL RAILINGS06 15 00WOOD DECKING06 15 33WOOD PATIO DECKING06 49 13WOOD SCREENS06 60 00PLASTIC FABRICATIONS08 13 16ALUMINUM DOORS08 30 00SPECIALTY DOORS AND FRAMES11 11 36VEHICLE CHARGING EQUIPMENT11 93 13HYDROPONIC GROWING SYSTEMS22 14 53RAINWATER STORAGE TANKS48 14 13SOLAR ENERGY COLLECTORS	-c	CLIENT U.S. DEPARTMENT OF ENERGY SOLAR DECATHLON 2015 WWW.SOLARDECATHLON.GOV
	—В	I MAR 26, 2015 CD 100% 2 AUG 17, 2015 AS BUILT MARK DATE DESCRIPTION LOT NUMBER: 104 DRAWN BY: HW
SHEET KEYNOTES	T	CHECKED BY: KC COPYRIGHT: NONE: PROJECT IS
	-A	SHEET TITLE SITE ELEVATIONS
7		A-201

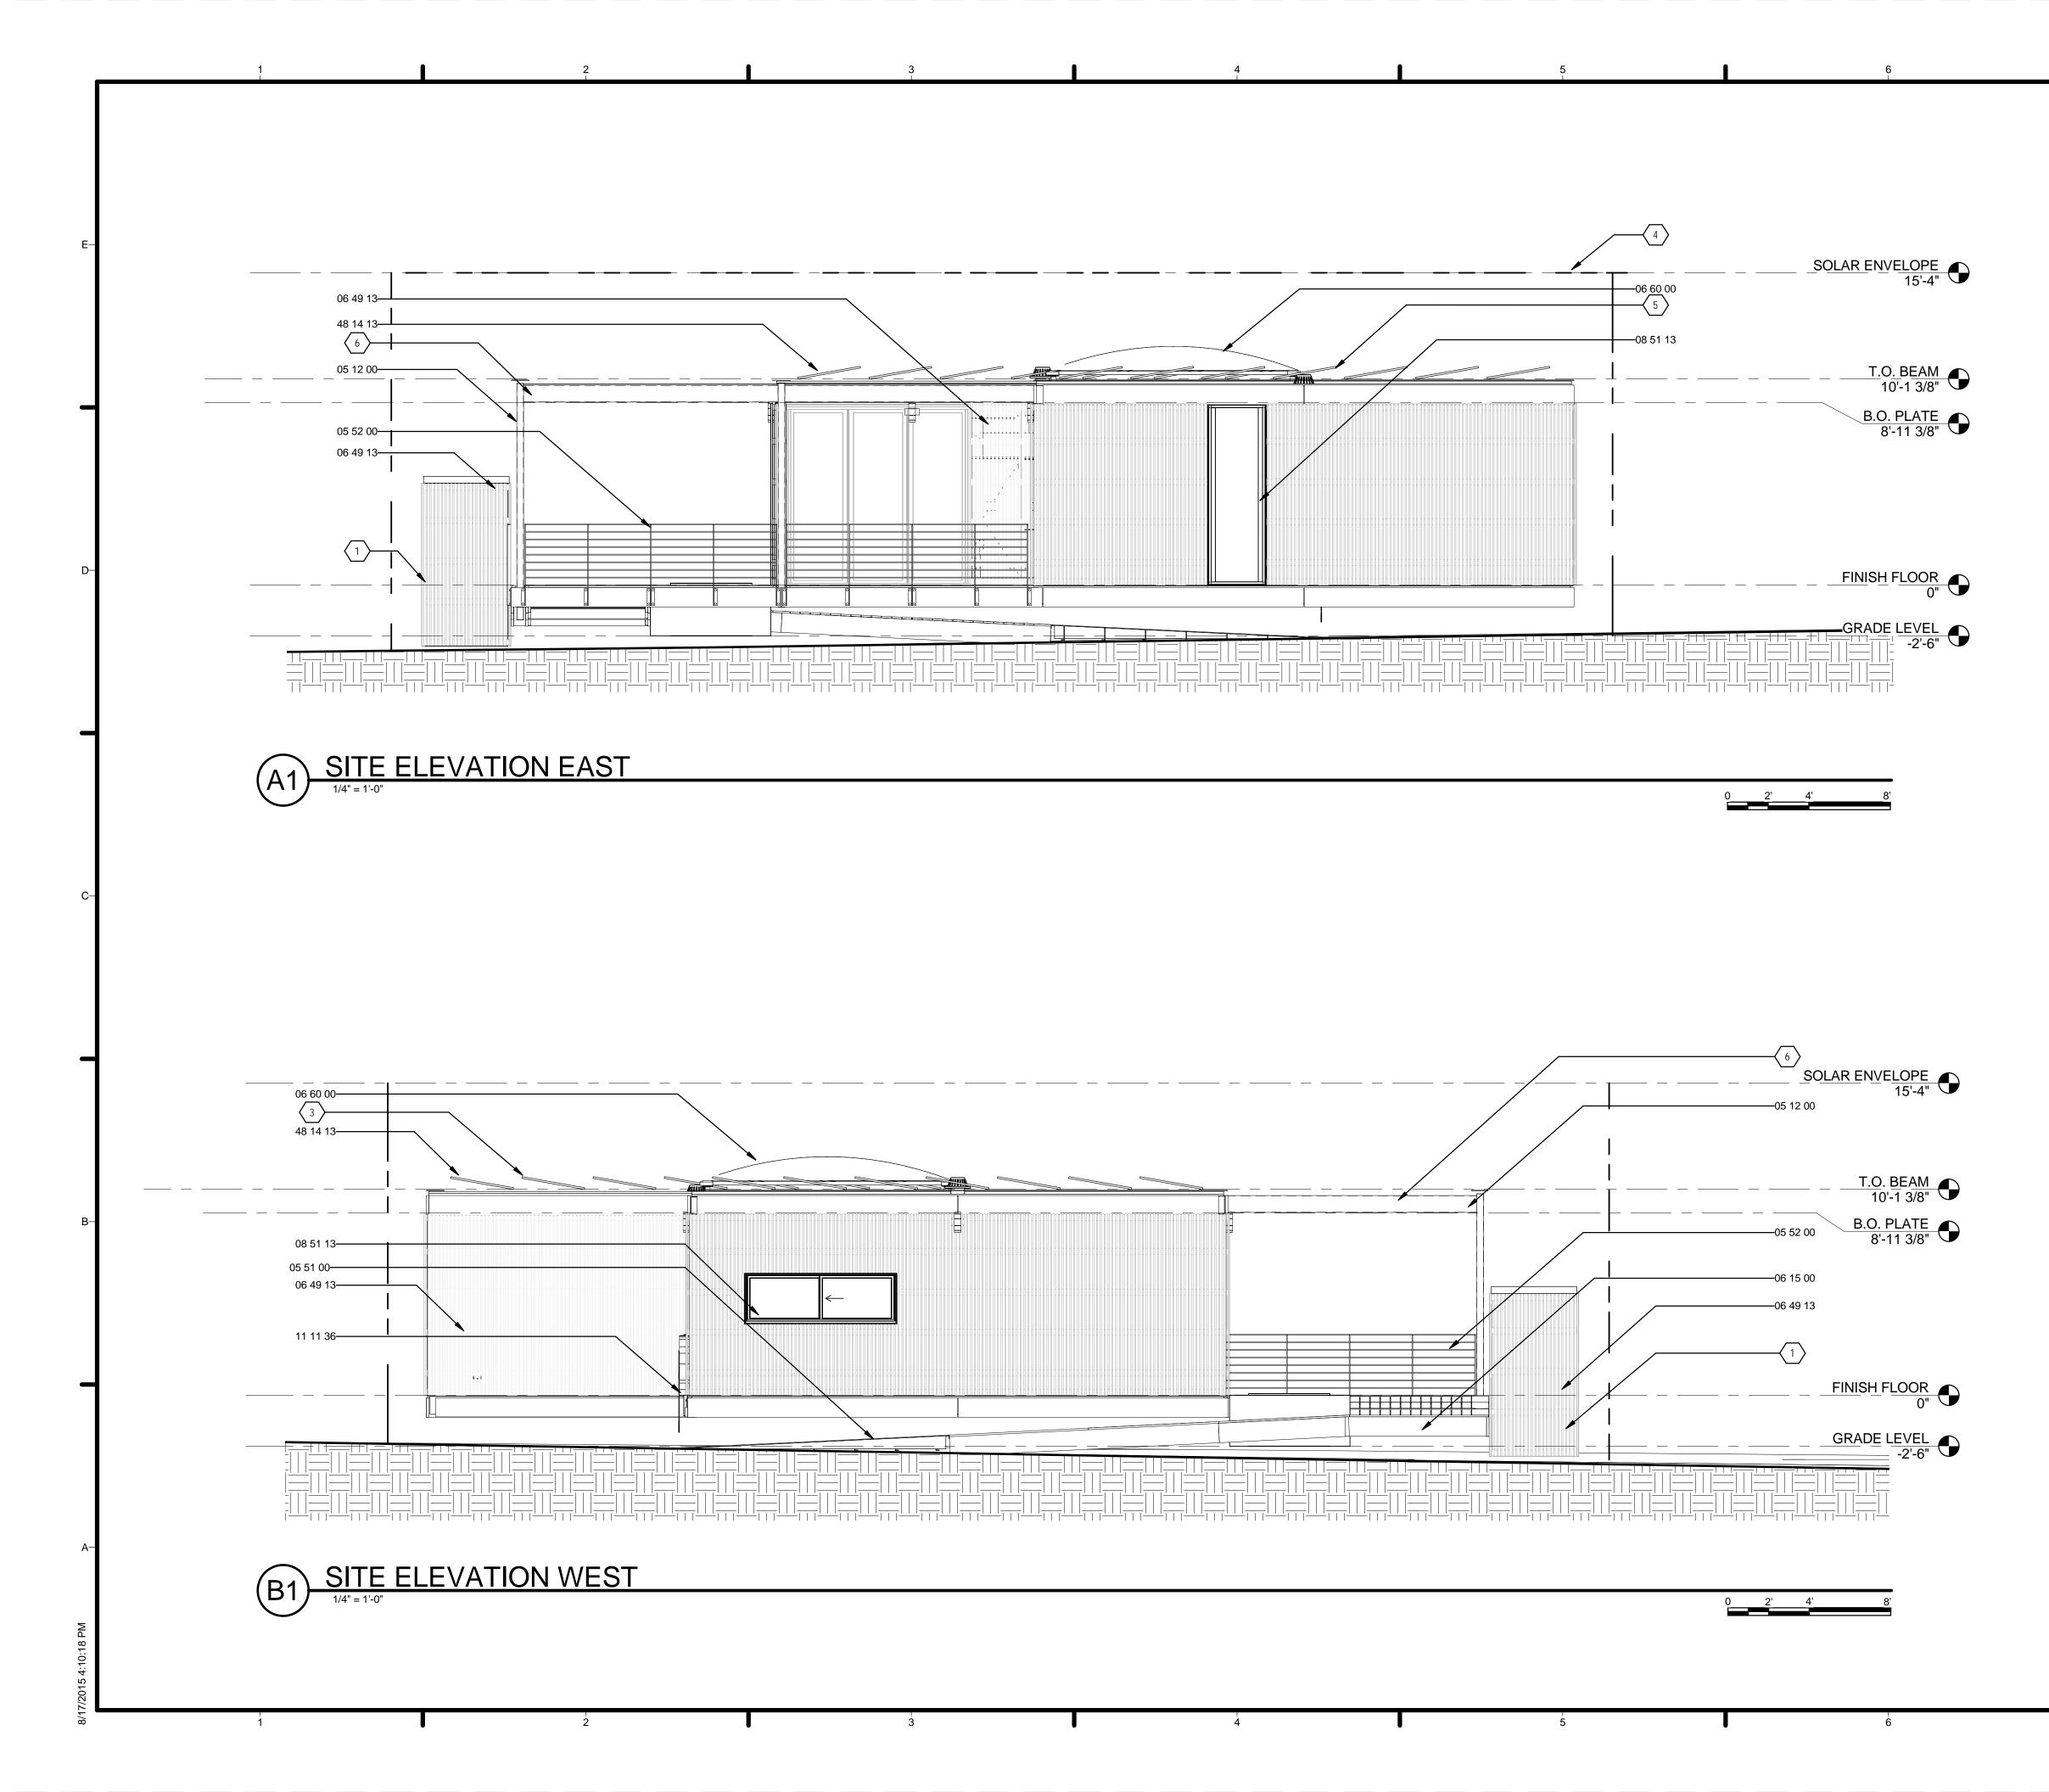


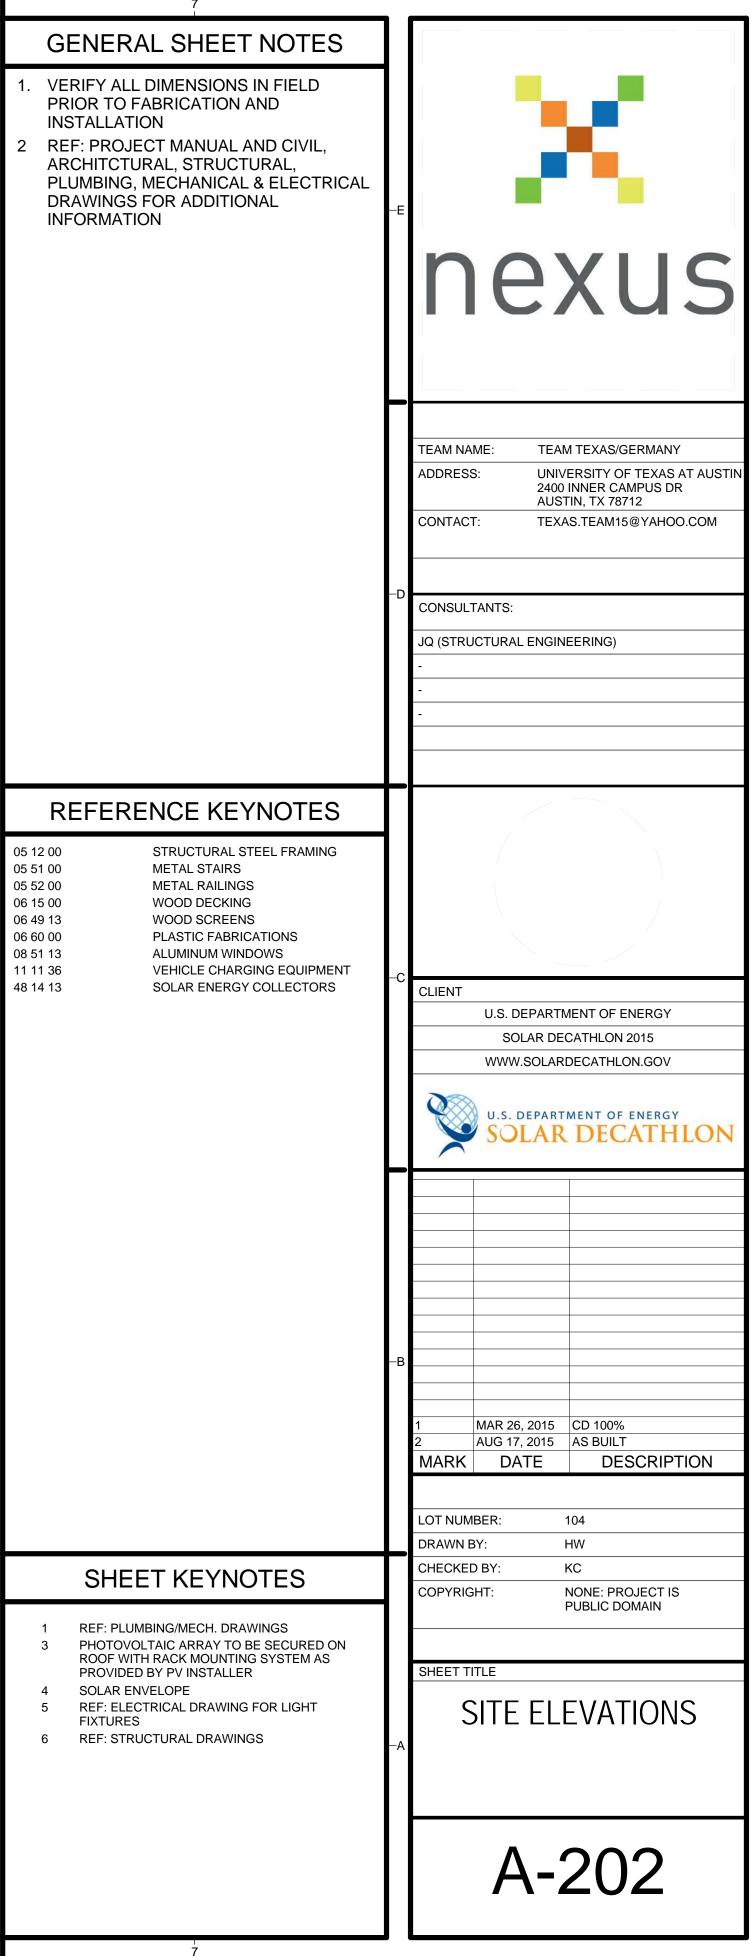


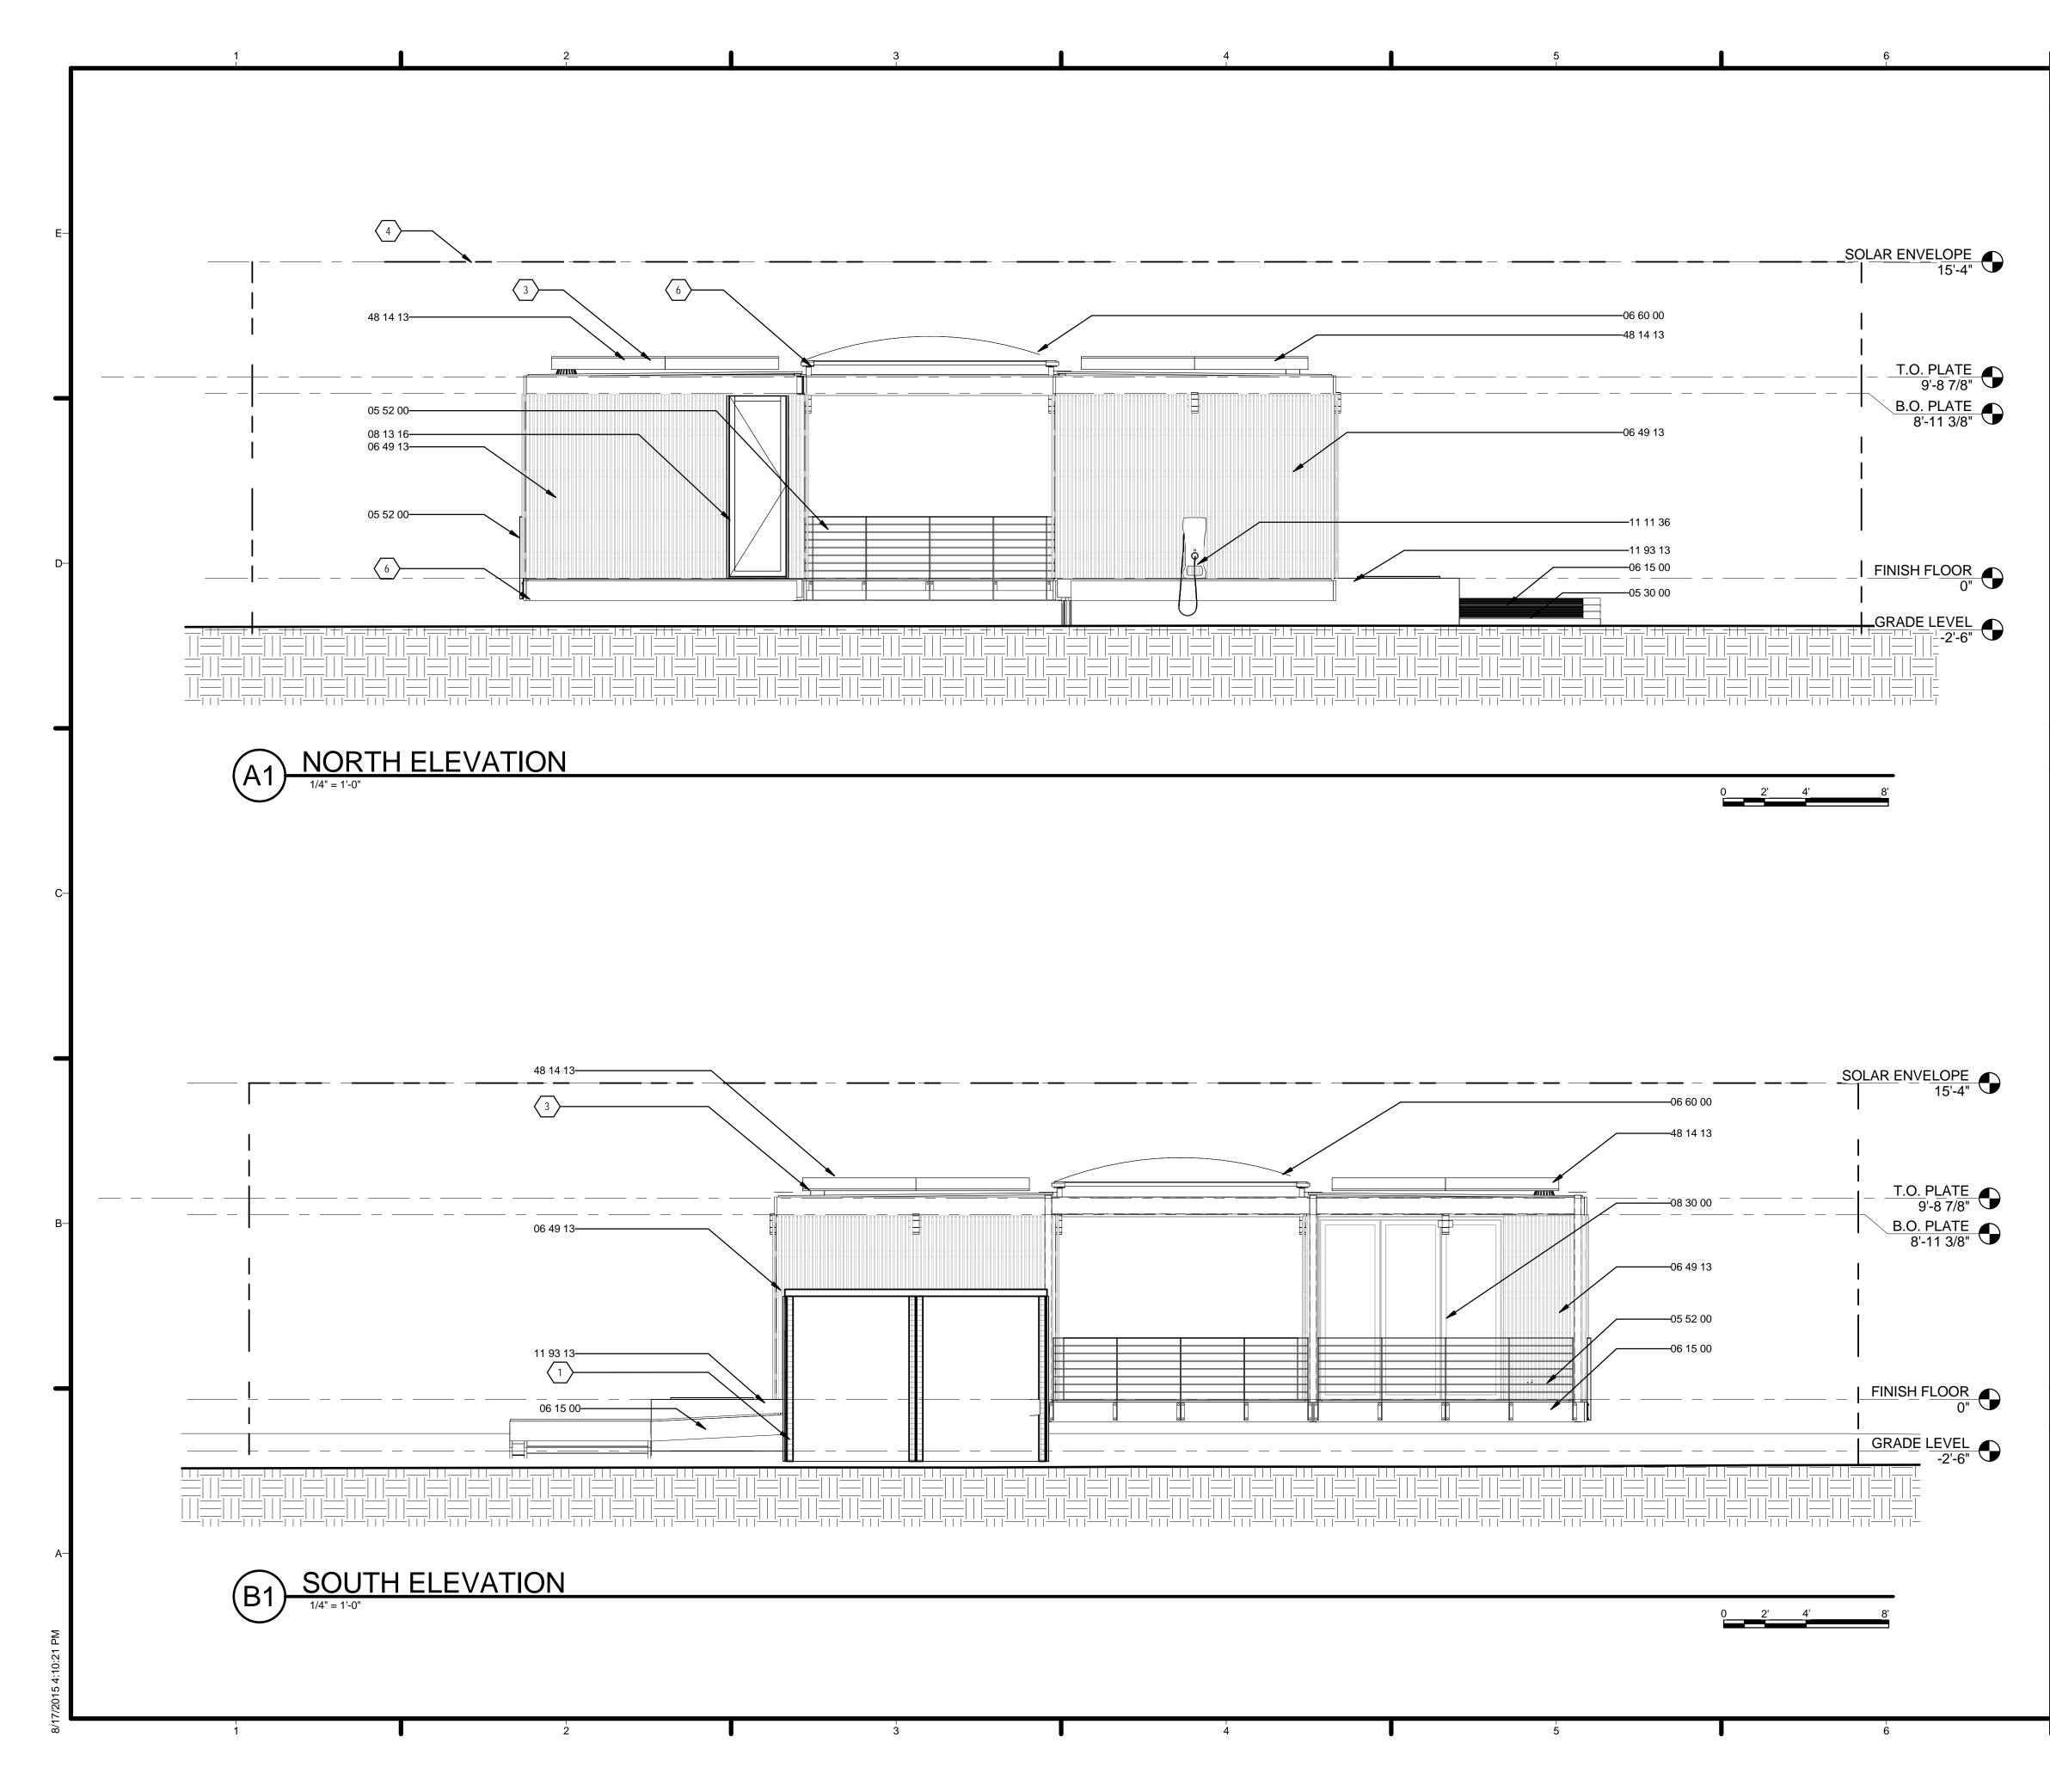

GENERAL SHEET NOTES		
 VERIFY ALL DIMENSIONS IN FIELD PRIOR TO FABRICATION AND INSTALLATION REF: PROJECT MANUAL AND CIVIL, ARCHITCTURAL, STRUCTURAL, PLUMBING, MECHANICAL & ELECTRICAL DRAWINGS FOR ADDITIONAL INFORMATION 	-E	nexus
		TEAM NAME:TEAM TEXAS/GERMANYADDRESS:UNIVERSITY OF TEXAS AT AUSTIN 2400 INNER CAMPUS DR AUSTIN, TX 78712CONTACT:TEXAS.TEAM15@YAHOO.COM
	-D	CONSULTANTS:
		JQ (STRUCTURAL ENGINEERING)
		-
		-
REFERENCE KEYNOTES		
05 30 00METAL DECKING05 52 00METAL RAILINGS06 15 00WOOD DECKING06 49 13WOOD SCREENS06 60 00PLASTIC FABRICATIONS08 13 16ALUMINUM DOORS08 30 00SPECIALTY DOORS AND FRAMES14 14 20METAL DECKING FOLLIPMENT		
11 11 36VEHICLE CHARGING EQUIPMENT11 93 13HYDROPONIC GROWING SYSTEMS48 14 13SOLAR ENERGY COLLECTORS	–C	
		U.S. DEPARTMENT OF ENERGY SOLAR DECATHLON 2015
	_	U.S. DEPARTMENT OF ENERGY SOLAR DECATHLON
	—В	
		1 MAR 26, 2015 CD 100% 2 AUG 17, 2015 AS BUILT MARK DATE DESCRIPTION
		LOT NUMBER: 104 DRAWN BY: HW
SHEET KEYNOTES		CHECKED BY: KC COPYRIGHT: NONE: PROJECT IS
1 REF: PLUMBING/MECH. DRAWINGS 3 PHOTOVOLTAIC ARRAY TO BE SECURED ON		PUBLIC DOMAIN
ROOF WITH RACK MOUNTING SYSTEM AS PROVIDED BY PV INSTALLER 4 SOLAR ENVELOPE		SHEET TITLE
6 REF: STRUCTURAL DRAWINGS		ELEVATIONS
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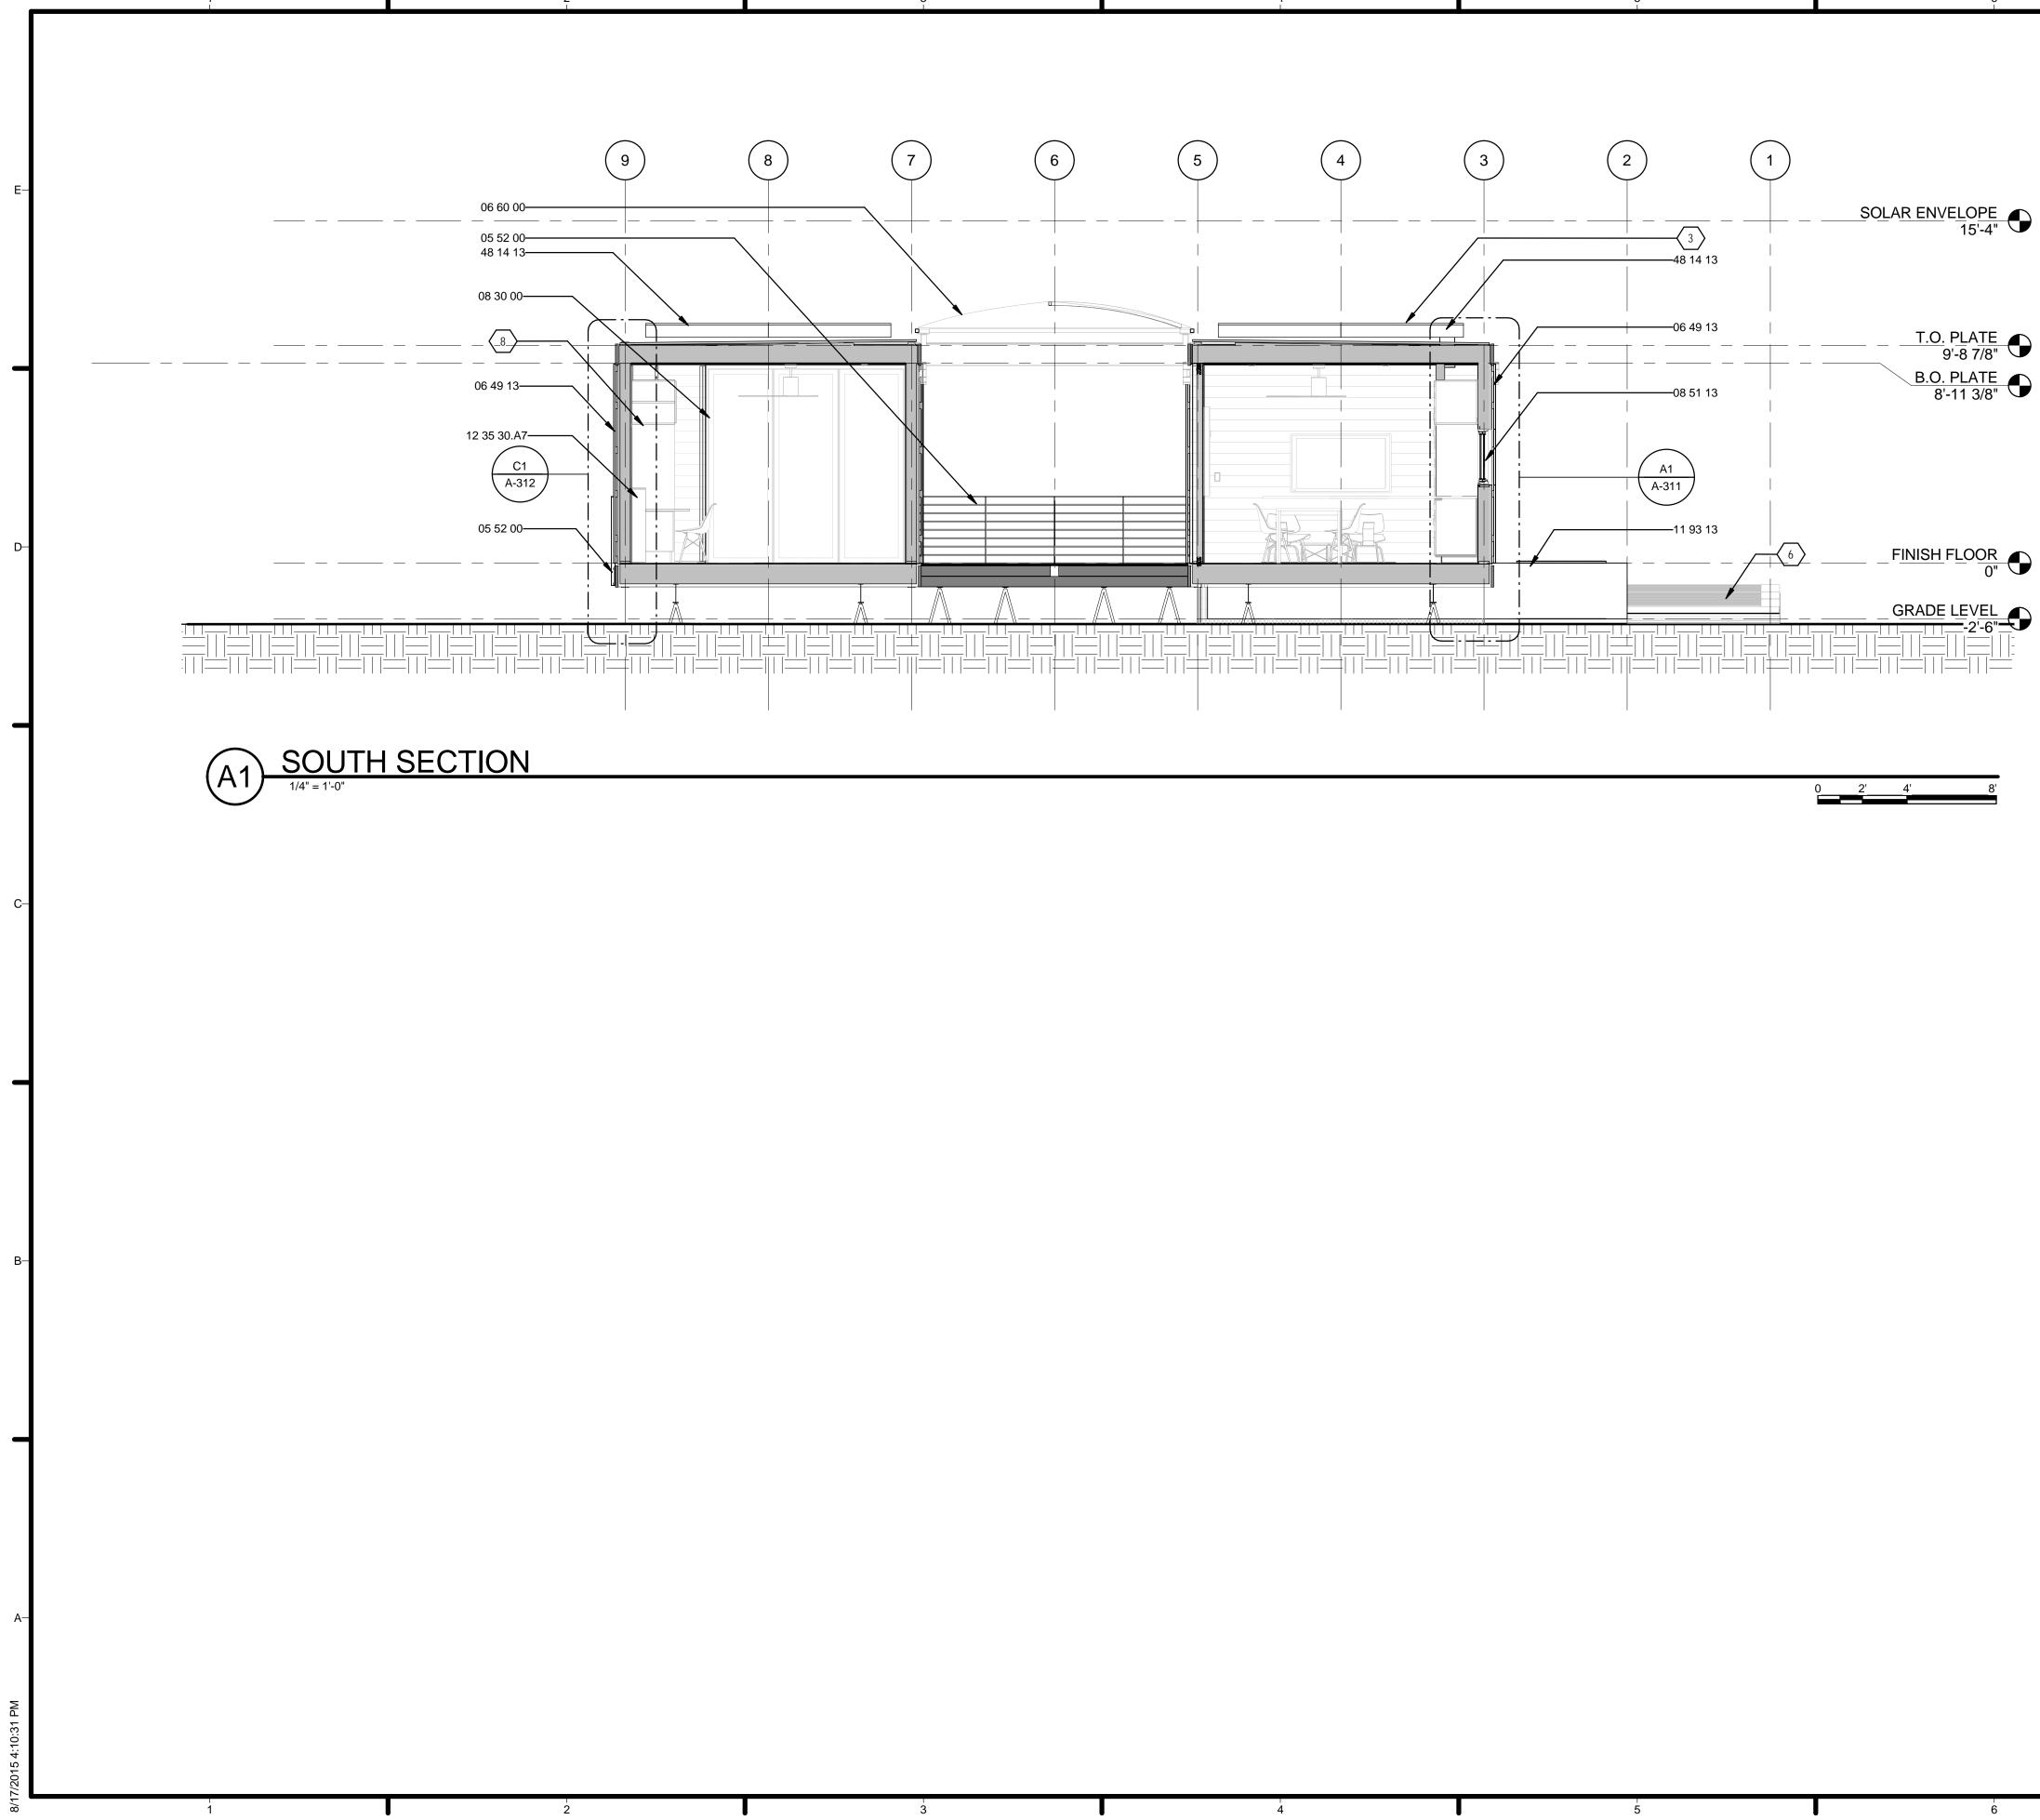


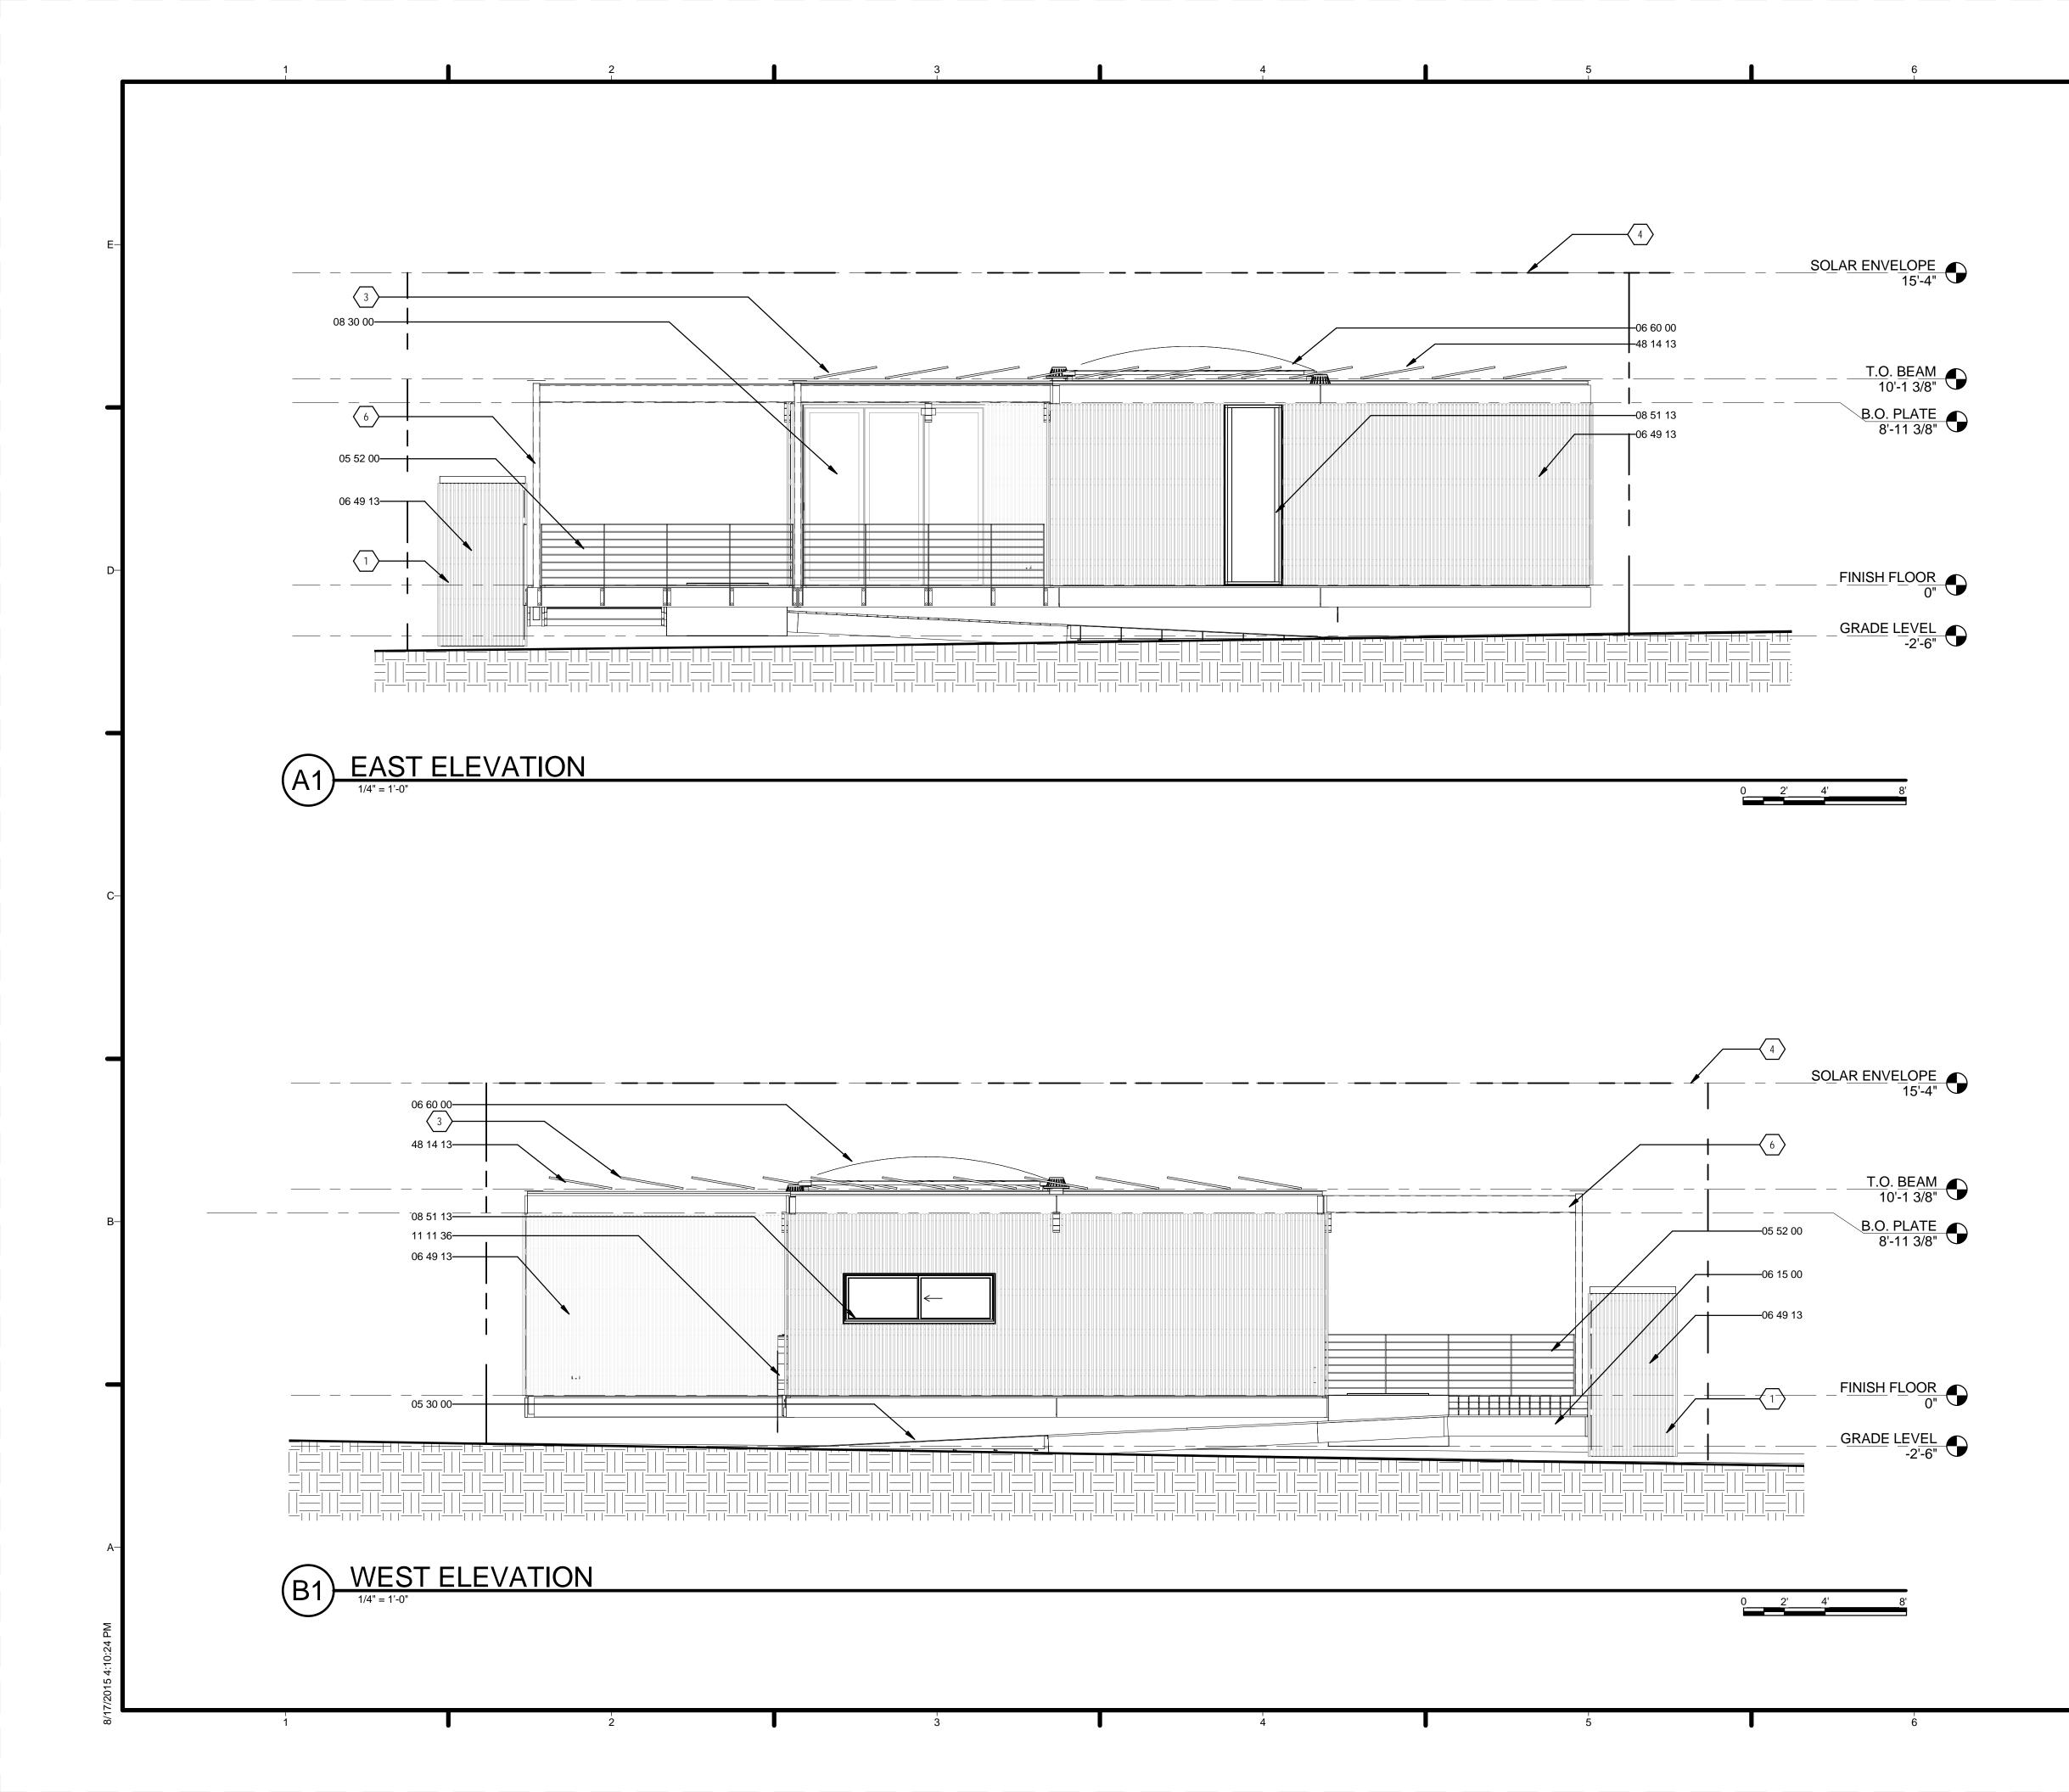


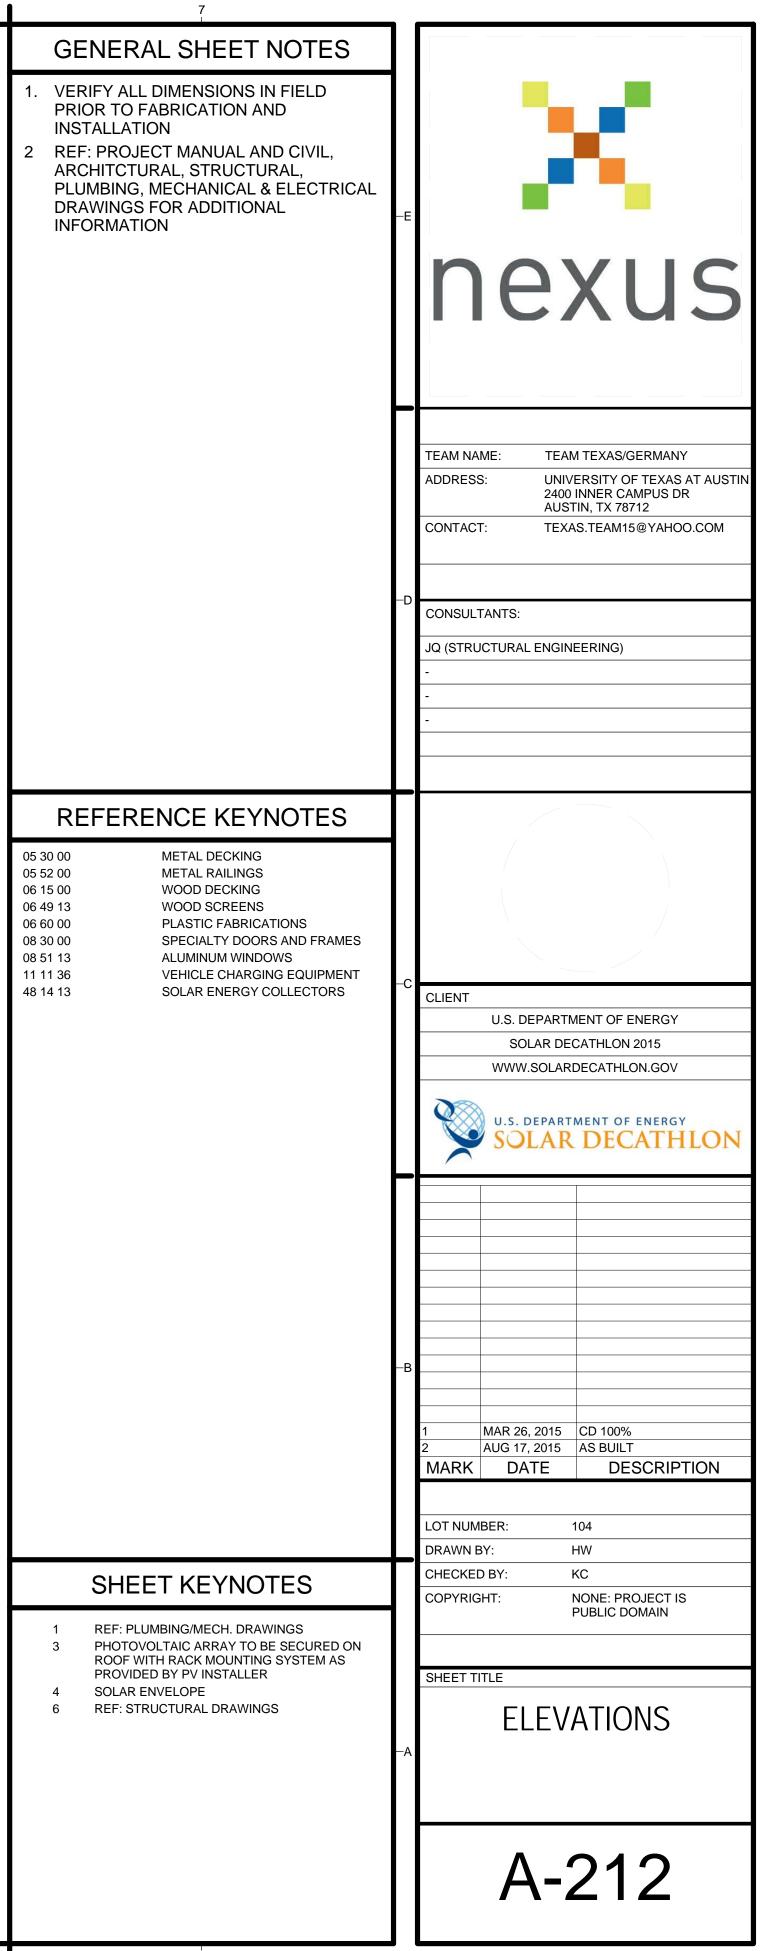

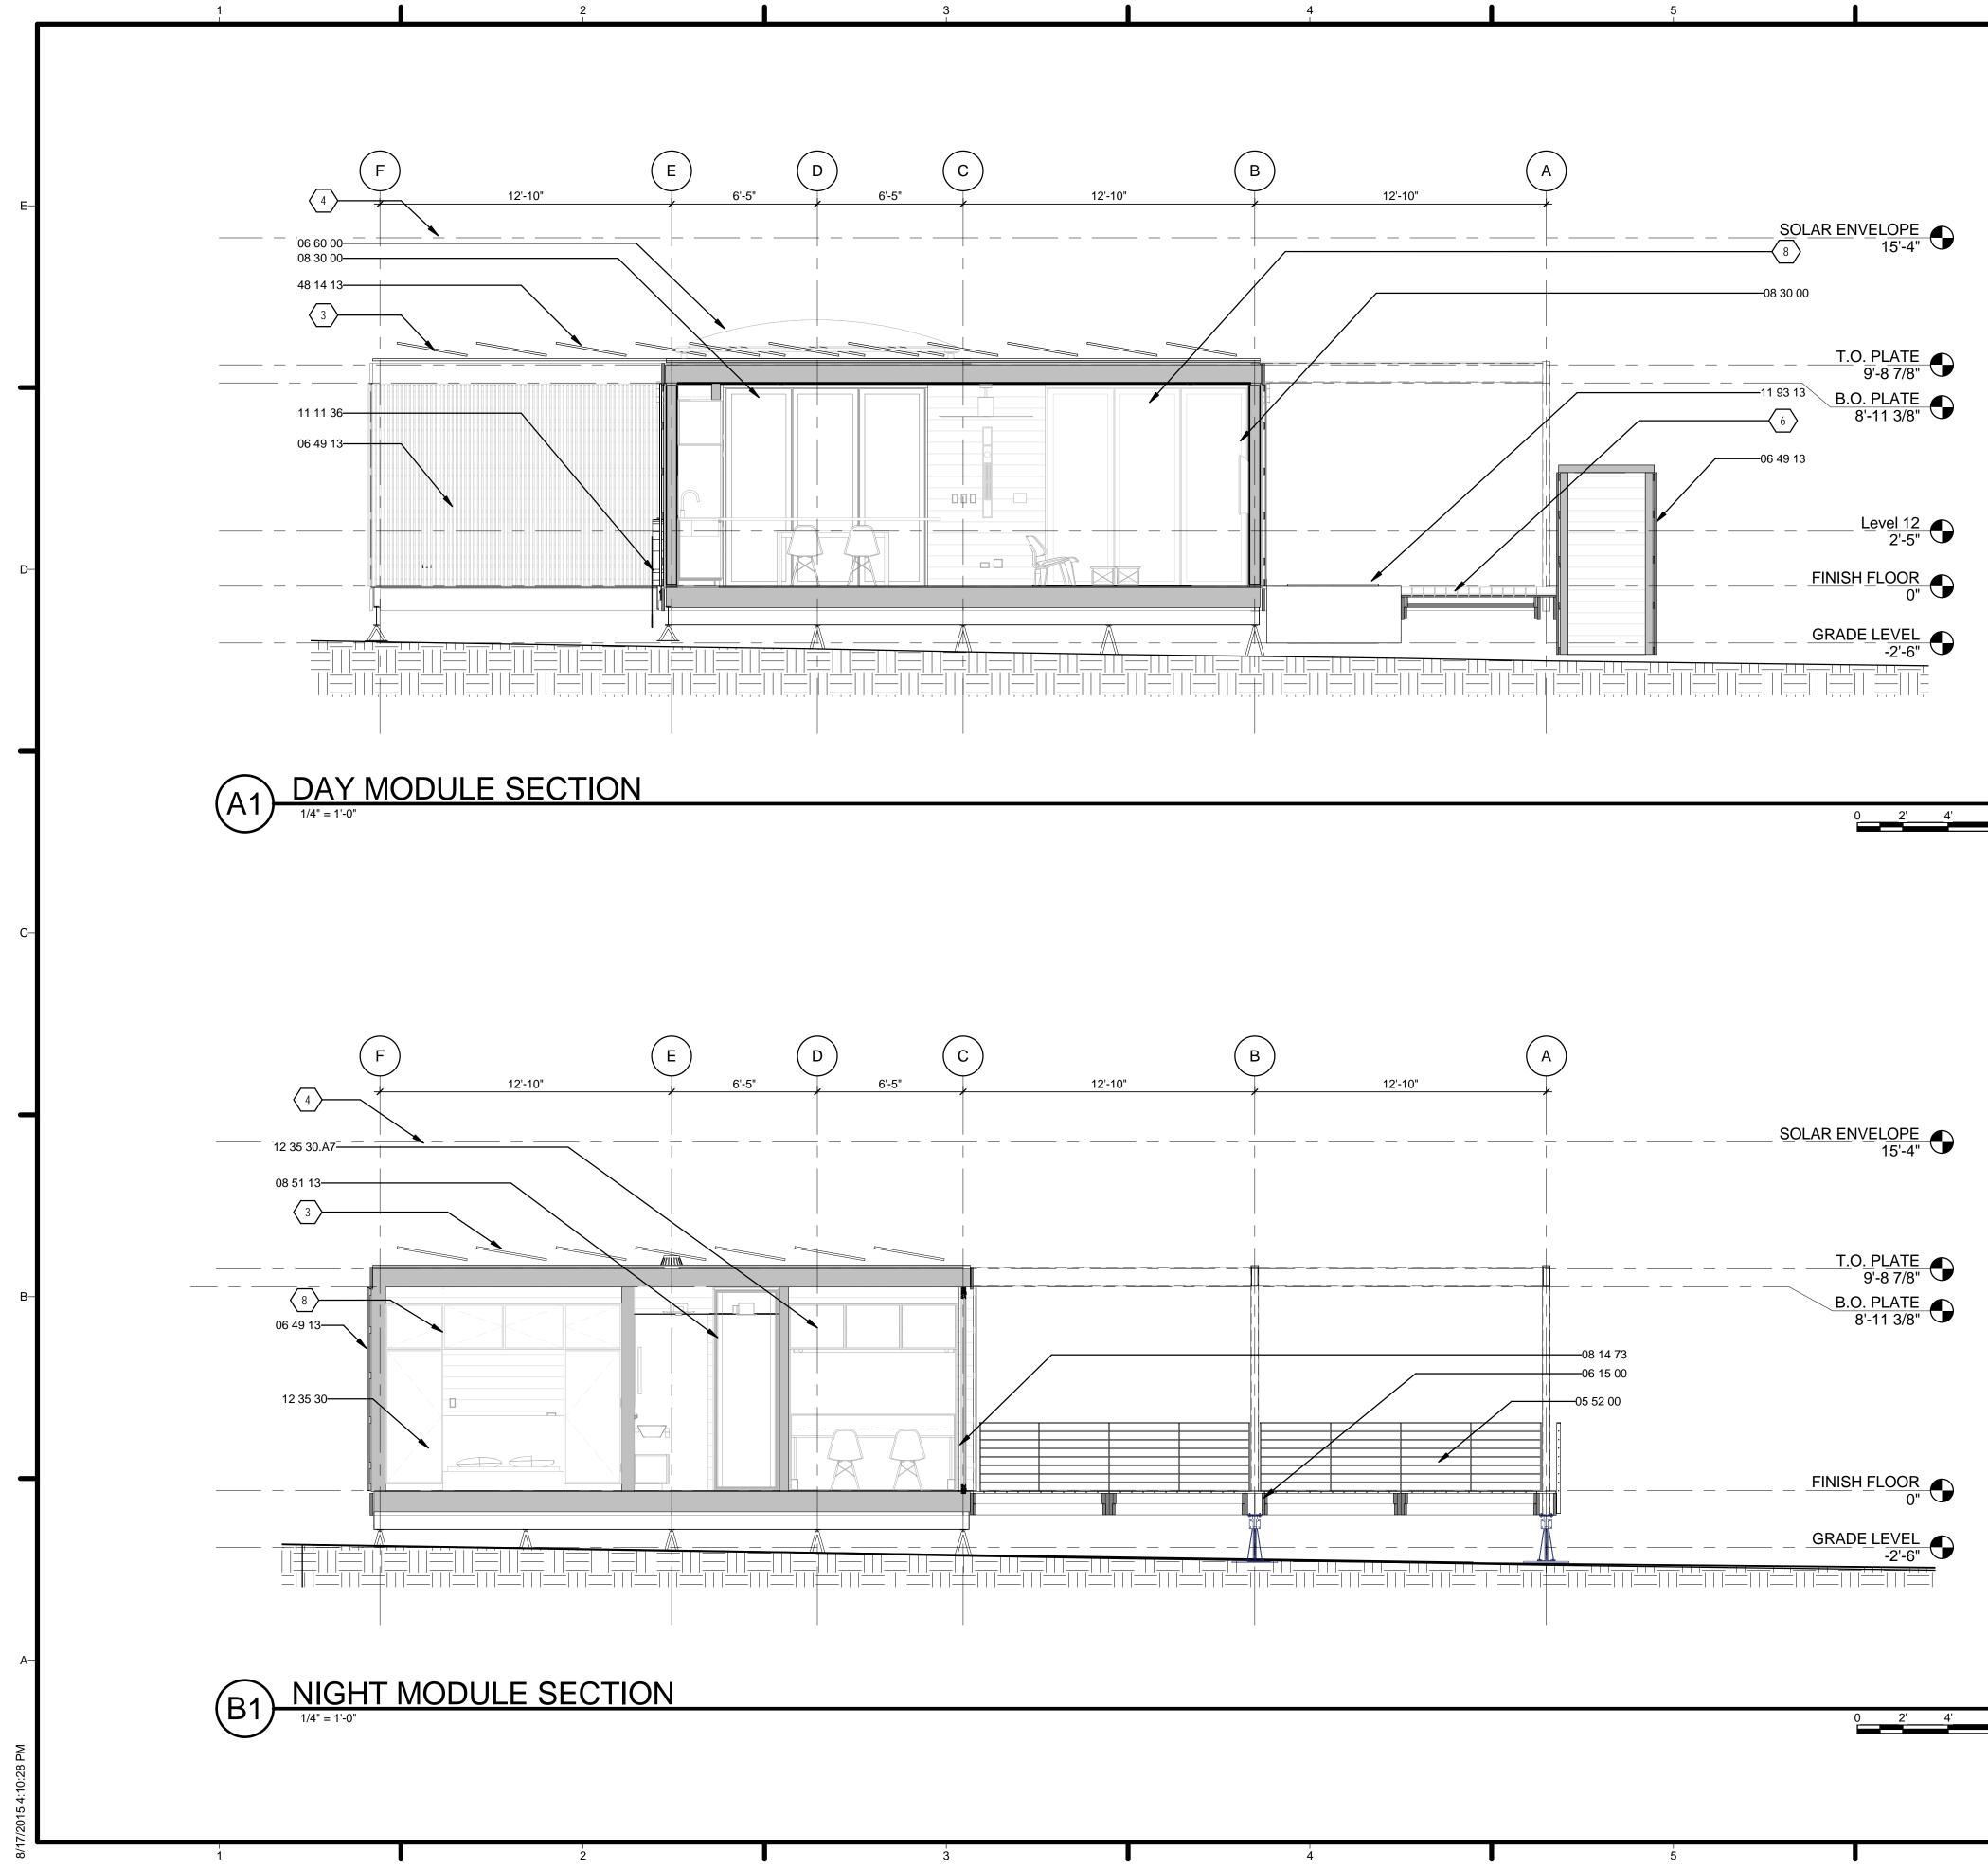
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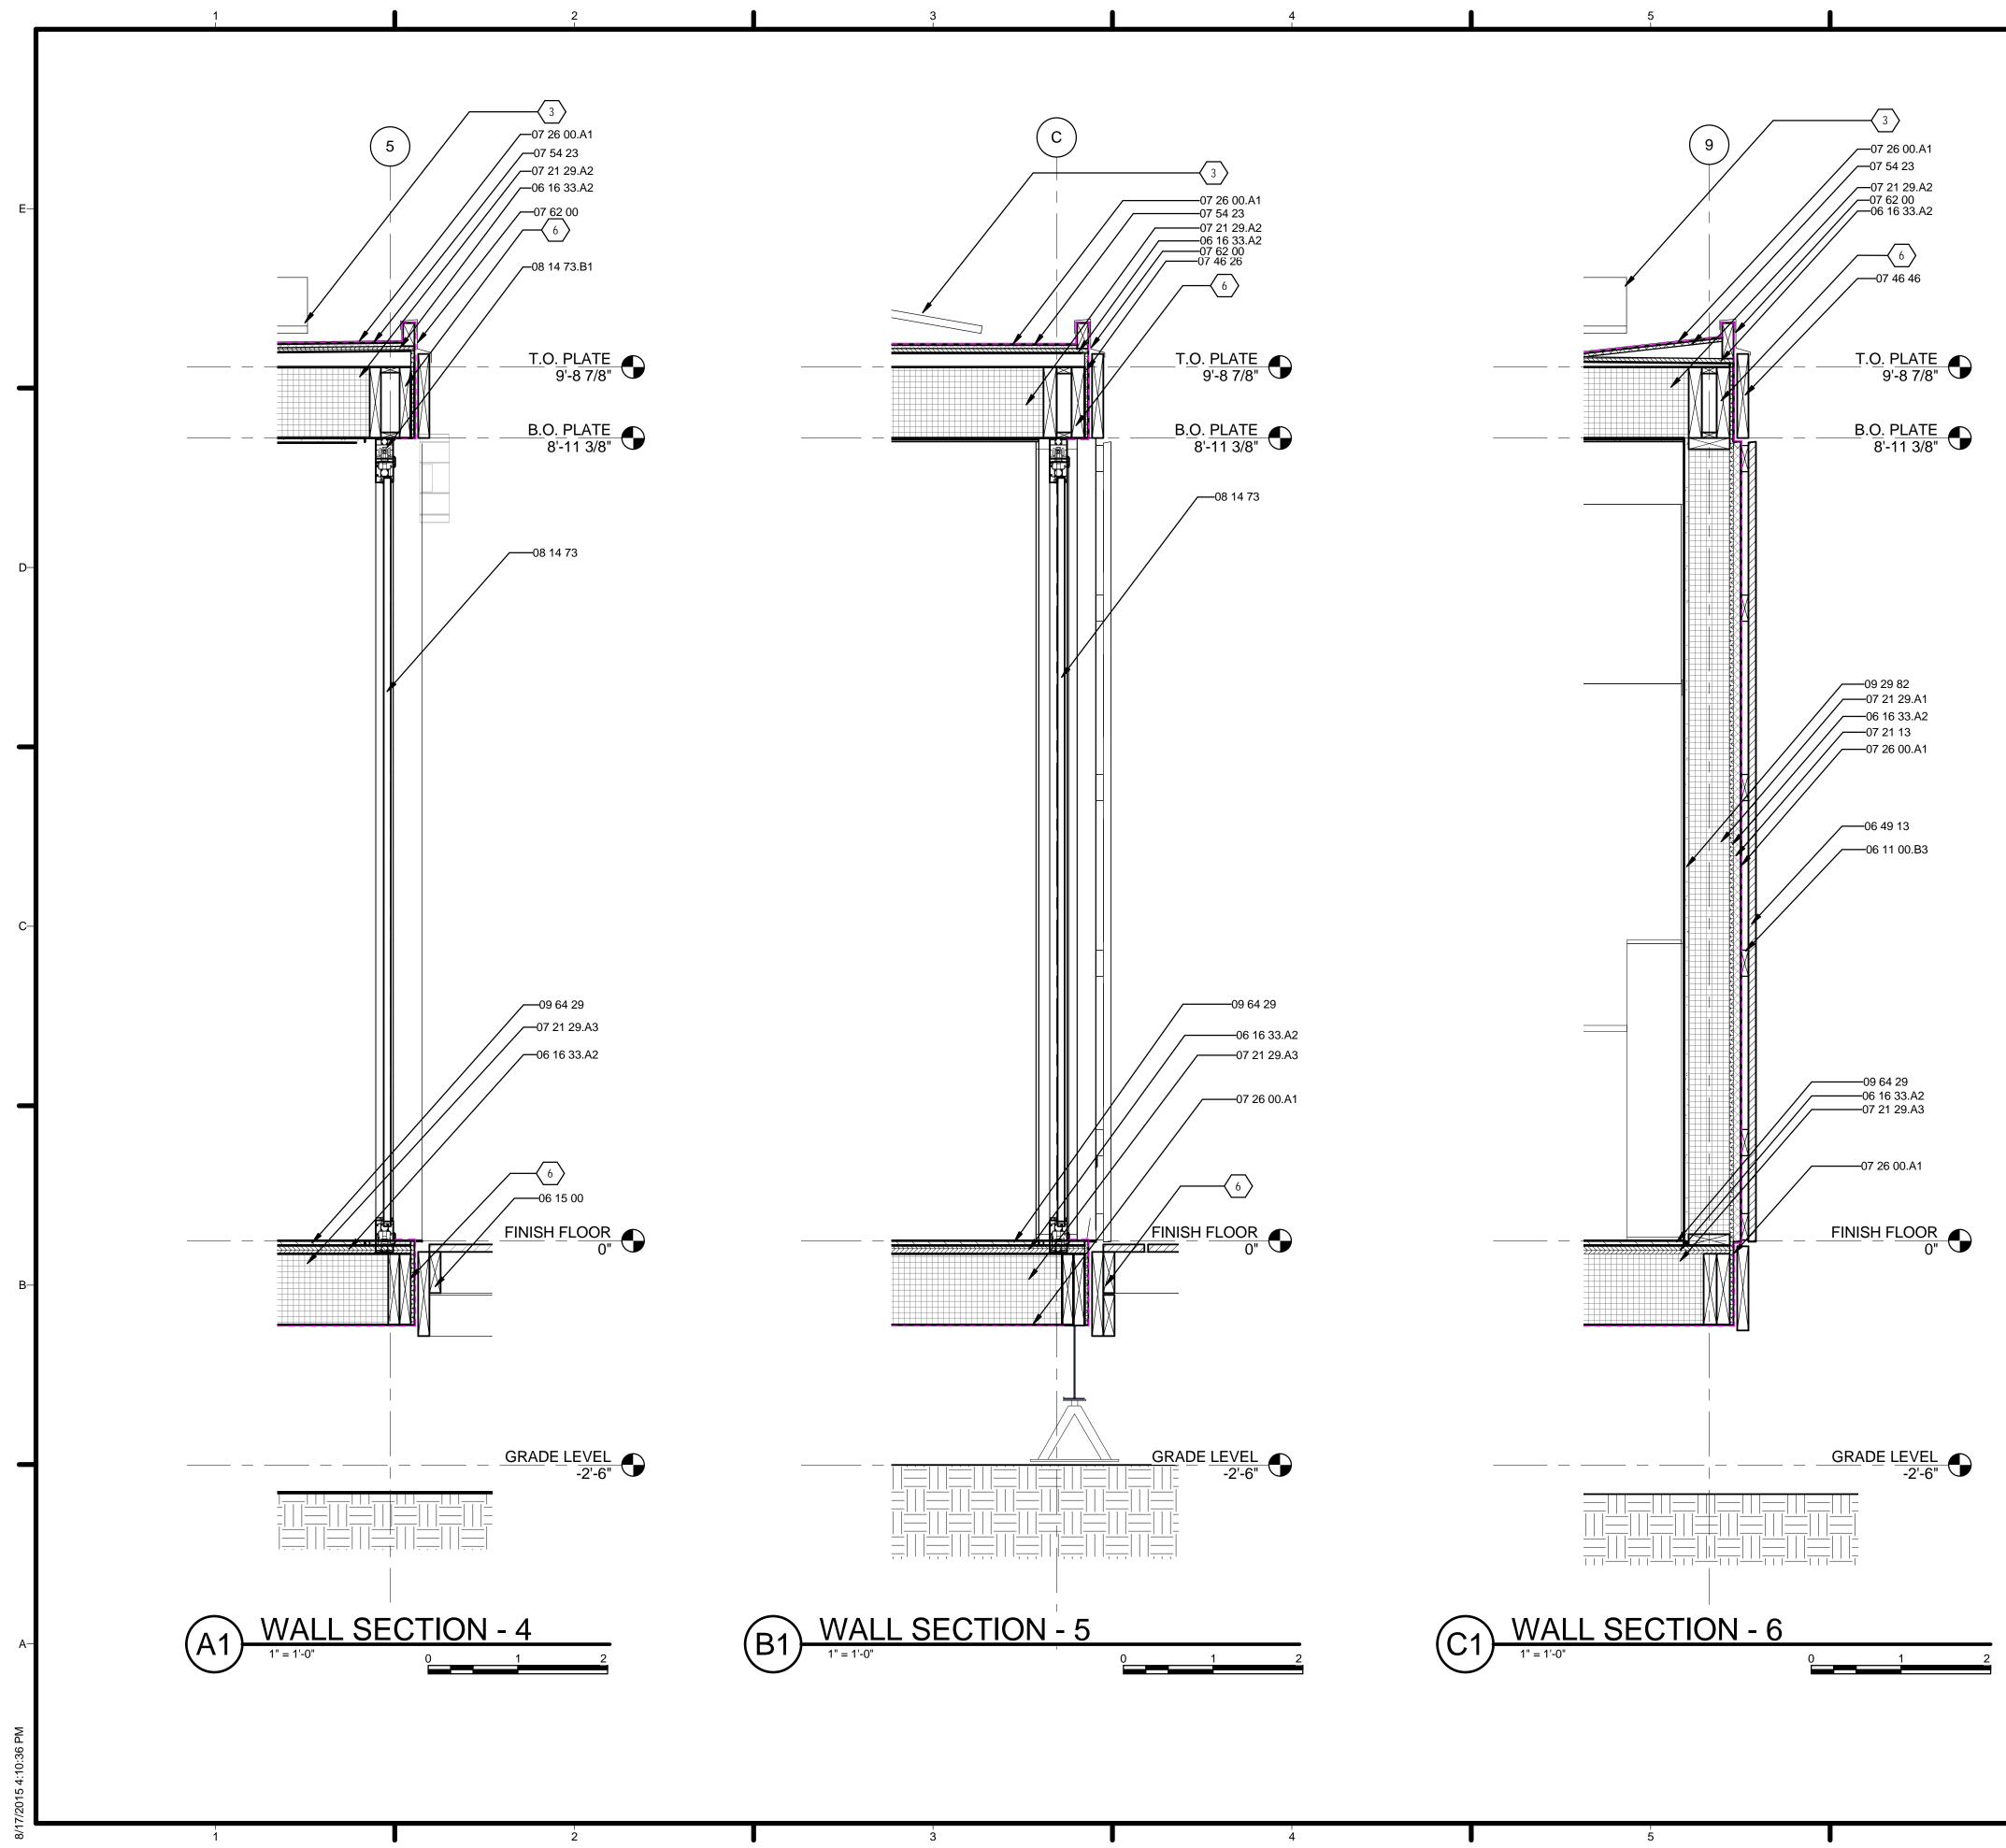
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GENERAL SHEET NOTES	6
 VERIFY ALL DIMENSIONS IN FIELD PRIOR TO FABRICATION AND INSTALLATION REF: PROJECT MANUAL AND CIVIL, ARCHITCTURAL, STRUCTURAL, PLUMBING, MECHANICAL & ELECTR DRAWINGS FOR ADDITIONAL INFORMATION 	ICAL TENEXUS
	TEAM NAME: TEAM TEXAS/GERMANY ADDRESS: UNIVERSITY OF TEXAS AT AUSTIN 2400 INNER CAMPUS DR AUSTIN, TX 78712 CONTACT: TEXAS.TEAM15@YAHOO.COM -D CONSULTANTS: JQ (STRUCTURAL ENGINEERING) - - -
REFERENCE KEYNOTES	
05 52 00 METAL RAILINGS 06 15 00 WOOD DECKING 06 44 13 WOOD SCREENS 06 60 00 PLASTIC FABRICATIONS 08 14 73 SLIDING WOOD DOORS 08 30 00 SPECIALTY DOORS AND FRAM 08 51 13 ALUMINUM WINDOWS 11 11 36 VEHICLE CHARGING EQUIPME 11 93 13 HYDROPONIC GROWING SYST 12 35 30 RESIDENTIAL CASEWORK 12 35 30.A7 DORMITORY CASEWORK 48 14 13 SOLAR ENERGY COLLECTORS	IES NT EMS -C CLIENT U.S. DEPARTMENT OF ENERGY
 SHEET KEYNOTES REF: PLUMBING/MECH. DRAWINGS PHOTOVOLTAIC ARRAY TO BE SECURED ON ROOF WITH RACK MOUNTING SYSTEM AS PROVIDED BY PV INSTALLER SOLAR ENVELOPE REF: STRUCTURAL DRAWINGS REF: INTERIOR DRAWINGS 	CHECKED BY: KC COPYRIGHT: NONE: PROJECT IS PUBLIC DOMAIN
	A-301







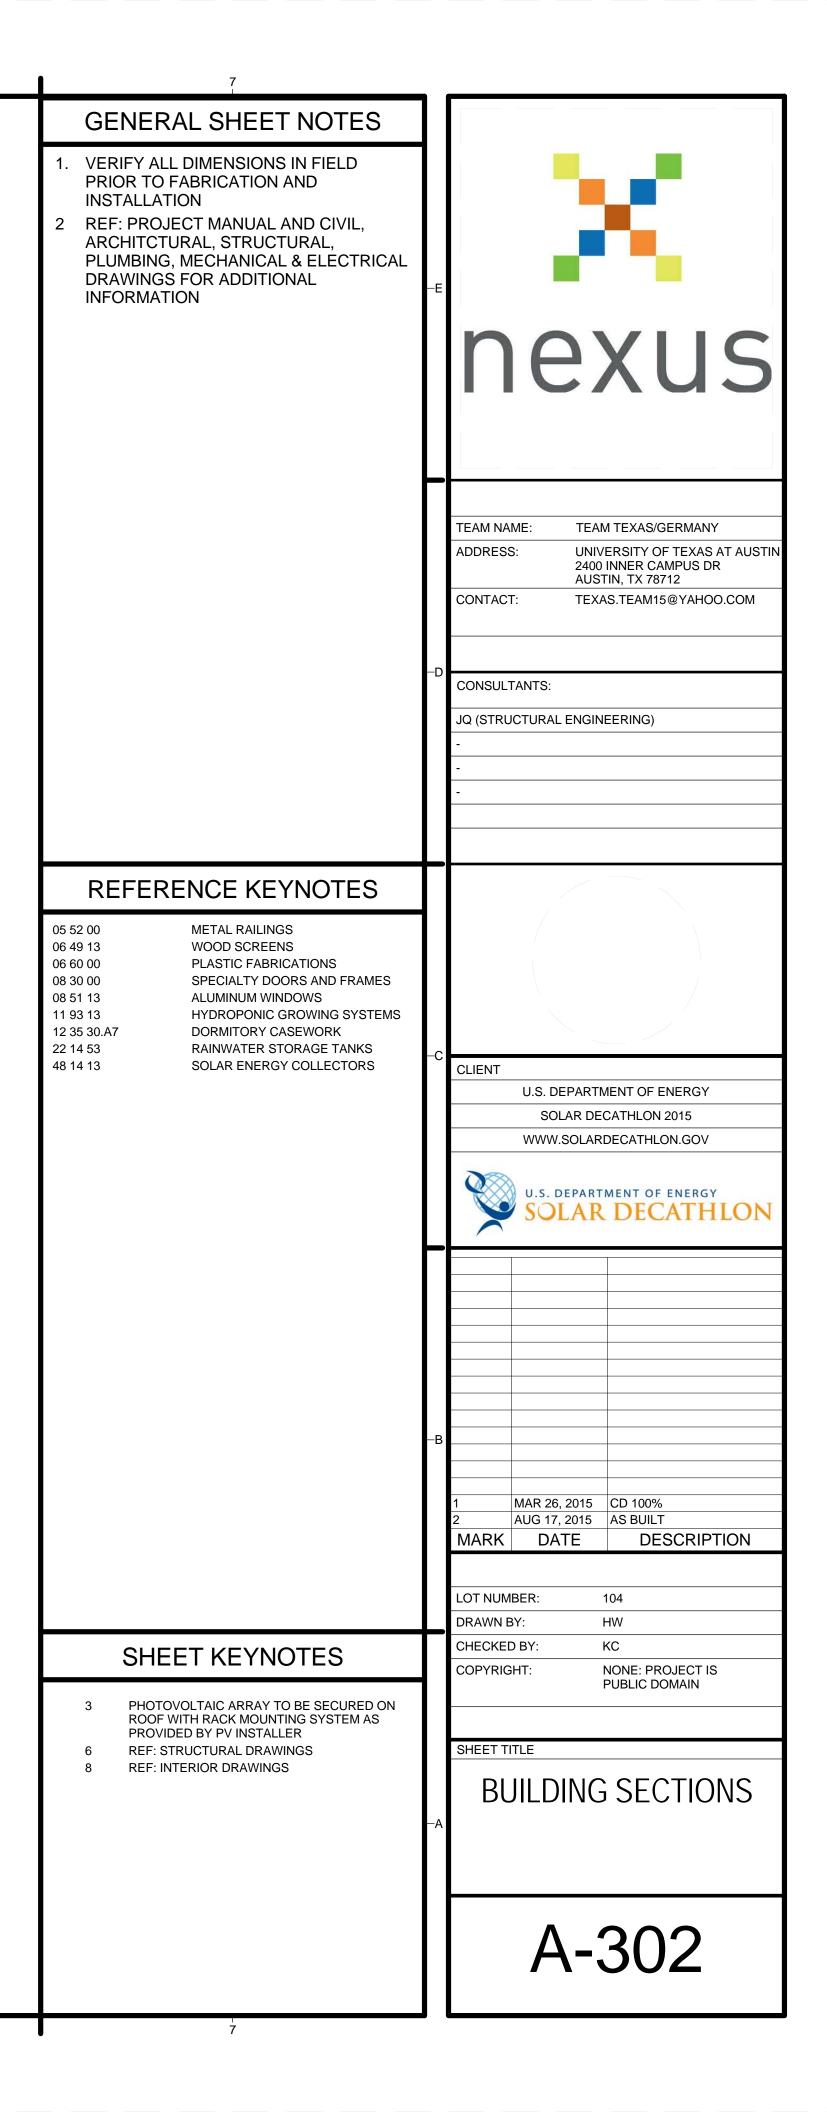


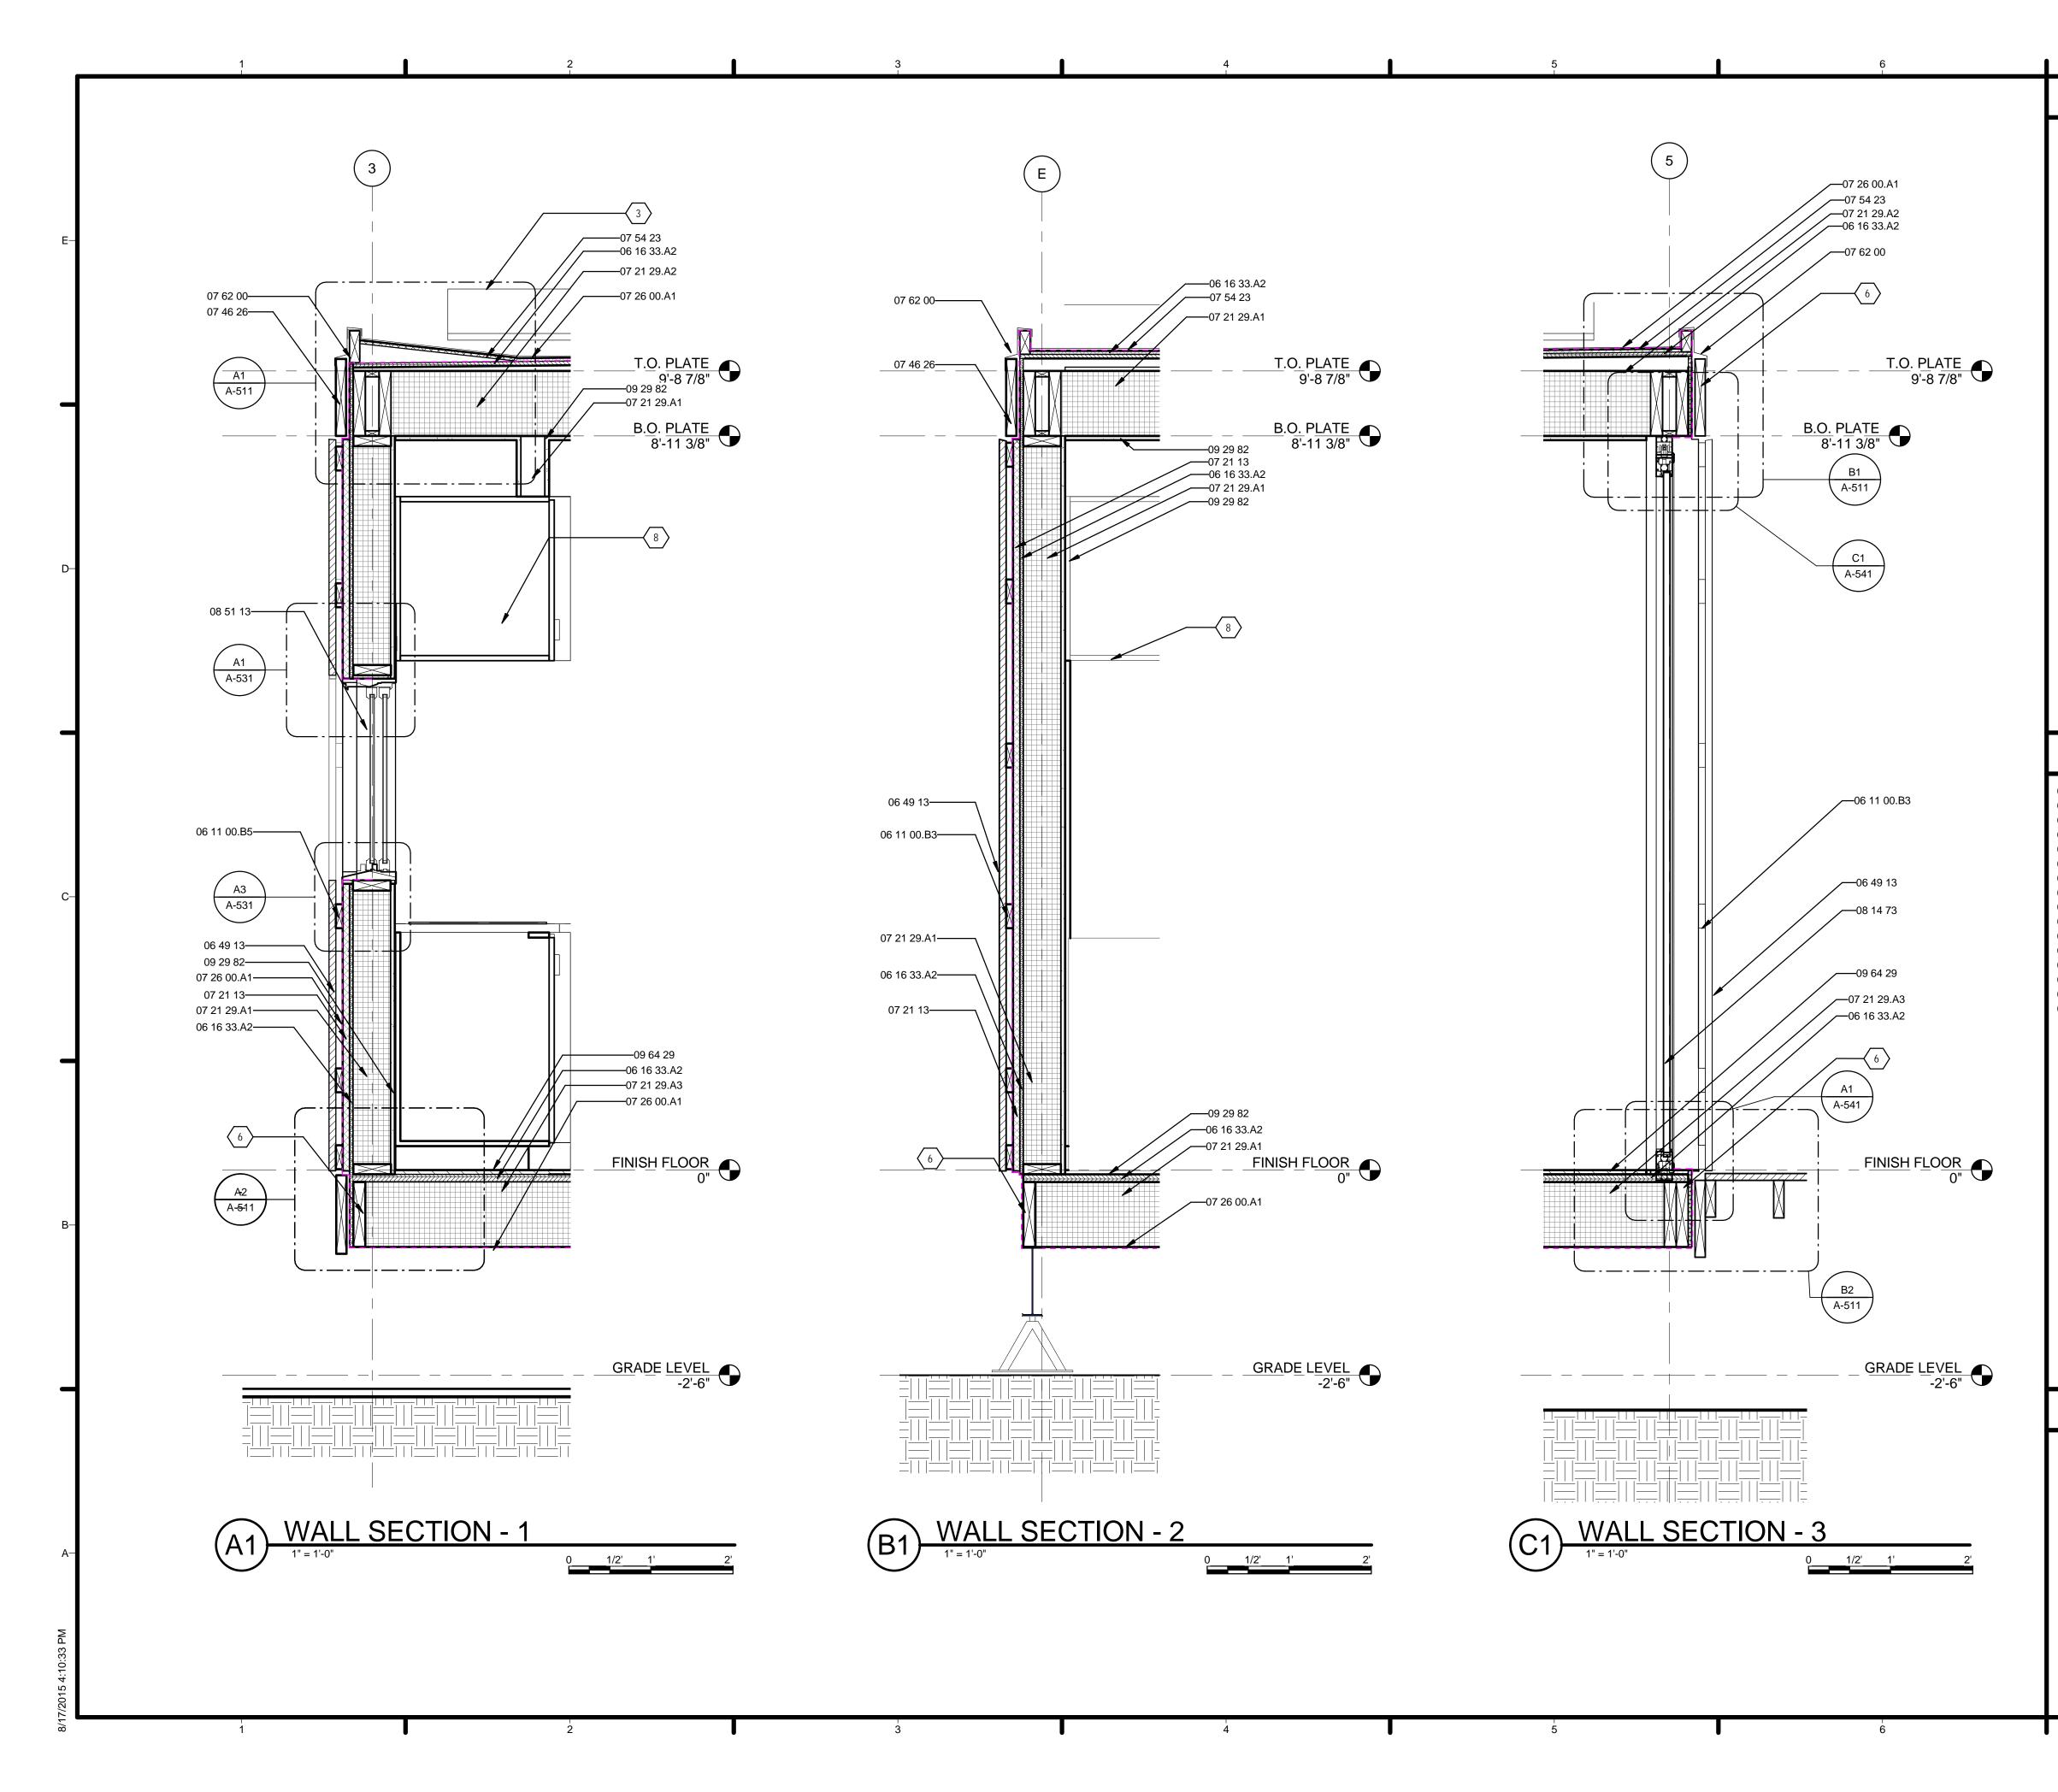
GENERAL SHEET NOTES	
 VERIFY ALL DIMENSIONS IN FIELD PRIOR TO FABRICATION AND INSTALLATION REF: PROJECT MANUAL AND CIVIL, ARCHITCTURAL, STRUCTURAL, PLUMBING, MECHANICAL & ELECTRICAL DRAWINGS FOR ADDITIONAL INFORMATION 	■
	TEAM NAME: TEAM TEXAS/GERMANY ADDRESS: UNIVERSITY OF TEXAS AT AUSTIN 2400 INNER CAMPUS DR AUSTIN, TX 78712 CONTACT: TEXAS.TEAM15@YAHOO.COM O CONSULTANTS: JQ (STRUCTURAL ENGINEERING) -
REFERENCE KEYNOTES	
06 11 00.B31X306 11 00.B51X406 16 33.A2WOOD BOARD SHEATHING06 49 13WOOD SCREENS07 21 13BOARD INSULATION07 21 29.A1SPRAYED INSULATION-WALL07 21 29.A2SPRAYED INSULATION-ROOF07 21 29.A3SPRAYED INSULATION-FLOOR07 26 00.A1VAPOR RETARDERS07 46 26HARDBOARD SIDING07 54 23THERMOPLASTIC-POLYOLEFIN ROOFING07 62 00SHEET METAL FLASHING AND TRIM08 14 73SLIDING WOOD DOORS08 51 13ALUMINUM WINDOWS09 29 82FIREPROOF GYPSUM PLASTERING09 64 29WOOD STRIP AND PLANK FLOORING	-C CLIENT U.S. DEPARTMENT OF ENERGY SOLAR DECATHLON 2015 WWW.SOLARDECATHLON.GOV U.S. DEPARTMENT OF ENERGY SOLAR DECATHLON
	-В 1 MAR 26, 2015 CD 100% 2 AUG 17, 2015 AS BUILT MARK DATE DESCRIPTION
	LOT NUMBER: 104 DRAWN BY: HW
 SHEET KEYNOTES PHOTOVOLTAIC ARRAY TO BE SECURED ON ROOF WITH RACK MOUNTING SYSTEM AS PROVIDED BY PV INSTALLER REF: STRUCTURAL DRAWINGS REF: INTERIOR DRAWINGS 	CHECKED BY: KC COPYRIGHT: NONE: PROJECT IS PUBLIC DOMAIN SHEET TITLE WALL SECTIONS
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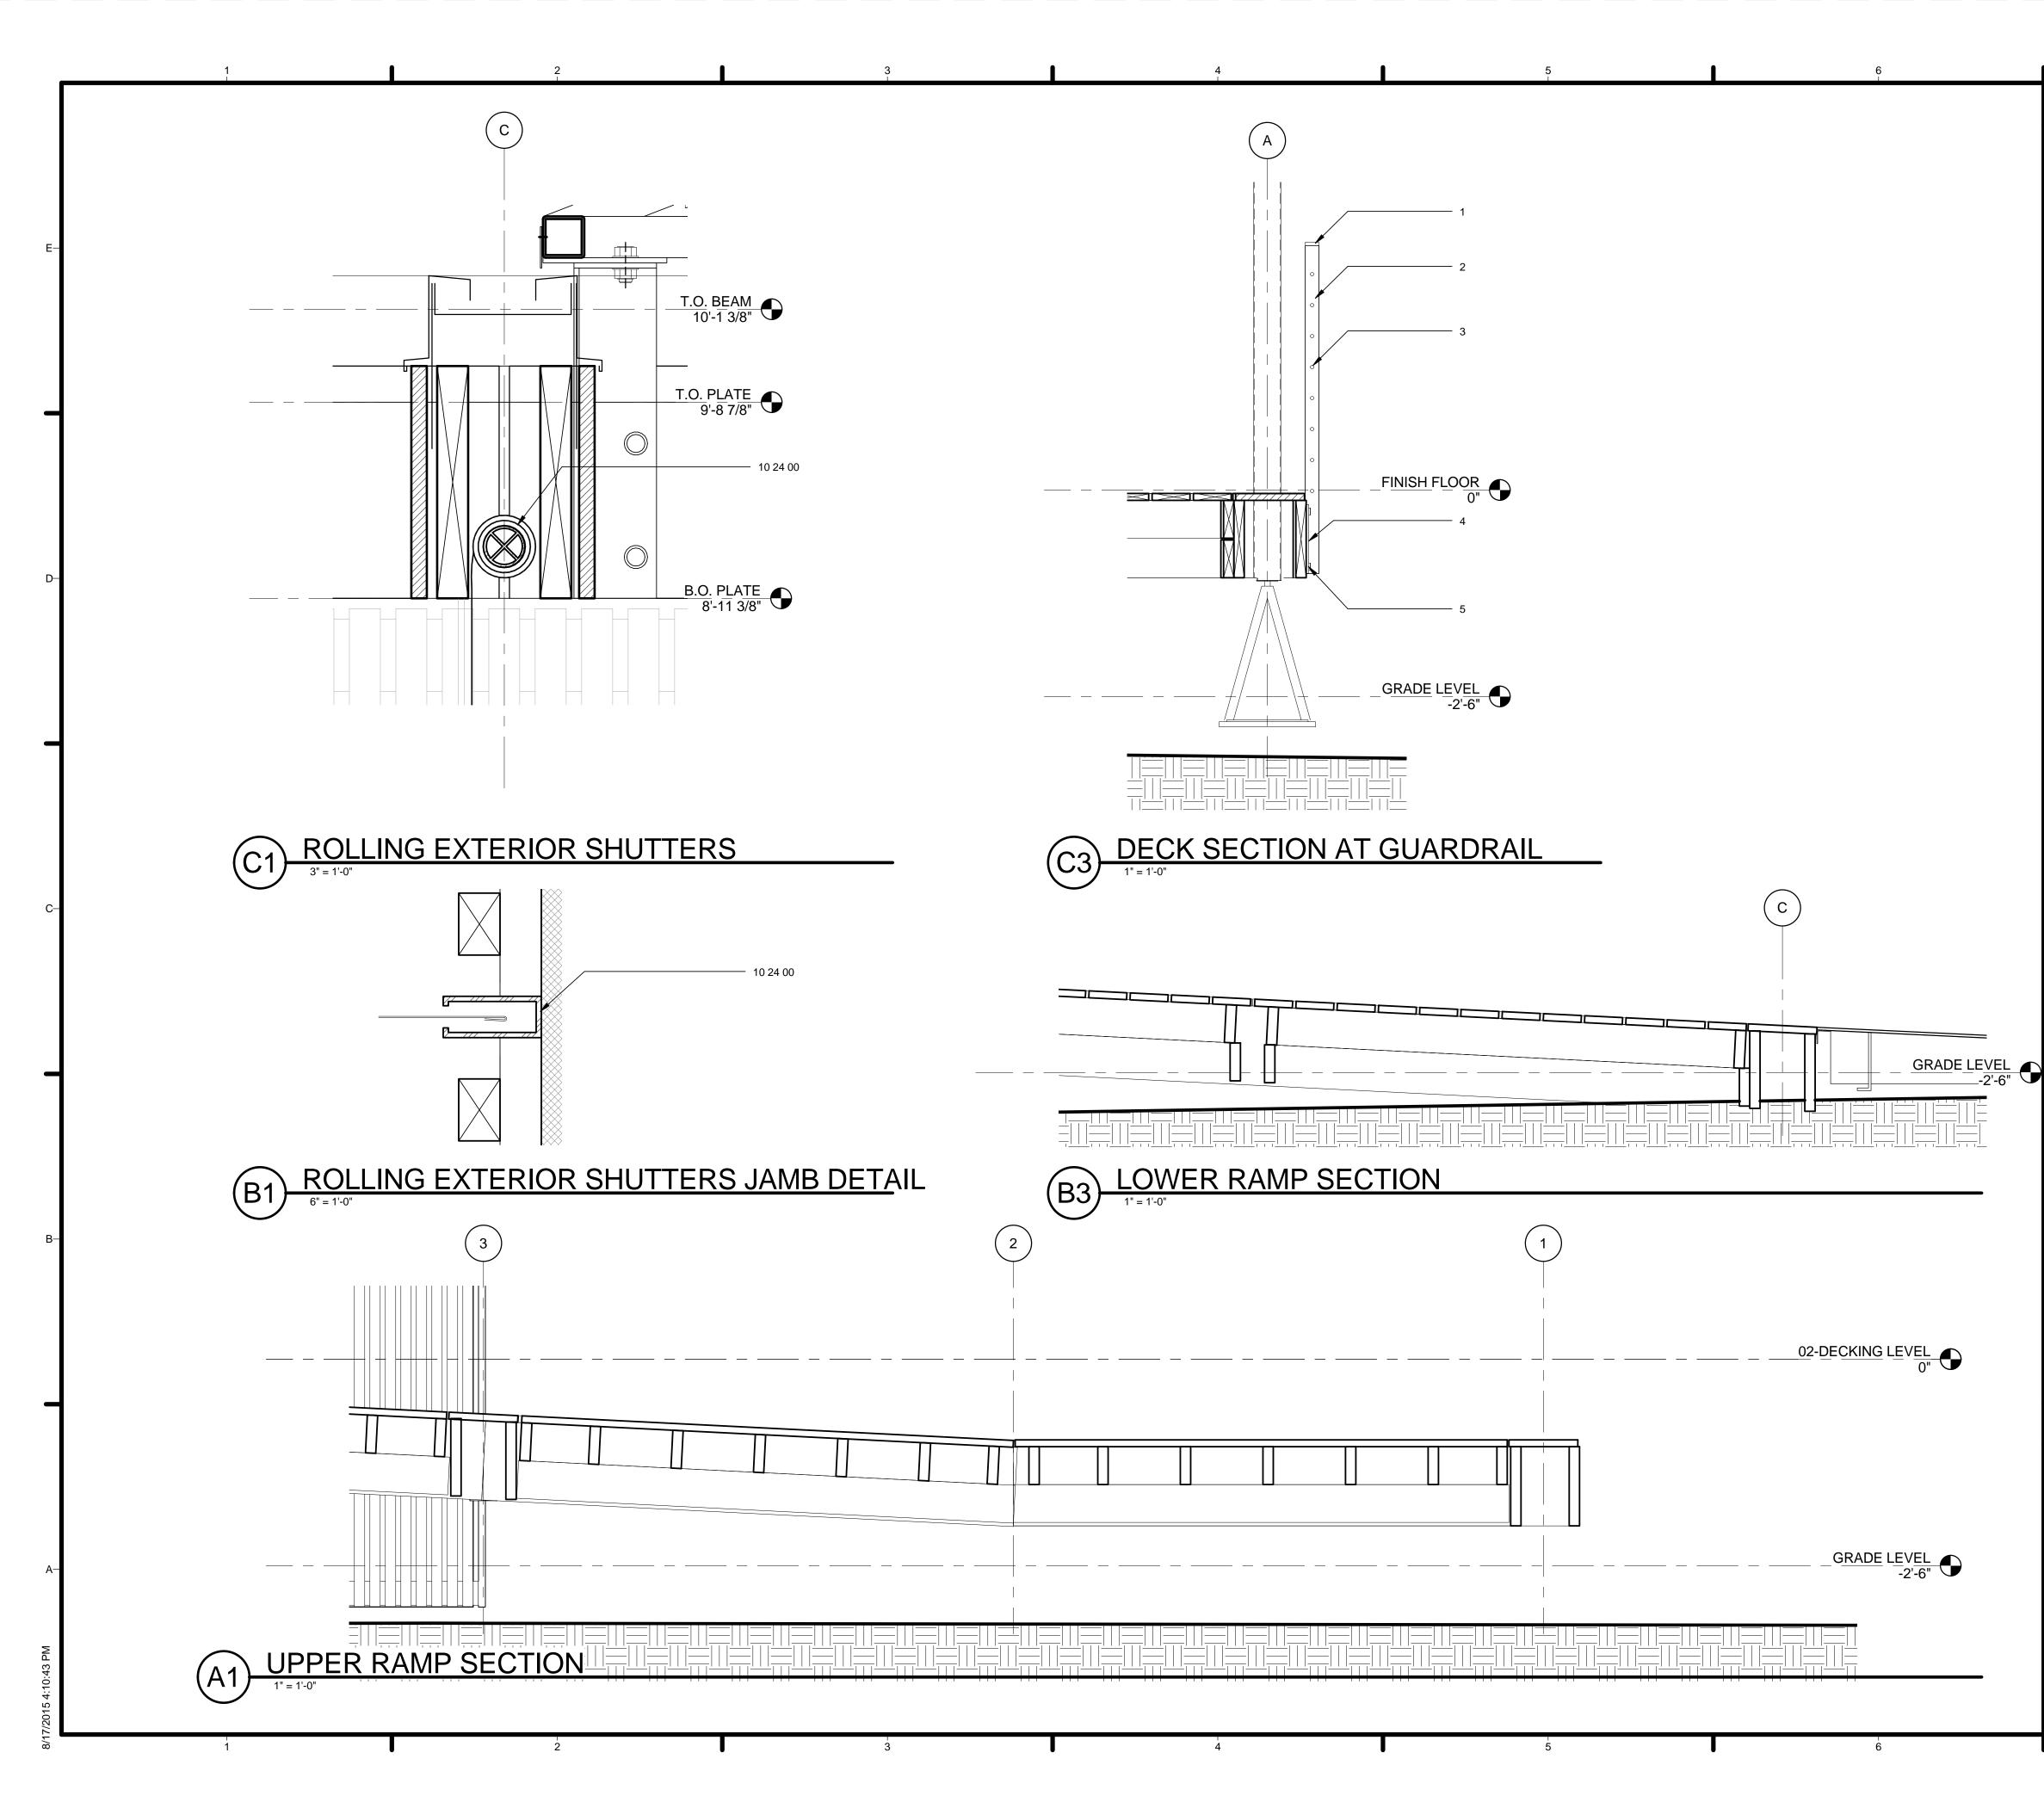





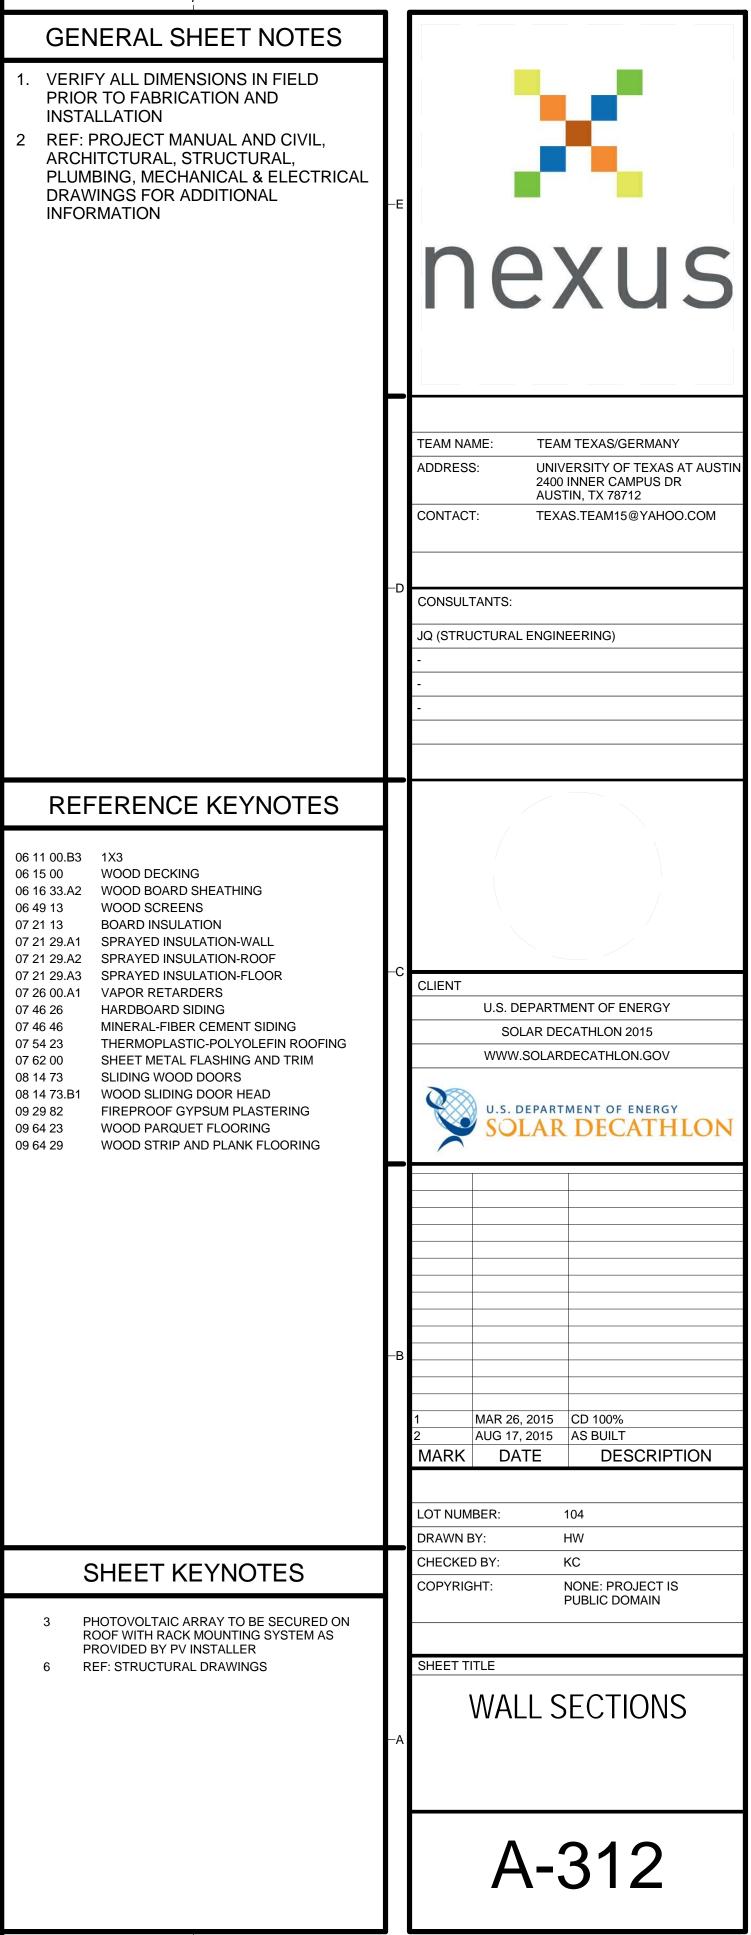


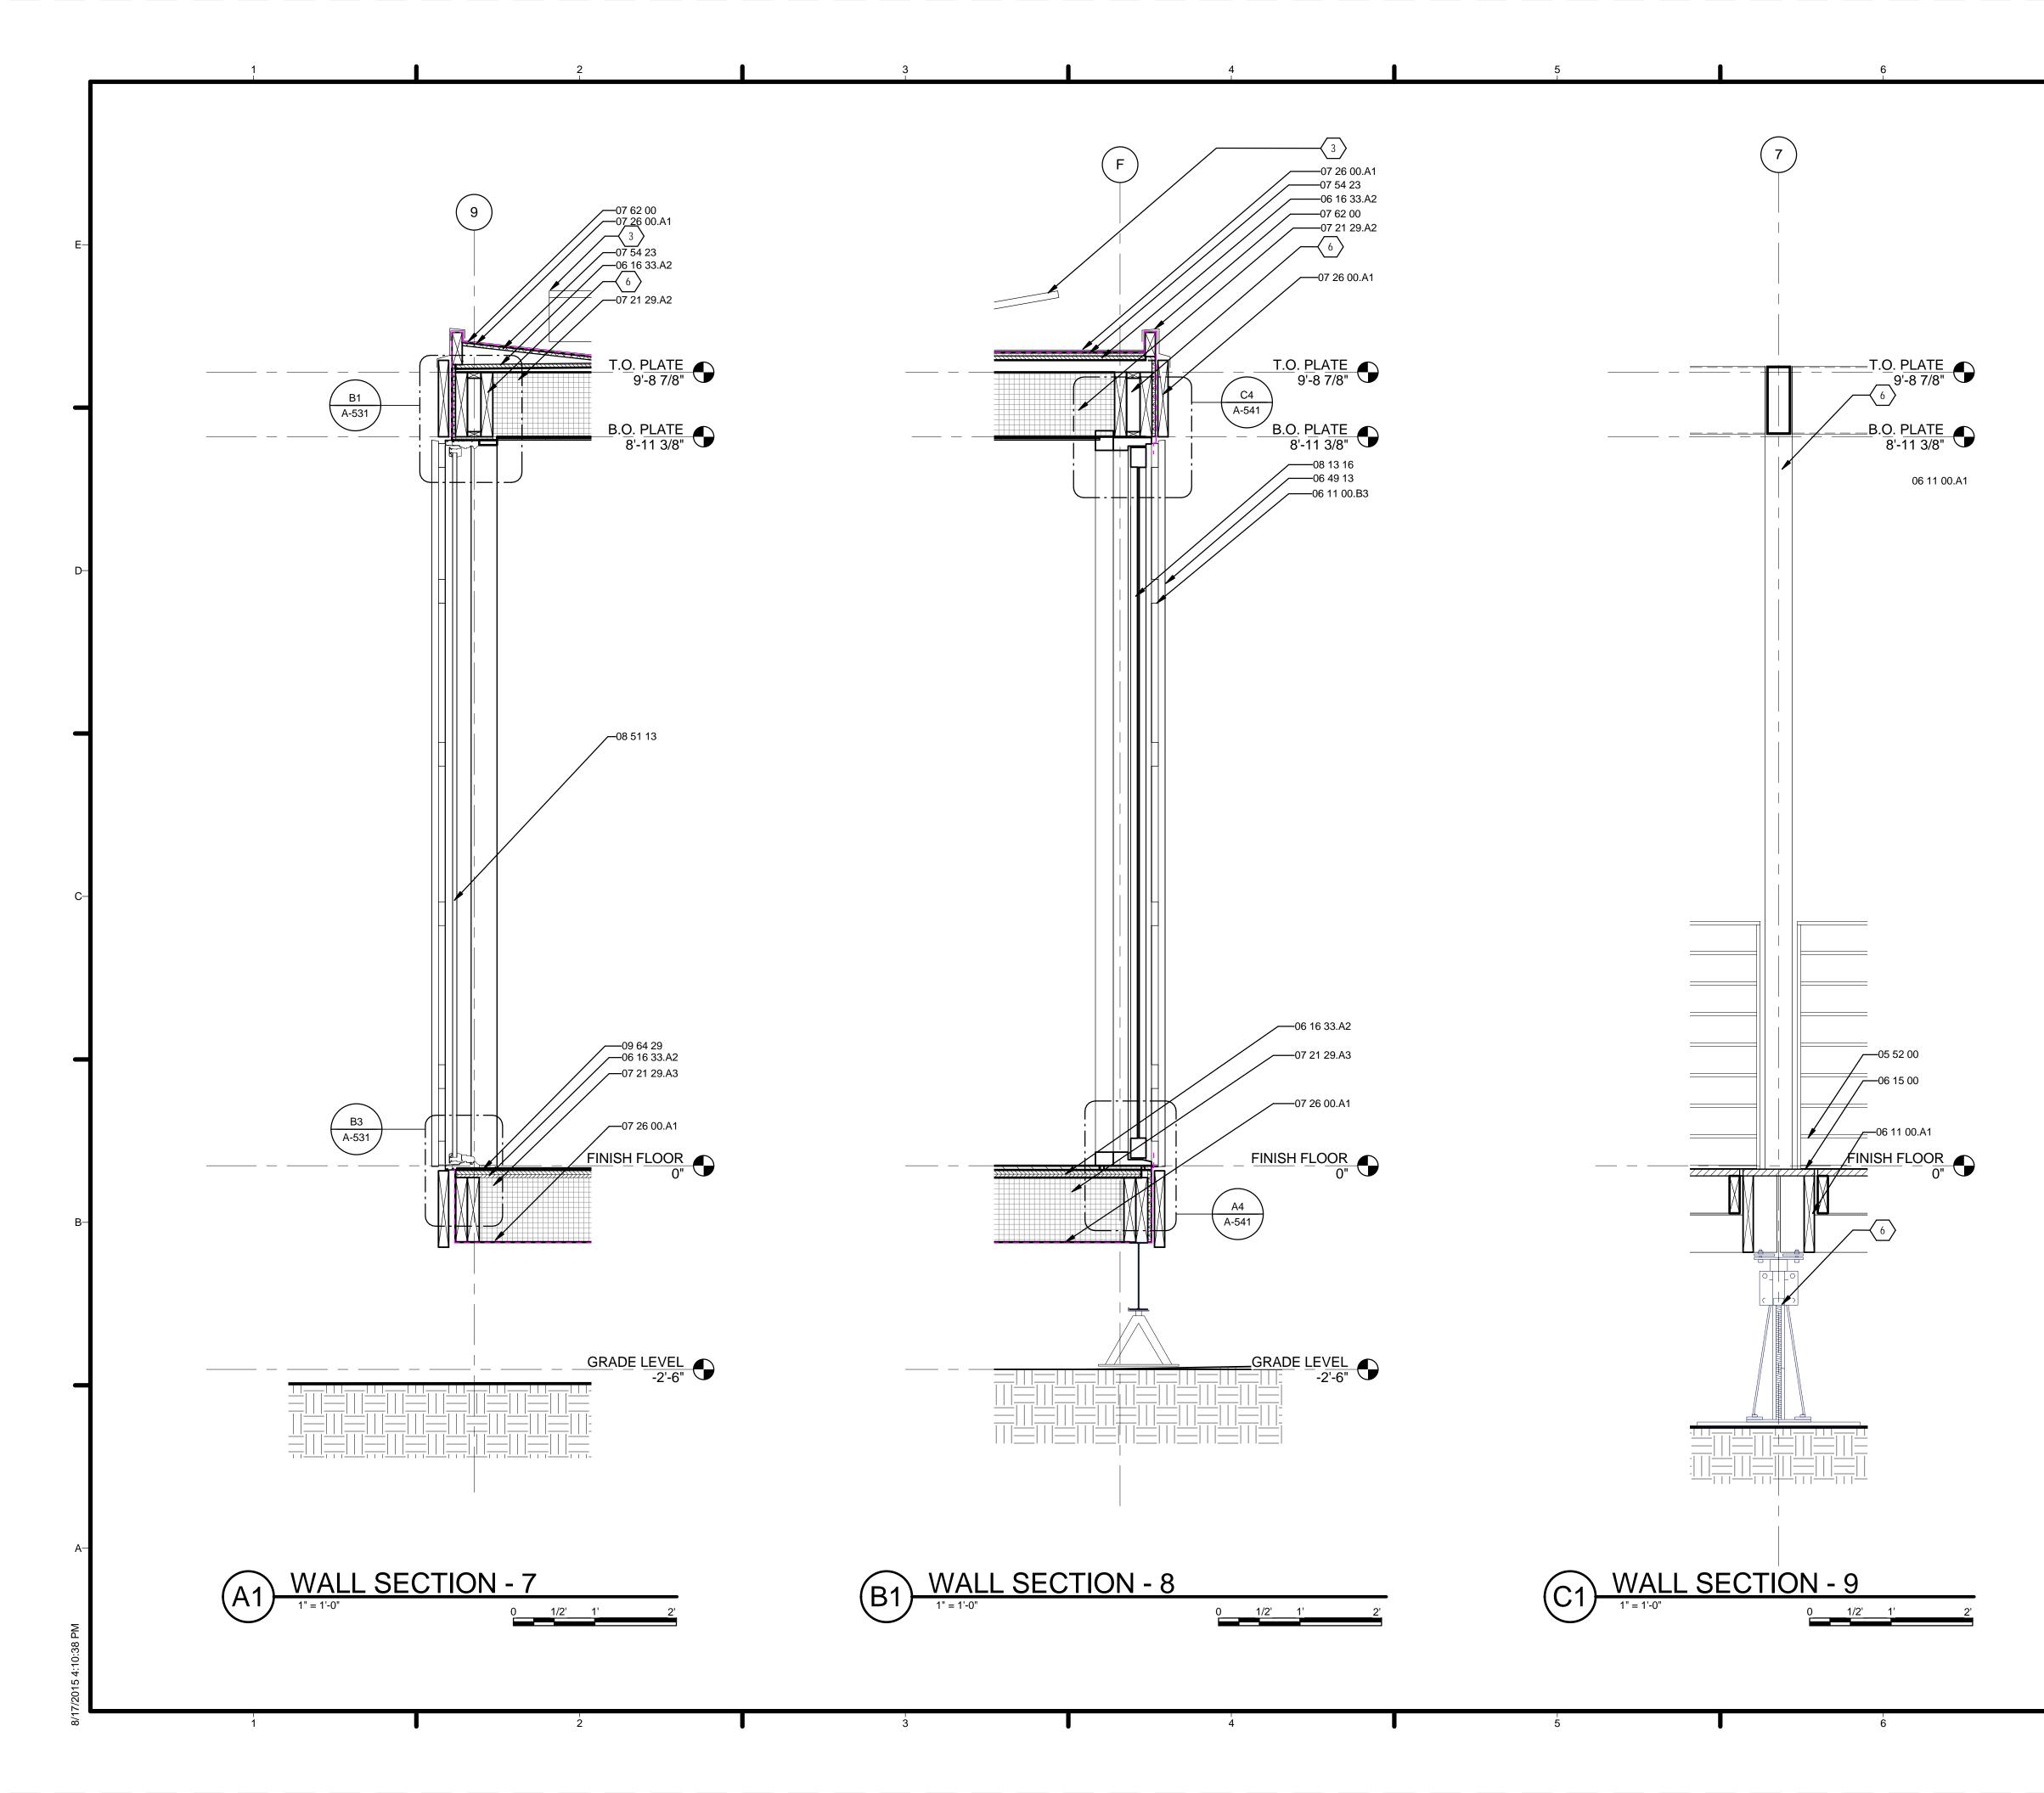


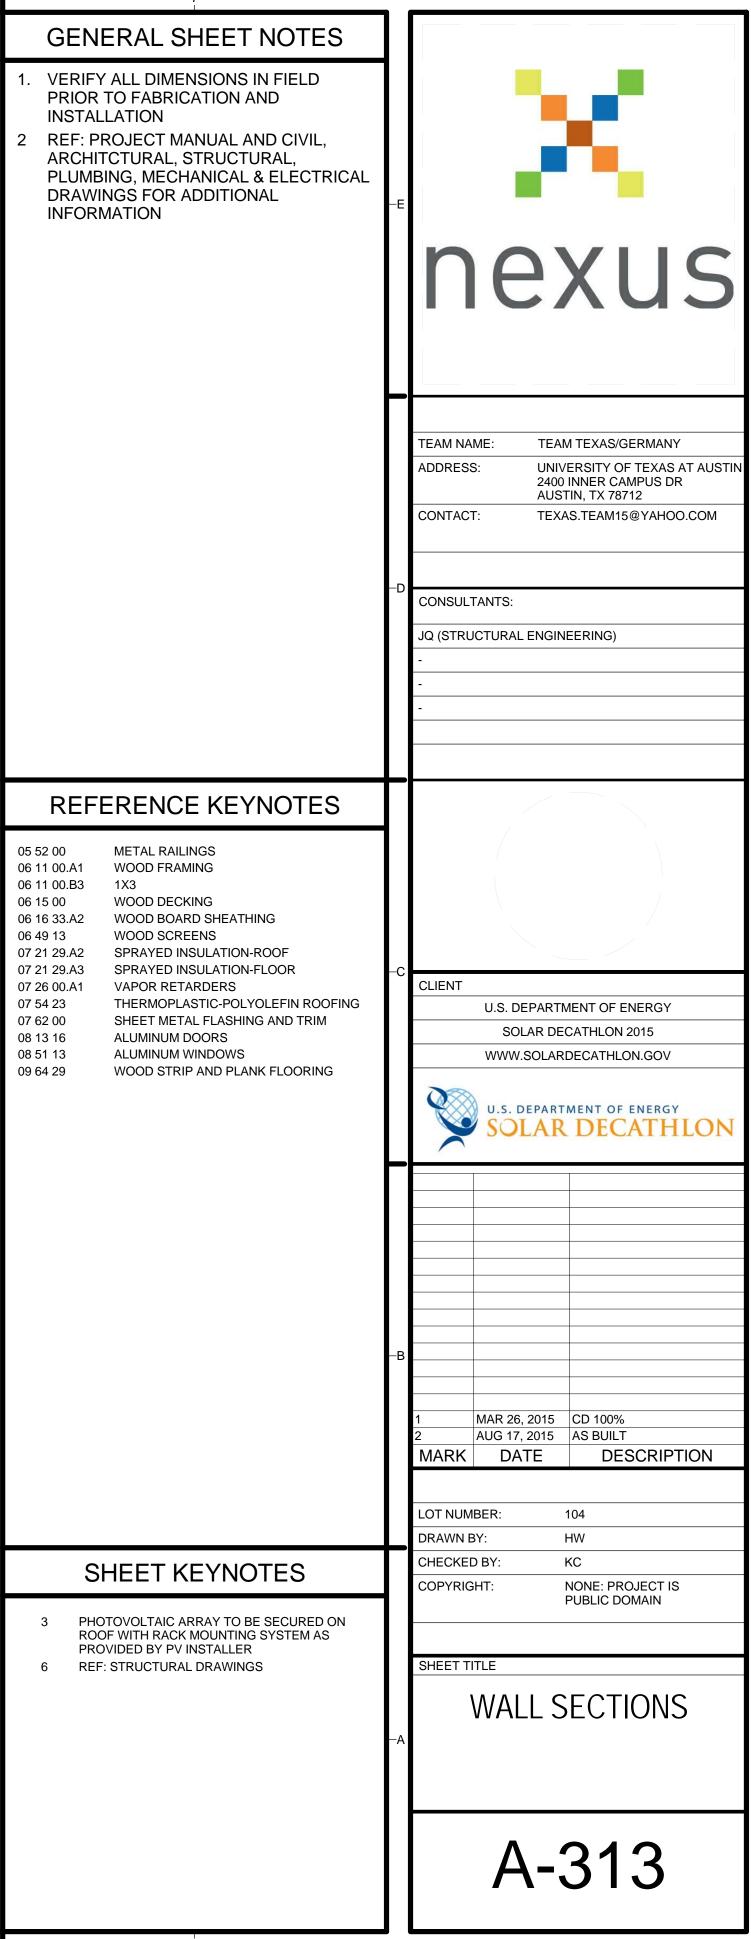	GENERAL SHEET NOTES	
	1. VERIFY ALL DIMENSIONS IN FIELD PRIOR TO FABRICATION AND	
	INSTALLATION 2 REF: PROJECT MANUAL AND CIVIL,	
	ARCHITCTURAL, STRUCTURAL, PLUMBING, MECHANICAL & ELECTRICAL	
	DRAWINGS FOR ADDITIONAL INFORMATION	-E
		\mathbf{D}
		nexus
		TEAM NAME: TEAM TEXAS/GERMANY
00		ADDRESS: UNIVERSITY OF TEXAS AT AUSTIN 2400 INNER CAMPUS DR AUSTIN, TX 78712
		CONTACT: TEXAS.TEAM15@YAHOO.COM
		-D CONSULTANTS:
		JQ (STRUCTURAL ENGINEERING) -
		-
		-
	REFERENCE KEYNOTES	
	06 16 33.A2 WOOD BOARD SHEATHING 07 21 29.A2 SPRAYED INSULATION-ROOF	
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	07 54 23THERMOPLASTIC-POLYOLEFIN ROOFING07 62 00SHEET METAL FLASHING AND TRIM08 14 73.B1WOOD SLIDING DOOR HEAD	
	08 14 73.51WOOD SLIDING DOOR HEAD09 51 26ACOUSTICAL WOOD CEILINGS09 64 23WOOD PARQUET FLOORING	-C CLIENT
		U.S. DEPARTMENT OF ENERGY SOLAR DECATHLON 2015
		WWW.SOLARDECATHLON.GOV
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		SOLAR DECATHLON
		B
		1 MAR 26, 2015 CD 100% 2 AUG 17, 2015 AS BUILT MARK DATE DESCRIPTION
		LOT NUMBER: 104 DRAWN BY: HW
	SHEET KEYNOTES	CHECKED BY: KC COPYRIGHT: NONE: PROJECT IS
	6 REF: STRUCTURAL DRAWINGS	PUBLIC DOMAIN
		SHEET TITLE
		EXTERIOR DETAILS
		A-511
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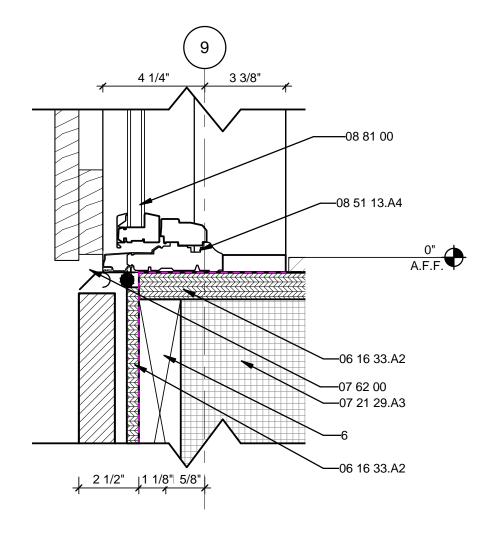


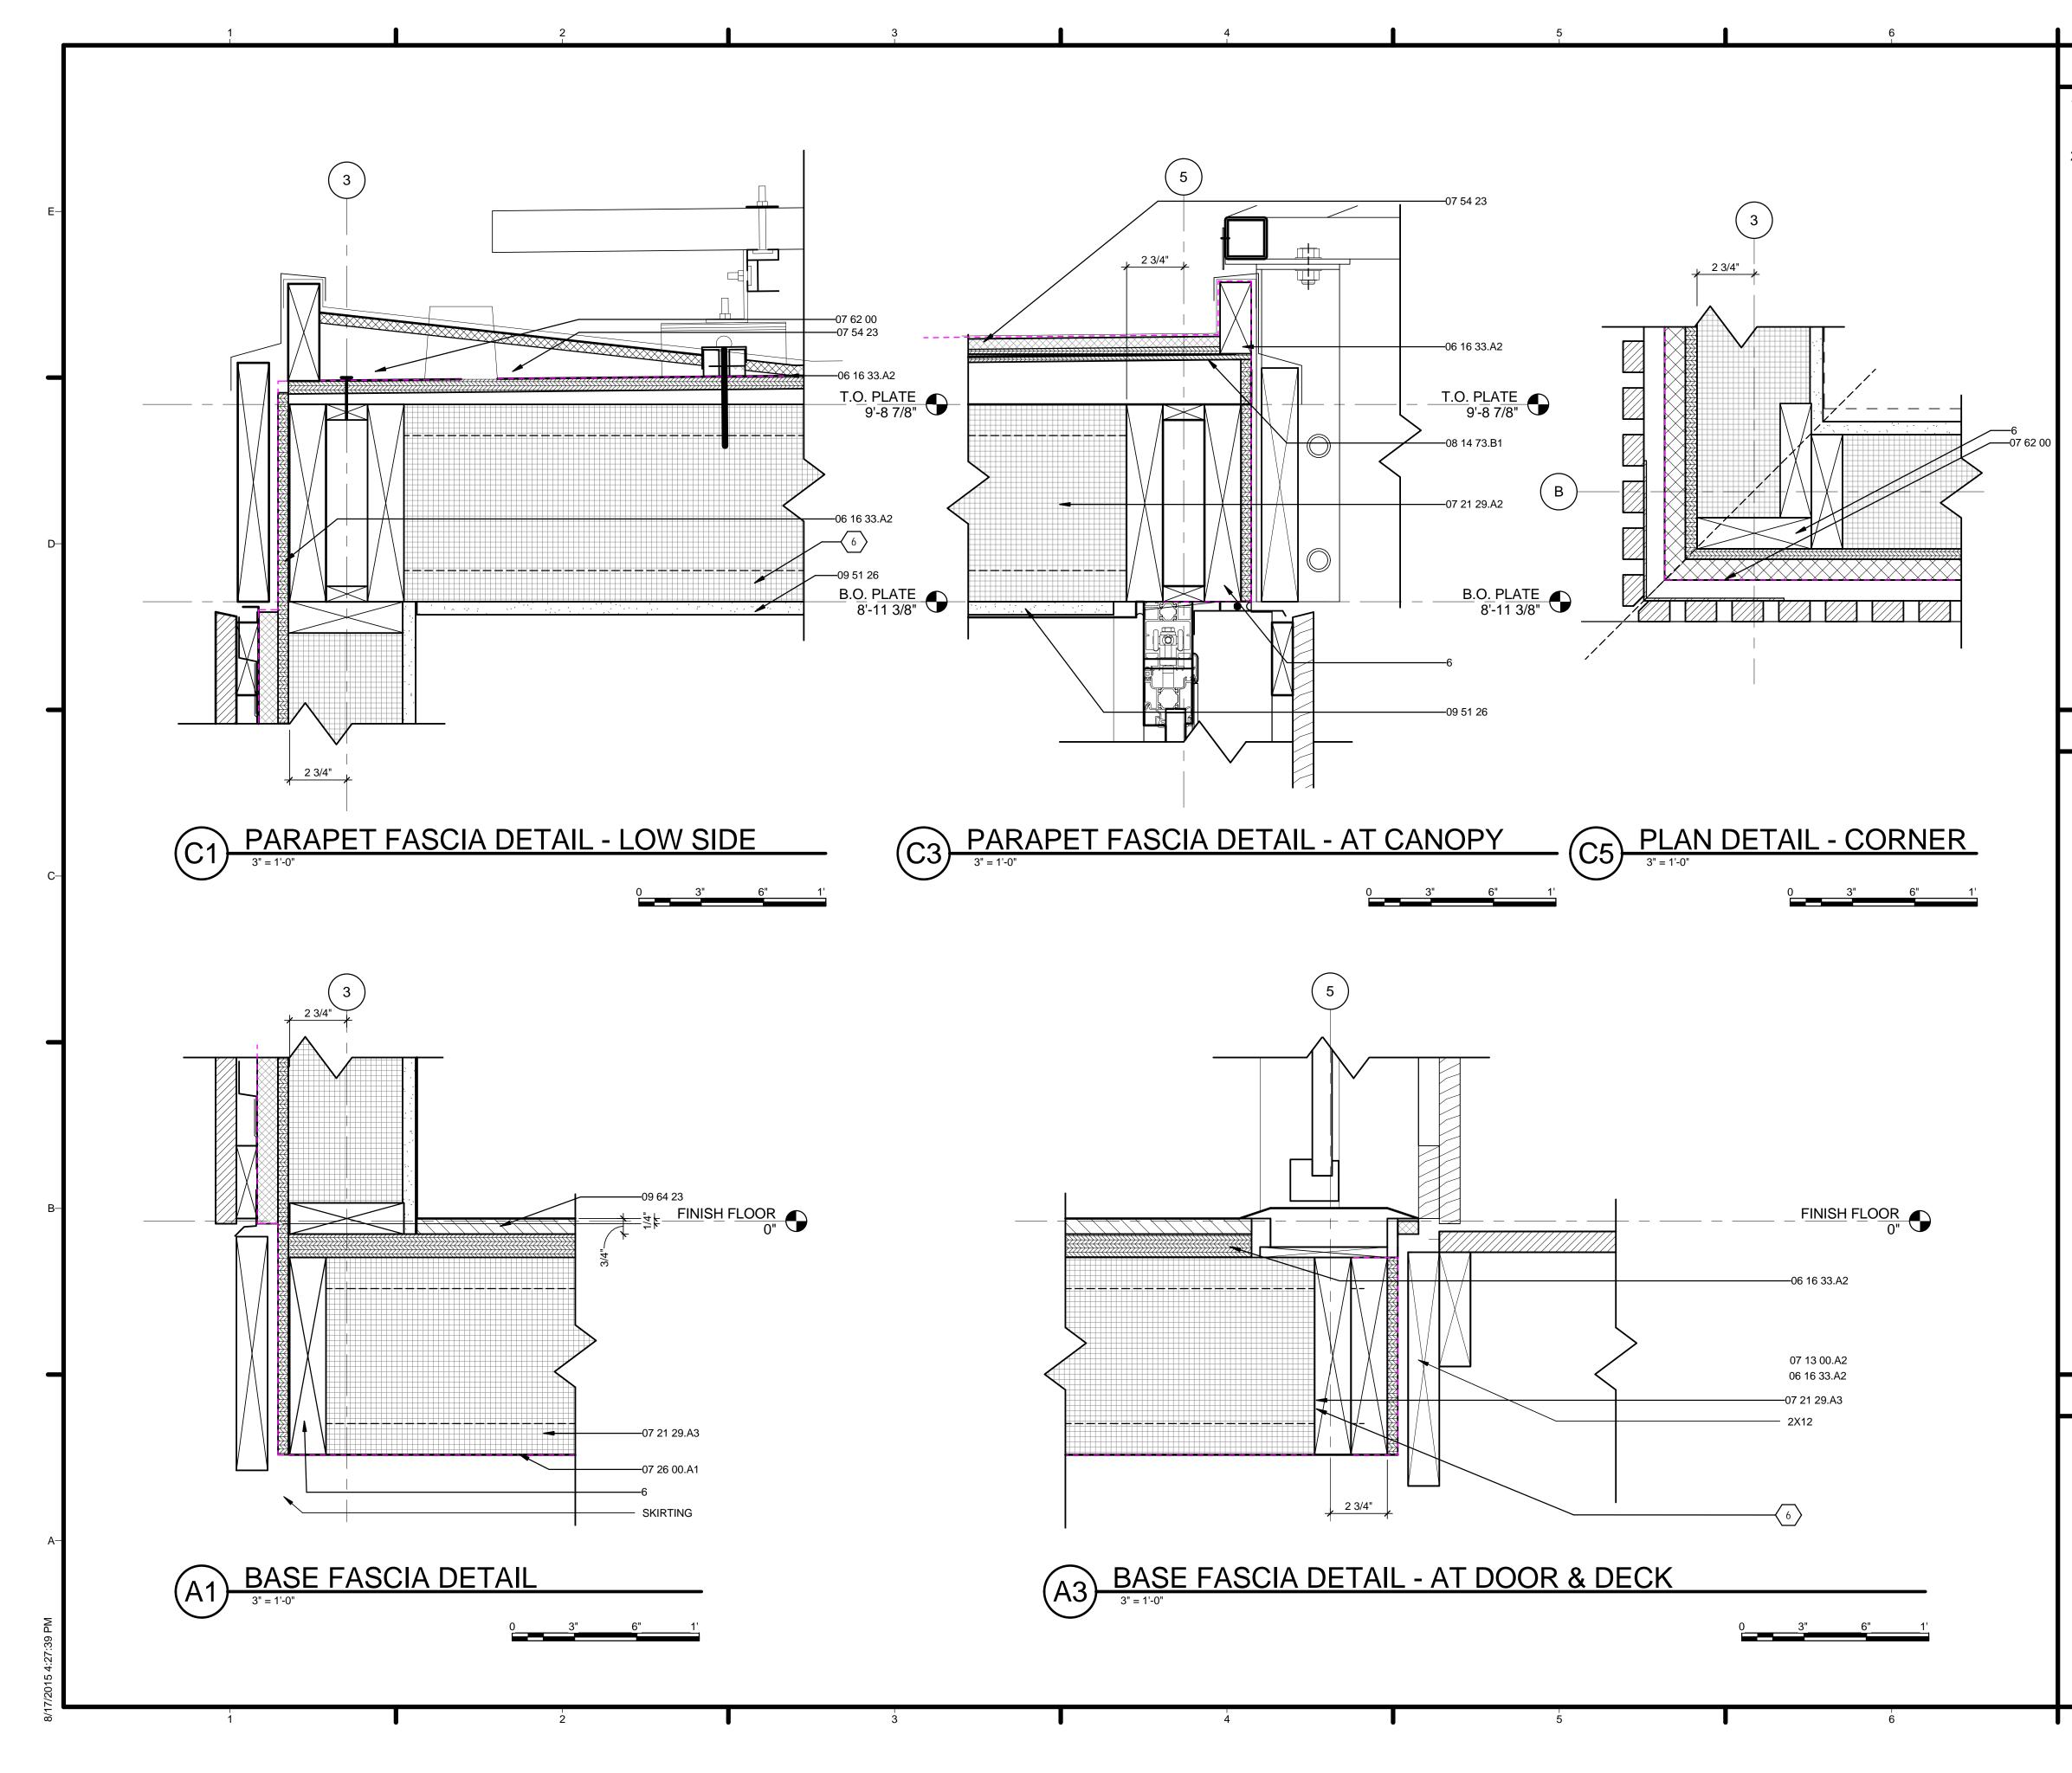

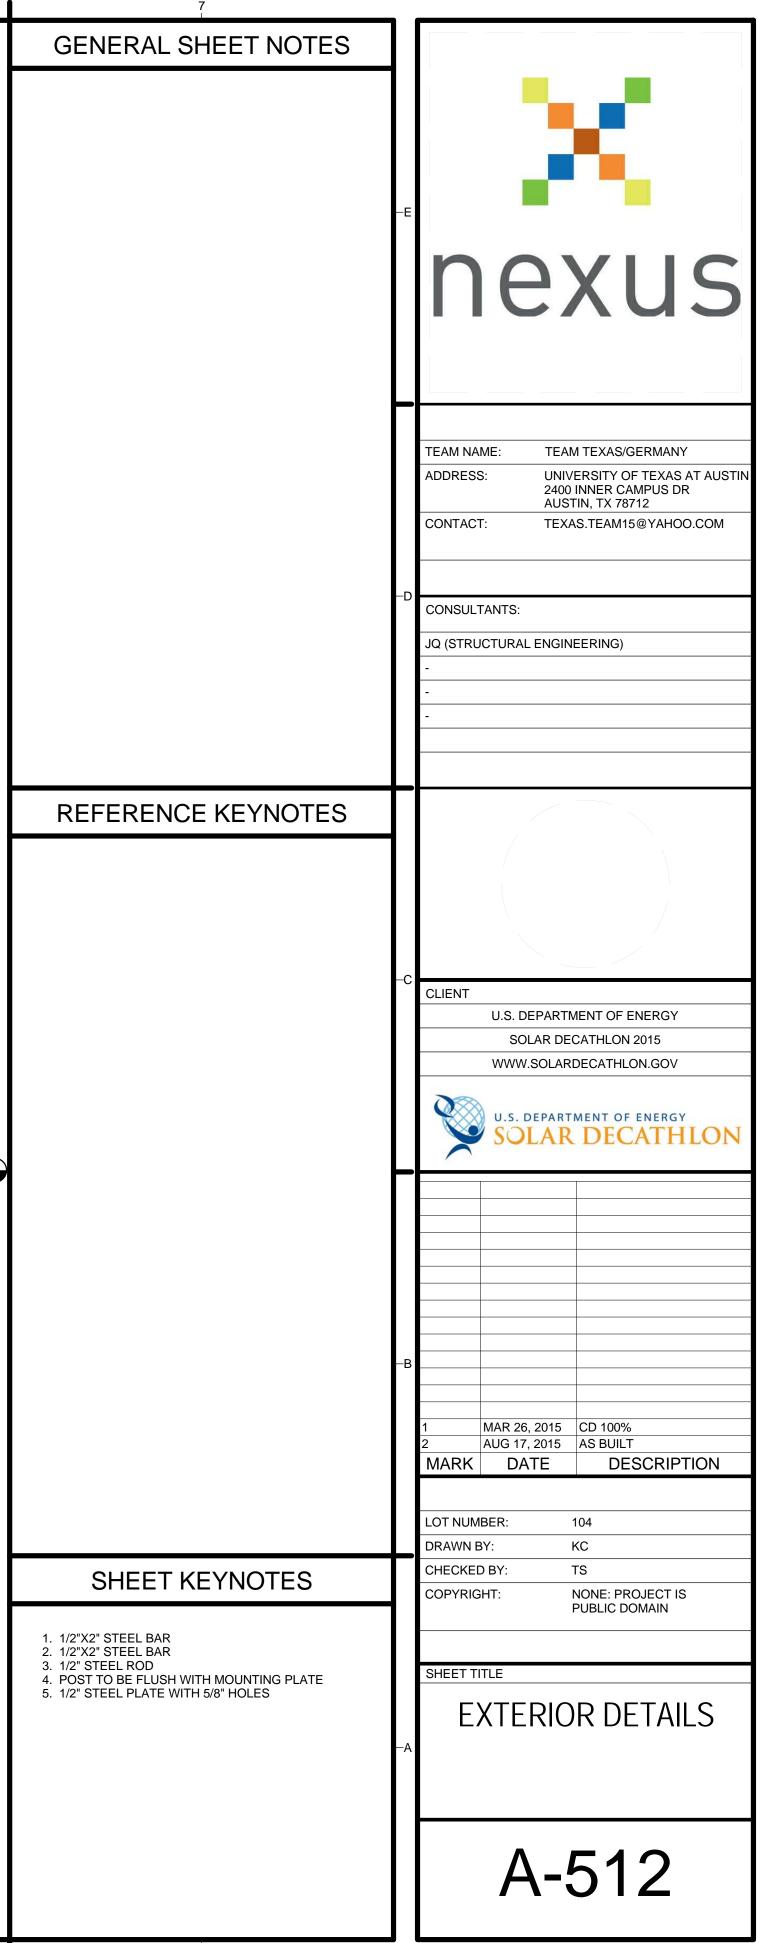

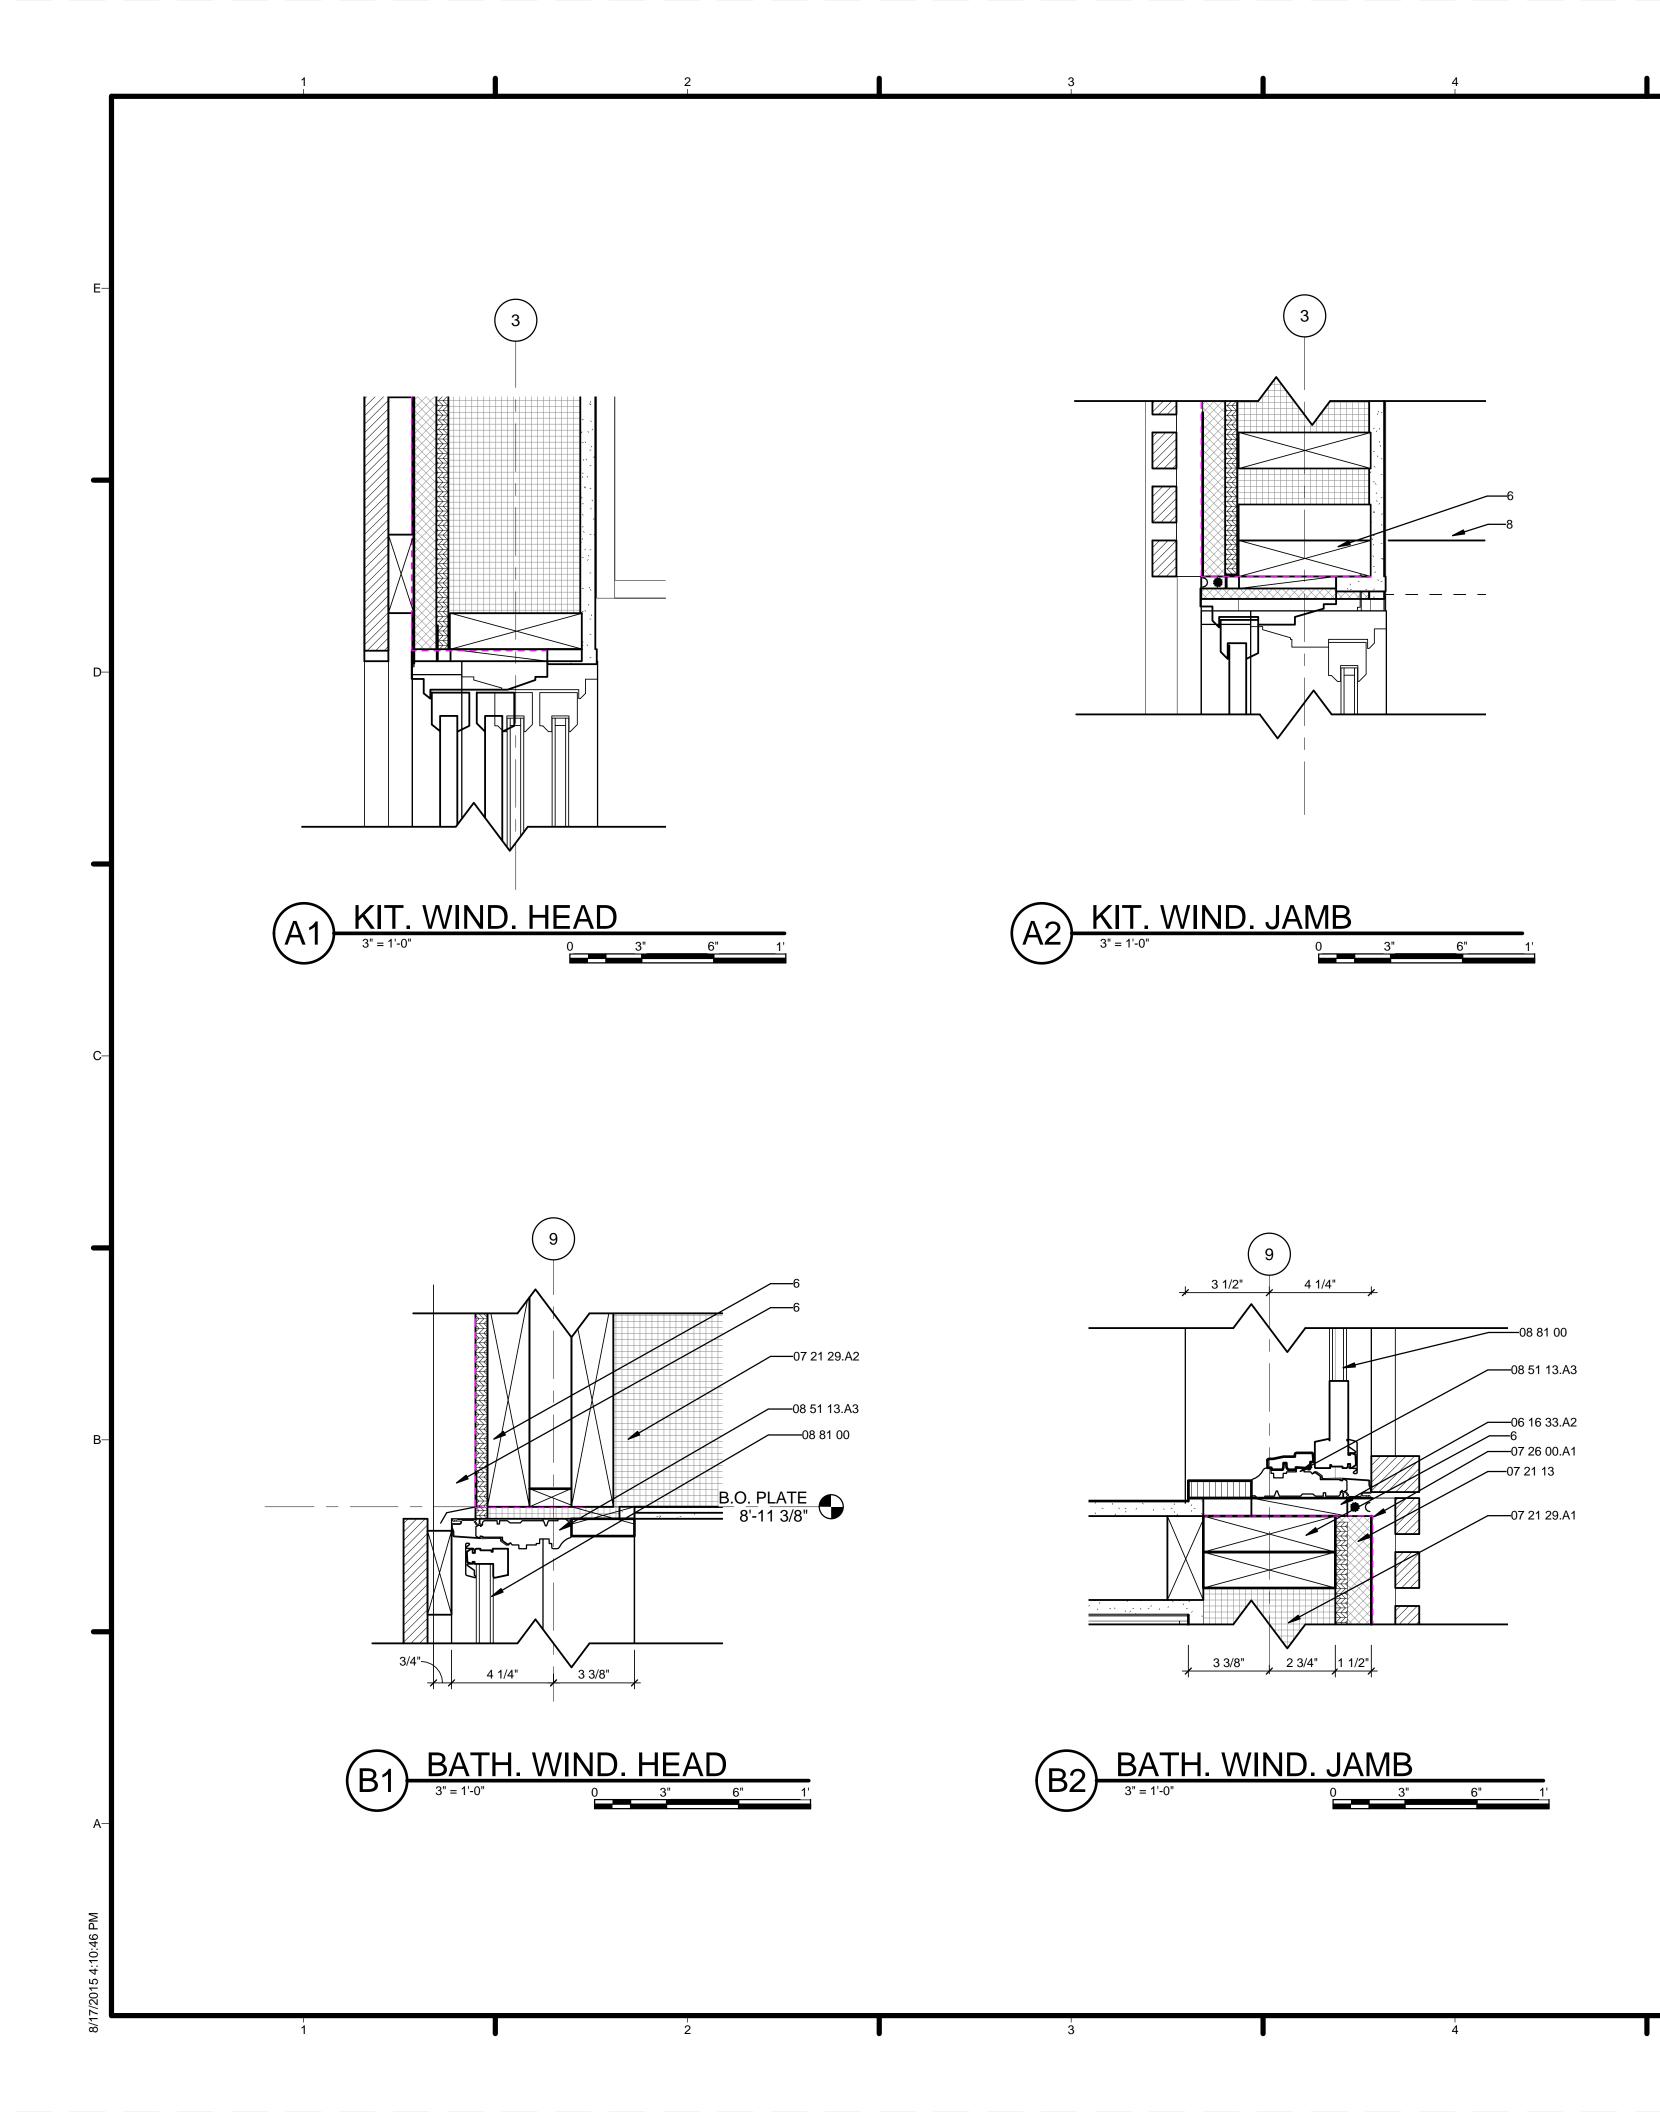


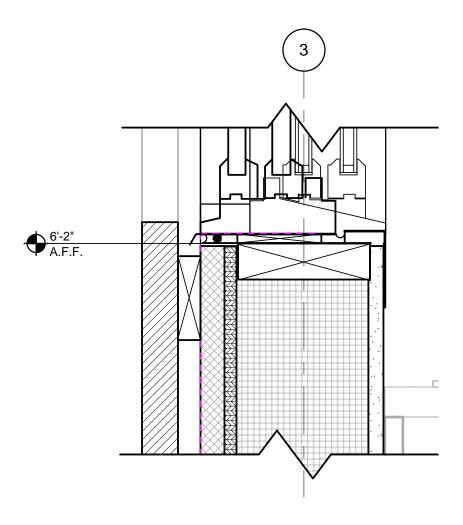







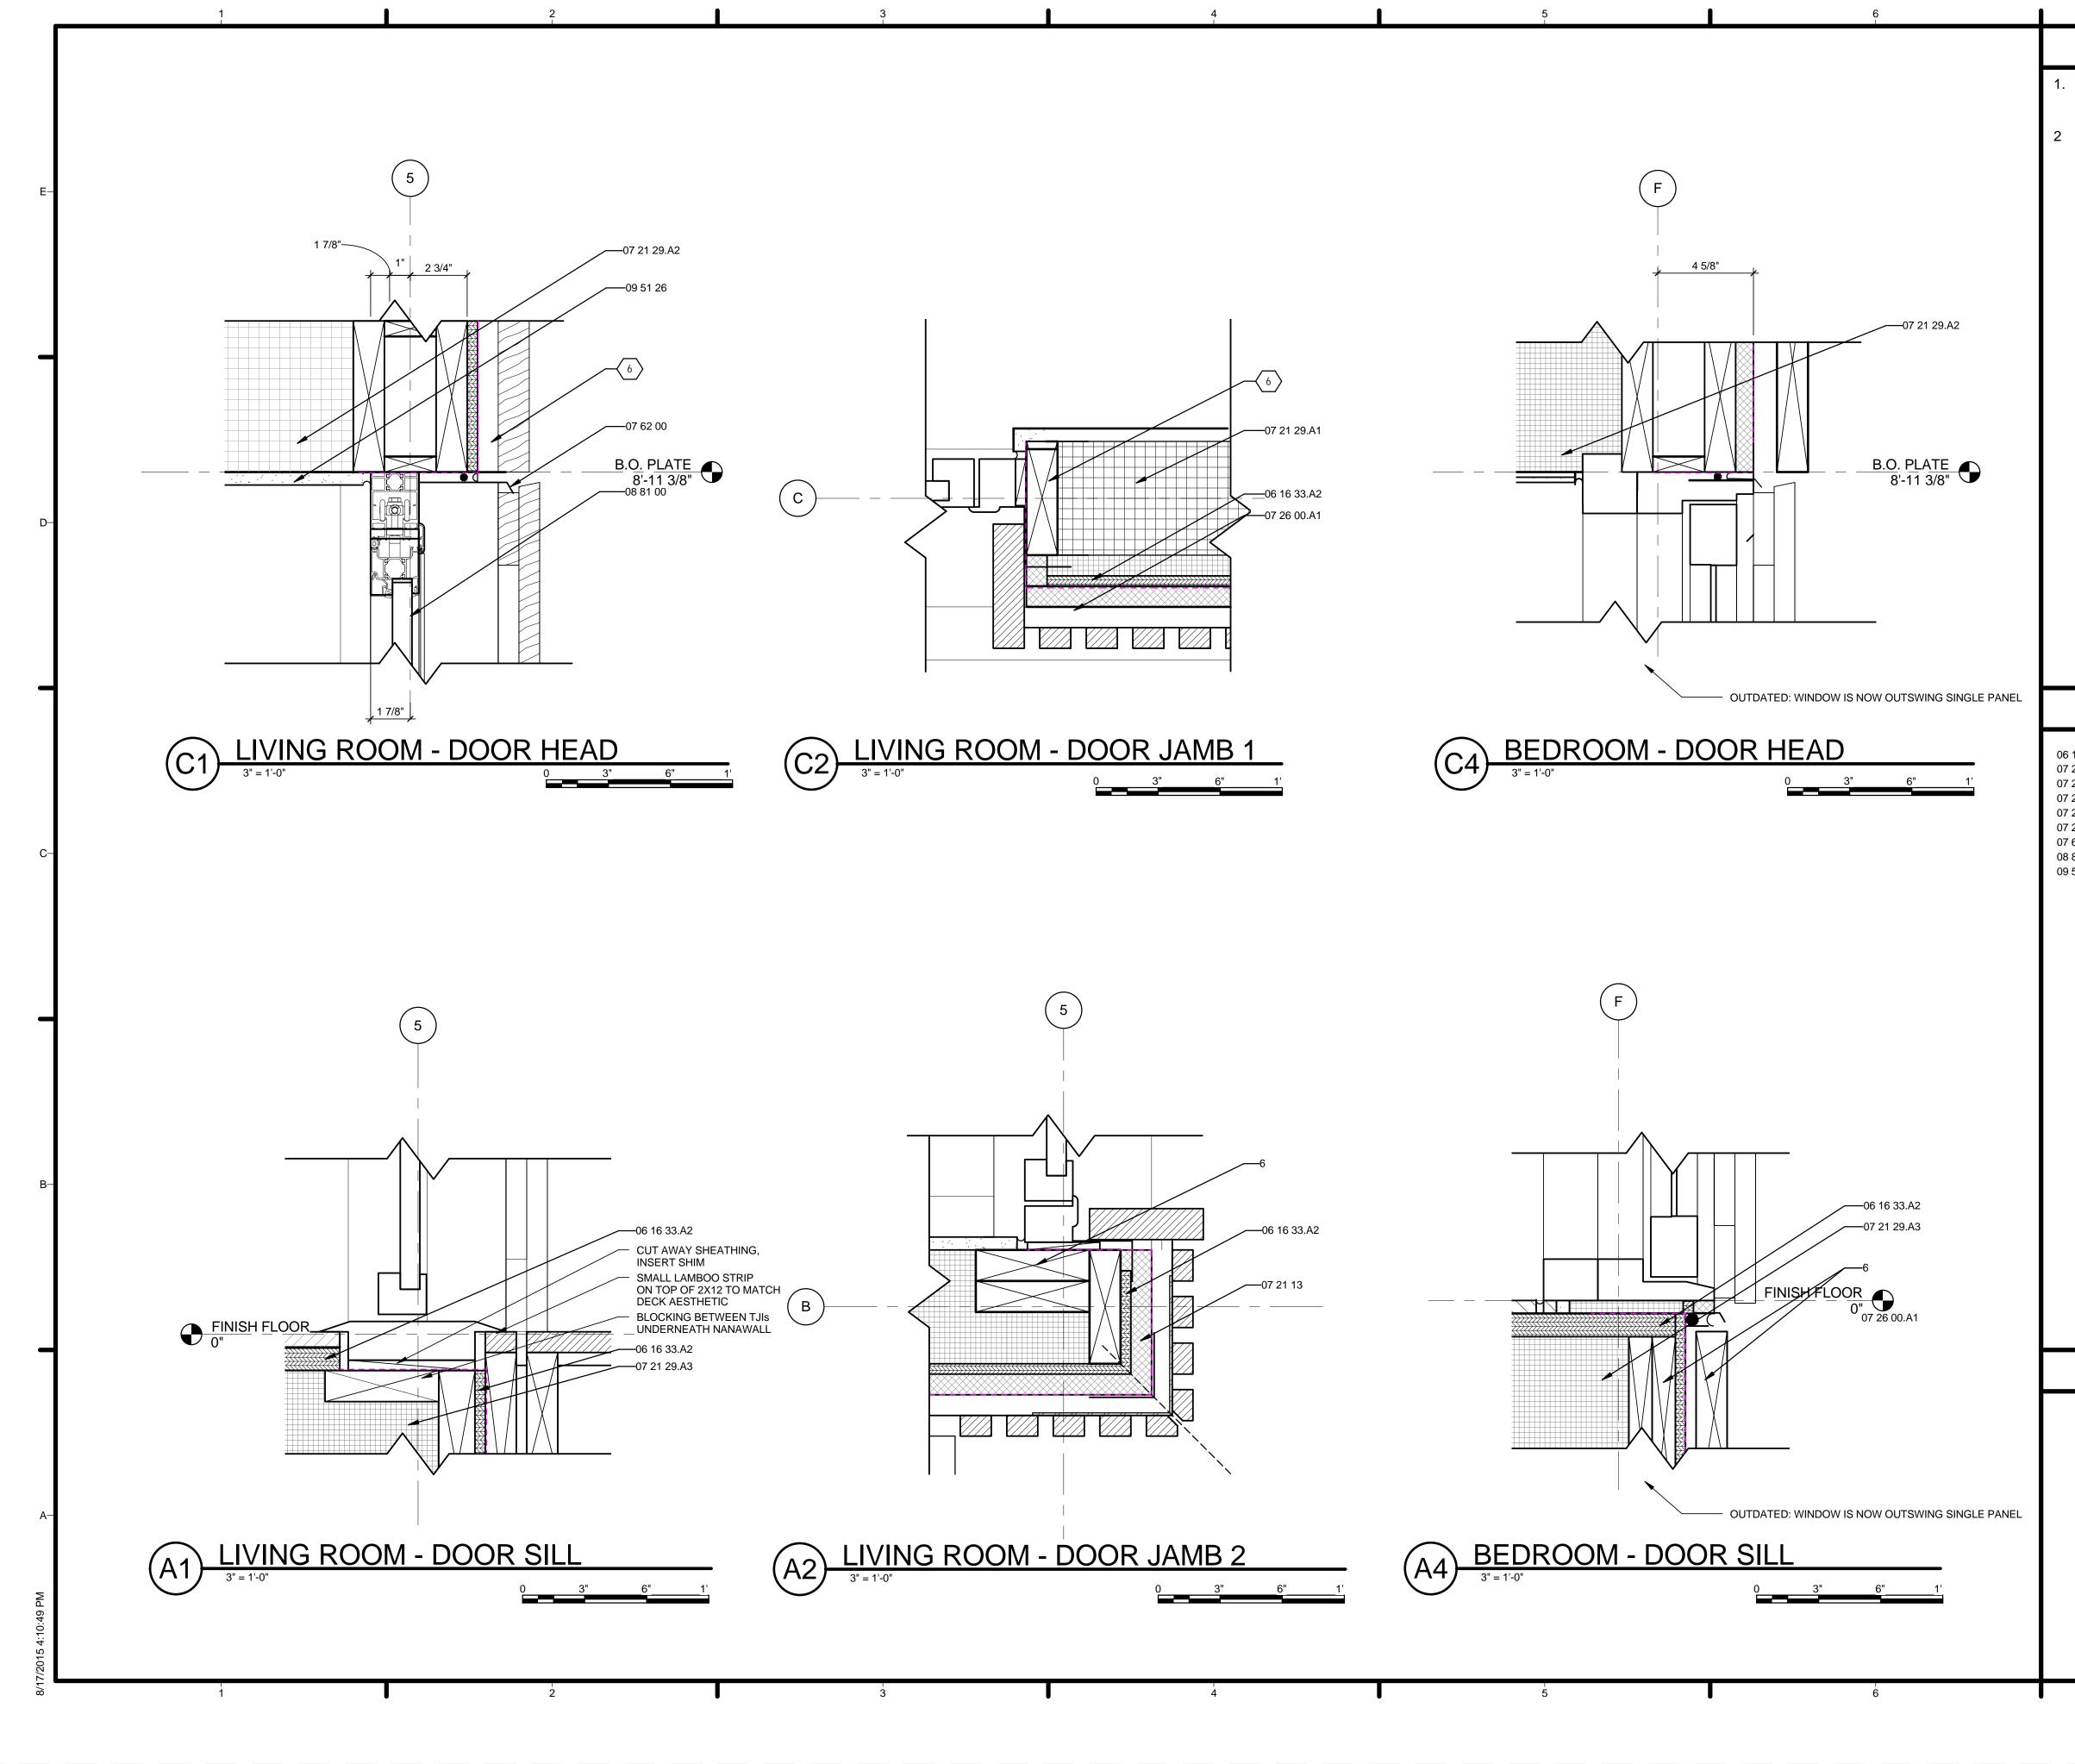

GENERAL SHEET NOTES	
1. VERIFY ALL DIMENSIONS IN FIELD PRIOR TO FABRICATION AND	
INSTALLATION 2 REF: PROJECT MANUAL AND CIVIL,	
ARCHITCTURAL, STRUCTURAL, PLUMBING, MECHANICAL & ELECTRICAL	
DRAWINGS FOR ADDITIONAL INFORMATION	-E
	DOVUIC
	nexus
	TEAM NAME:TEAM TEXAS/GERMANYADDRESS:UNIVERSITY OF TEXAS AT AUSTIN
	2400 INNER CAMPUS DR AUSTIN, TX 78712
	CONTACT: TEXAS.TEAM15@YAHOO.COM
	-D
	CONSULTANTS:
	JQ (STRUCTURAL ENGINEERING) -
	-
REFERENCE KEYNOTES	
06 16 33.A2WOOD BOARD SHEATHING07 21 13BOARD INSULATION07 21 02 A1OPDAVED INSULATION	
07 21 29.A1SPRAYED INSULATION-WALL07 21 29.A2SPRAYED INSULATION-ROOF07 21 29.A3SPRAYED INSULATION-FLOOR	
07 26 00.A1VAPOR RETARDERS07 62 00SHEET METAL FLASHING AND TRIM	
08 81 00GLAZING09 51 26ACOUSTICAL WOOD CEILINGS	-C CLIENT U.S. DEPARTMENT OF ENERGY
	SOLAR DECATHLON 2015 WWW.SOLARDECATHLON.GOV
	U.S. DEPARTMENT OF ENERGY SOLAR DECATHLON
	-в
	1 MAR 26, 2015 CD 100% 2 AUG 17, 2015 AS BUILT
	MARK DATE DESCRIPTION
	LOT NUMBER: 104
SHEET KEYNOTES	DRAWN BY: HW CHECKED BY: KC
	COPYRIGHT: NONE: PROJECT IS PUBLIC DOMAIN
6 REF: STRUCTURAL DRAWINGS	
	DOOR DETAILS
	A-541
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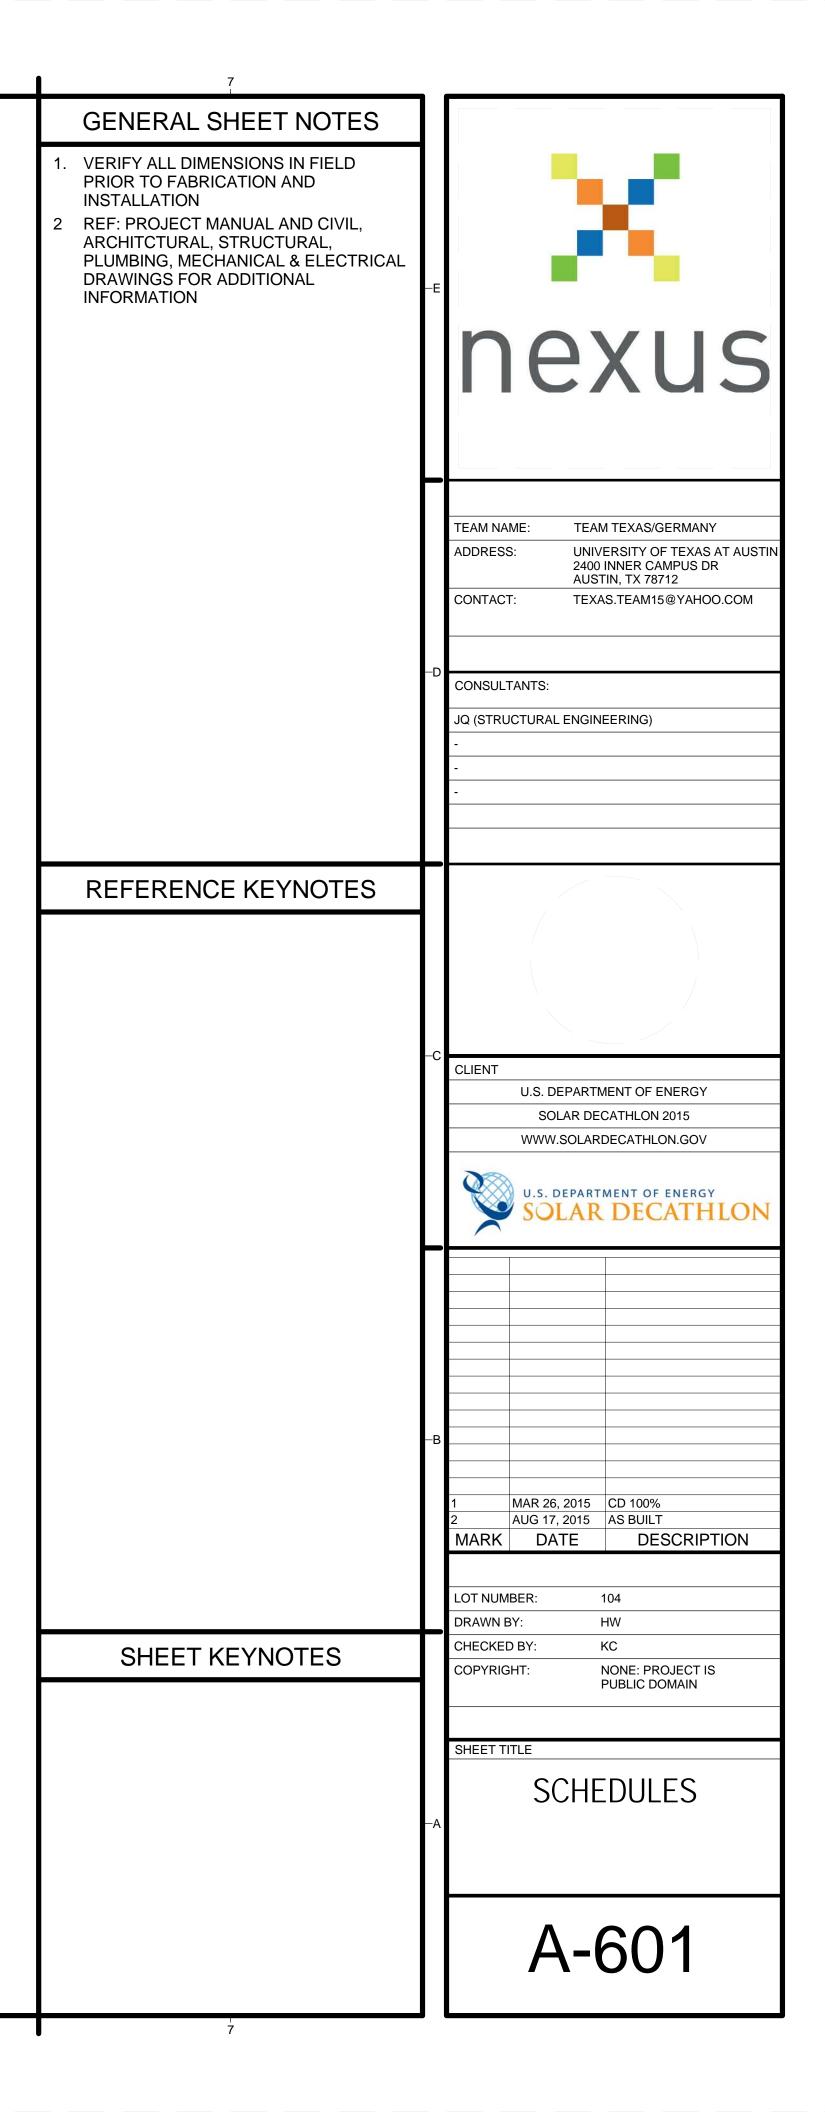
ROOM FINISH SCHEDULE											
ROOM NAME	FLOOR	WALL	CEILING	CEILING HEIGHT	COUNTERTOP	CASEWORK	COMMENTS				
STUDIO	FL01	PT01	PT02	8'-10 7/8"	N/A	WVNR01					
THRSHD.	FL01	PT01	PT02	8'-10 7/8"	N/A	N/A					
MASTER BEDROOM	FL01	PT01	PT02	8'-10 7/8"	N/A	WVNR01					
BATHROOM	FL01/FL02	PT01/TL01	PT02	7'-9"	SS01	WVNR01	FL02 AND TL01 IN SHOWER ONLY. CEILING HEIGHT IN SHOWER IS 8'-10 7/8".				
KITCHEN/DINING	FL01	PT01	PT02	8'-10 7/8"	SS01	WVNR01					
LIVING	FL01	PT01	PT02	8'-10 7/8"	N/A	WVNR01					

FLOOR SCHEDULE									
MARK	MANUFACTURER DESCRIPTION COMMENT								
FL01	AUSTIN FINE LUMBERS	RECYCLED PINE							
FL02	ECO FRIENDLY FLOORING	DIRTY WHITE GLOSSY GLASS TILE							

WALL SCHEDULE											
MARK	ТҮРЕ	COUNT	Width	Length	STRUCTURAL USAGE	AREA	COMMENTS	DESCRIPTION			
	SKID WALL	8	4"	38'-10"	Non-bearing	311 SF					
01	EXTERIOR	8	7 5/8"	155'-1 11/16"	Bearing	1,175 SF	VAPOR, CORK, OSB, 6" STUD, GYP				
02	INTERIOR-BATHWALL	1	6 3/4"	12'-10 7/8"	Non-bearing	78 SF	GYP, 6" STUD, GYP				
O3	INTERIOR	5	4 3/4"	59'-11 15/16"	Non-bearing	141 SF	GYP, 6" STUD				

WINDOW SCHEDULE																
ROUGH OPENING											DETAIL		GL	AZING		
			SILL									THICKNE		HEAD		
MARK	WIDTH	HEIGHT	HEIGHT	TYPE	COUNT	MANUFACTURER	SERIES	MATERIAL	FINISH	HEAD	JAMB	SILL	SS	TYPE	HEIGHT	COMMENTS
W1	2'-11"	5'-11"	-5/8"	FIXED	1	WESTERN WINDOW SYSTEM	600	ALUMINIUM	DARK BRONZE ANODISED				7/8"	TEMPERED	5'-10 3/8"	THERMALLY BROKEN
W2	7'-5"	2'-5 1/2"	3'-6 3/8"	MULTI-SLIDE STACKING	1	WESTERN WINDOW SYSTEM	600	ALUMINIUM	DARK BRONZE ANODISED				7/8"	TEMPERED	5'-11 7/8"	NOT THERMALLY BROKEN

DOOR SCHEDULE																	
	DR TYPE						FRAME		[DETAILS	6			FINISH			
MARK	MARK	DR TYPE	Height	Width	MANUFACTURER	MODEL	TYPE	FIRE RATING	HEAD	JAMB	SILL	DESCRIPTION	DOOR	FRAME	HANDLE	U-VALUE	E SHGC
101A	109	FOLDING SYSTEM	8'-11 3/8"	9'-0"	NANAWALL SYSTEMS, INC.	SL-60	ALUMINIUM	AS SPECIFIED	A1	A2/A3	A4	STANDARD THERMALLY CONTROLLED	DARK ANODISED BRONZE	DARK ANODISED BRONZE	STAINLESS STEEL	0.27	0.23
102A	109	FOLDING SYSTEM	8'-11 3/8"	9'-0"	NANAWALL SYSTEMS, INC.	SL-60	ALUMINIUM	AS SPECIFIED	A1	A2/A3	A4	STANDARD THERMALLY CONTROLLED	DARK ANODISED BRONZE	DARK ANODISED BRONZE	STAINLESS STEEL	0.27	0.23
103A	109	FOLDING SYSTEM	8'-11 3/8"	9'-0"	NANAWALL SYSTEMS, INC.	SL-60	ALUMINIUM	AS SPECIFIED	A1	A2/A3	A4	STANDARD THERMALLY CONTROLLED	DARK ANODISED BRONZE	DARK ANODISED BRONZE	STAINLESS STEEL	0.27	0.23
103B	107	INTERIOR SLIDING	8'-11 1/2"	3'-8 1/4"	DOOR OUTLET	BARN TRACK	WOOD	AS SPECIFIED				ALUMINIUM TRACK	WOOD	WOOD			
104A	85	INTERIOR SLIDING	7'-0"	3'-1 5/16"	DOOR OUTLET	POCKET DOOR	WOOD	S SPECIFIED				POCKET GLASS DOOR	FROSTED GLASS	WOOD			
105A	105A	SINGLE OUTSWING RH (44" x 107 1/4")	8'-11 1/4"	3'-8"	LACANTINA DOORS, INC.	ALUMINIUM	ALUMINIUM	AS SPECIFIED	B1		B2	THERMALLY CONTROLLED	BRONZE ANODISED	BRONZE ANODISED	BRONZE	0.51	0.21
106A	106A	SINGLE OUTSWING RH (35.5" x 107 1/4")	8'-11 1/4"	2'-11 1/2"	LACANTINA DOORS, INC.	ALUMINIUM	ALUMINIUM	AS SPECIFIED	B1		B2	THERMALLY CONTROLLED	BRONZE ANODISED	BRONZE ANODISED	BRONZE	0.51	0.21
106B	107	INTERIOR SLIDING	8'-11 1/2"	3'-8 1/4"	DOOR OUTLET	BARN TRACK	WOOD	AS SPECIFIED				ALUMINIUM TRACK	WOOD	WOOD			



SYMBOL LEGEND MARK DESCRIPTION CENTERLINE ዊ <u>≠ 5'-0"</u> ≠ DIMENSION LINE DOOR TAG 101 1' GRAPHIC SCALE 0 GRID HEAD TAG 1 Ref INTERIOR ELEVATION TAG A101 1 Ref ()NORTH ARROW **REVISION TAG** A4 SECTION CUT TAG A101 1 View Name 1/8" = 1'-0" VIEW TITLE 1L WALL TAG WINDOW TAG

2

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2


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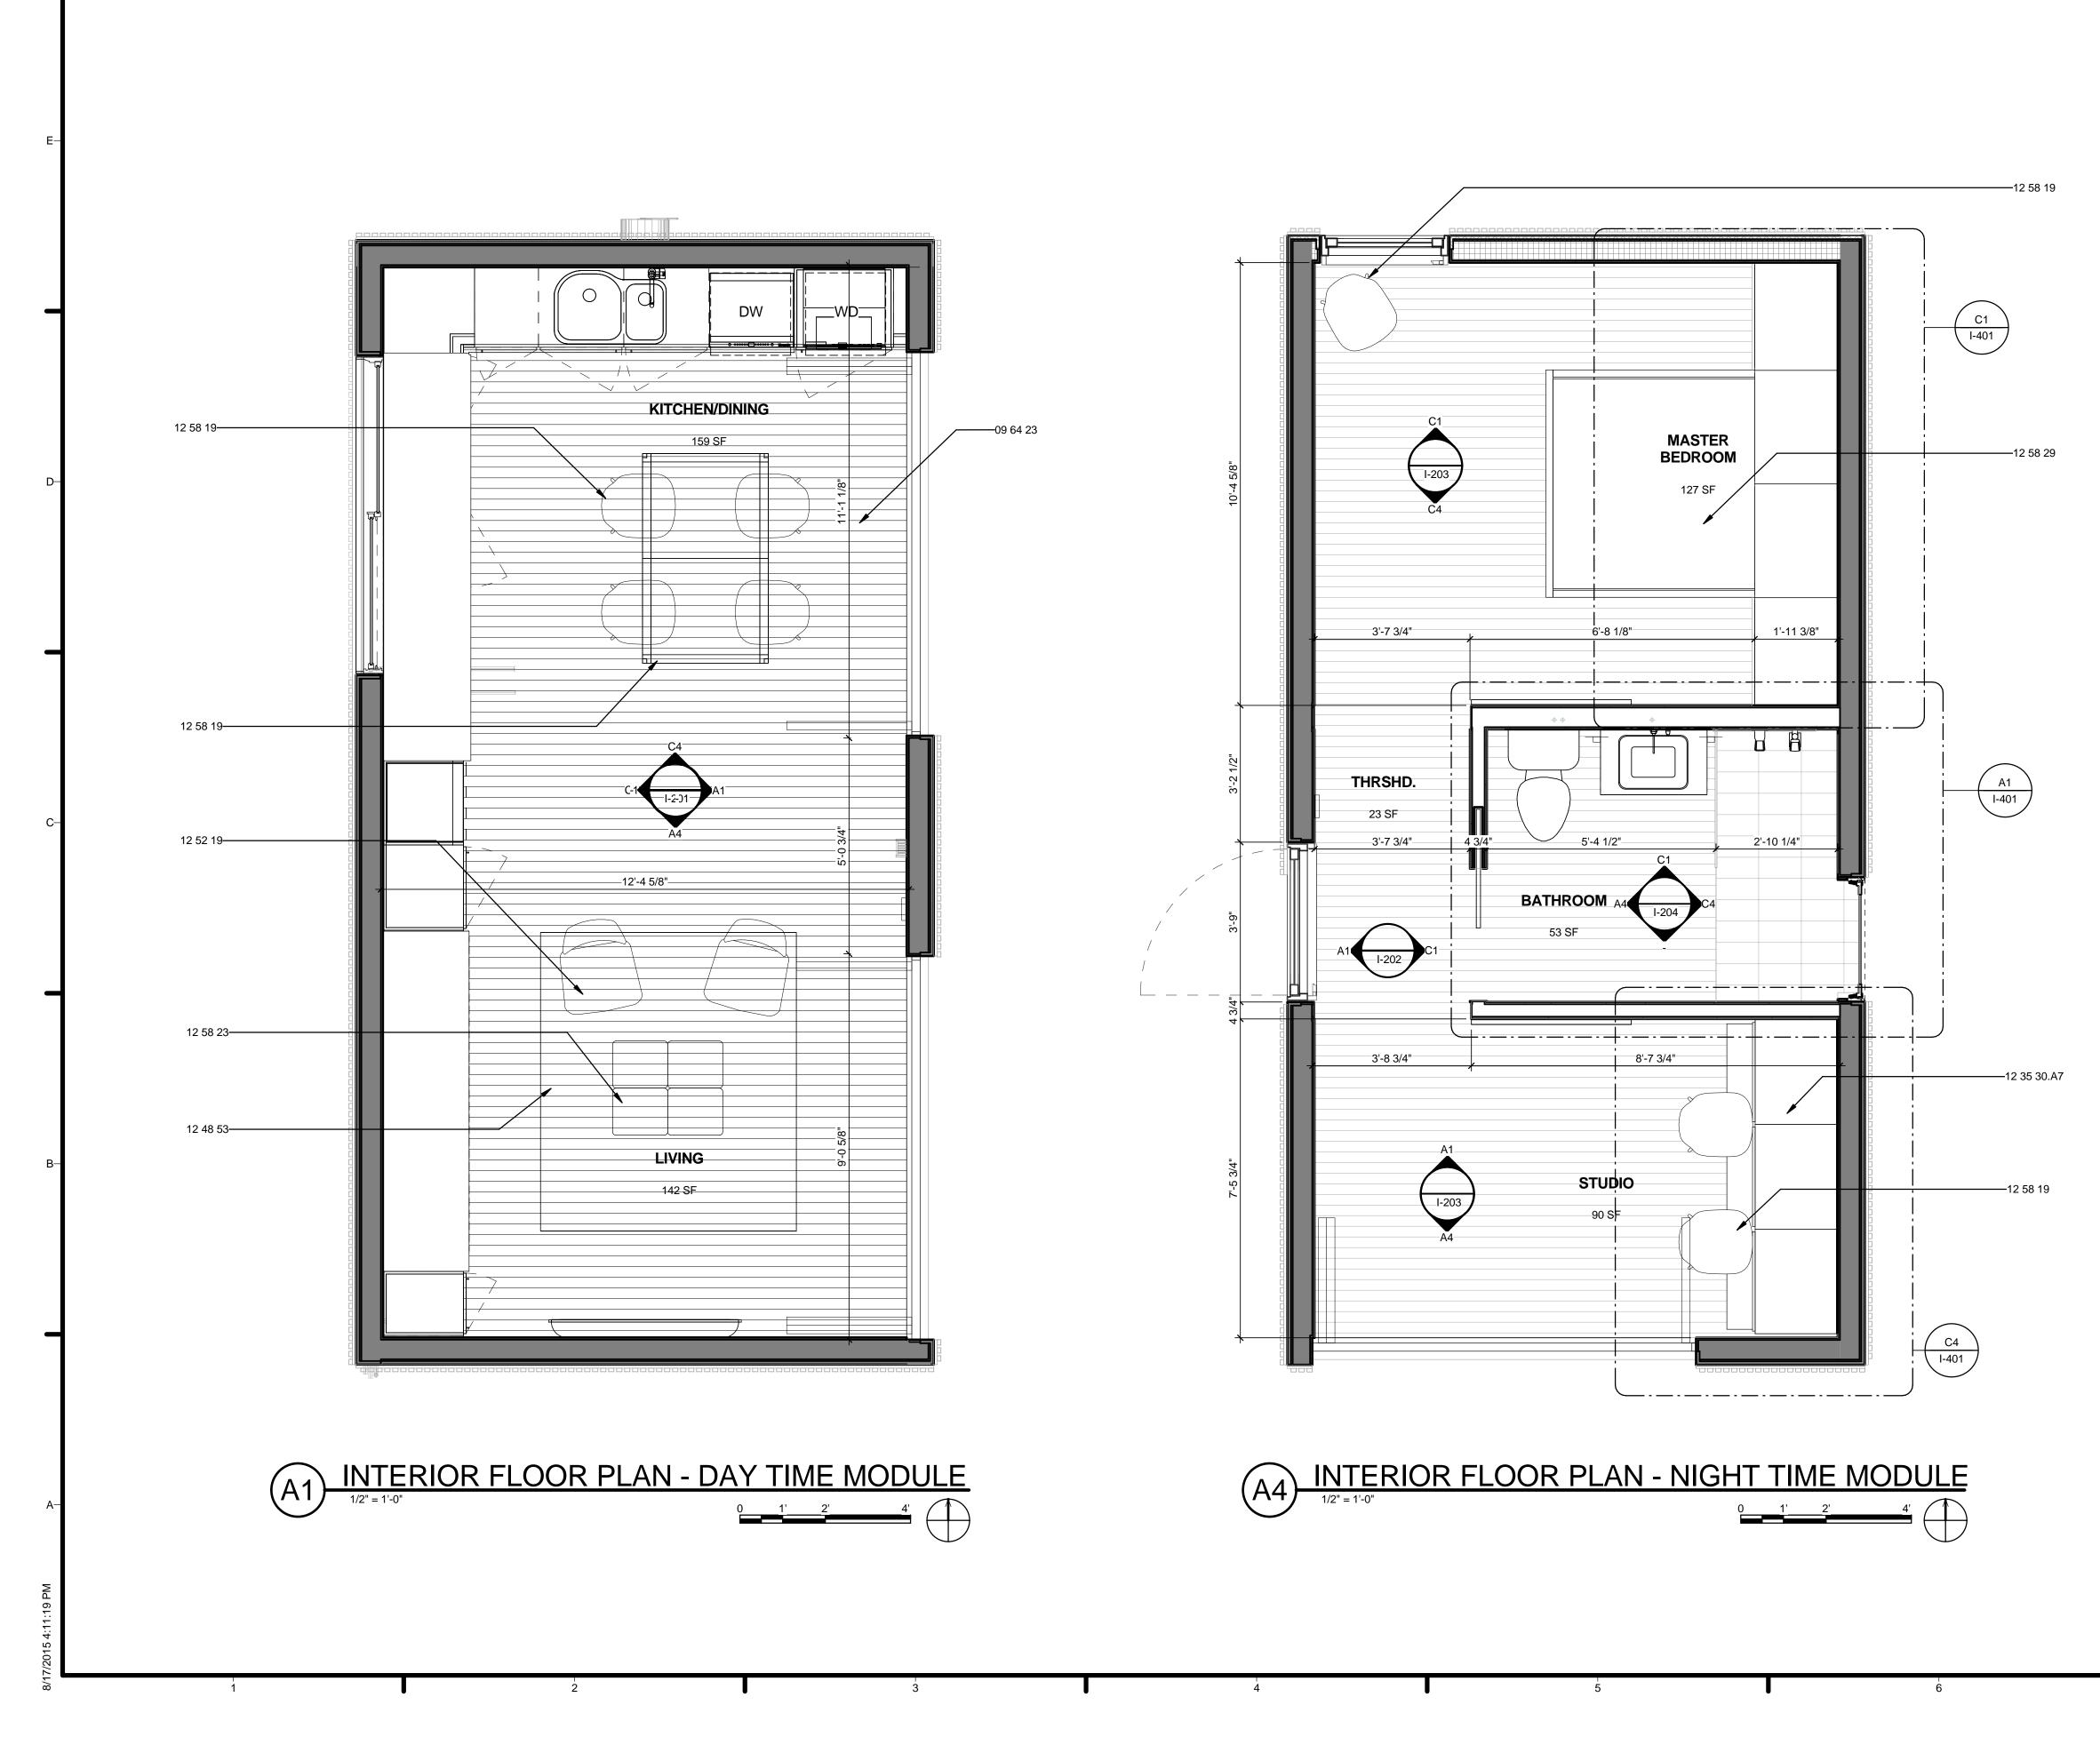
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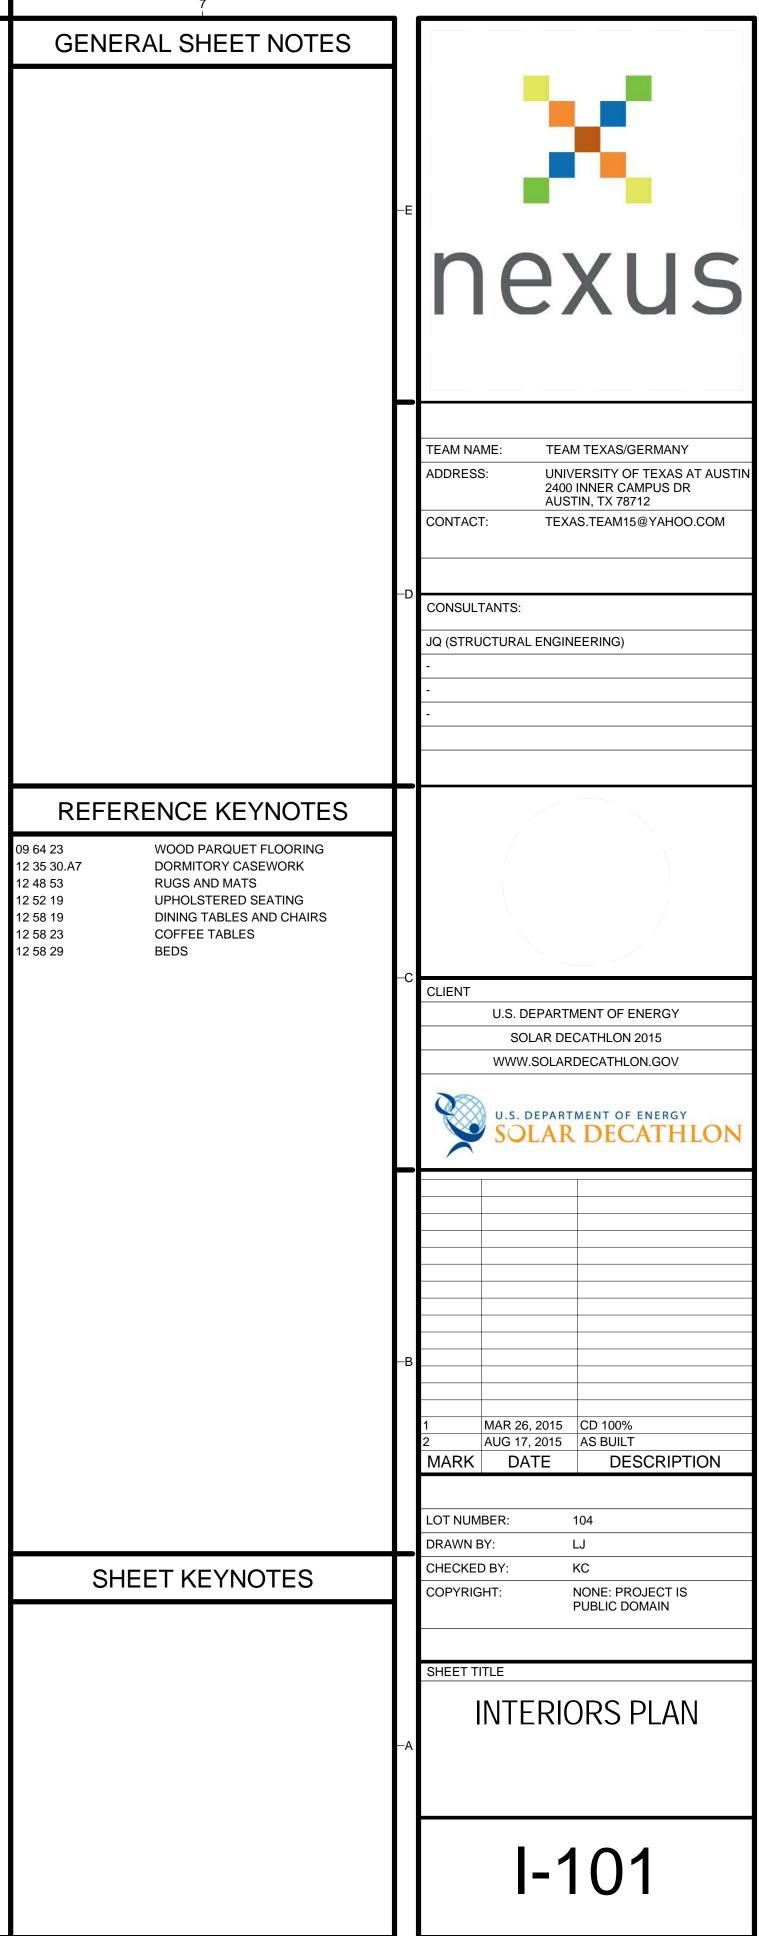
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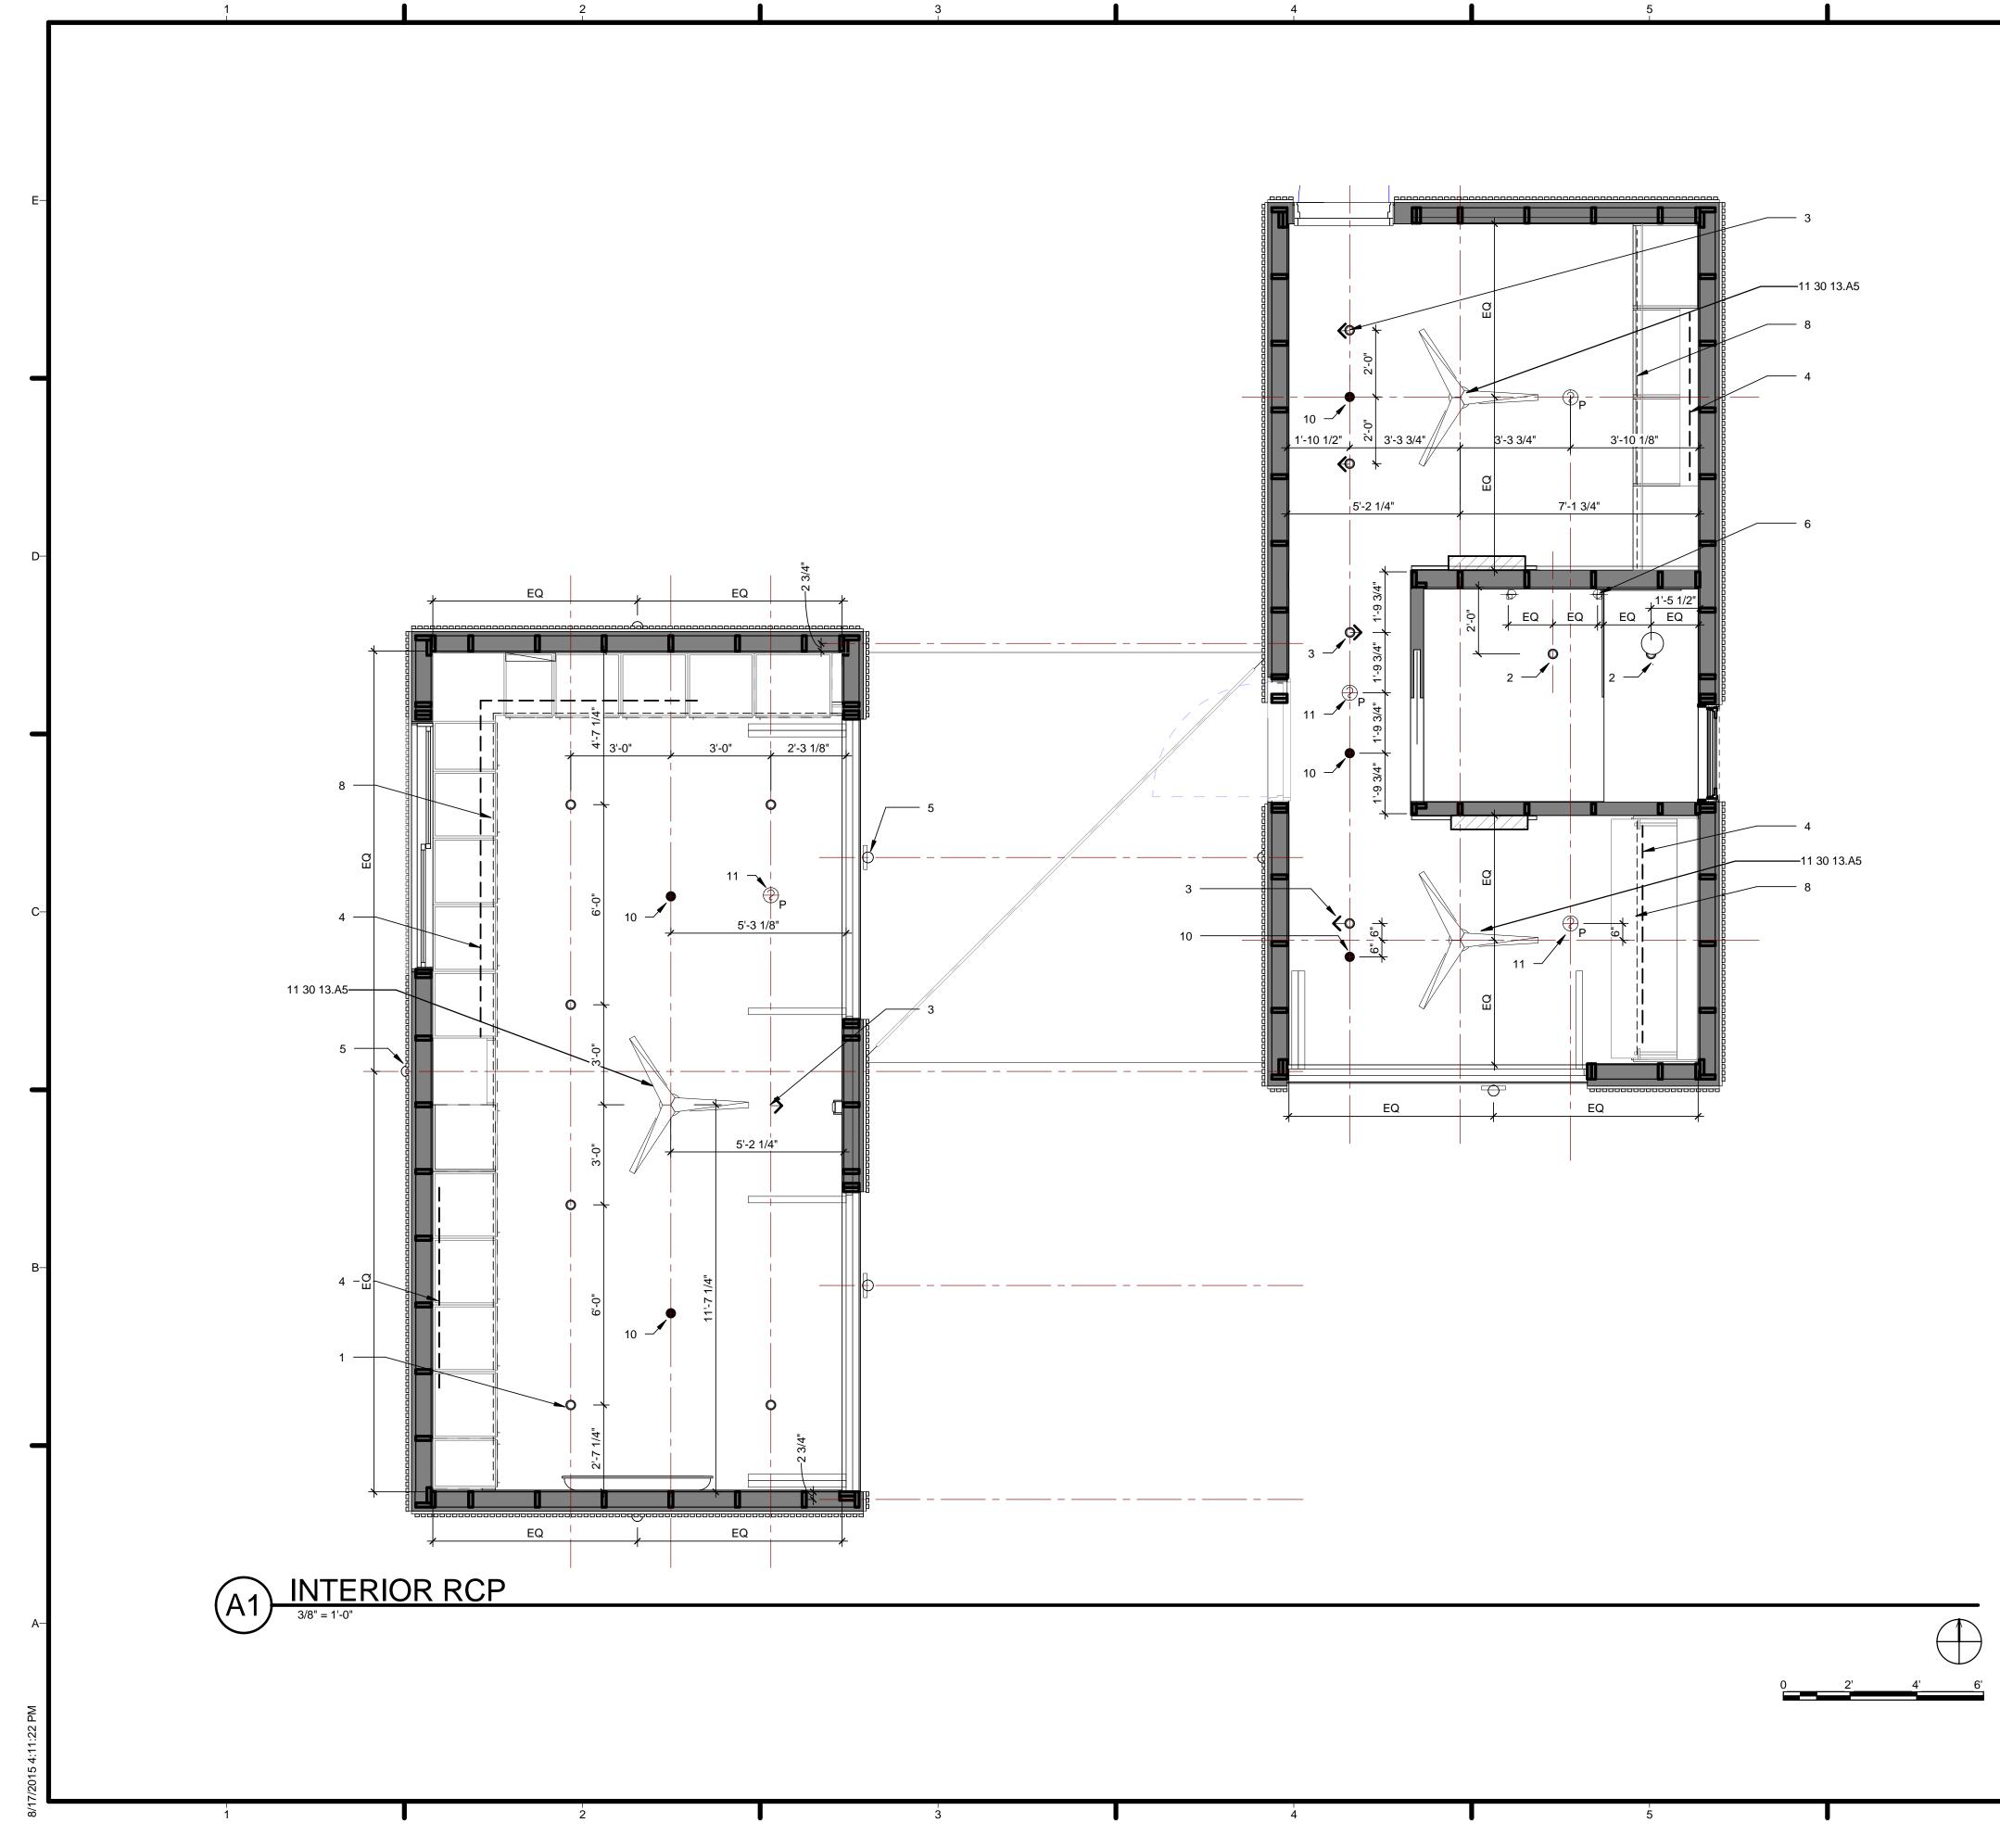
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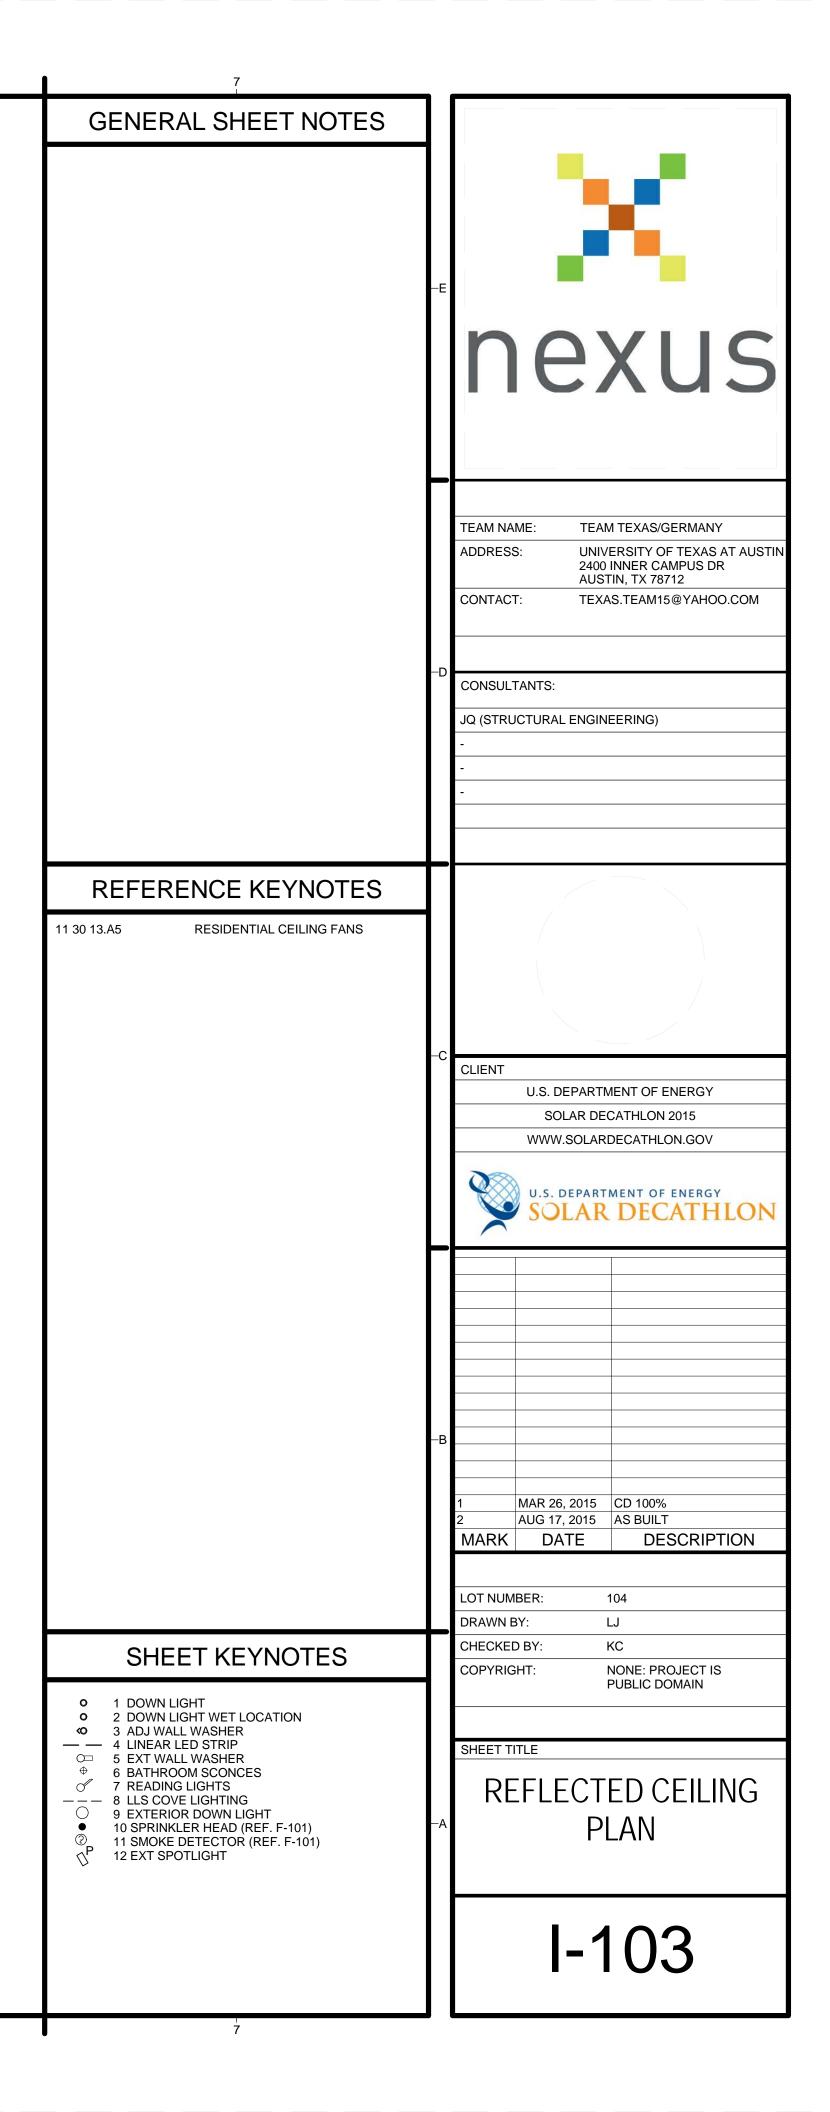
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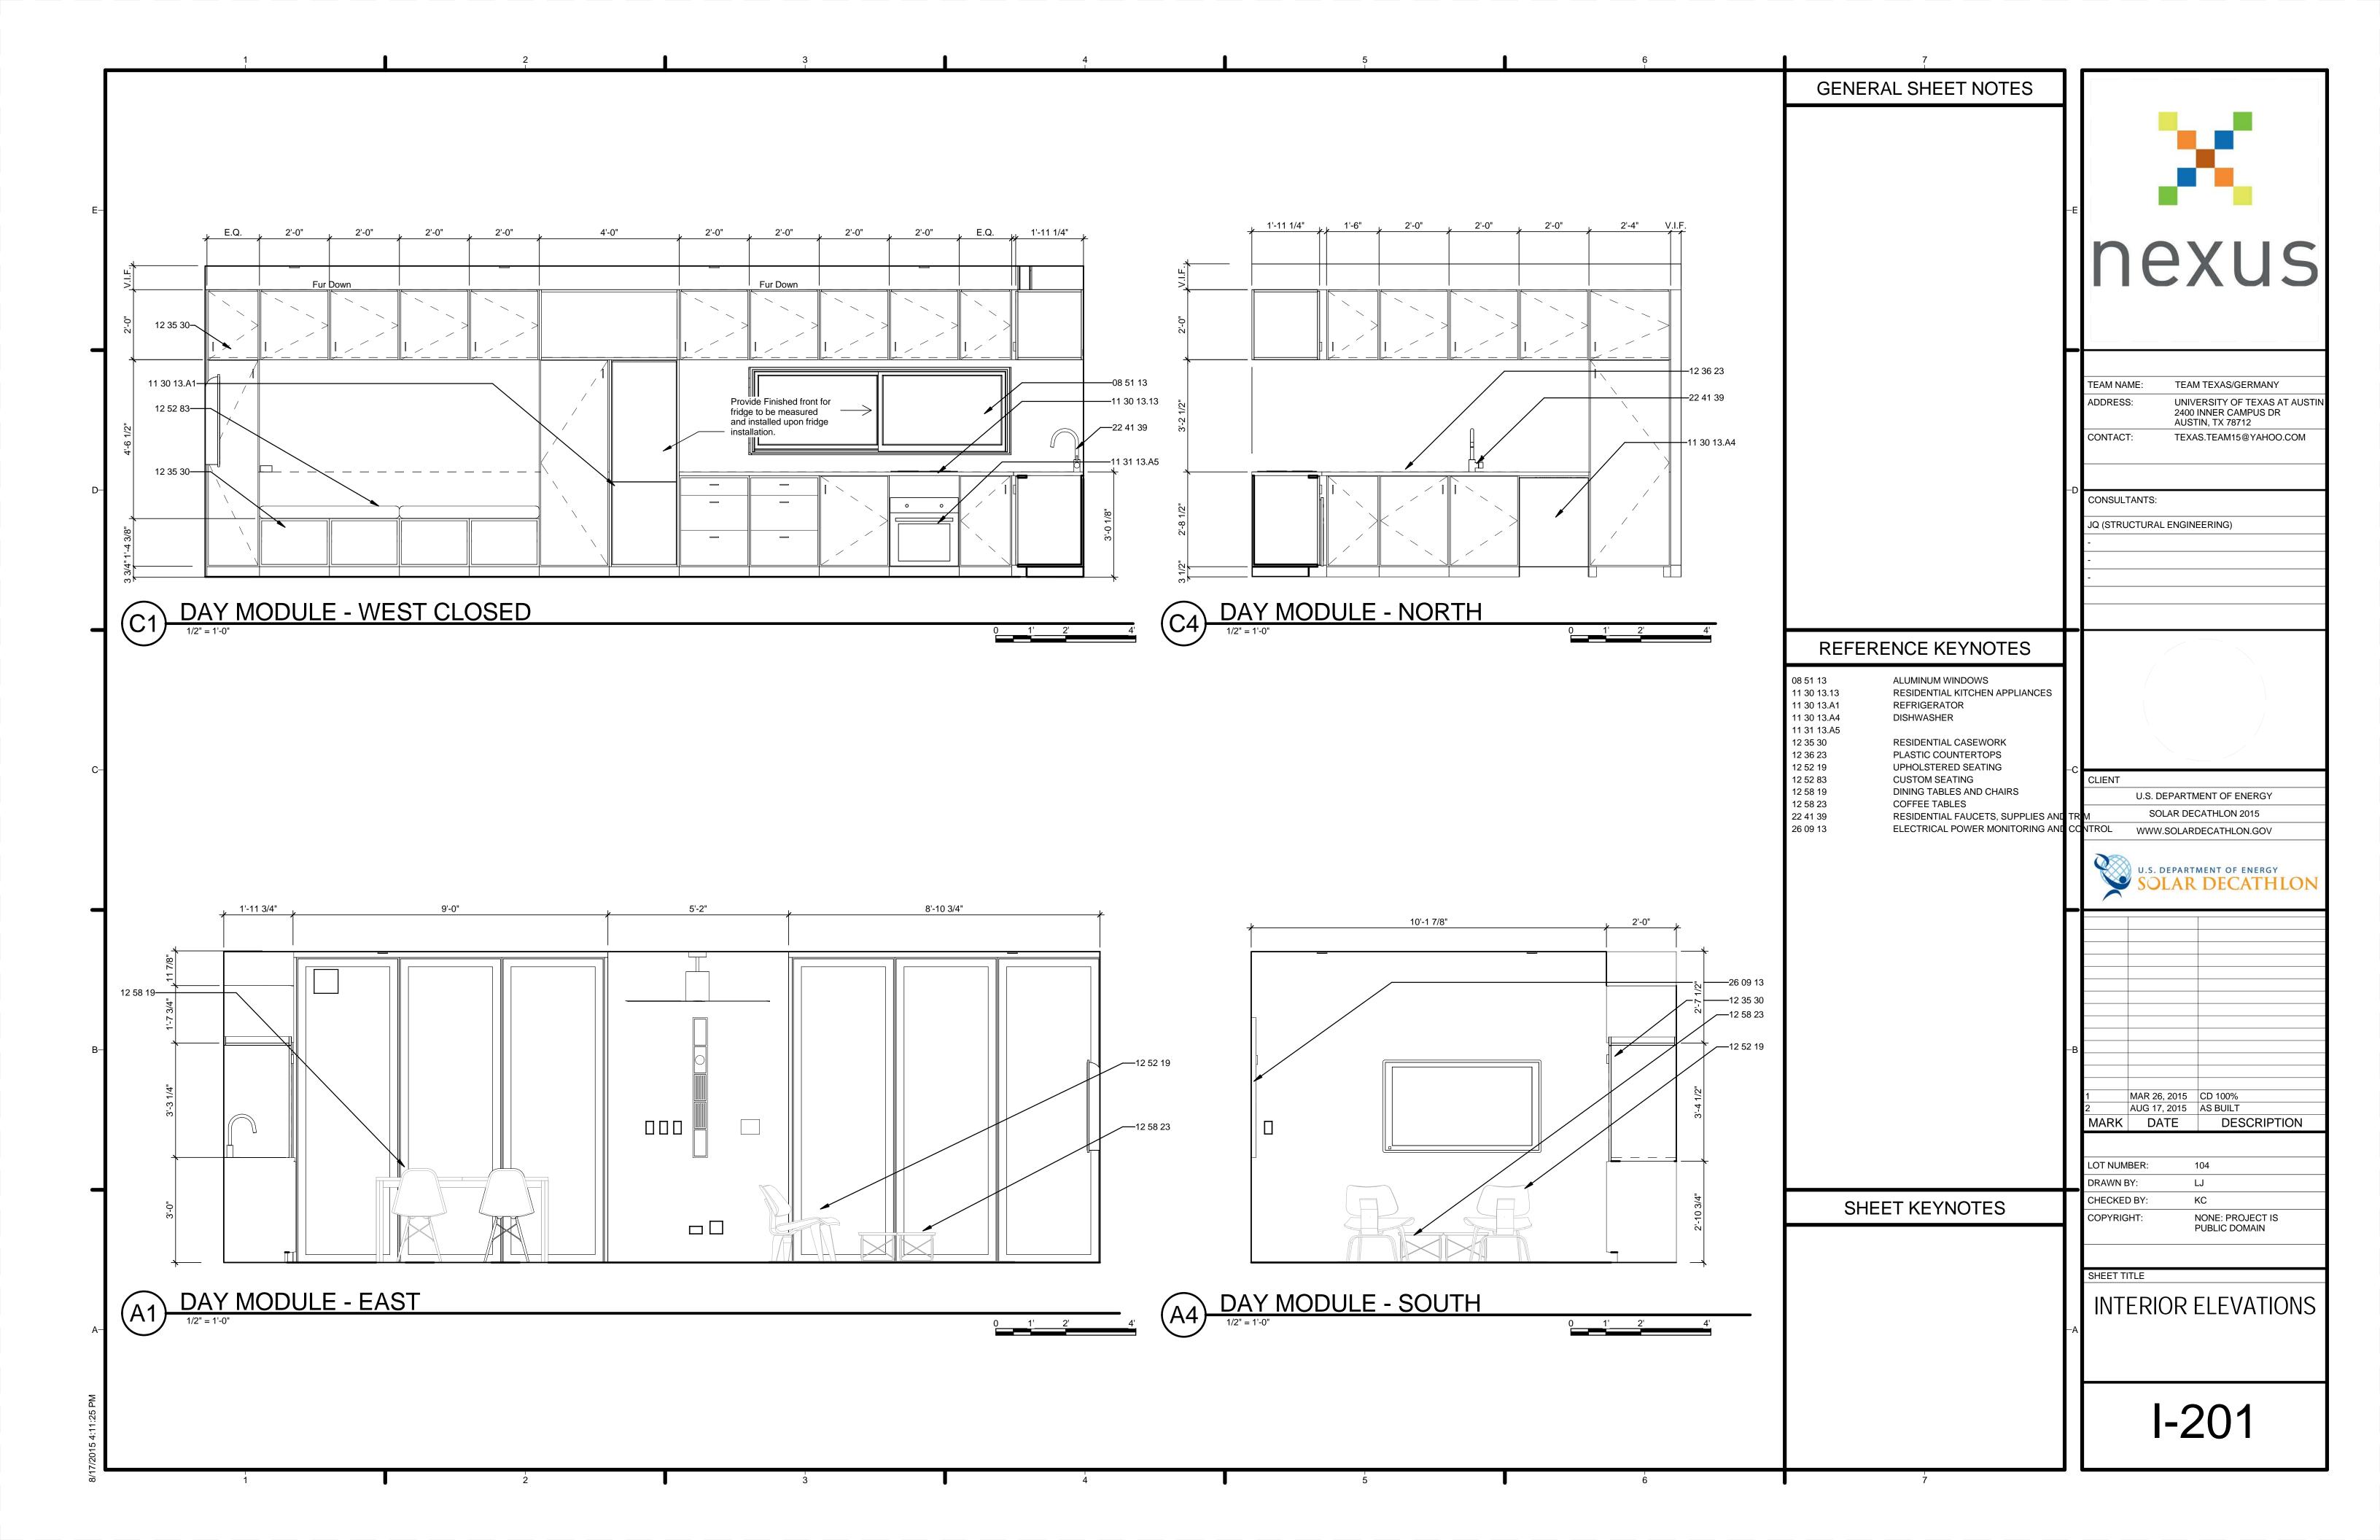














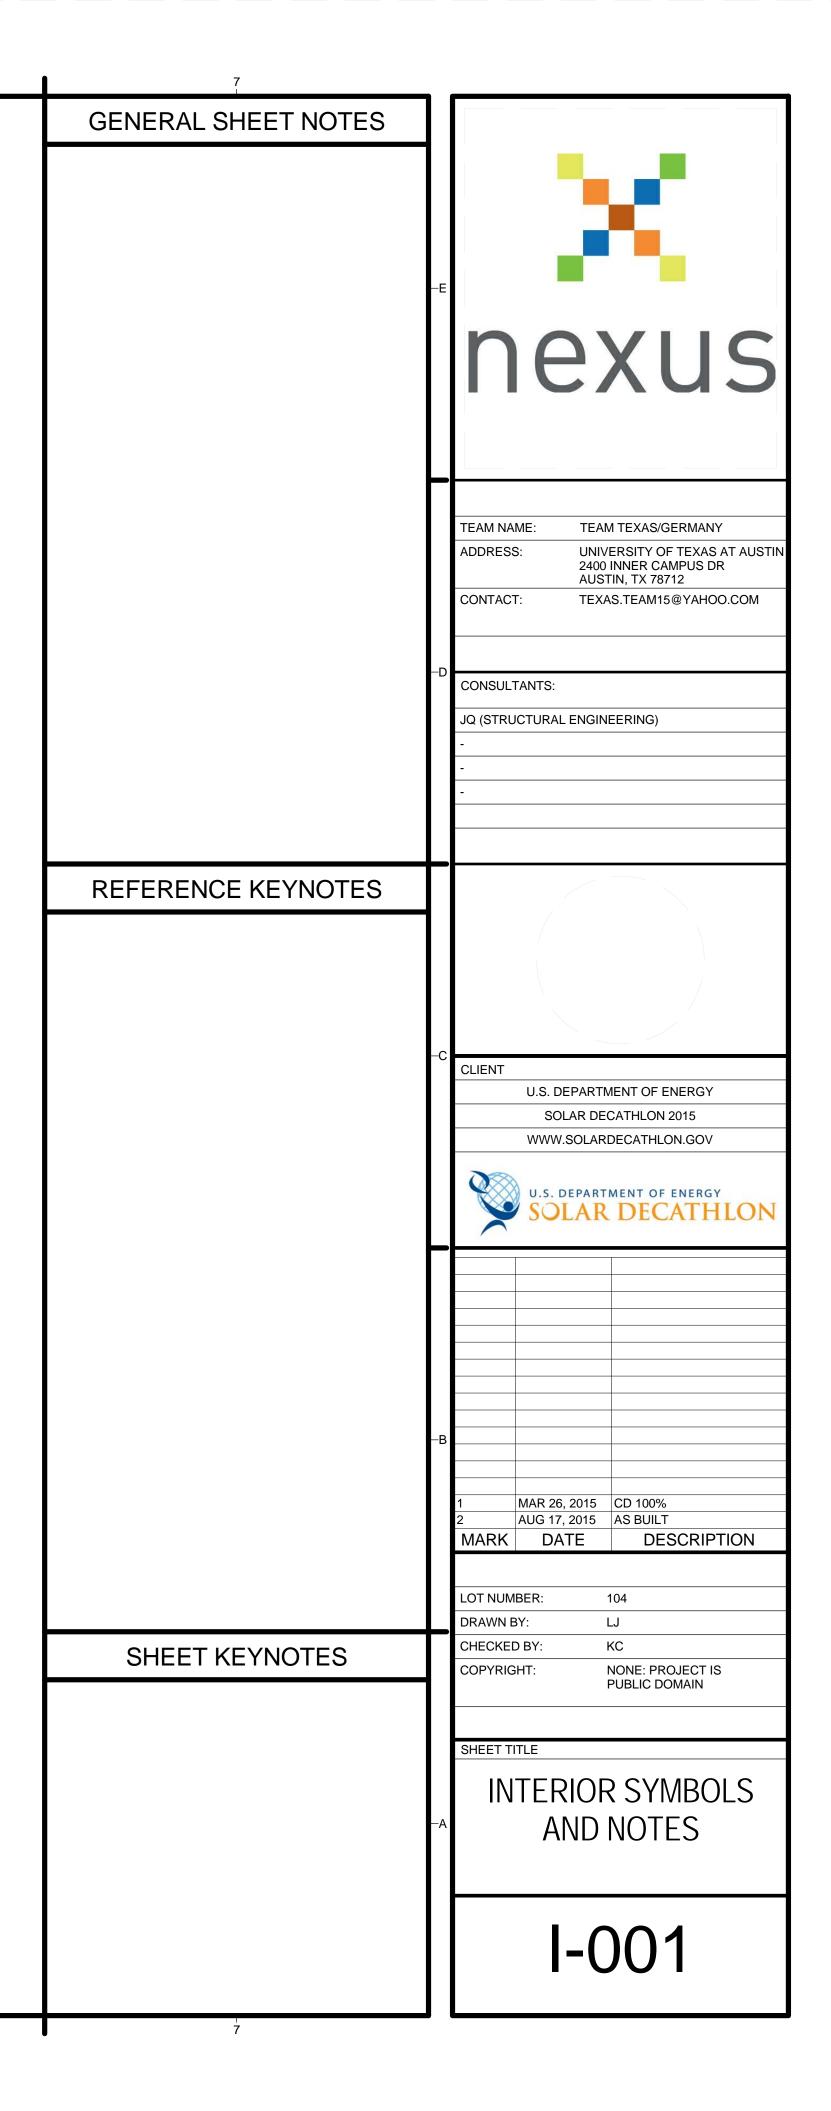


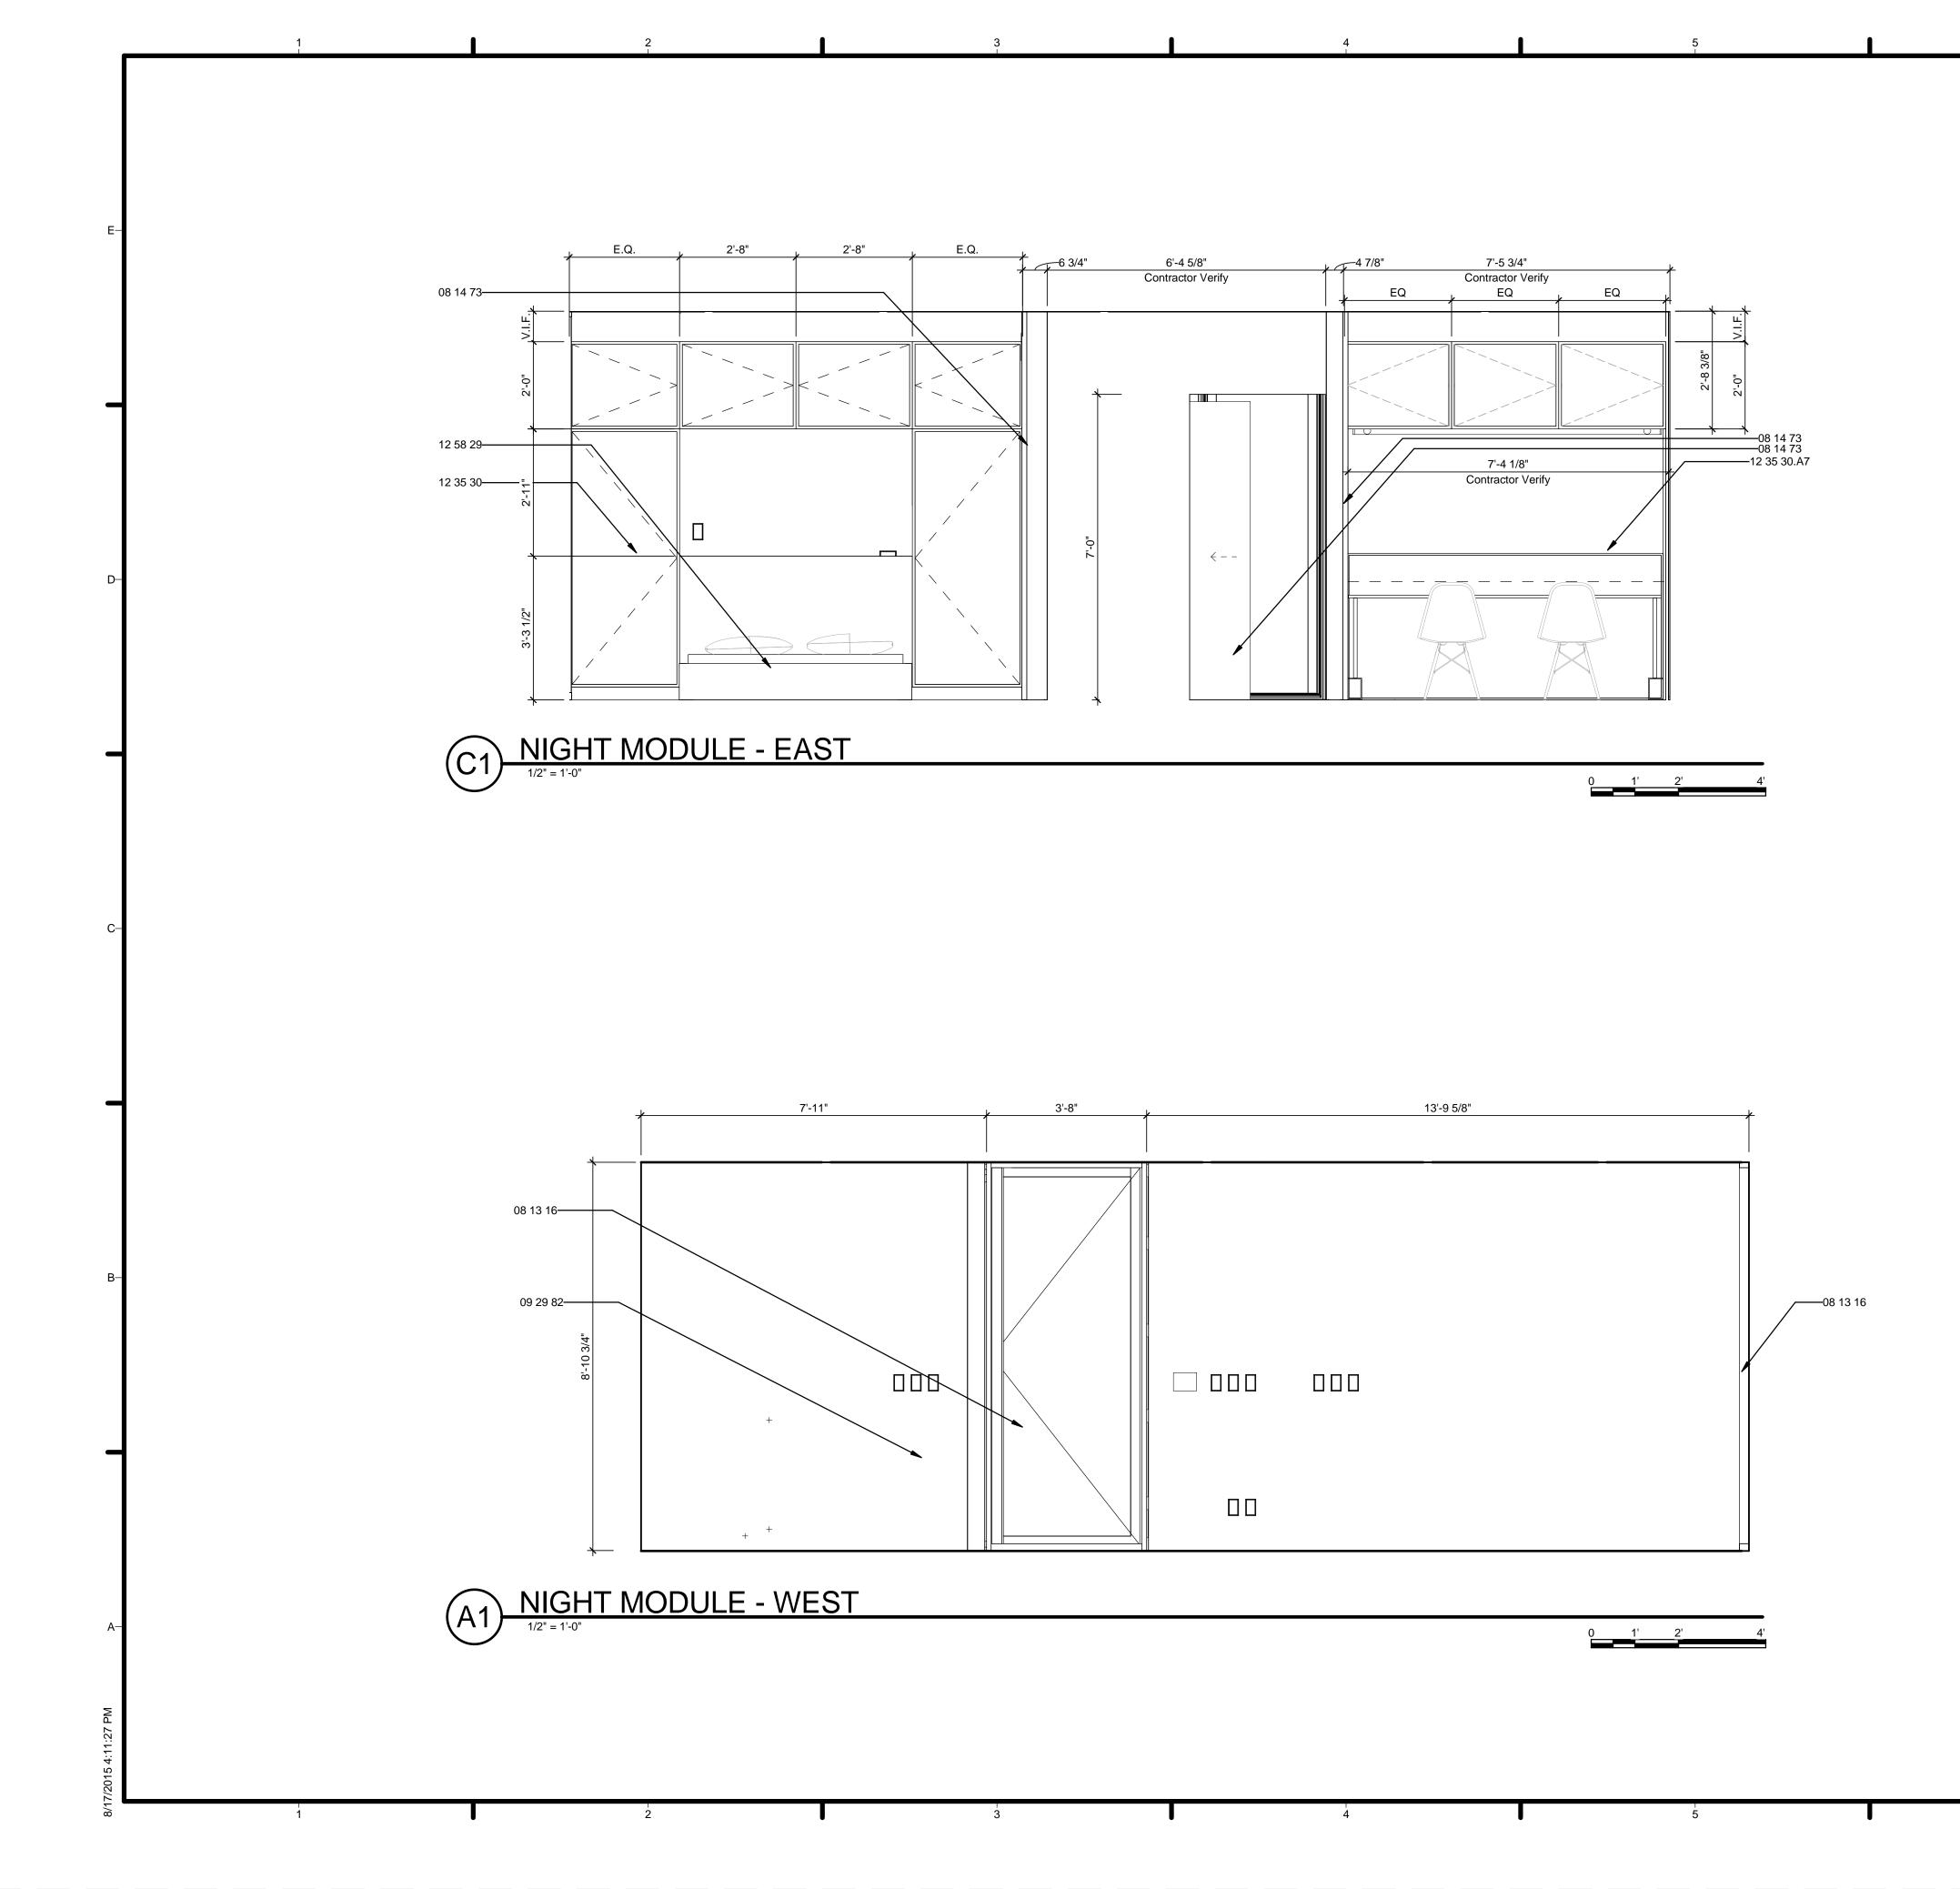

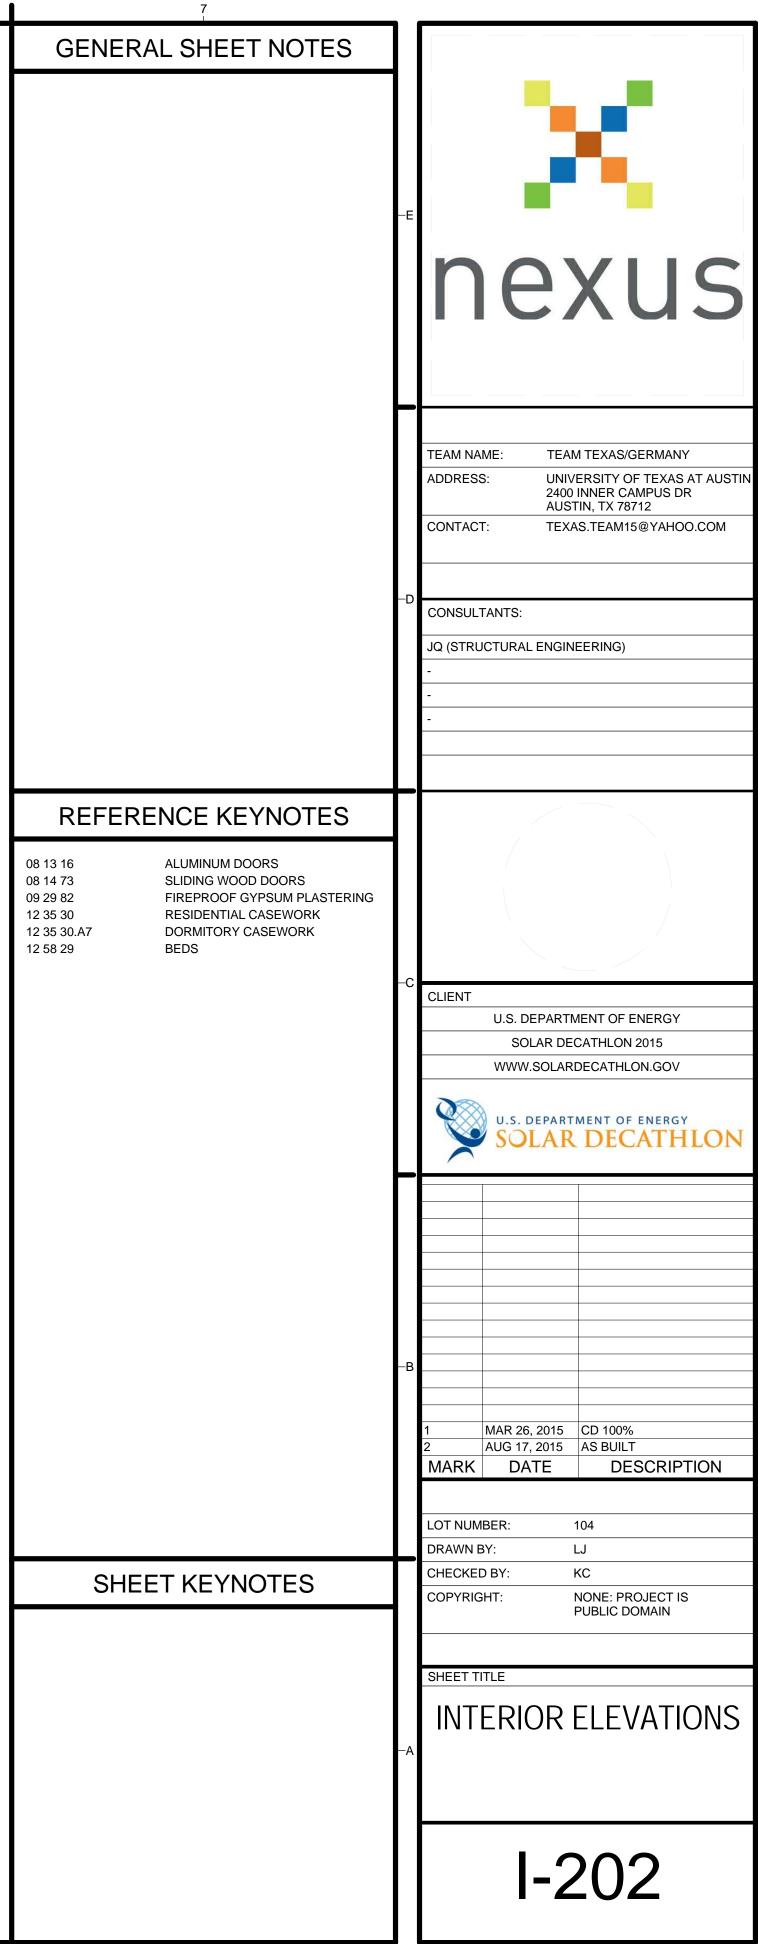


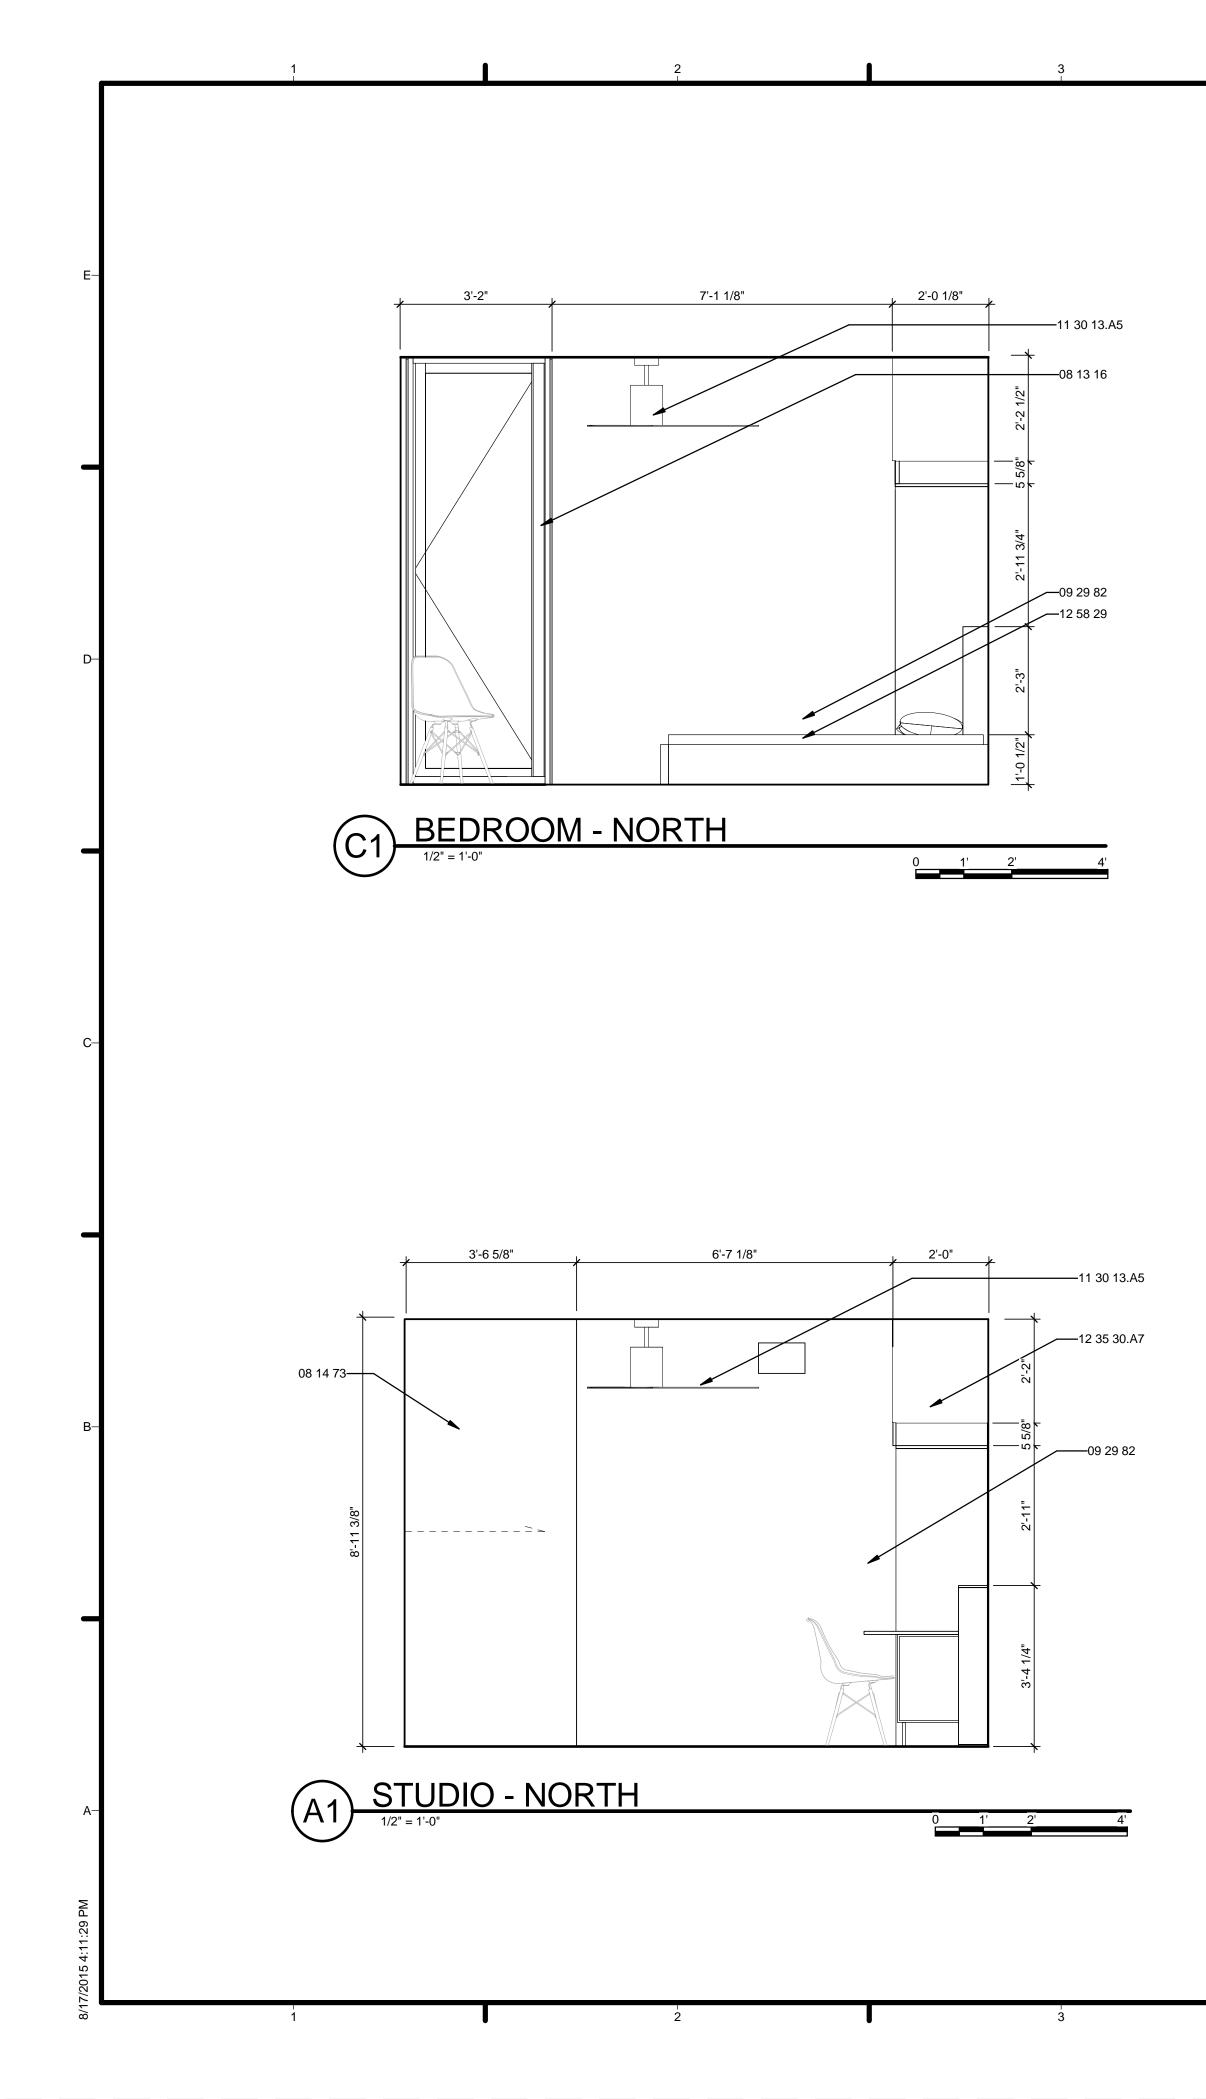


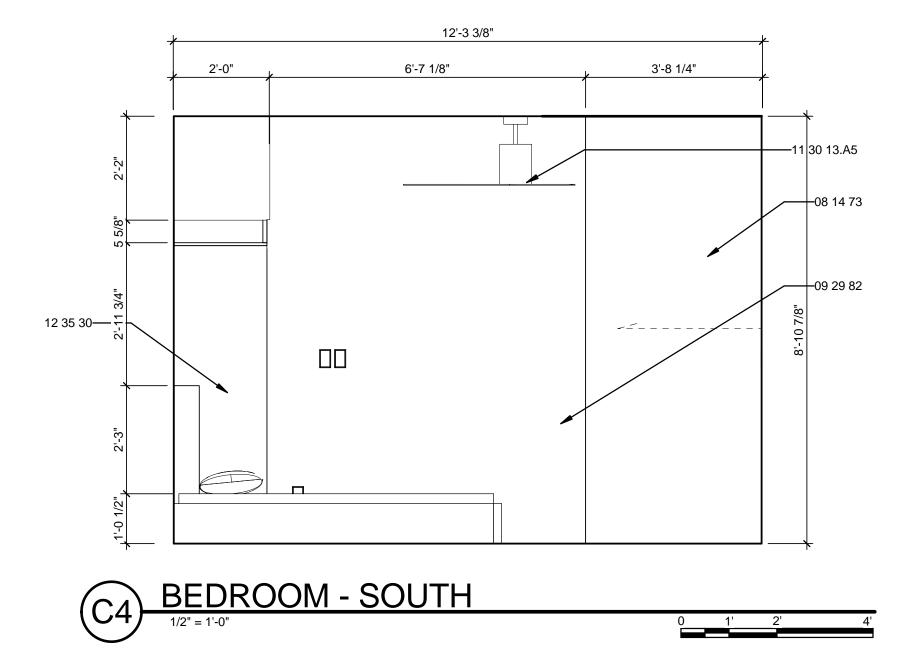


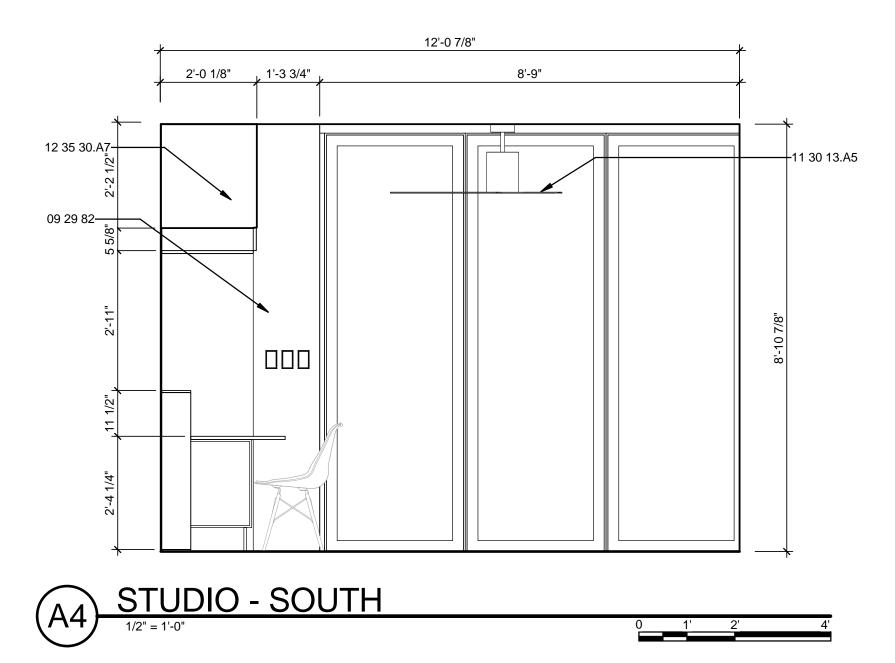





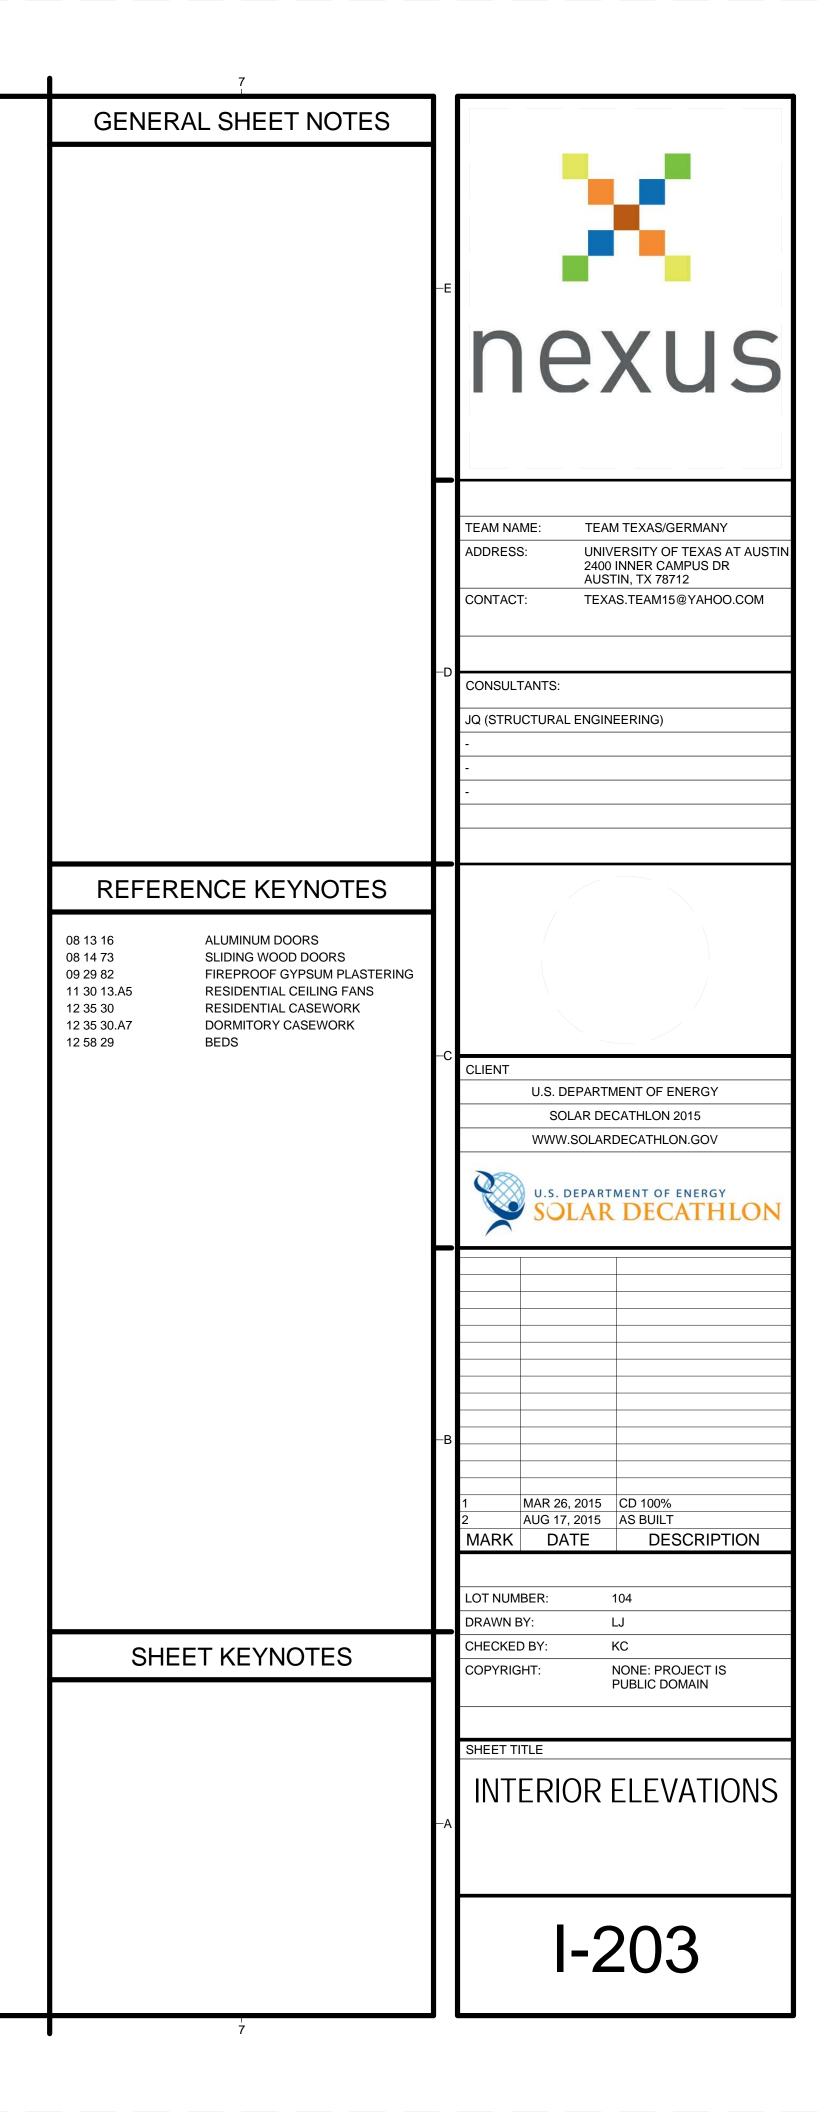


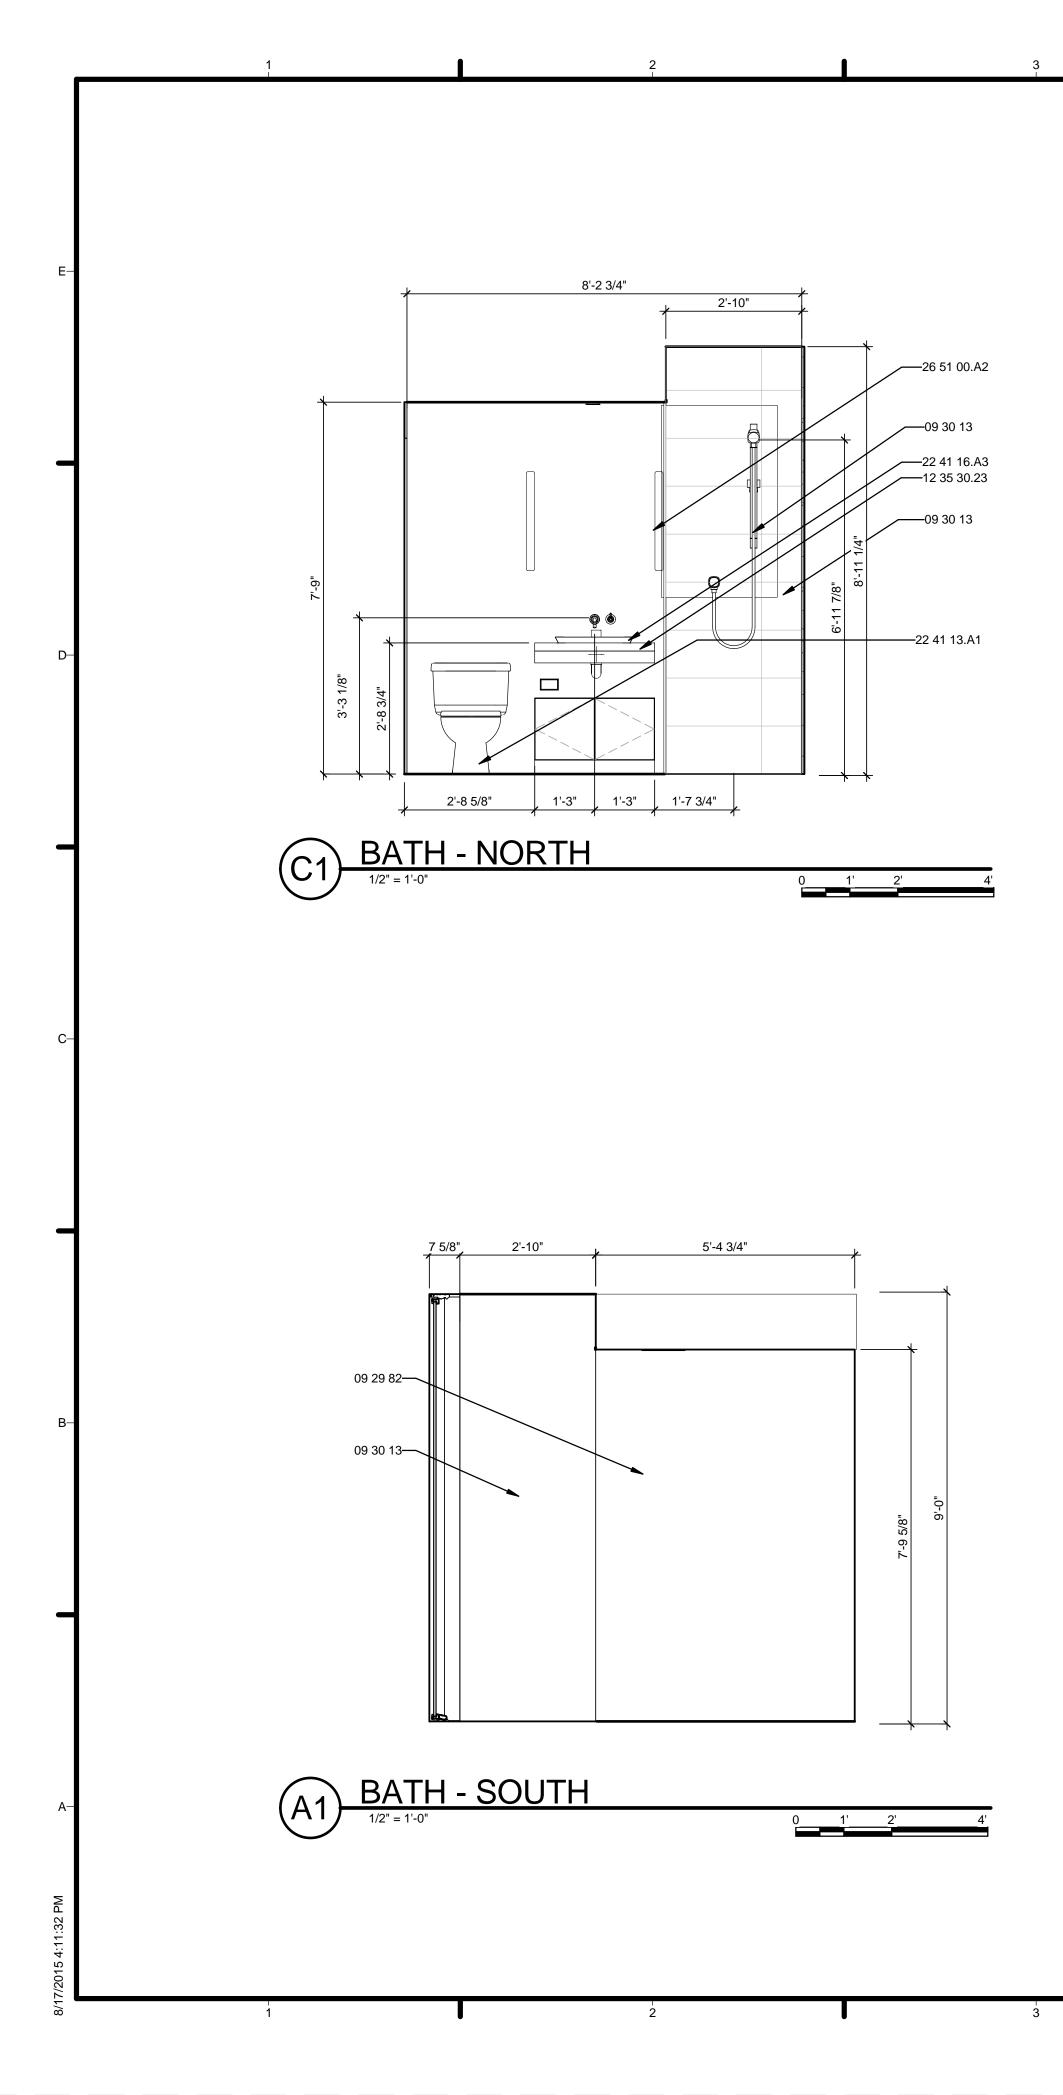


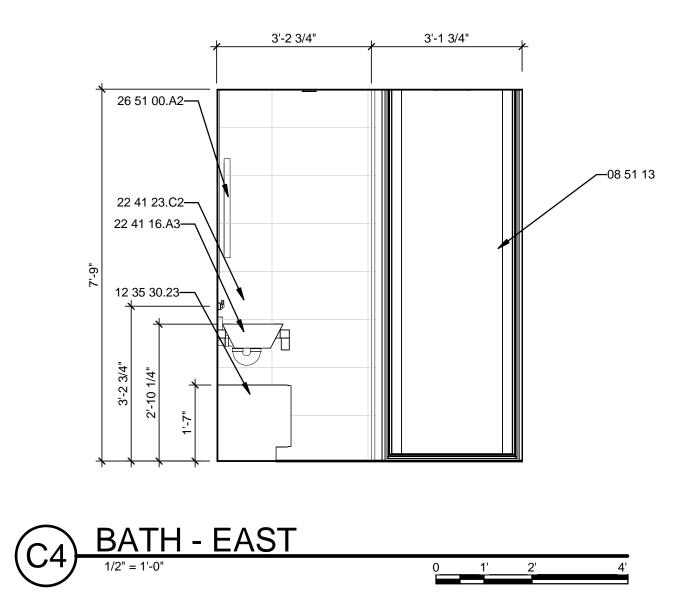

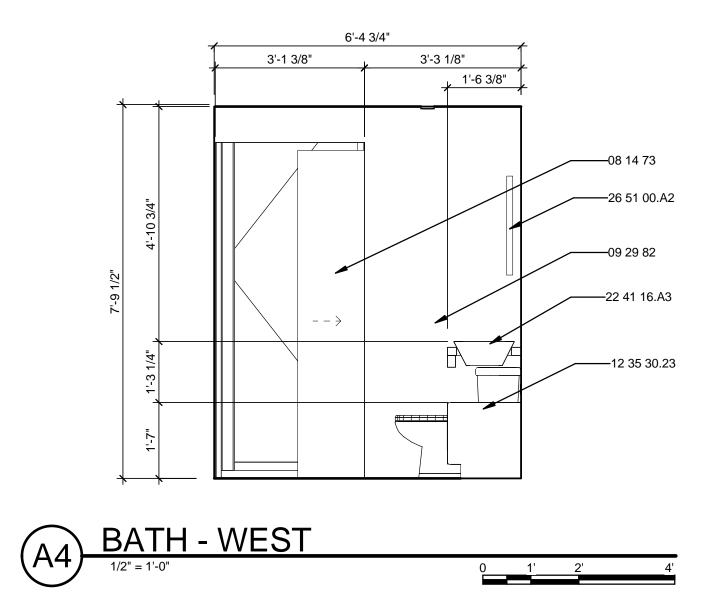


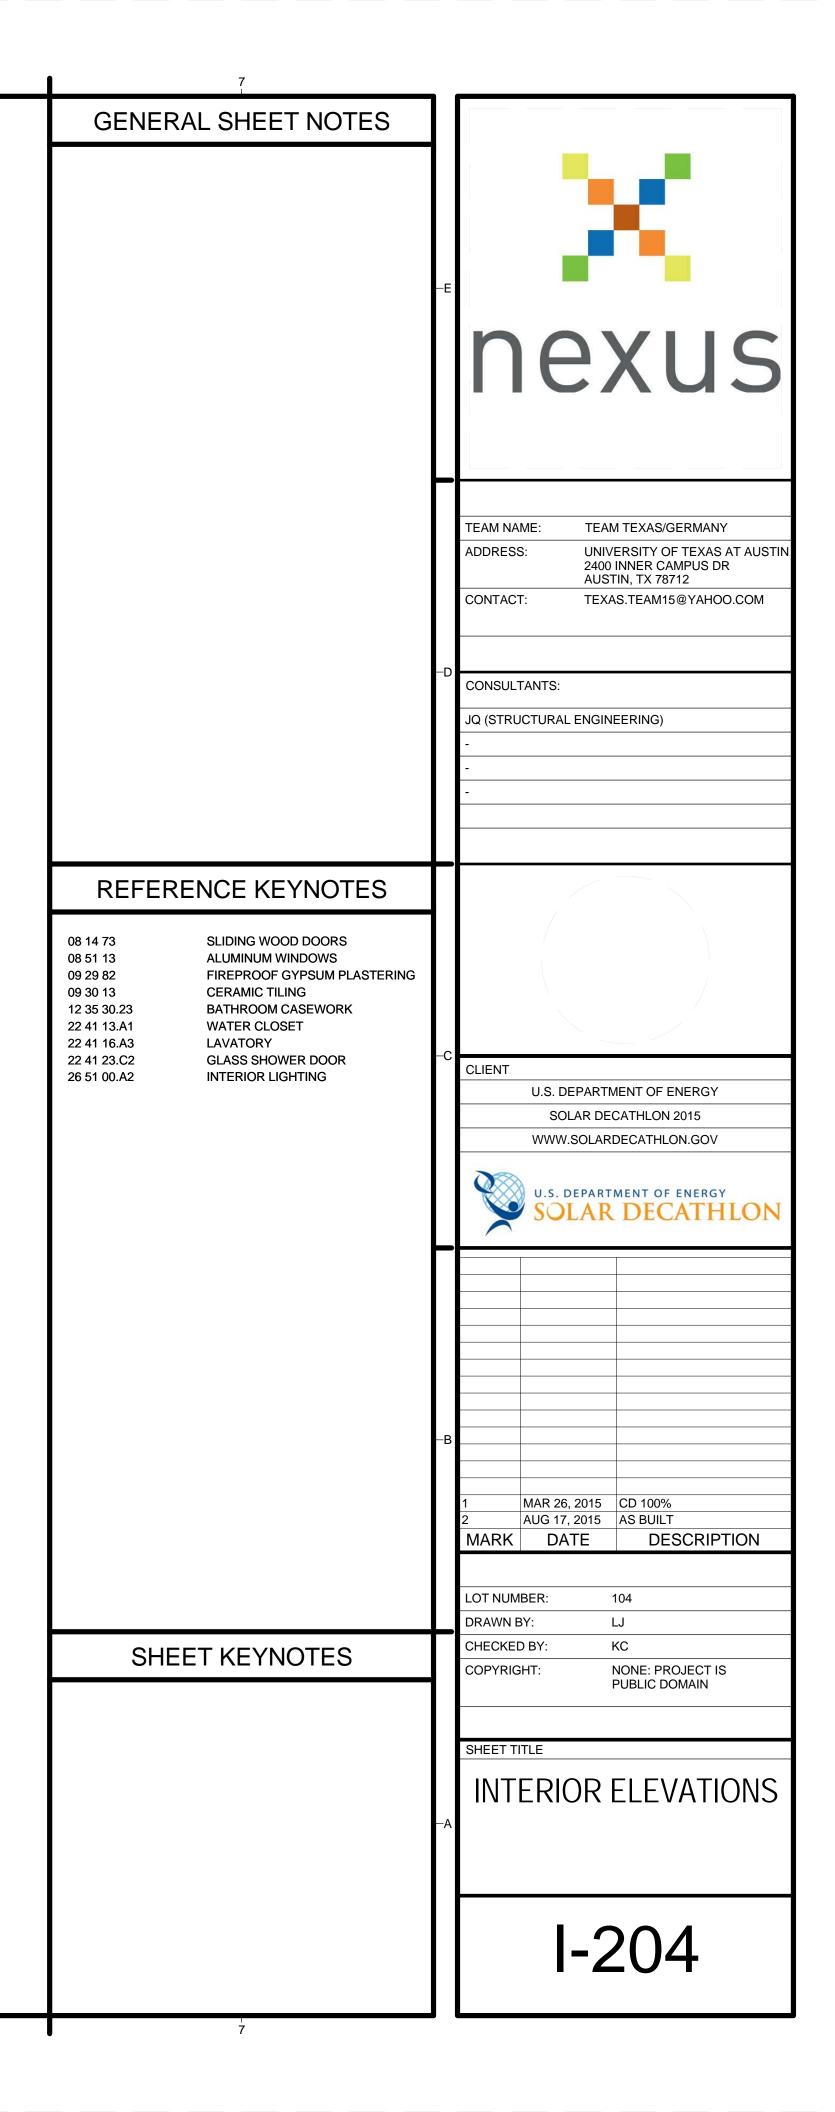

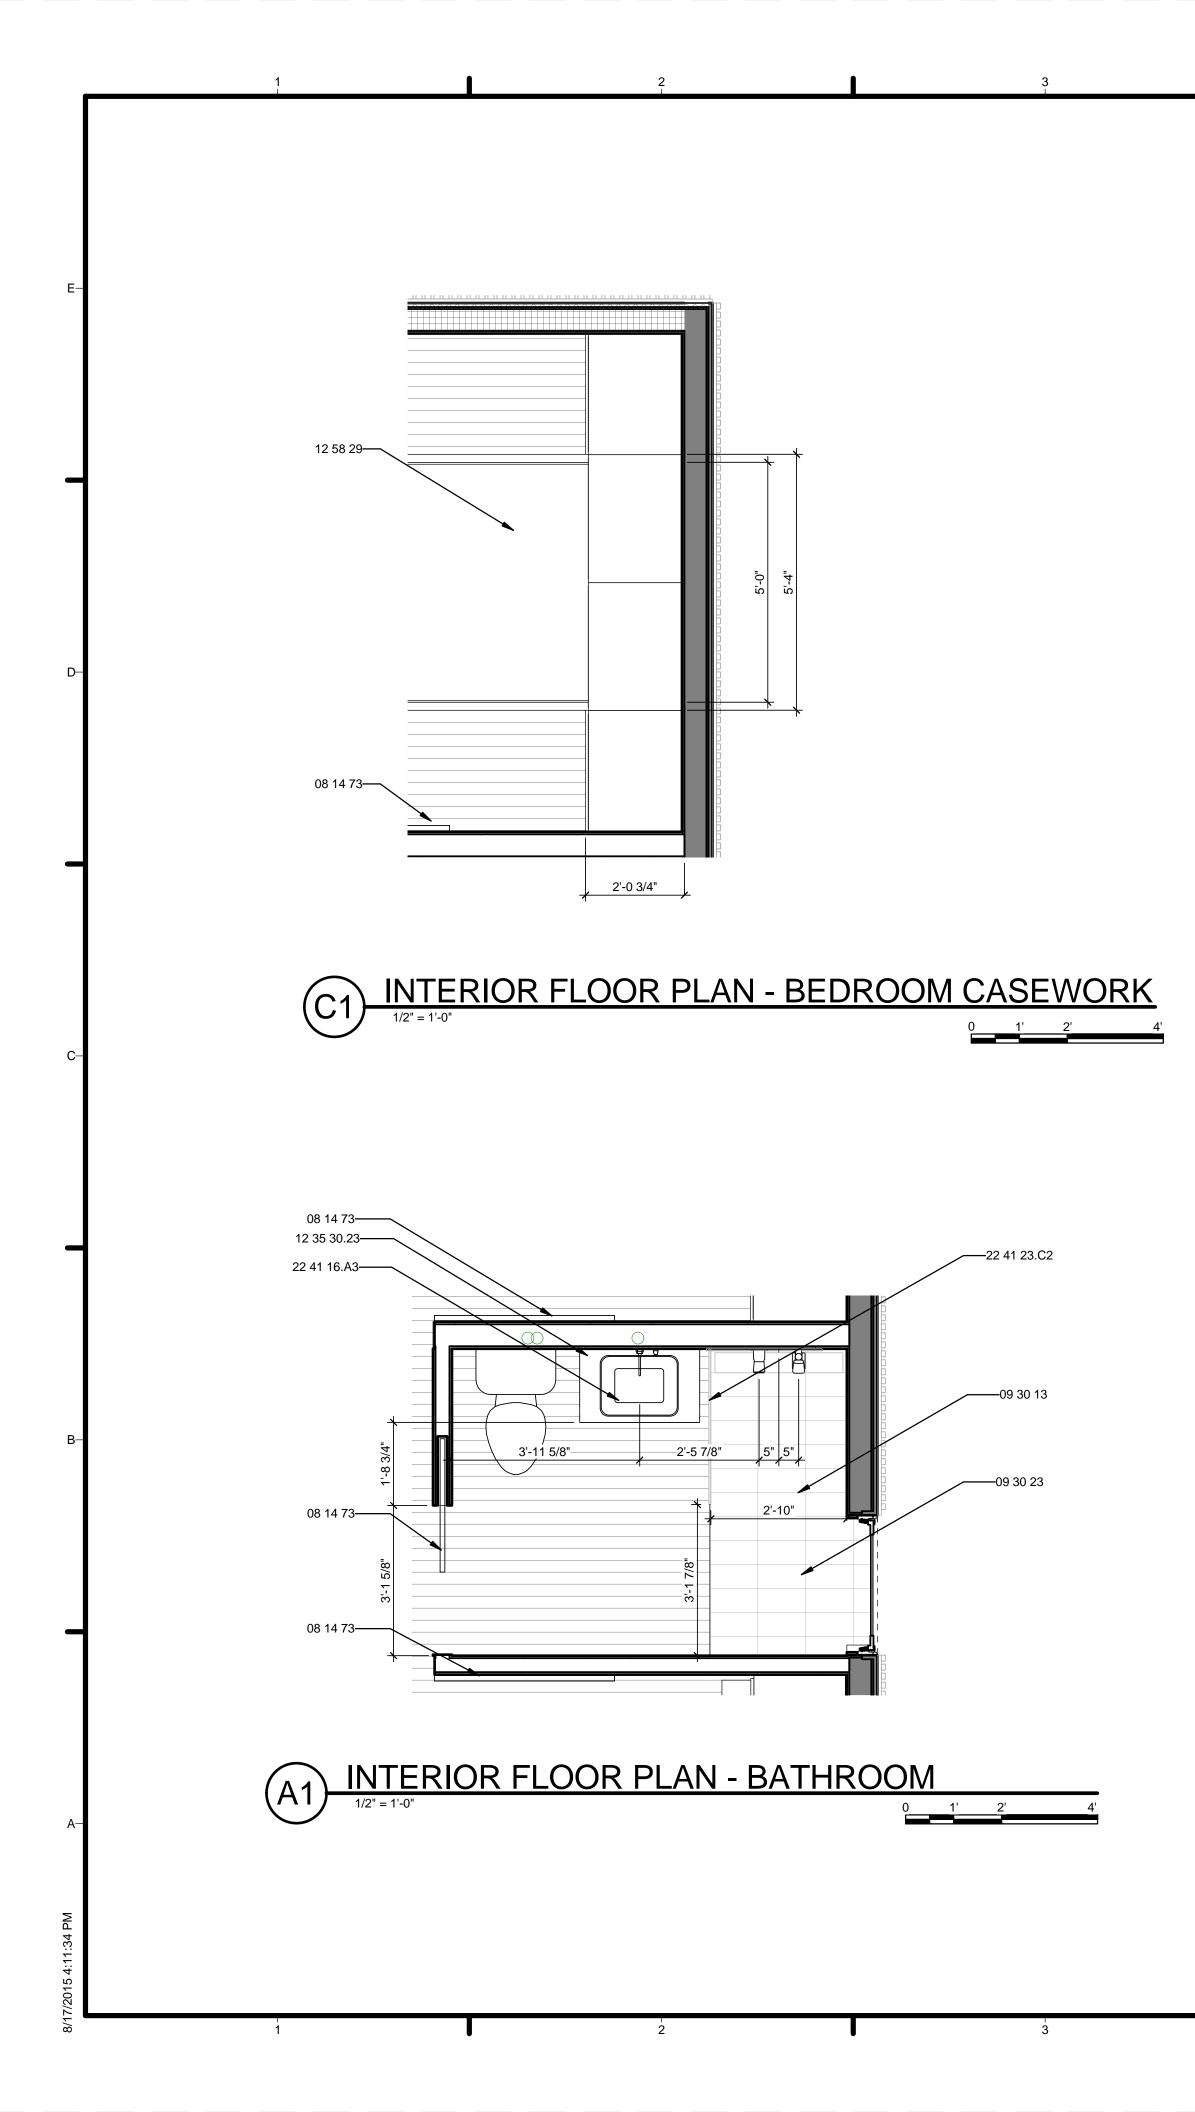

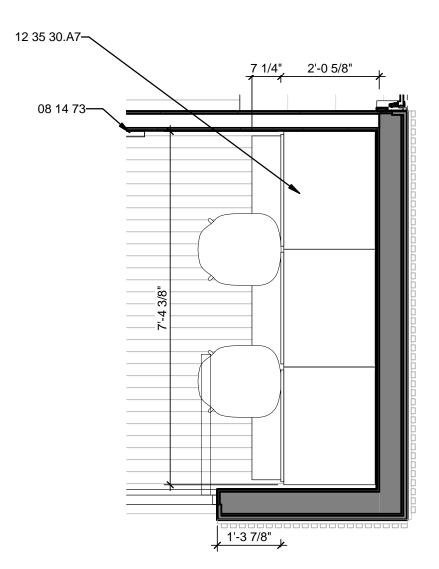



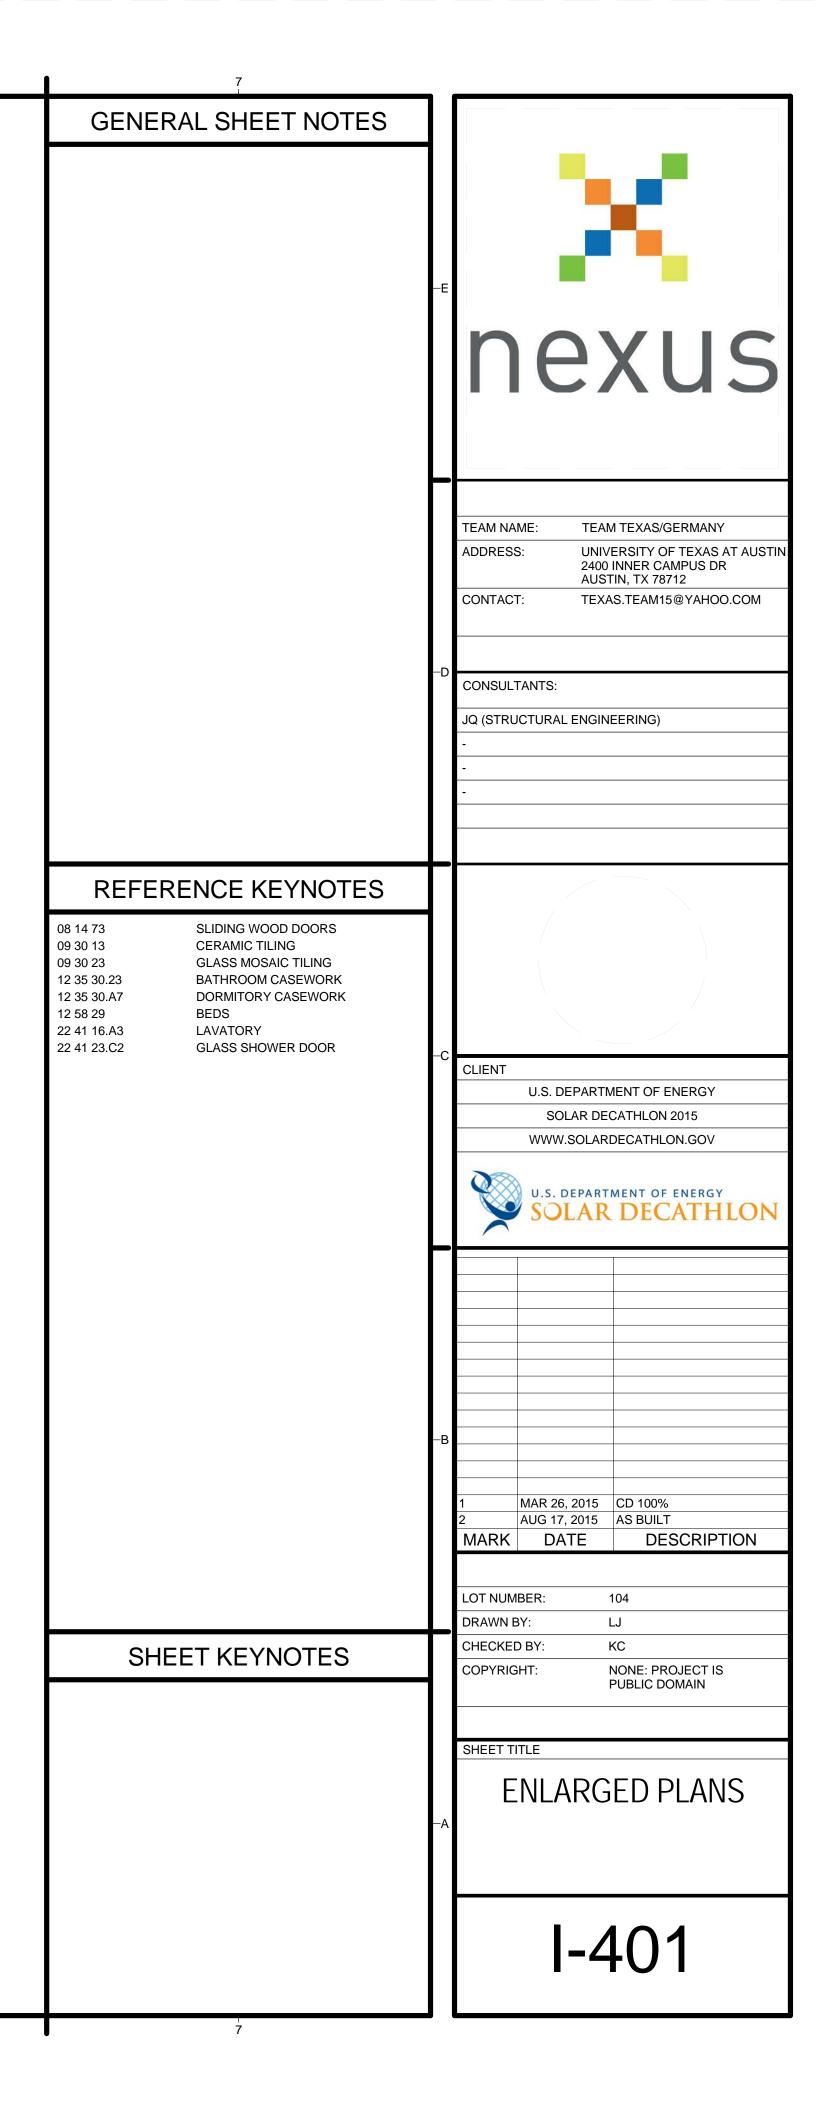


							PLUMBING FIXT	JRE SCHEDULE							
												CONN	ECTION		
	MARK	KEYNOTE	DESCRIPTION	COUNT	MANUFACTURER	MODEL	SUPPLY FITTING	SUPPLY PIPE	DRAIN	TRAP	CW	HW	WASTE	VENT	COMMENTS
43		11 31 23.A1	COMBO WASHER DRYER	1	EQUATOR	EZ4000									
16		22 41 39	KITCHEN FAUCET	1	GROHE	32665DC1									
29		22 41 39	BATHROOM FAUCET	1	GROHE	19291001									
20		09 30 13	HANDSHOWER SET	1	GROHE	26125000									
8		22 41 39	SHOWER HEAD	1	GROHE	28373000									
47		22 41 13.13	DUAL-FLUSH PERSUADE CURV	1	KOHLER	K-3723									
14		22 41 16.A5	KITCHEN SINK	1	KOHLER	K-5540-NA									
42		22 41 16.A3	BATHROOM SINK	1	KRAUS	KCV-122-CH									


	MECHANICAL EQUIPMENT SCHEDULE								
KEYNOTE	DESCRIPTION	COUNT	MANUFACTURER	MODEL	COMMENTS				
11 30 13.A4	DISHWASHER	1	BLOMBERG	DW55100SS					
11 31 13.A5	OVEN	1	BLOMBERG	BWOS24100	BUILT-IN				
11 30 13.A1	REFRIGERATOR	1	BLOMBERG	BRFB1050FFBIN	BUILT-IN				
11 30 13.13	COOKTOP	1	SUMMIT	SINC424220	INDUCTION				

	FURNITURE SCHEDULE							
Keynote	Description	COUNT	MANUFACTURER	MODEL	COMMENTS			
		11						
12 58 19	Side Chair Upholstered Molded Plastic 4-Leg Base	4	Herman Miller, Inc.	DSX.U				
12 58 19	TABLE	1	CUSTOM	N/A				
12 58 19	TABLE	2	CUSTOM	N/A				
12 58 29	QUEEN BED FRAME	1	CUSTOM	N/A				
12 58 29	QUEEN BED MATTRESS	1		N/A				

				ROOM FINISH SCHEDULE			
ROOM NAME	FLOOR	WALL	CEILING	CEILING HEIGHT	COUNTERTOP	CASEWORK	COMMENTS
STUDIO	FL01	PT01	PT02	8'-10 7/8"	N/A	WVNR01	
THRSHD.	FL01	PT01	PT02	8'-10 7/8"	N/A	N/A	
MASTER BEDROOM	FL01	PT01	PT02	8'-10 7/8"	N/A	WVNR01	
BATHROOM	FL01/FL02	PT01/TL01	PT02	7'-9"	SS01	WVNR01	FL02 AND TL01 IN SHOWER ONLY. CEILING HEIGHT IN SHOWER IS 8'-10 7/8".
KITCHEN/DINING	FL01	PT01	PT02	8'-10 7/8"	SS01	WVNR01	
LIVING	FL01	PT01	PT02	8'-10 7/8"	N/A	WVNR01	


				FINIS	H SCHEDULE			
FINISH CODE	PRODUCT	PRODUCT NUMBER	MANUFACTURER	COLOR	SURFACE FINISH	SIZE	DEPTH	NOTES
FL01	RECYCLED PINE		AUSTIN FINE LUMBERS		MATTE	VARIED	5/8"	
FL02	CERAMIC TILE FLOOR	PT2247 TERRA MAESTRICHT	MOSA	216V	HONED	VARIED	1/2"	
TL01	CERAMIC TILE	PT2247 TERRA MAESTRICHT	MOSA	216V	HONED	VARIED	1/2"	
SS01	CORIAN SOLID SURFACES		DUPONT	STARDUST			3/4"	
WVNR01					LACQUERED		1/16"	
PT01	PAINT	OC-117	BENJAMIN MOORE	SIMPLY WHITE	EGGSHELL			PT02 IS THE SAME AS PT01, BUT IN MATTE FINISH.

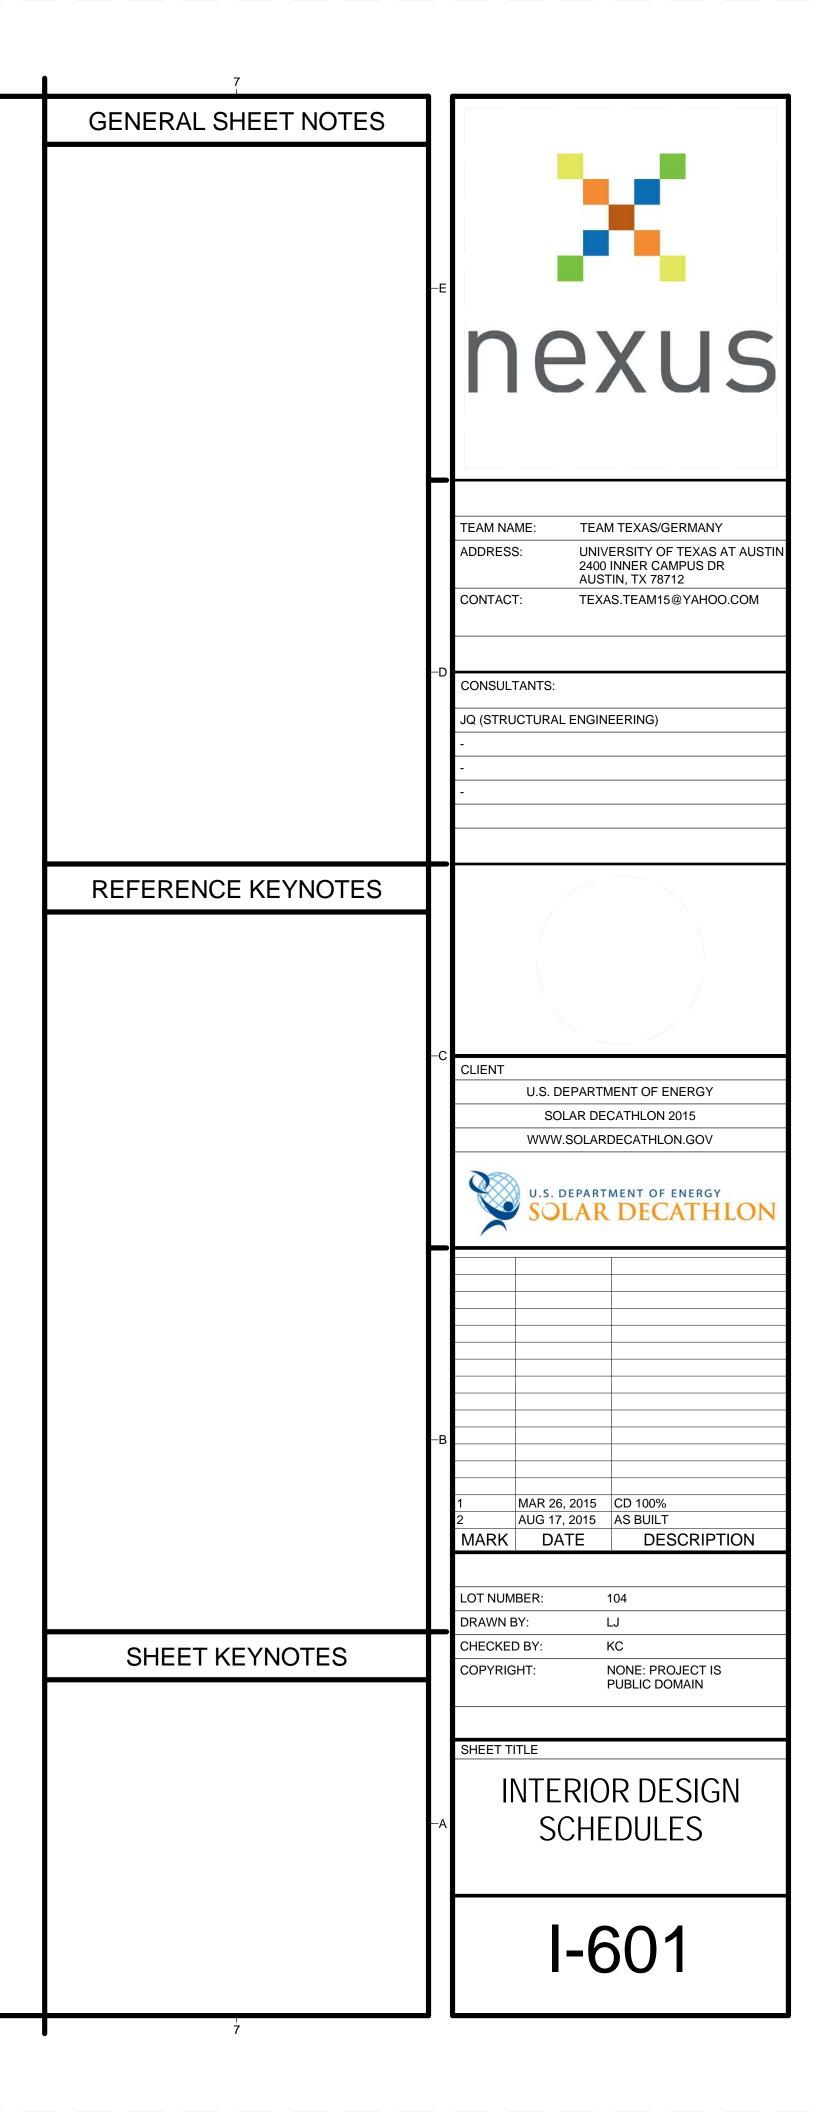

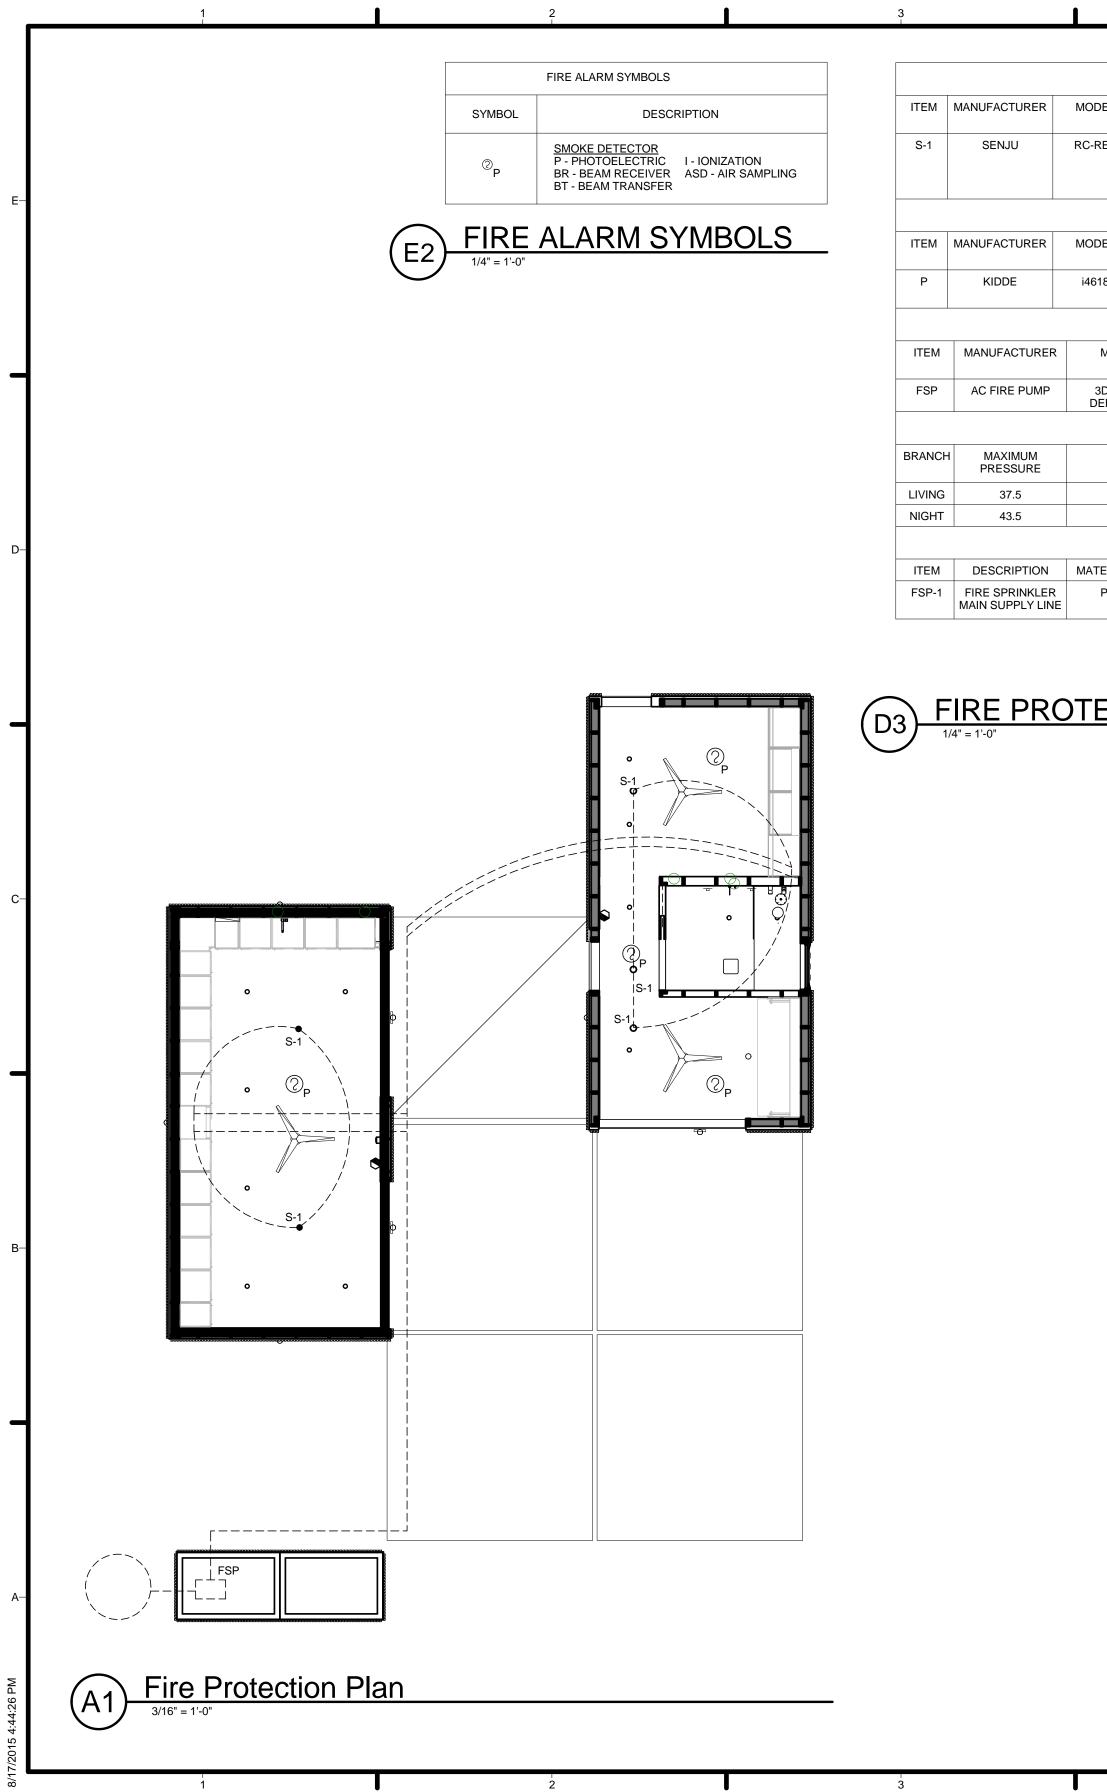

	4			I			5		I	6	5	1
												GENERAL
				S	PRINKLER	S						
NODEL	TY	PE		DIAM DIMENS		COVER AREA (FT			REQUIRED PRESSURE (PSI)	K FACTOR (GPM/PSI)	TEMPERATURE RAITING F(C)	SPRINKLER HEADS MUST CEILING OBSTRUCTIONS CENTER)
C-RES	FLAT PLATE CON	CEALED PENDAN	г	3 5	/16	16 X ²	16 13		7	4.9	160 (71)	ALL OUTDOOR PIPING MU
											FIRE SUPPRESSION SUP DECKING (HUNG FROM B	
·			·	SMO	KE DETEC	TORS						COMMON TRAY WITH THI HYDRONIC PIPING) THEN MECHANICAL CHUTES.
NODEL	SENSO	R TYPE		DIAM DIMENS		PRI	MARY POWER		BACKUP POWER		NOTES	MECHANICAL CHUTES.
i4618	IONST	ATION	3 5/16			1	120V / 60Hz	3xAA BATTERY				
			FIRE S	UPPRESSI	ON WATE	R SUPPLY PL	JMP	1				
MODEL	PUMP HP	IMPELLER DIAMETER (IN)		ATED RATED V (GPM) PRESSURE (PSI)		NOTES						
3D HOME DEFENDER	5	5 1/16		30		37	PUMP PACKAGE CONTAINS CHECK VALVE, PRESSURE SWITC DISCHARGE CHECK VALVE, DOMAIN VALVE, AND EXI					
		FIRE SUPPRESSI	ON WAT	ER SUPPL	Y PUMP M	NIMUM PRES	SSURE CALCULATION					
PIPE SIZE	FLOW RATE (GPM)	SPRINKLER PRESSURE		AL PIPE NGTH		JRE DROP FOOT	FITTINGS PRESSURE DROP		TIC PRESSURE HEAD (PSI)	Ν	OTES	
1"	13	7	:	55	0	.12	100		4.4			
1"	13	7		90	0	.12	105		4.4			
				PI	PE SUPPL	Y						
MATERIAL TYPE	FITTING TYPES	DIAMETER (IN)	INSU	JLATED	R-\	/ALUE			NOTES			
PEX - A	PROPEX AND NPT	1	Υ	/ES		6.8						
	-						1					

FIRE PROTECTION EQUIPMENT SCHEDULE

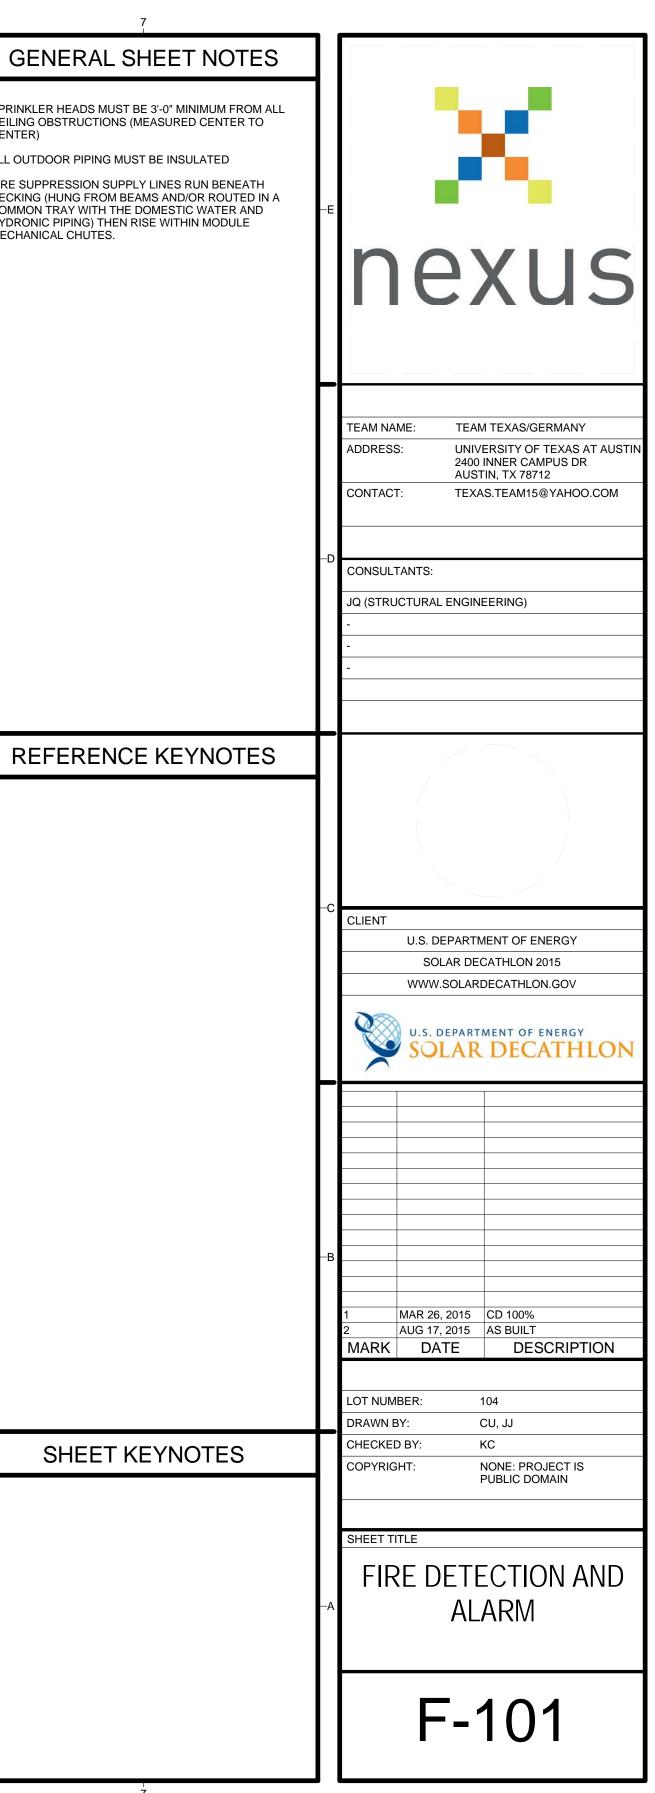

ABE	BREVIATIONS
ITEM MARK	DESCRIPTION
DHW	DOMESTIC HOT WATER
SPL	SUPPLY TANK
GWT	GRAY WATER TANK
BWT	BLACK WATER TANK
RWT	RAINWATER TANK
WBP	WATER BOOSTER PUMP
STP	SOLAR THERMAL TANK
VTR	VENT THROUGH ROOF
CW	CLOTHES WASHER
DW	DISH WASHER
KS	KITCHEN SINK
WC	WATER CLOSET
BS	BATHROOM SINK
S	SHOWER
TST	THERMAL STORAGE TANK
GFS	GREYWATER FILTERATION SYSTEM
RP	RAINWATER PUMP
RWP	RAINWATER PIPING
DWP	DOMESTIC WATER PIPING
GWP	GREYWATER DRAIN PIPING
BWP	BLACKWATER DRAIN PIPING
PTS	POTABLE WATER TREATMENT SYSTEM
RP2	POTABLE WATER SYSTEM
DPT	DOMESTIC PRESSURE TANK
HET	HOT WATER EVAPORATION TANK
AAV-	AIR ADMITTENCE VALVE

	DRAINAGE FIXTURE UNIT TABULATION					
	MIN TRAP SIZE (IN)					
LIVING/KITCHEN MODULE						
CLOTHES WASHER	3		2			
DISHWASHER, DOMESTIC		2	1.5			
KITCHEN SINK		2	1.5			
MODULE SUBTOTAL	3	4				
BEDROOM/BATHROOM MODULE						
LAVATORY	1		1.25			
SHOWER	2		2			
WATER CLOSET (1.2 GPF)		3	3			
MODULE SUBTOTAL	3	3				
HOUSE TOTAL	6	7				

GREY AND BLACK WATER PIPE SIZING (IN DIAMETER)							
LIVING/KITCHEN MODULE	HORIZONTAL DRAIN	VERTICAL DRAIN	VENTILATION PIPE				
GREYWATER PIPING	2	2	2				
BLACKWATER PIPING	2	2	2				
BEDROOM/BATHROOM MODULE							
GREYWATER PIPING	2	2	2				
BLACKWATER PIPING	2	2	2				

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١	WATER SUPPLY FIXTURE UNIT (WSFU) TABULATION						
LIVING/KITCHEN MODULE	COLD WATER HOT WATER		MINIMUM DIAMETER (IN)				
CLOTHES WASHER	4	4	1/2				
DISHWASHER, DOMESTIC	1.5	0	1/2				
KITCHEN SINK	1.5	1.5	1/2				
MODULE SUBTOTAL	7	5.5					
BEDROOM/BATHROOM MODULE							
LAVATORY	1	1	1/2				
SHOWER	2	2	1/2				
WATER CLOSET (1.2 GPF)	2.5	0	1/2				
MODULE SUBTOTAL	5.5	3					
OUTDOOR WATER FIXTURES							
HOSE BIB	2.5	0	1/2				
1 ADDITIONAL HOSE BIB (TES)	1	0	1/2				
TOTAL	16	8.5					

	PIPE SIZING BASED ON WSFU (IN DIAMETER)						
	COLD WATER	HOT WATER	NOMINAL LENGTH (FT)	NOTES			
WATER SYSTEM EQUIPMENT SKID							
UNTREATED RAINWATER SUPPLY	1"		60	INSULATED			
TREATMENT TO HOT WATER SUPPLY TEE	1"		5	INSULATED			
HOT WATER SUPPLY TEE TO WATER SKID MANIFOLD	3/4"	3/4"	10	INSULATED			
HOS BIB AND TES REFILL	1/2"		15	INSULATED			
LIVING/KITCHEN MODULE							
MULTI TEE SUPPLY DIAMETER	3/'4"	3/4"	20	INSULATED			
CLOTHES WASHER	1/2"	1/2"	5				
DISHWASHER, DOMESTIC	1/2"		10				
KITCHEN SINK	1/2"	1/2"	15				
BEDROOM/BATHROOM MODULE							
MULTI TEE SUPPLY DIAMETER	3/4"	3/4"	15	INSULATED			
LAVATORY	1/2"	1/2"	10				
SHOWER	1/2"	1/2"	15				
WATER CLOSET (1.2 GPF)	1/2"		10				

-H	nexus
-D	TEAM NAME: TEAM TEXAS/GERMANY ADDRESS: UNIVERSITY OF TEXAS AT AUSTIN 2400 INNER CAMPUS DR AUSTIN, TX 78712 CONTACT: TEXAS.TEAM15@YAHOO.COM CONSULTANTS: JQ (STRUCTURAL ENGINEERING) - - - - - - - - - - - -
-c	CLIENT U.S. DEPARTMENT OF ENERGY SOLAR DECATHLON 2015 WWW.SOLARDECATHLON.GOV
-в	Image: Second state sta
-A	DRAWN BY: KC CHECKED BY: CU COPYRIGHT: NONE: PROJECT IS PUBLIC DOMAIN SHEET TITLE SUPPLY + DRAINAGE SIZING CALCULATIONS AND ABBREVIATIONS AND ABBREVIATIONS P-001

ITEM MARK	MANUFACTURER	SERVICE	QUANTITY	CAPACITY	DIMENSIONS	PLUMBING CONNECTION	FILL/EMPTY OPENING	NOTES
BWT	QUADEL	BLACKWATER HOLDING TANK	1	250	84"X40"X16"	3" THREADED CAP	4" TOP CAP	
RWT	HUSKY	RAINWATER COLLECTION TANKS	1	2000	125"X144"X24"	2" BALL VALVE	4" TOP CAP	
TST	CORGAL	THERMAL STORAGE/BACK-UP WATER/FIRE WATER	1	1000	48" DIA., 131" TALL	2" BALL VALVE	48" TOP LID	TST HAS 48" TOP LID FOR WATER DELIVERY AND PUMP OUT

	POTABLE WATER TREATMENT SYSTEM FOR RAINWATER SCHEDULE									
ITEM MARK	SYSTEM USE	MANUFACTURER	MODEL	QUANTITY	TREATMENT TYPE	RATED OUTPUT FLOW (GPM)	POWER DEMAND (W)	ELECTRICITY SUPPLY (VOLTAGE/PHASE/HZ)	INLET PIPE SIZE	OUTLET PIPE SIZE
	POTABLE WATER TREATMENT SYSTEM	UV MAX	IHS22-E4	1	5 MICRON CARTRAGE, 5 MICRON CARBON, UV TREATMENT	16	84	120/1/60	1" NPT	1" NPT


	GREYWATER FILTRATION SYSTEM SCHEDULE											
ITEM	SYSTEM USE	MANUFACTURER	MODEL	QUANTITY	TREATMENT TYPE	RATED OUTPUT FLOW (GPM)	MAX PRESSURE (PSI)	STORAGE CAPACITY (GALLONS)	ELECTRICITY SUPPLY (VOLTAGE/PHASE/Hz	INLET PIPE SIZE	OUTLET PIPE SIZE	NOTES
GFS	GREYWATER FILTRATION SYSTEM	MATALA	AQUA2USE GWDD	1	4-STAGE MEDIA FILTER	14	10	21	115/1/60	2"		SUMP PUMP HAS BOTH FLOAT SWITCH AND 24 HOUR TIMER CONTROL BUILT-IN GREYWATER TO BLACKWATER DIVERSION VALVE

	PLUMBING FIXTURE SCHEDULE									
ITEM	DESCRIPTION	MANUFACTURER	MODEL NAME	MODEL #	MAX FLOW RATE	NOTES				
BS	LAVATORY FAUCET	GROHE	ATRIO	19291	2					
KS	KITCHEN FAUCET	GROHE	CONCETTO	32665	1.75					
S	SHOWER	GROHE	RAINSHOWER RUSTIC 130	27140	2.5					
WC	WATER CLOSET	KOHLER	ADAIR	K-6925	1.28 GPF					

WATER-USING APPLIANCES SCHEDULE									
ITEM	DESCRIPTION	MANUFACTURER	MODEL NAME	GALLONS/ CYCLE	ELEC. SUPPLY (VOLT/PHASE/Hz)	INLET SUPPLY SIZE	DRAIN SIZE	MIN/MAX WATER PRESSURE	ENERGY STAR ANNUAL ENERGY USE (KWH/YR)
CW	CLOTHES WASHER	EQUATOR	EZ 4000 CV	9.6	120/1/60	3/4" THREADED HOSE	1" HOSE	7.25-145	
DW	DISHWASHER	BLOMBERG	DW 55100	3.8	120/1/60	3/8" HOSE	1" HOSE	4.5/145	273

	RAINWATER SUPPLY PUMP SCHEDULE										
ITEM	DESCRIPTION	MANUFACTURER	MODEL	QUANTITY	MAXIMUM LIFT (FT)	DESIGN PRESSURE RANGE (PSI)	DESIGN FLOW RATE (GPM)	ELECTRICITY SUPPLY (VOLTS/PHASE/HZ)	INLET SIZE	OUTLET SIZE	
RP	RAINWATER/DOMESTIC SUPPLY PUMP	GRONDFOS	MQ 3-45	1	25	60	12	240/1/60	1" NPT	1" NPT	

NON-PRESSURIZED WATER TANKS SCHEDULE

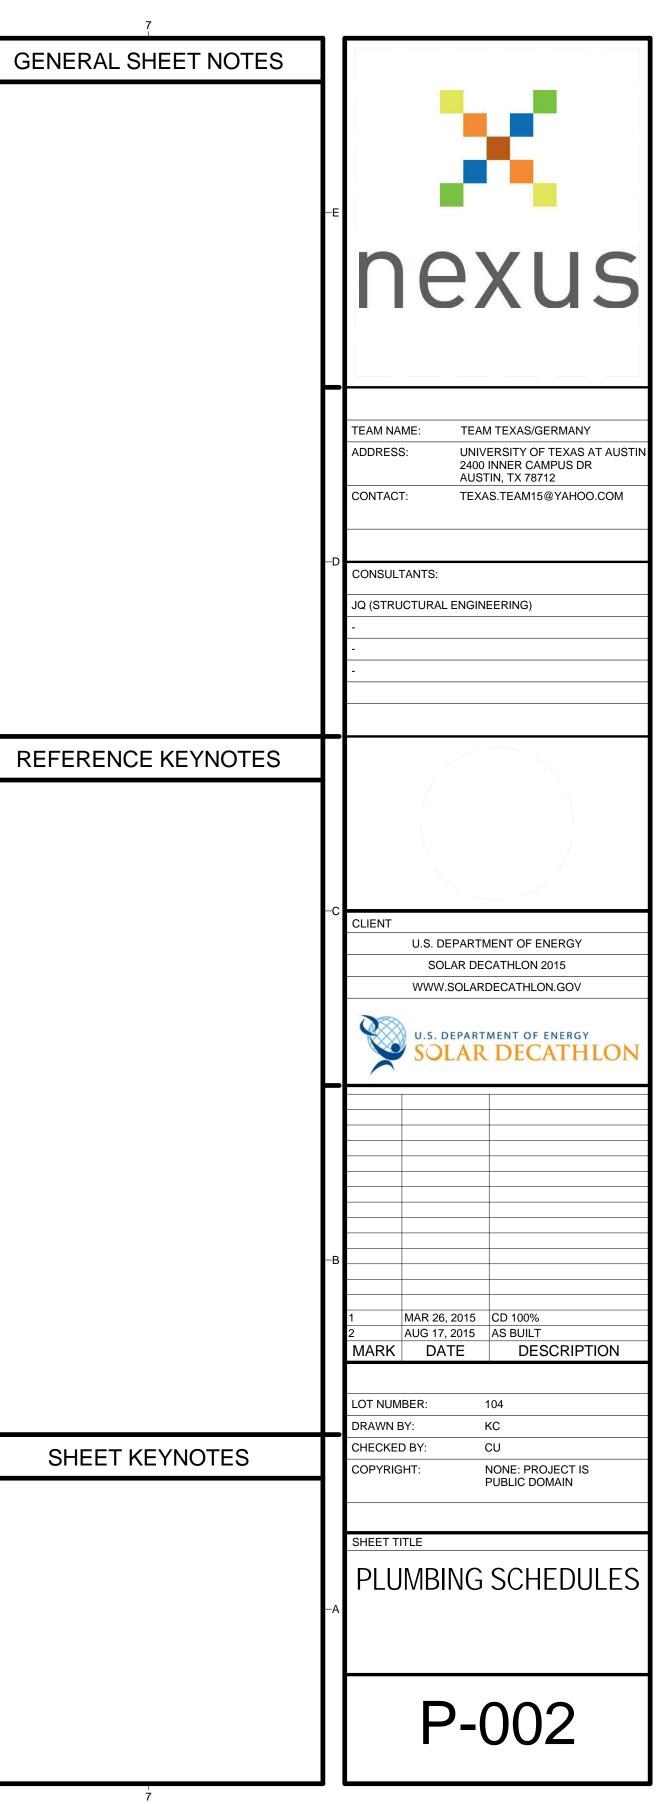



			PIPING	SCHEDULE			
ITEM	SERVICE	SIZE (DIAMETER)	MATERIAL TYPE	FITTING TYPE	JOINT TYPE	PIPE INSULATION TYPE	PIPE INSULATION R VALUE
DWP	PRESSURIZED DOMESTIC WATER PIPING	1/2 IN	PEX-A	PROPEX	PEX-A CONNECTIONS	SELF-SEAL POLYETHYLENE FOAM	7.9
DWP	PRESSURIZED DOMESTIC WATER PIPING	3/4 IN	PEX-A	PROPEX	PEX-A CONNECTIONS	SELF-SEAL POLYETHYLENE FOAM	7.2
DWP	PRESSURIZED DOMESTIC WATER PIPING	1 IN	PEX-A	PROPEX	PEX-A CONNECTIONS	SELF-SEAL POLYETHYLENE FOAM	6.8
GWP	GREYWATER DRAIN PIPING	2 IN	PVC	DWV 35 PVC	SOLVENT WELDED	NONE	
BWP	BLACKWATER DRAIN PIPING	3 IN	PVC	DWV 35 PVC	SOLVENT WELDED	NONE	
RWP	RAINWATER INLET PIPING	3 IN	PVC	DWV 35 PVC	SOLVENT WELDED	NONE	


	BACKFLOW PREVENTION SCHEDULE										
ITEM	SYSTEM	DESCRIPTION	MANUFACTURER	MODEL	PIPE SIZE	CONNECTION TYPE					
RP2	POTABLE WATER SYSTEM	RPZ BACKFLOW PREVENTER	WATTS	LF009M2 QTS	1"	NPT					


	PRESSURE/EXPANSION TANK SCHEDULE									
ITEM	DESCRIPTION	MANUFACTURER	MODEL	TANK SIZE (TOTAL GAL)	TANK OPERATING RANGE	RATED DRAWDOWN (GAL)	DIMENSIONS	CONNECTION SIZE/TYPE		
DPT	PRESSURE TANK	GOULDS	V260	84.9	40/60 PSIG	22.8	22"D, 60.75 H	1 1/4" NPT		
HET	THERMAL EXPANSION TANK	GOULDS	V6P	1.9	40/140 F THERMAL RANGE	.5	8.25"D, 10.25"H	3/4" NPT		

	AIR ADMITTENCE VALVE SCHEDULE										
ITEM	SYSTEM	DESCRIPTION	MANUFACTURER	MODEL NAME	MODEL NUMBER	PIPE CONNECTION SIZE	VENTED FIXTURE				
AAV-1	BLACKWATER	AIR ADMITTENCE VALVE	ΟΑΤΕΥ	SURE-VENT	39016	2"	KITCHEN SINK AND DISHWASHER				
AAV-2	GREYWATER	AIR ADMITTENCE VALVE	ΟΑΤΕΥ	SURE-VENT	39016	2"	LAUNDRY				
AAV-3	GREY AND BLACKWATER	AIR ADMITTENCE VALVE	ΟΑΤΕΥ	SURE-VENT	39016	2"	TOILET, LAVATORY, SHOWER				

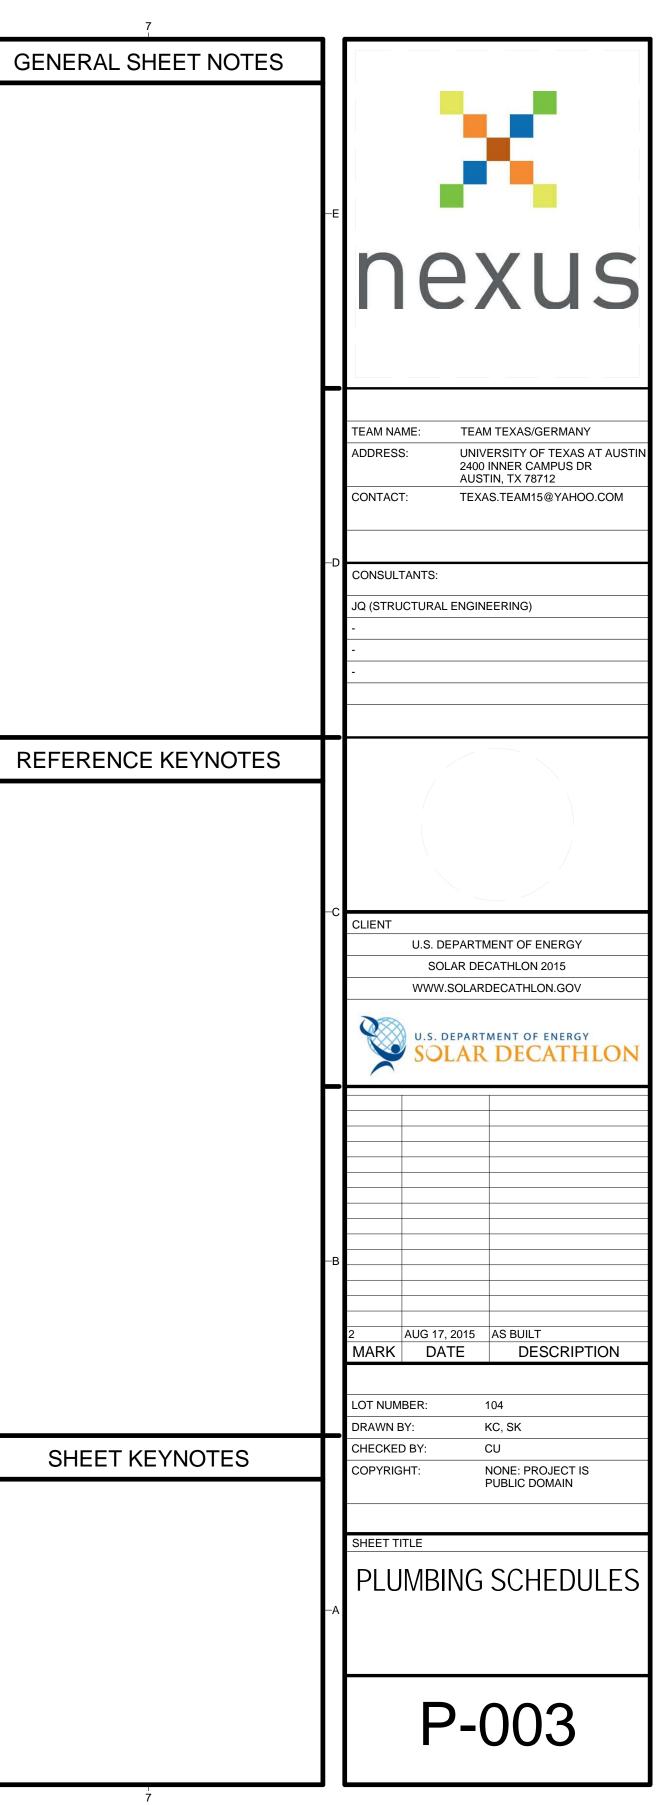


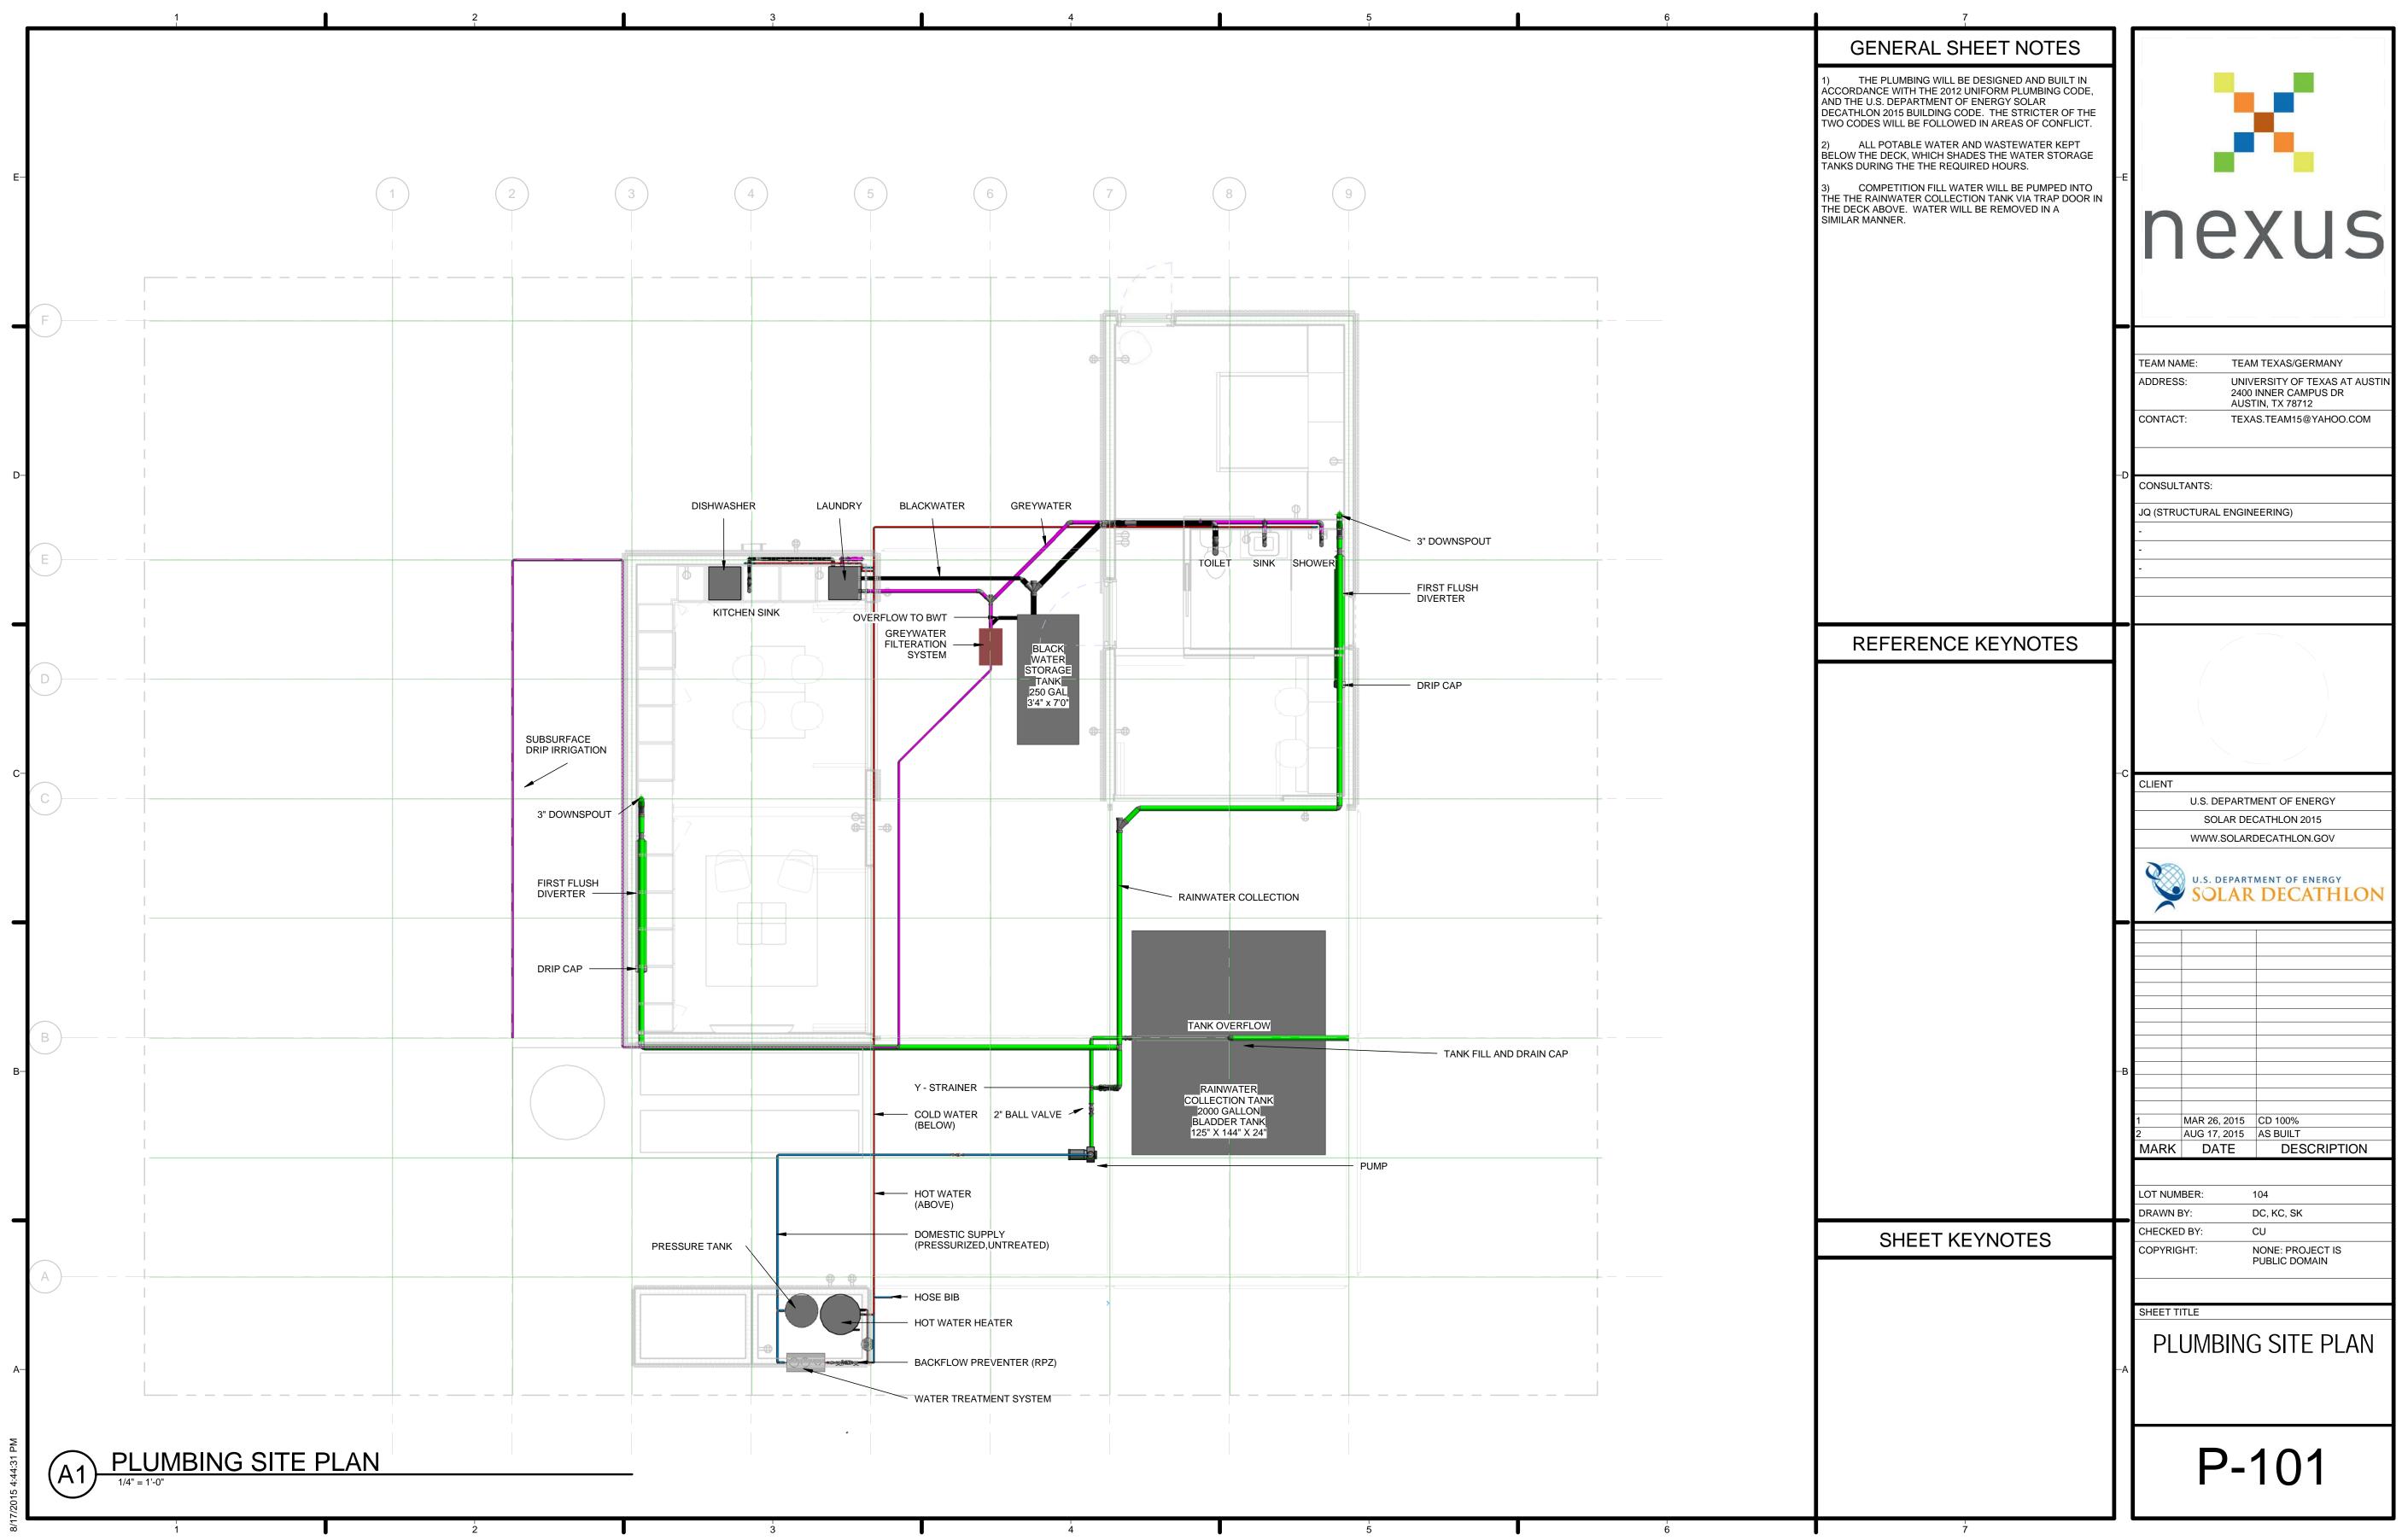


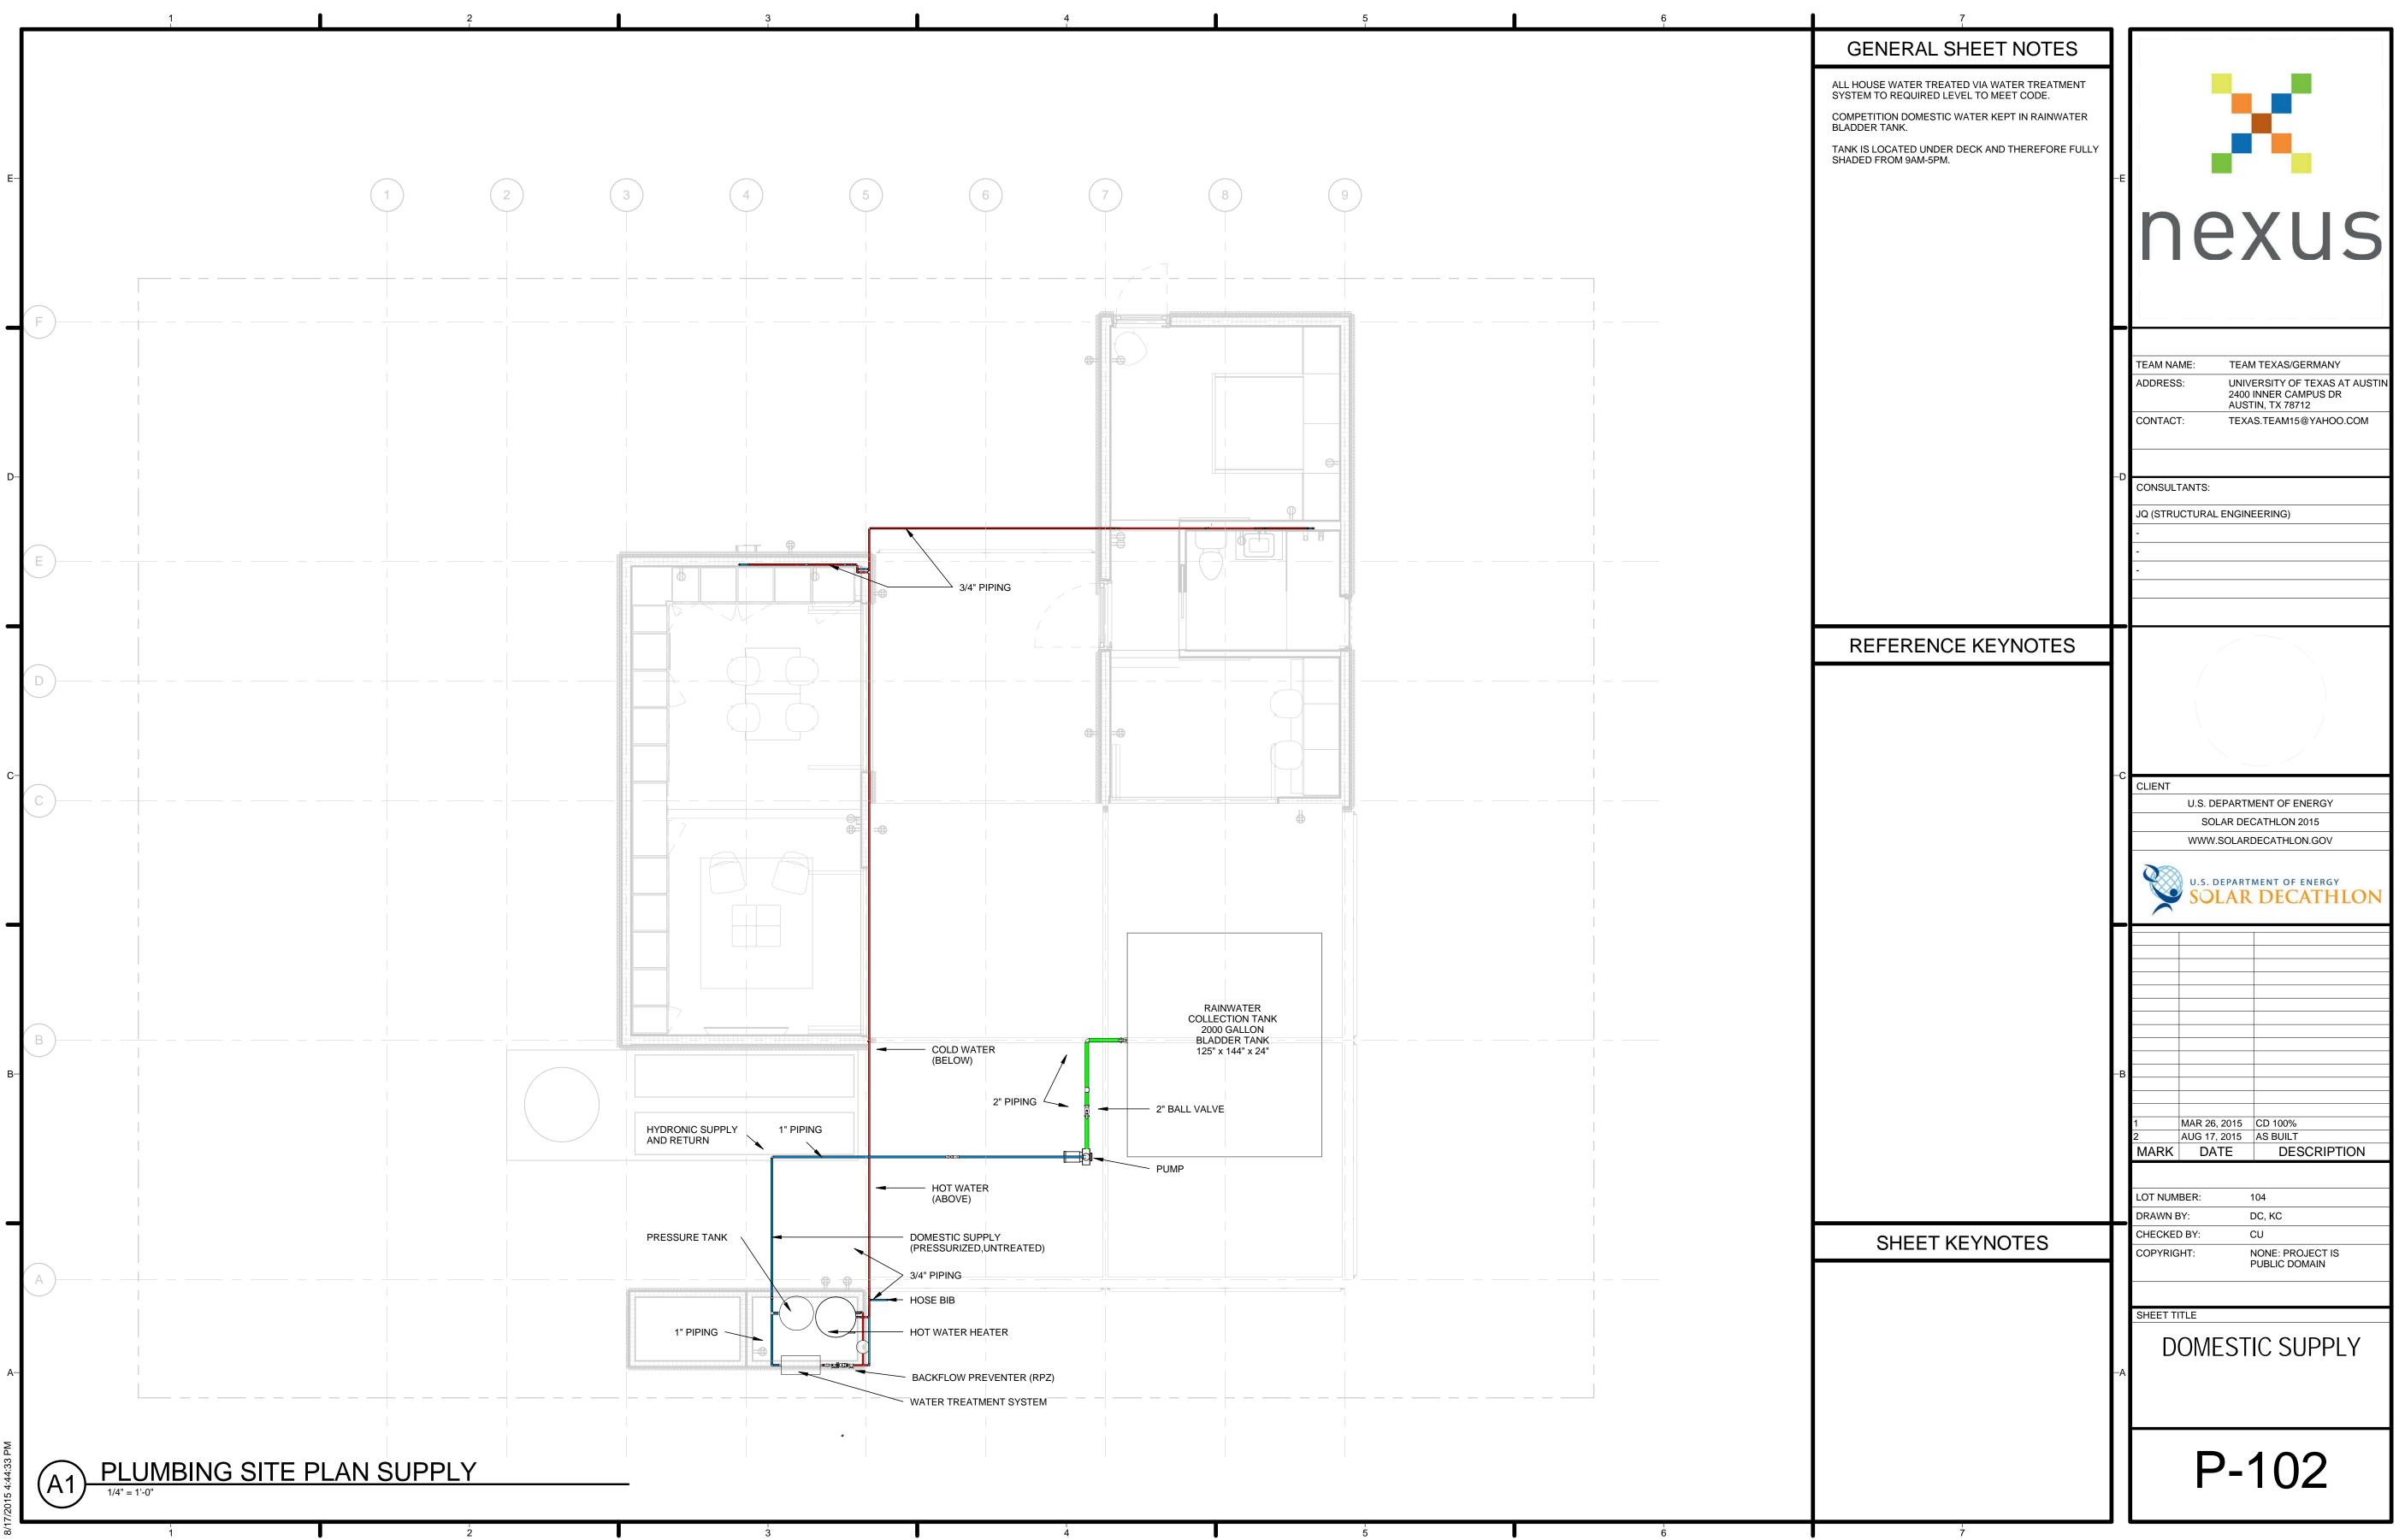


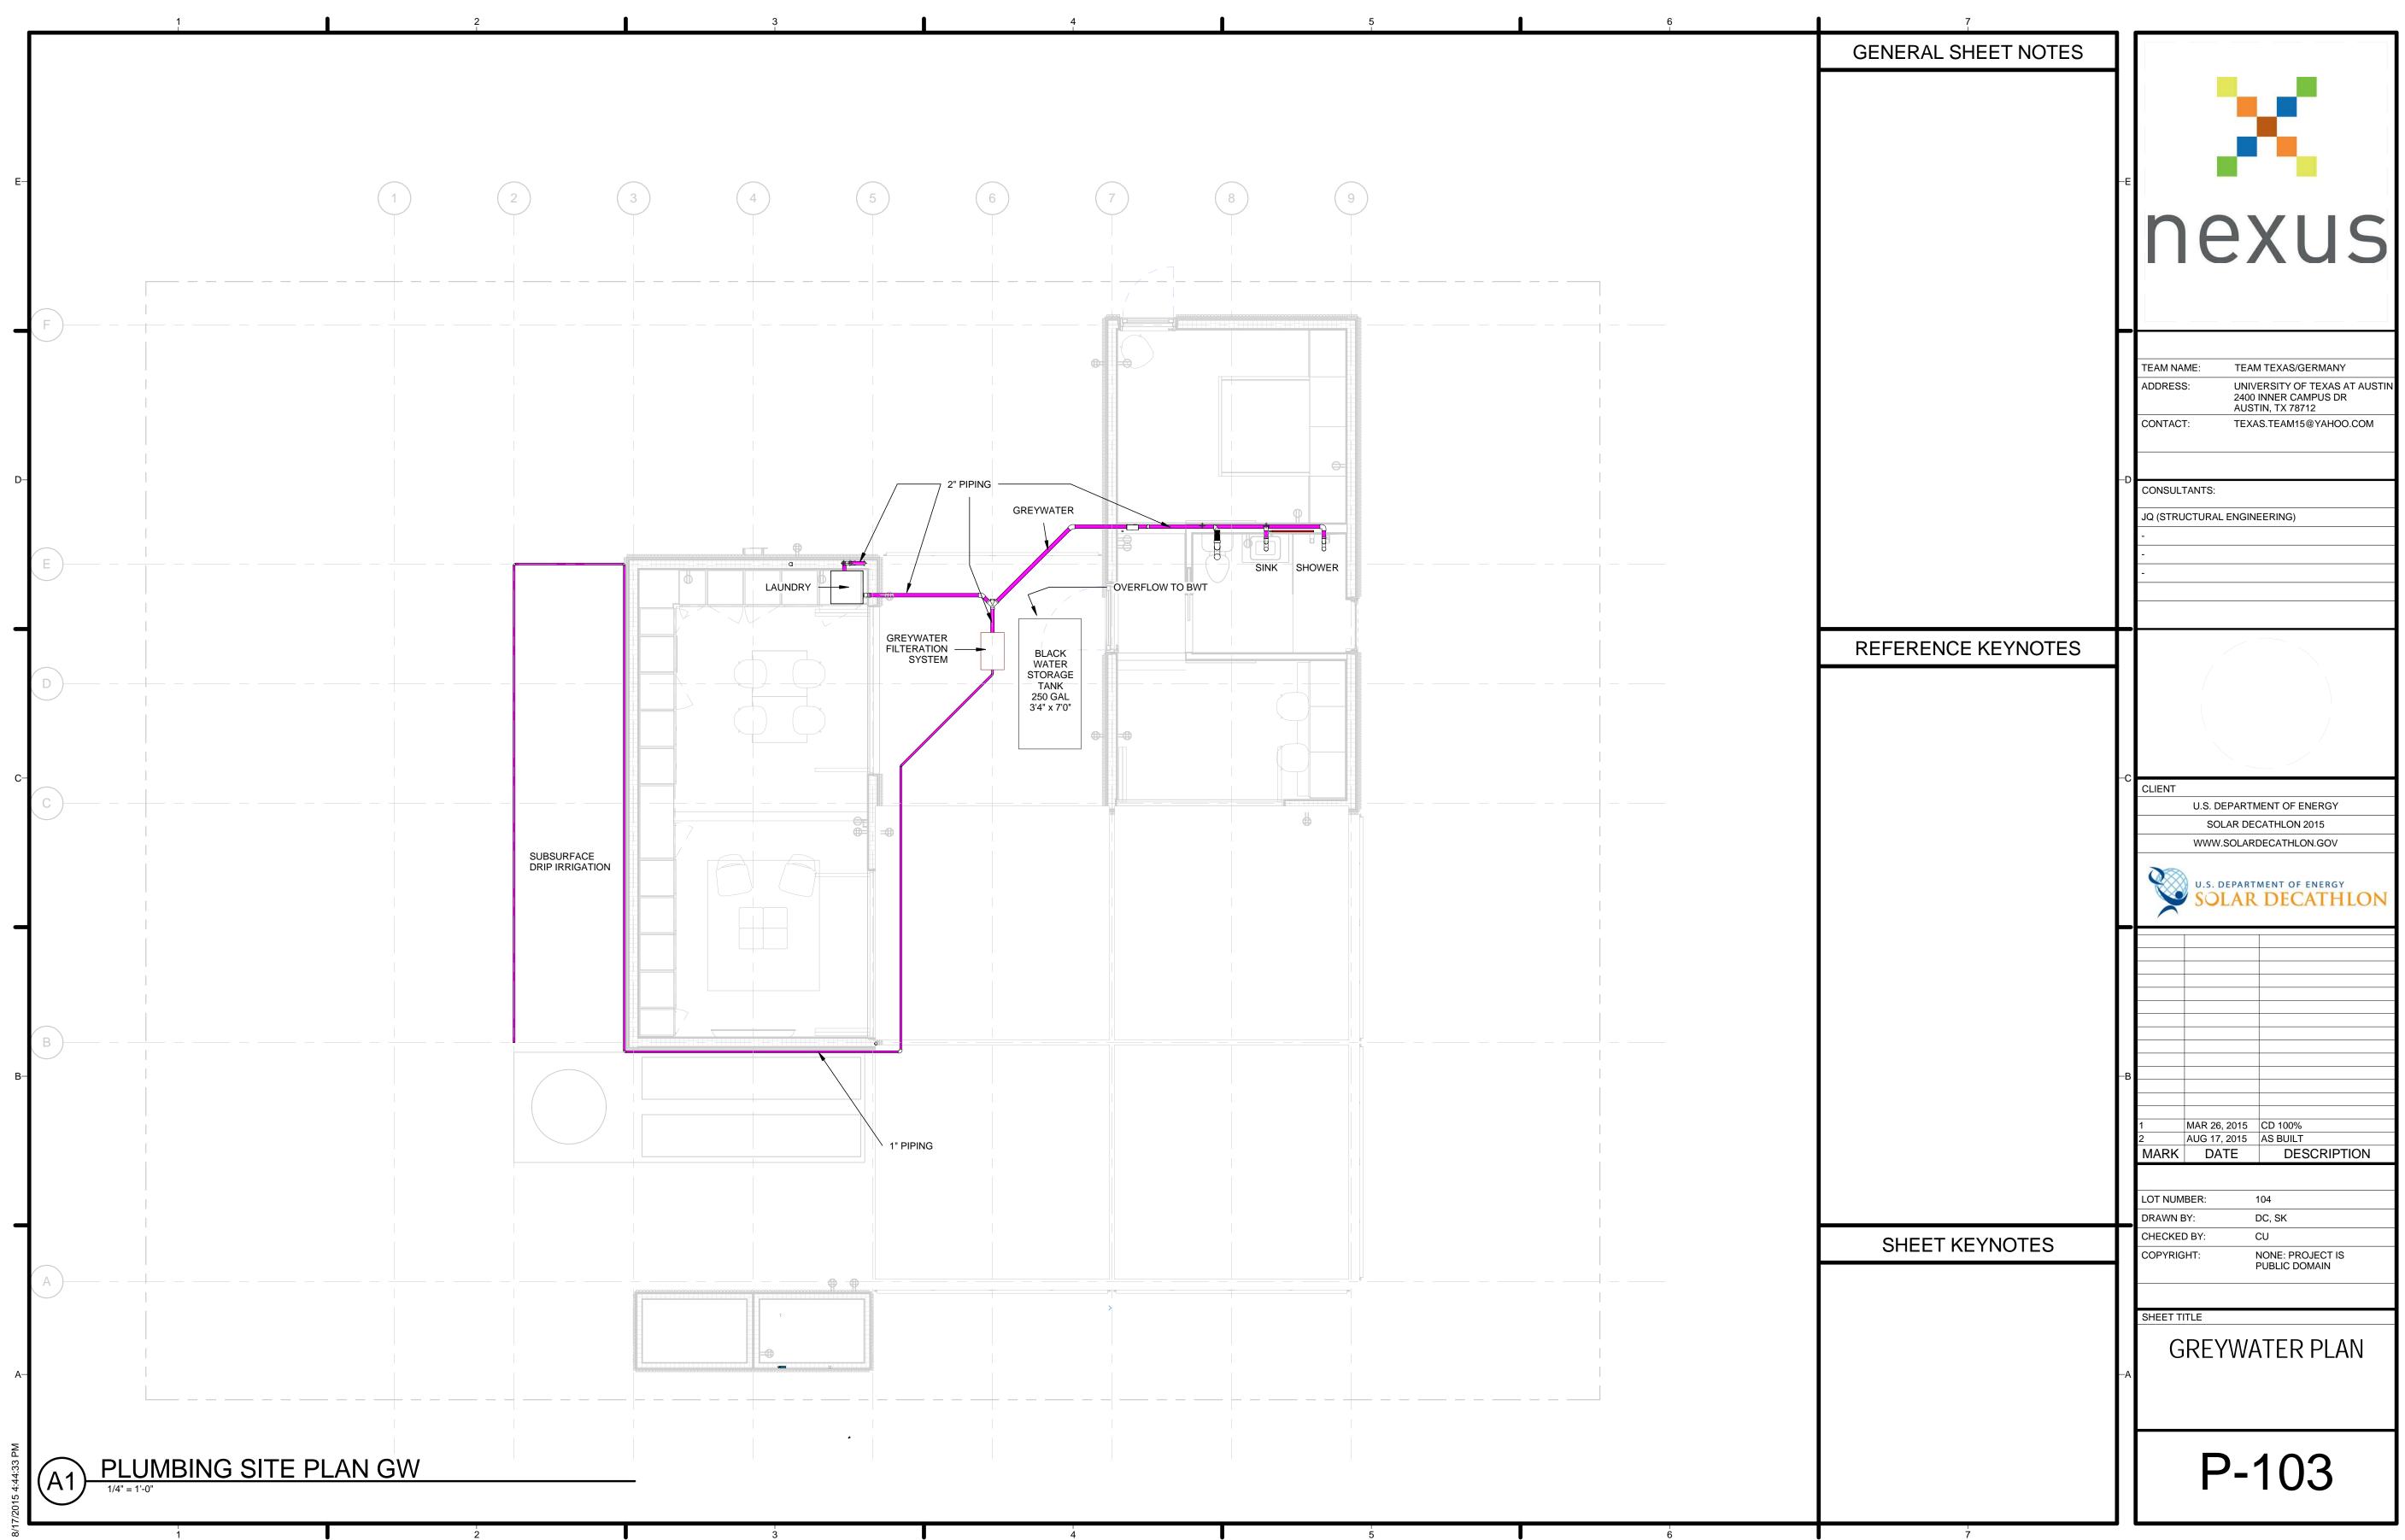





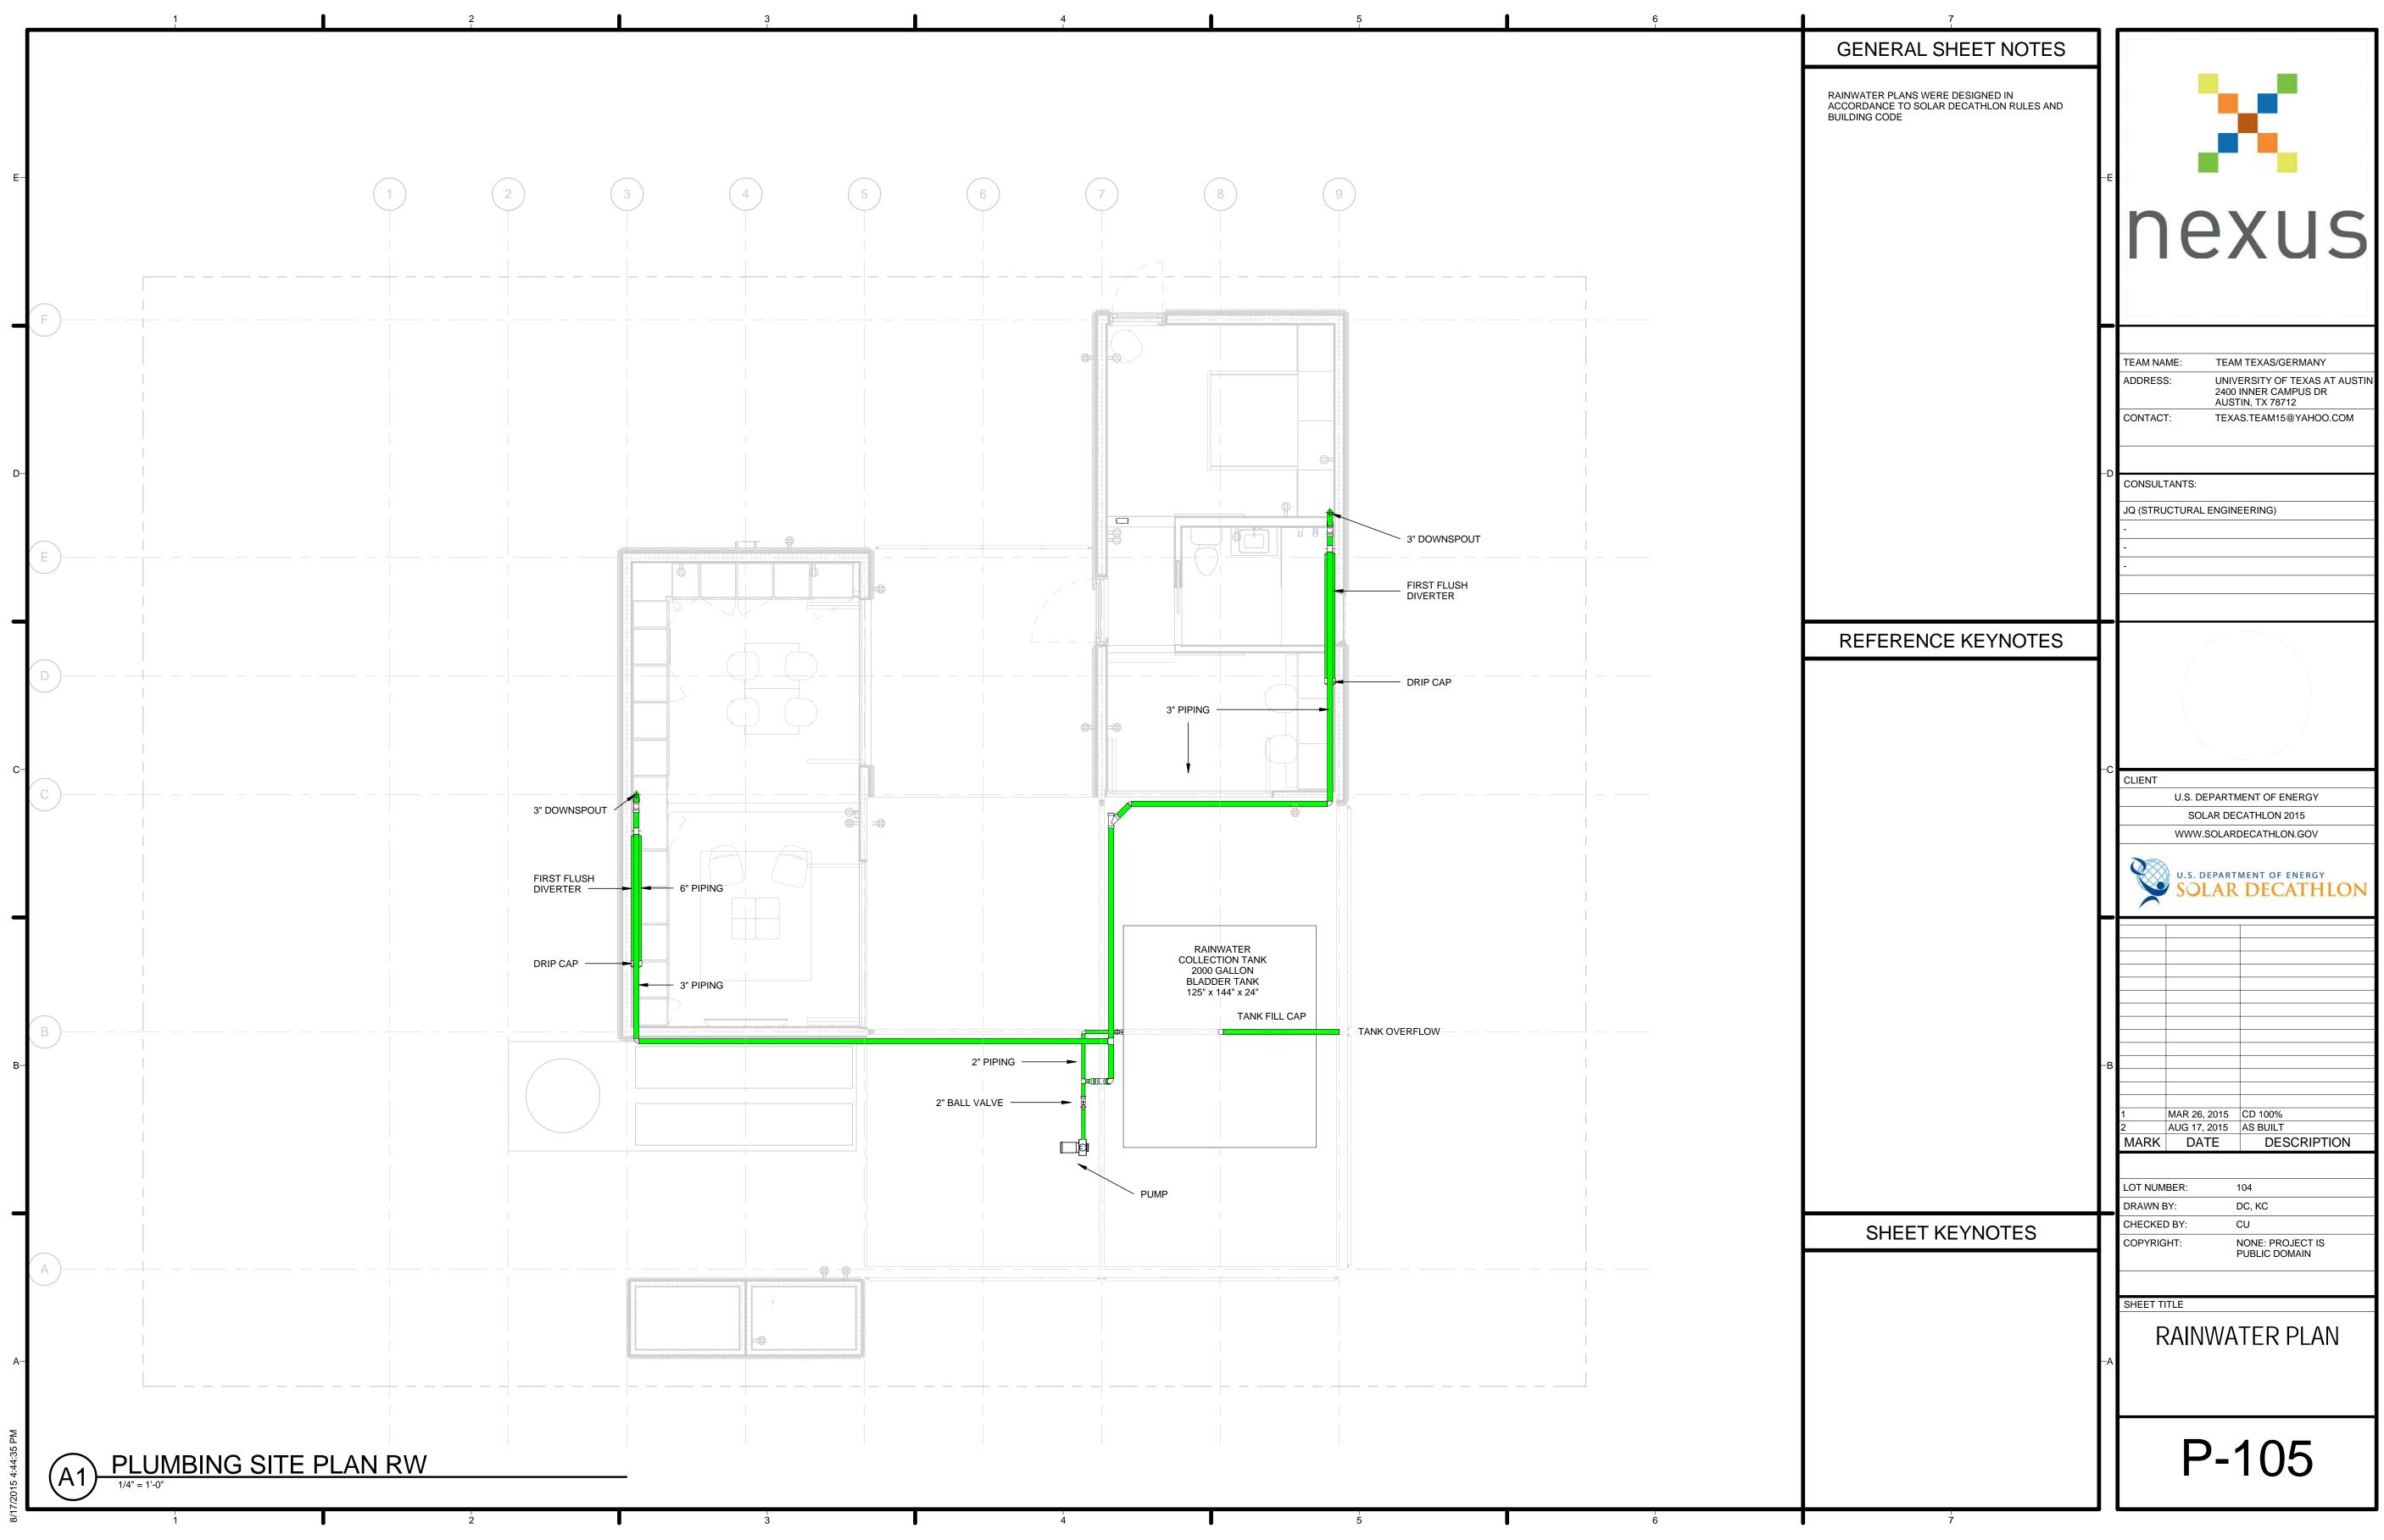

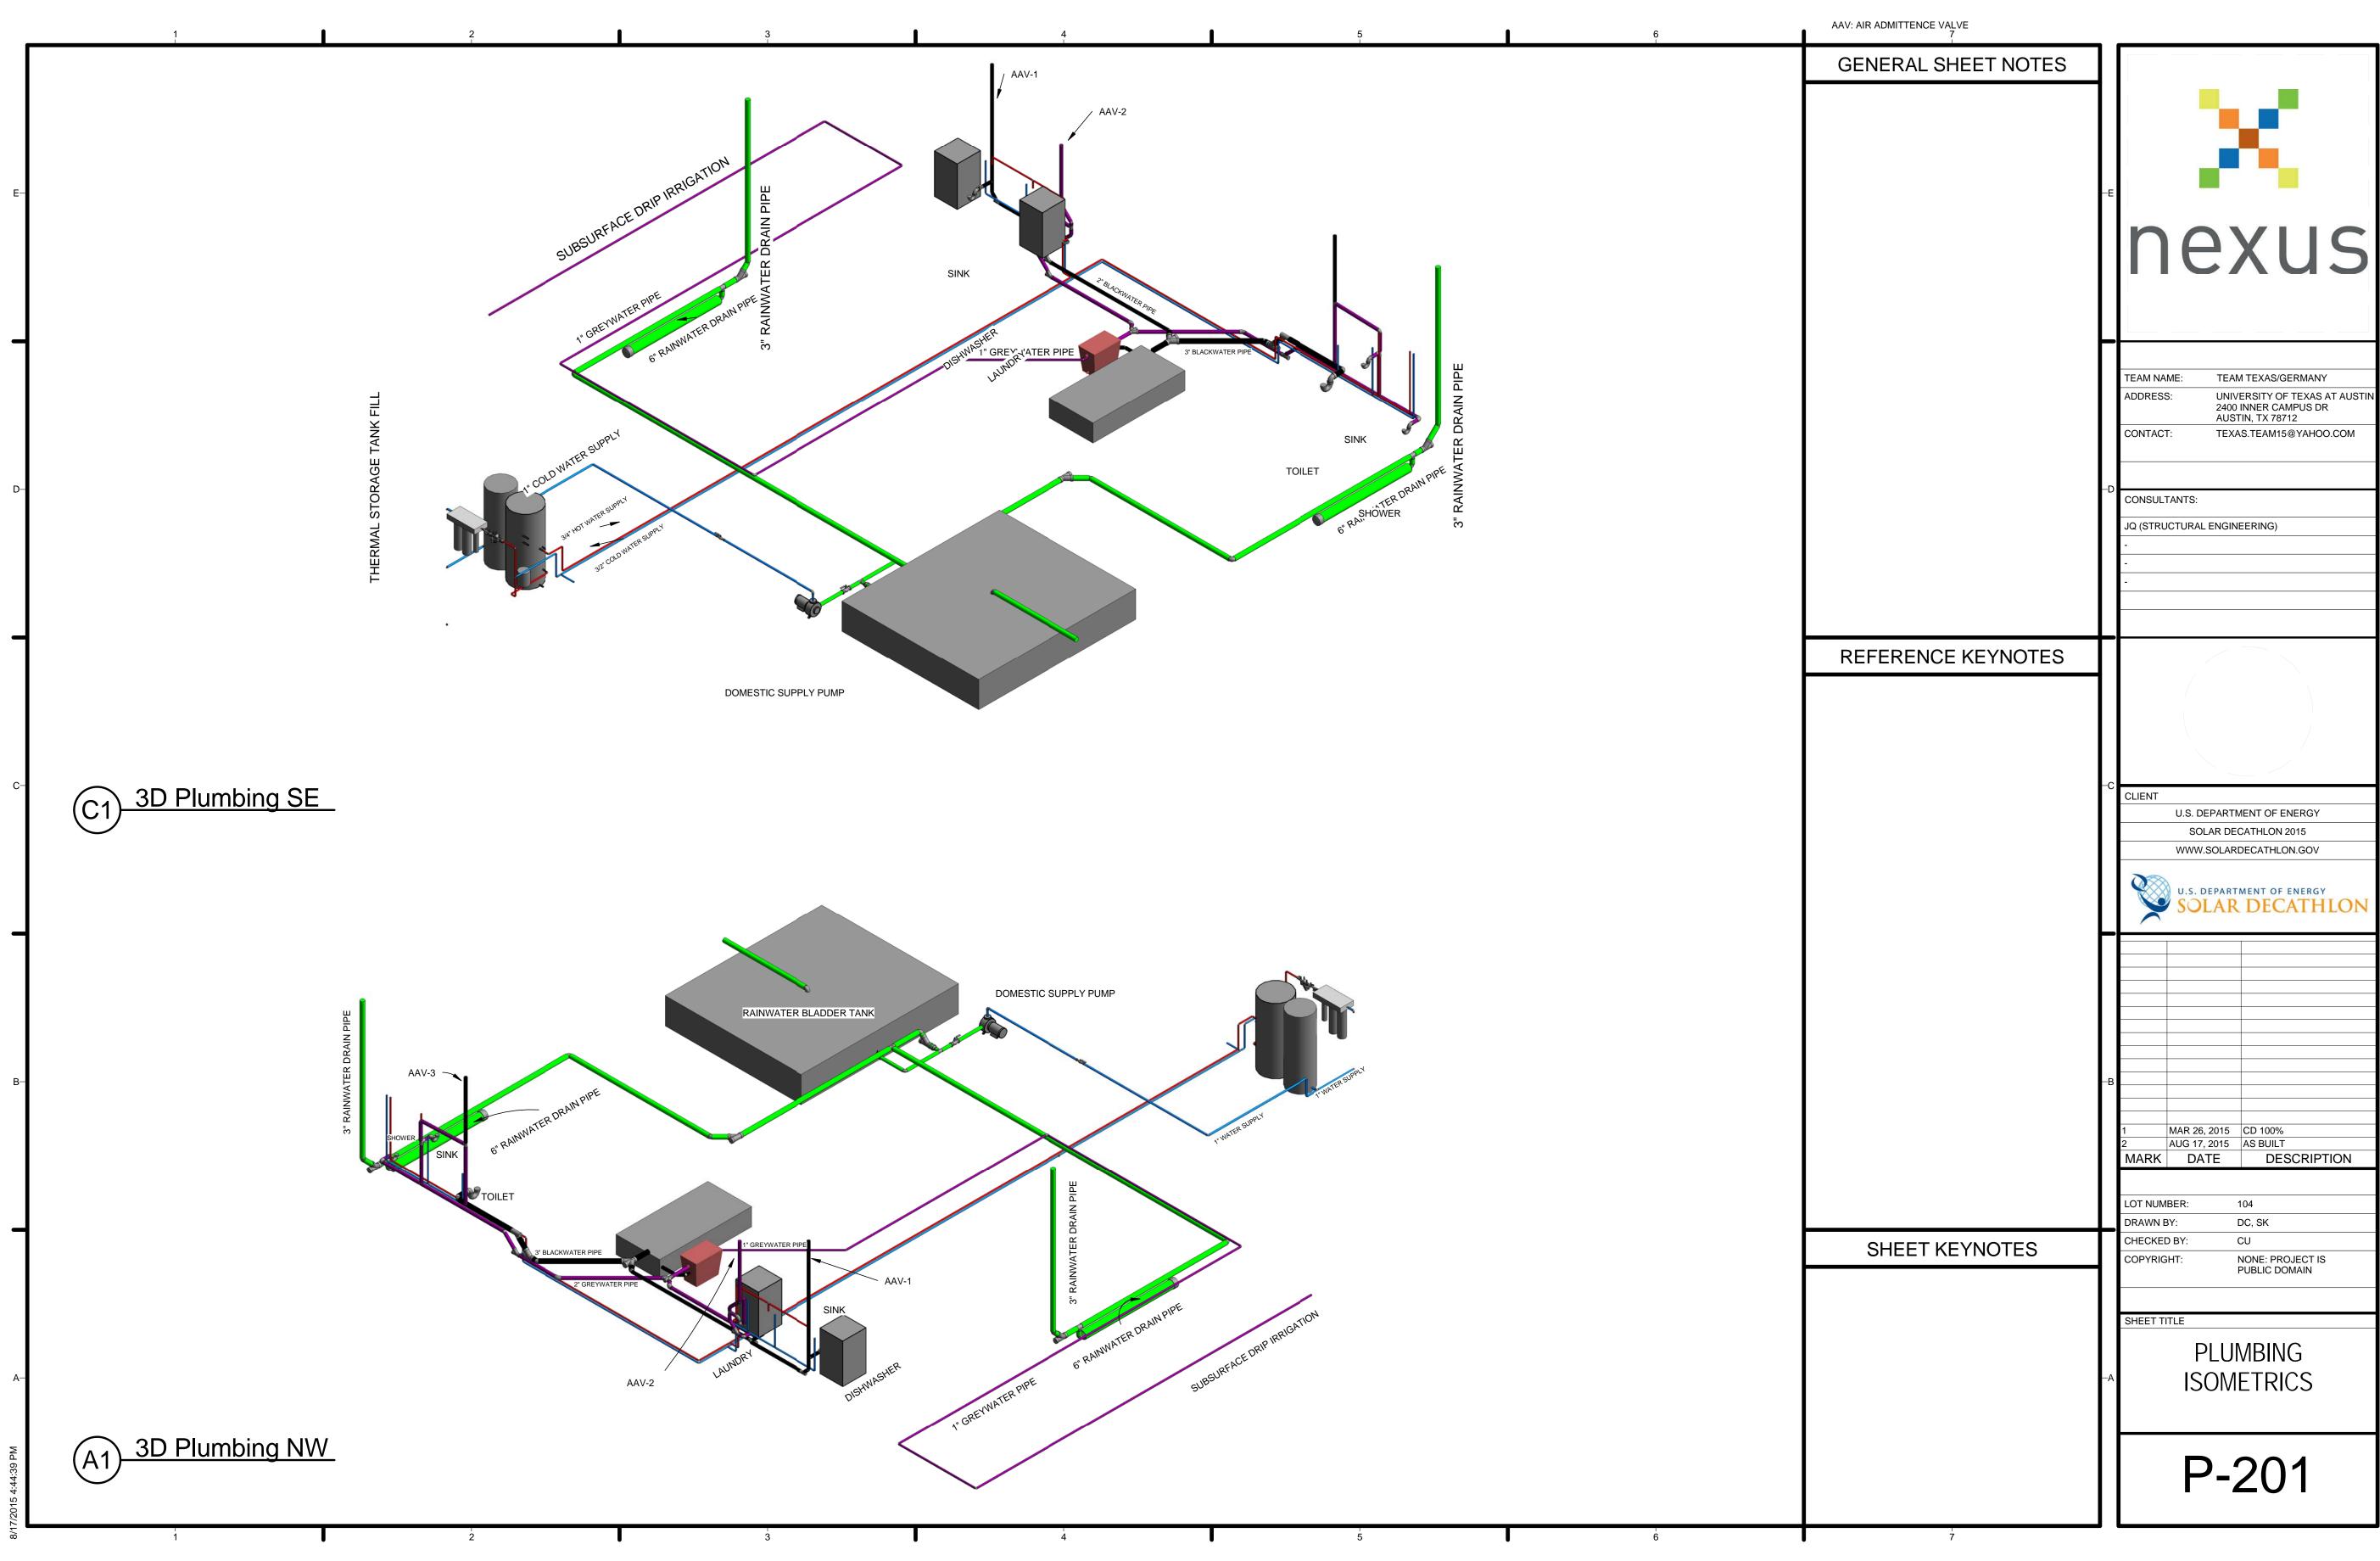

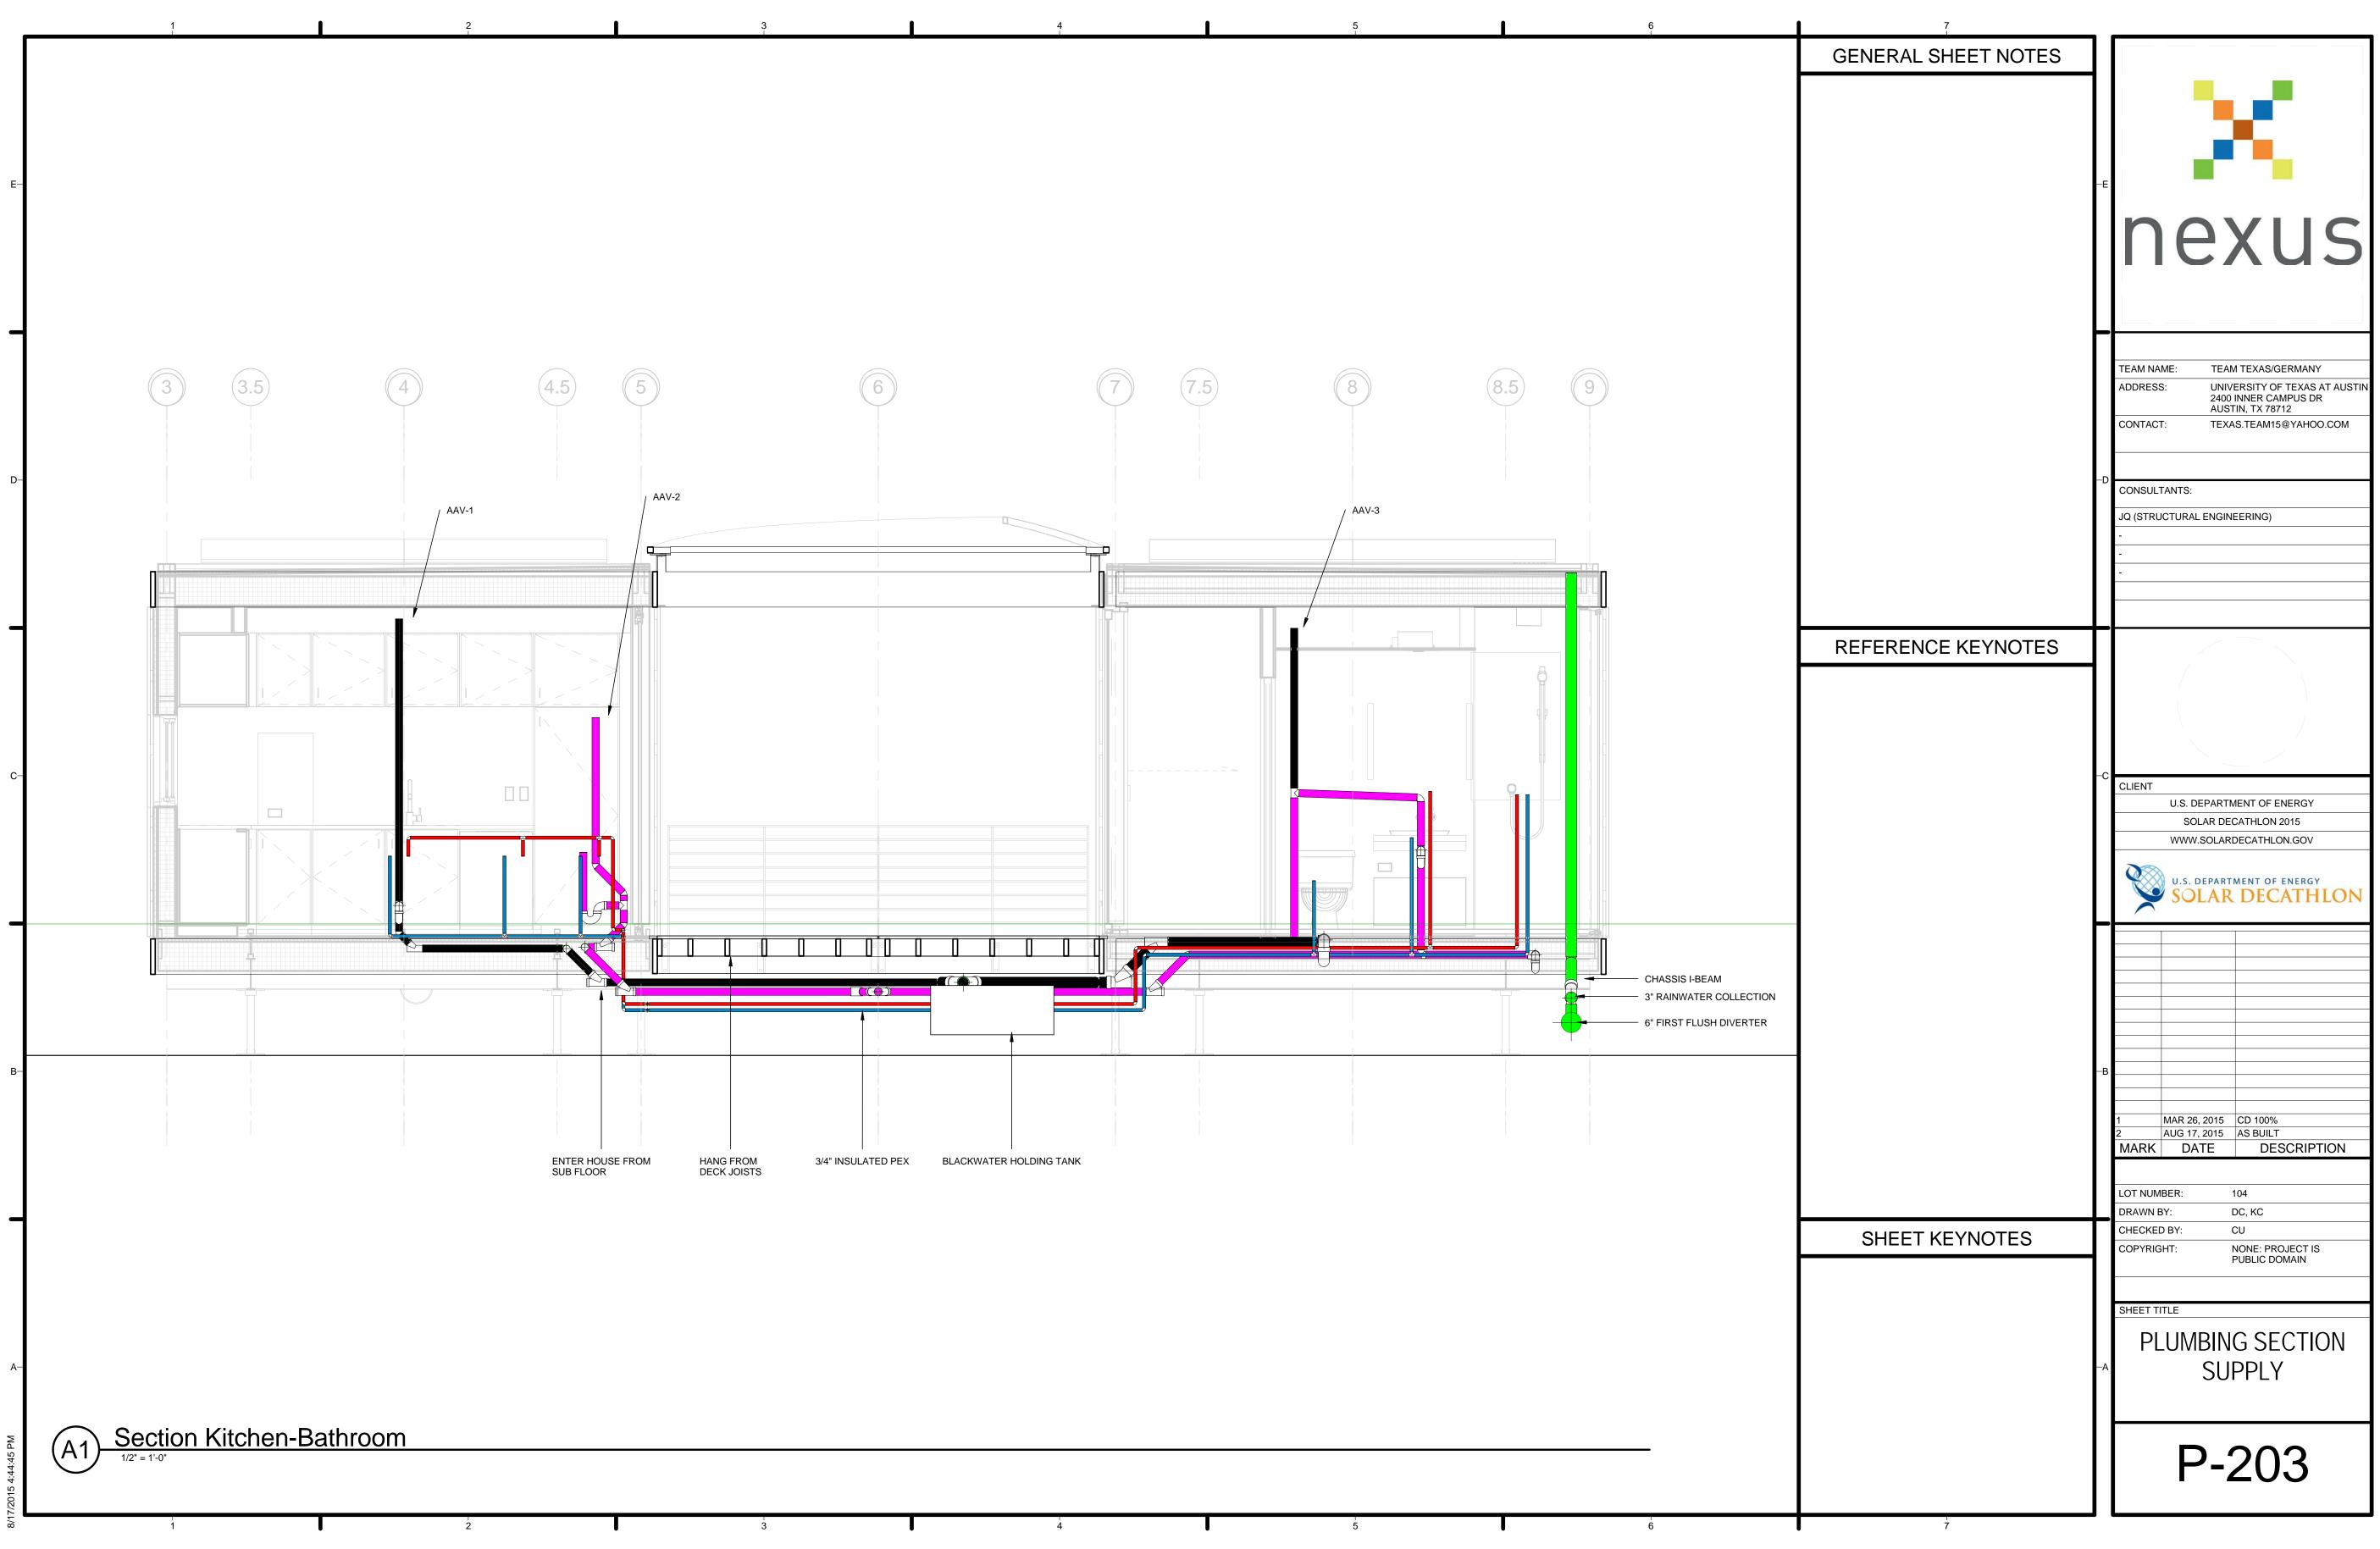

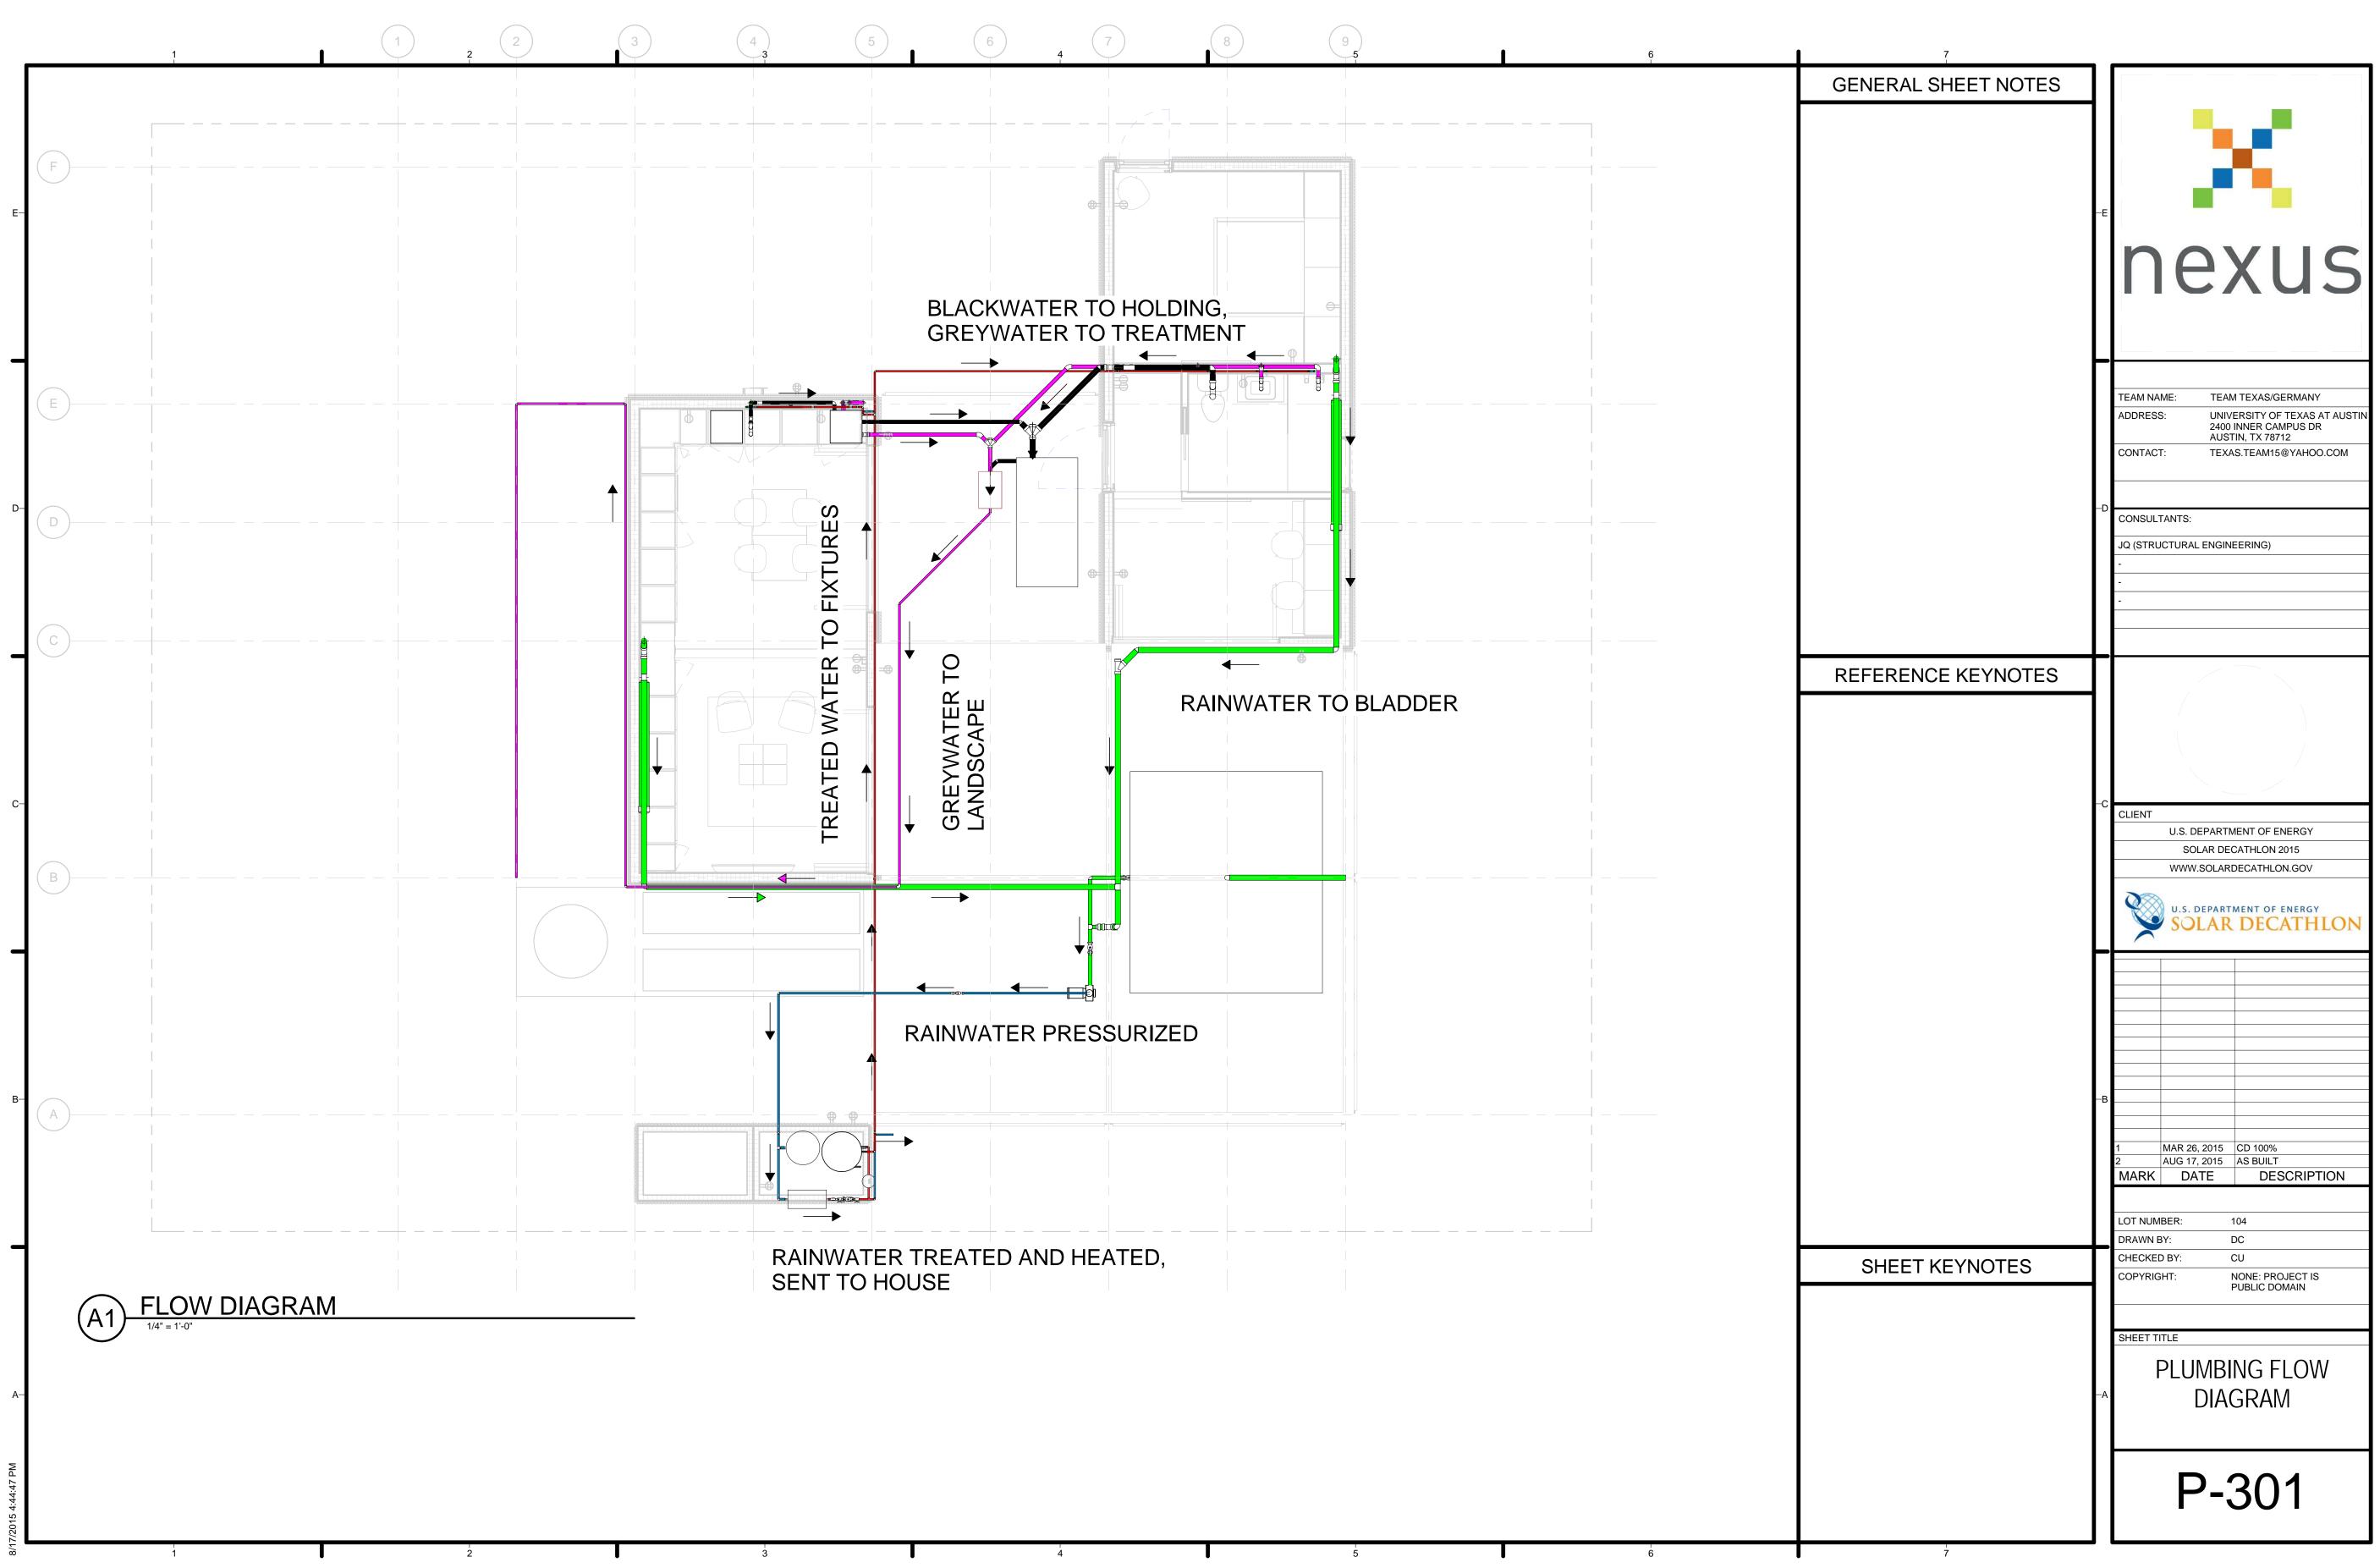

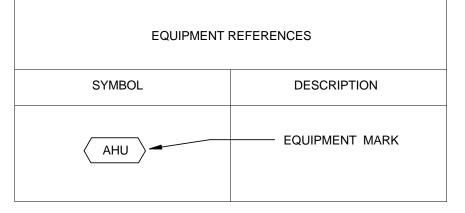

						HEATING			COOLING				
MARK	MANUFACTURER	MODEL	LOCATION	INLET/OUT LET SIZE (Ø")	WATER FLOW RATE (GPM)	LVG TEMP (°F)	HEATING CAPACITY (BTU/HR)	WATER FLOW RATE (GPM)	LVG TEMP (°F)	TOTAL LOAD (BTU/HR)	AIRFLOW RATE (CFM)	PRESSUR E DROP - HEAD (PSI)	MAX POWE (W)
FCU-1	CHILTRIX	CXI 84	DAY UNIT-ABOVE REFRIGERATOR	3/4	1.8	110	8090	1.8	44	8500	270	3.98	21
FCU-2	CHILTRIX	CXI 34	NIGHT-UNIT BATHROOM DROP CEILING	3/4	1.2	110	3550	1.2	44	3380	94	1.57	14
FCU-3	CU-3 CHILTRIX CXI 34 NIGHT-UNIT BATHROOM DROP 3/4 1.2 110 3550 1.2 44 3380 94 ¹								1.57	14			

ABBREVI	ATIONS
SYMBOL	DESCRIPTION
EF	EXHAUST FAN
EPT	EXPANSION PRESSURE TANK
ERV	ENERGY RECOVERY VENTILATOR
FCU	FAN COIL UNIT
НХ	HEAT EXCHANGER
ID	INDOOR UNIT
OD	OUTDOOR UNIT
P-FS	FIRE SUPPRESSION PUMP
P-HL	HYDRONIC LOOP PUMP
P-TS	THERMAL STORAGE PUMP
Т	THERMOSTAT
TES	THERMAL ENERGY STORAGE TANK

1

EPT	HYD	HYDRONIC LOOP							
MARK		DESCRIPTIO							
A	SI	DEWALL SUPPLY	RI						
В		RETURN REGI	SI						
R1		RETURN REGI	S1						
	•								
MANUFAC	TURER	N	10						
UPON	OR	CROSSLINKED P	0						
UPON	OR	CROSSLINKED P	0						
CERF	RO	COPPER,	Т						
IN	N TYPE								
SELF-SEA	L POLYE	THYLENE FOAM	⊢						
SELF-SEAL POLYETHYLENE FOAM									
SELF-SEA	L POLYE	THYLENE FOAM	H						

3

SERVICE

MARK

						R	EVERSIBL	E AIR-SOL	JRCE CHIL	LER/HEAT	PUMP SCHEDU	LE								
		BING	OPERATING RANGE								C	E	ELECTRICAL DATA							
					COOLIN	G TEMP	HEATIN	G TEMP	DOMES WATEF	TIC HOT R TEMP	REFRIGERANT	CHARGE	HEA	ΓING	COOL	lNG				
MARK	MANUFACTURER	MODEL	INLET/OUTLET CONNECTIONS		MIN (°F)	MAX (°F)	MIN (°F)	MAX (°F)	MIN (°F)	MAX (°F)	TYPE	(LBS)	CAPACITY (BTU/HR) (KBH)	INPUT POWER (KW) (KW)	CAPACITY (BTU/HR) (KBH)	INPUT POWER (KW) (KW)	MCA	VOLTAGE P	H HZ	NOTES
C/HP	CHILTRIX	CX30	1" NPT	0.2 - 6	-4	126	-13	100	-4	110	R-410A	4.4	25850	1.7	20160	1.47	12	208-240	60	

4

	MAL ENERGY STORAGE TANK SCHE	EDULE				
MARK MANUFACTURED MOREL OVETEM TYPE DIAMETER HEIGHT MIN VO	VOLUME CAPACITY		SYSTEM OPERAT	TING TEMP		
	(GAL) (GAL)	MIN CHARGE PRESSSURE	MIN	MAX	OUTLET	NOTES
			(°F)	(°F)		
TES COR-GAL GARDENTANK 4-1000 CHILLED WATER 48 131 50	500 1000	UNPRESSURIZED	43	55	2" FEMALE NPT	R-10 INSULATION

					PUMP SCHE	DULE						
MADK	MARK MANUF MODEL		IANUF MODEL SYSTEM			HEAD	% EFFECIENCY	ELEC	TRICAL DATA		Ш7	NOTES
			STOTEIVI	(IN)	(GPM)	(FT)		HP	VOLTAGE	PH	ΠΖ	NOTES
P-TS	BELL & GOSSETT	ECOCIRC XL B 36-45	TES LOOP		4.2	25		1/6	230	29	50/60	
P-HL	BELL & GOSSETT	ECOCIRC XL B 55-45	HYDRONIC LOOP		4.2	30		1/2	230	38	50/60	

		EXP	ANSION TANK SCHEDULE			
MANUFACTURER	SERIES	TANK SIZE (GALLONS)	MAX DRAWDOWN VOLUME (GALLONS)	HEIGHT (IN)	DIAMETER (IN)	
GOULDS	V69	1.9	1.3	8 1/4	10 3/16	

ON	SIZE	MOUNT	FINISH	MANUFACTURER	MODEL	
REGISTER	10"x6"	SIDEWALL	WHITE	TITUS	300FS	
STER	19"x7"	ON WALL FACE ABOVE DOOR	WHITE	TITUS	350RL	
STER	19"x7"	ON WALL FACE ABOVE DOOR	WHITE	TITUS	350RL	

	PII	PE SCHEDULE		
MODEL	SIZE	MATERIAL TYPE	FITTING TYPE	JOINT TYPE
POLYETHYLENE (PEX)	1"	PEX-A	PROPEX, NPT	COLD EXPANSION FITTING
POLYETHYLENE (PEX)	3/4"	PEX-A	PROPEX, NPT	COLD EXPANSION FITTING
, TYPE K HARD	1"	COPPER	SOLDER, NPT	SOLDER


	PIPE INSULATION S	SCHEDULE				
DESCRIPTION	MANUFACTURER	MODEL	INTERNAL DIAMETER (IN)	WALL THICKNESS (IN)	R	NOTES
HYDRONIC SYSTEM PIPE INSULATION	NOMALOCK	NRG5	7/8	1	7.2	
HYDRONIC SYSTEM PIPE INSULATION	NOMALOCK	NRG5	1 1/8	1	6.8	

5

NOTES

7

NOTES

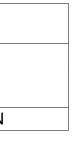




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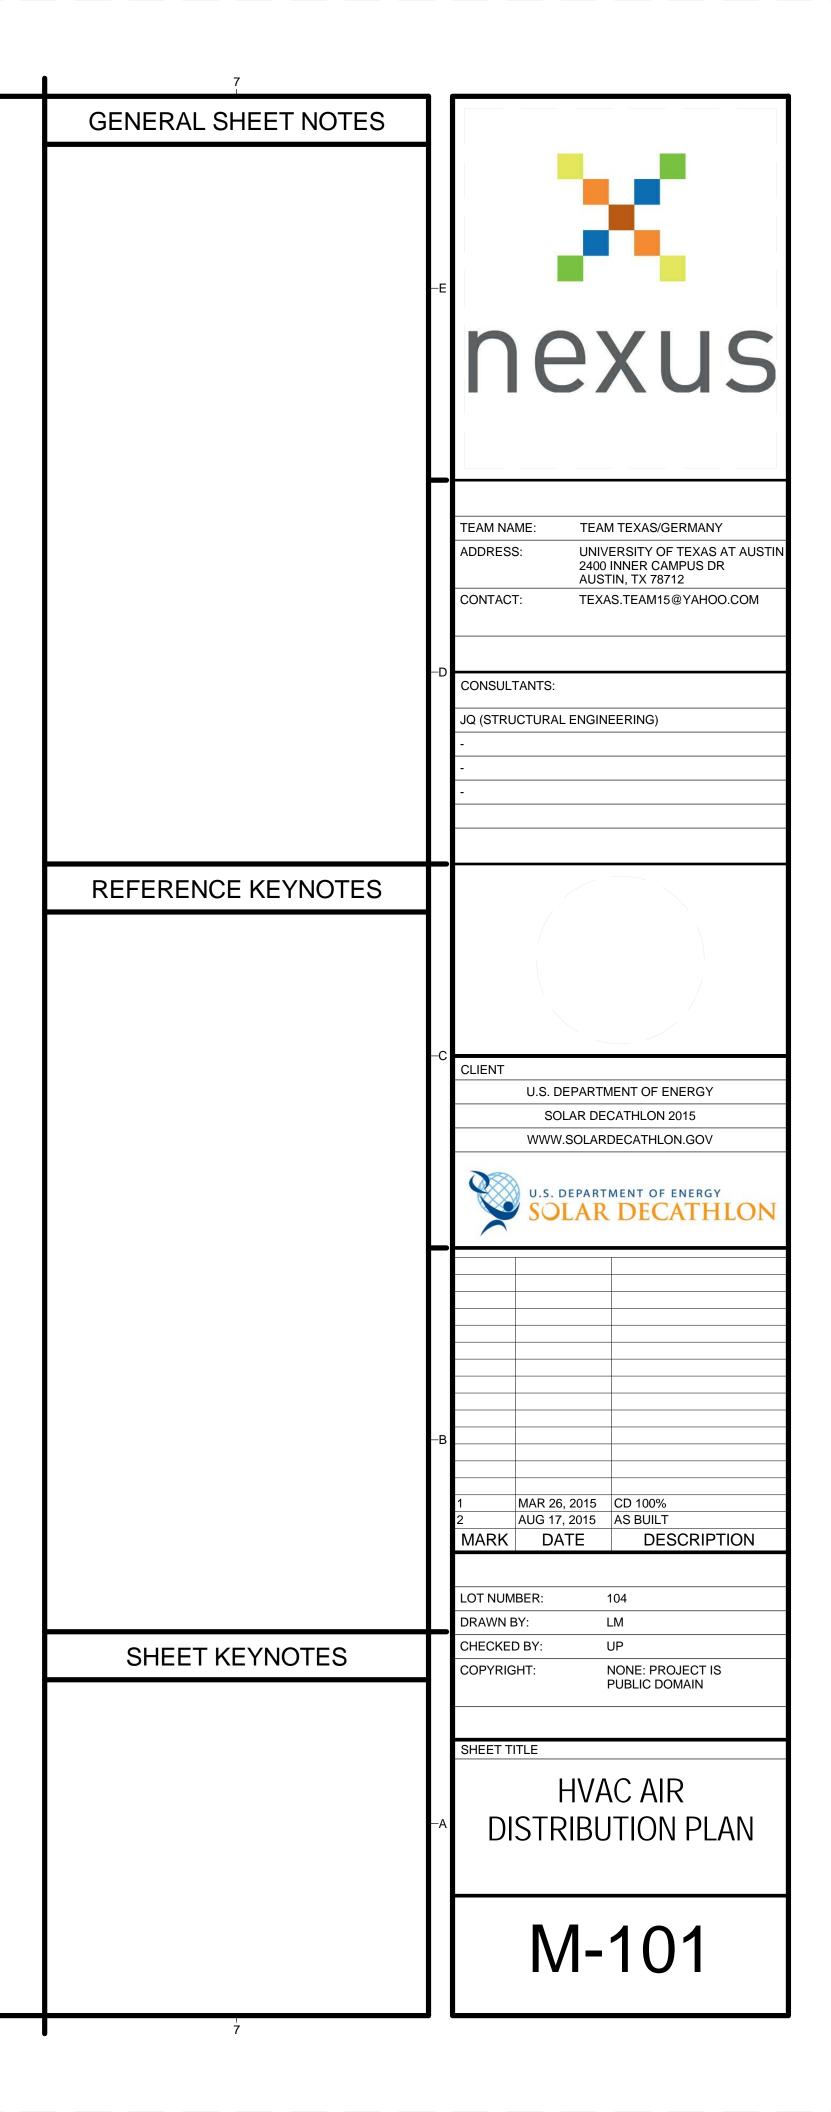
nexus TEAM NAME: TEAM TEXAS/GERMANY UNIVERSITY OF TEXAS AT AUSTIN 2400 INNER CAMPUS DR AUSTIN, TX 78712 ADDRESS: TEXAS.TEAM15@YAHOO.COM CONTACT: CONSULTANTS: JQ (STRUCTURAL ENGINEERING) CLIENT U.S. DEPARTMENT OF ENERGY SOLAR DECATHLON 2015 WWW.SOLARDECATHLON.GOV U.S. DEPARTMENT OF ENERGY SOLAR DECATHLON MAR 26, 2015 CD 100% AUG 17, 2015 AS BUILT MARK DATE DESCRIPTION LOT NUMBER: 104 DRAWN BY: RH CHECKED BY: CU NONE: PROJECT IS PUBLIC DOMAIN COPYRIGHT: SHEET TITLE MECHANICAL SYMBOLS AND SCHEDULES M-001


							ΗΕΑΤ ΕΧ	CHANGER SCH	IEDULE						
					MAX FLOW		INDO	OR UNIT SIDE			THERM	AL ENERGY STOR	AGE SIDE		
MARK	MANUFACTURER	DESCRIPTION	MODEL	INLET/OUTLET SIZE (Ø")	RATE (GPM)	FLUID	ENT TEMP (°F)	LVG TEMP (°F)	MAX PRESS DROP (IN WG)	FLUID	ENT TEMP (°F)	LVG TEMP (°F)	MAX PRESS DROP (IN WG)	HEATING CAPACITY (KBH)	NOTES
HX	ALFA LAVAL	PLATE HEAT EXCHANGER	AQ1L-FG	1.25	20	WATER	55	45	112.4	WATER	43	53	106.7	70	


				ENERGY RECOVERY VENTILAT	OR SCHEDUL	E								
					WALL	MIN WALL	MAX WALL	MAX FLOW		ELECTRIC	L DATA			
MARK	MANUFACTURER	MODEL	DESCRIPTION	LOCATION	OPENING (IN)	THICKNESS	THICKNESS	RATE (CFM)	POWER	VOLTAGE	PHASE	HZ	CONTROL	NOTES
ERV-3	VENTOMAXX	Z-WRG RONDO IQ	MULTI-FUNCTION THROUGH-WALL ERV	DAY-UNIT - SOUTHWEST CORNER	8	4 3/4	11 13/16	25	3.4	120	1	60	WALL SWITCH	
ERV-1	VENTOMAXX	Z-WRG RONDO IQ	MULTI-FUNCTION THROUGH-WALL ERV	NIGHT UNIT - BEDROOM	8	4 3/4	11 13/16	25	3.4	120	1	60	WALL SWITCH	
ERV-2	VENTOMAXX	Z-WRG RONDO IQ	MULTI-FUNCTION THROUGH-WALL ERV	NIGHT UNIT - BEDROOM	8	4 3/4	11 13/16	25	3.4	120	1	60	WALL SWITCH	
ERV-5	Johnson Controls, Inc.	CXI 34	Low Profile Horizontal Fan Coil Unit	NIGHT-UNIT BATHROOM DROP CEILING					14					

-E	nexus
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-D	CONSULTANTS: JQ (STRUCTURAL ENGINEERING) - - - -
–C	
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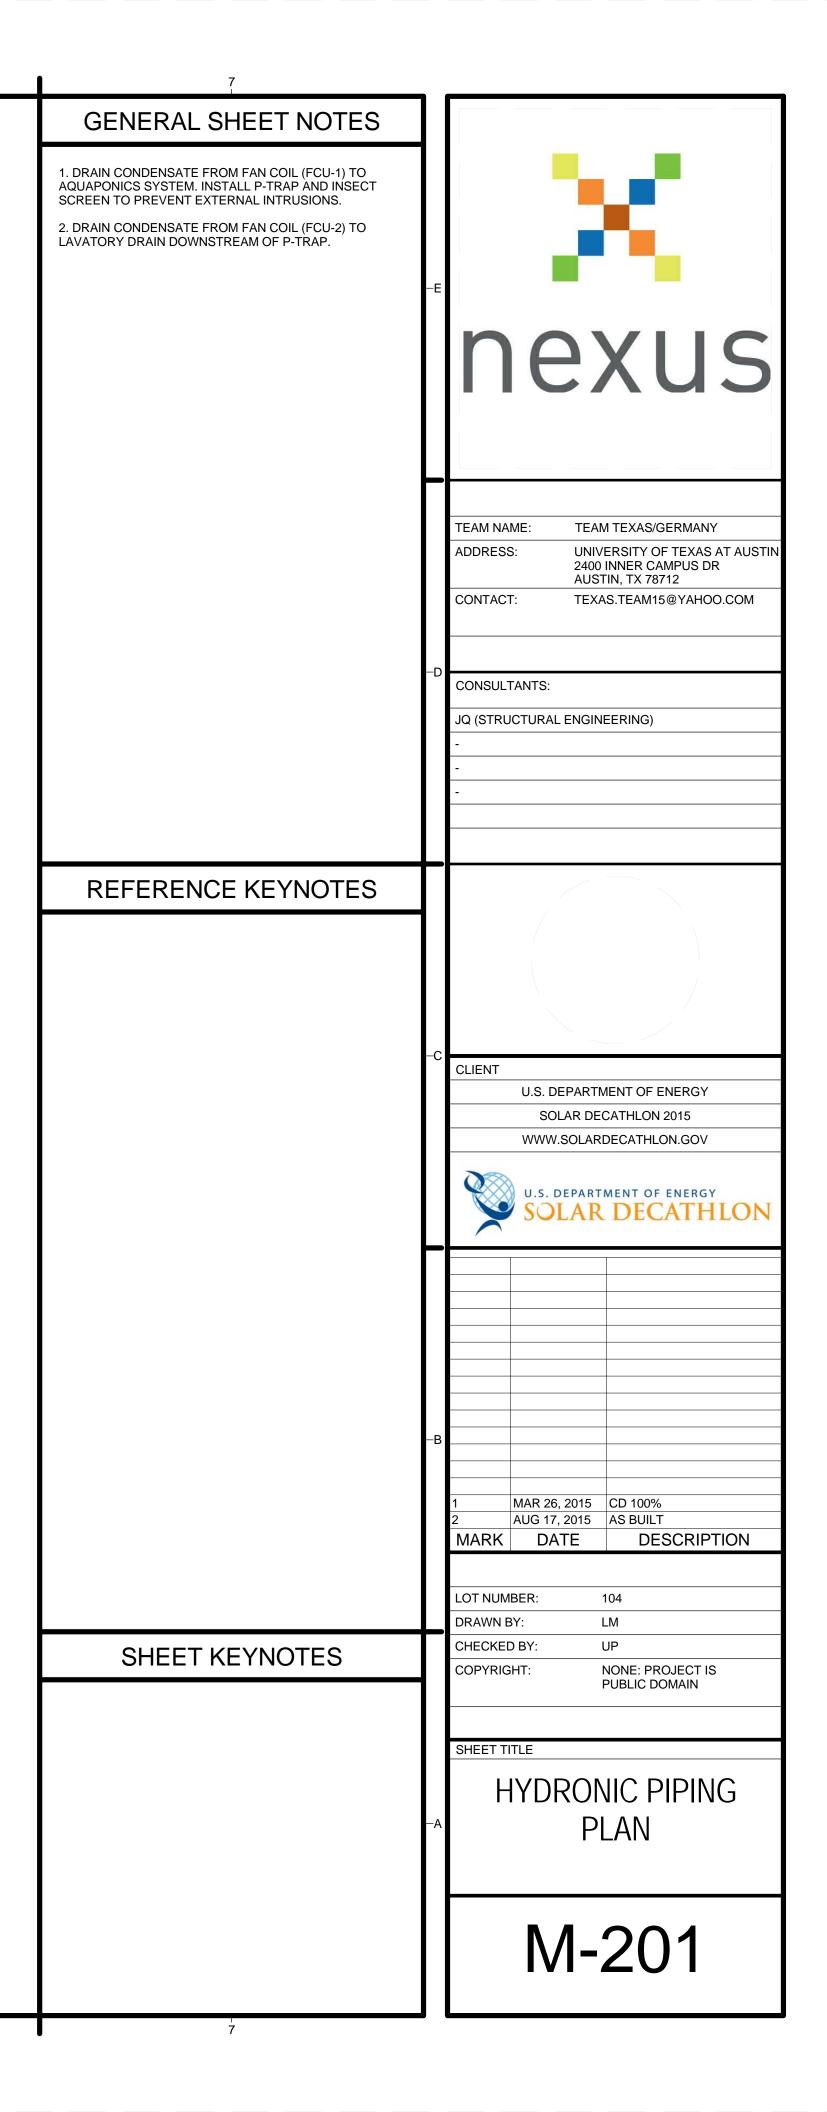



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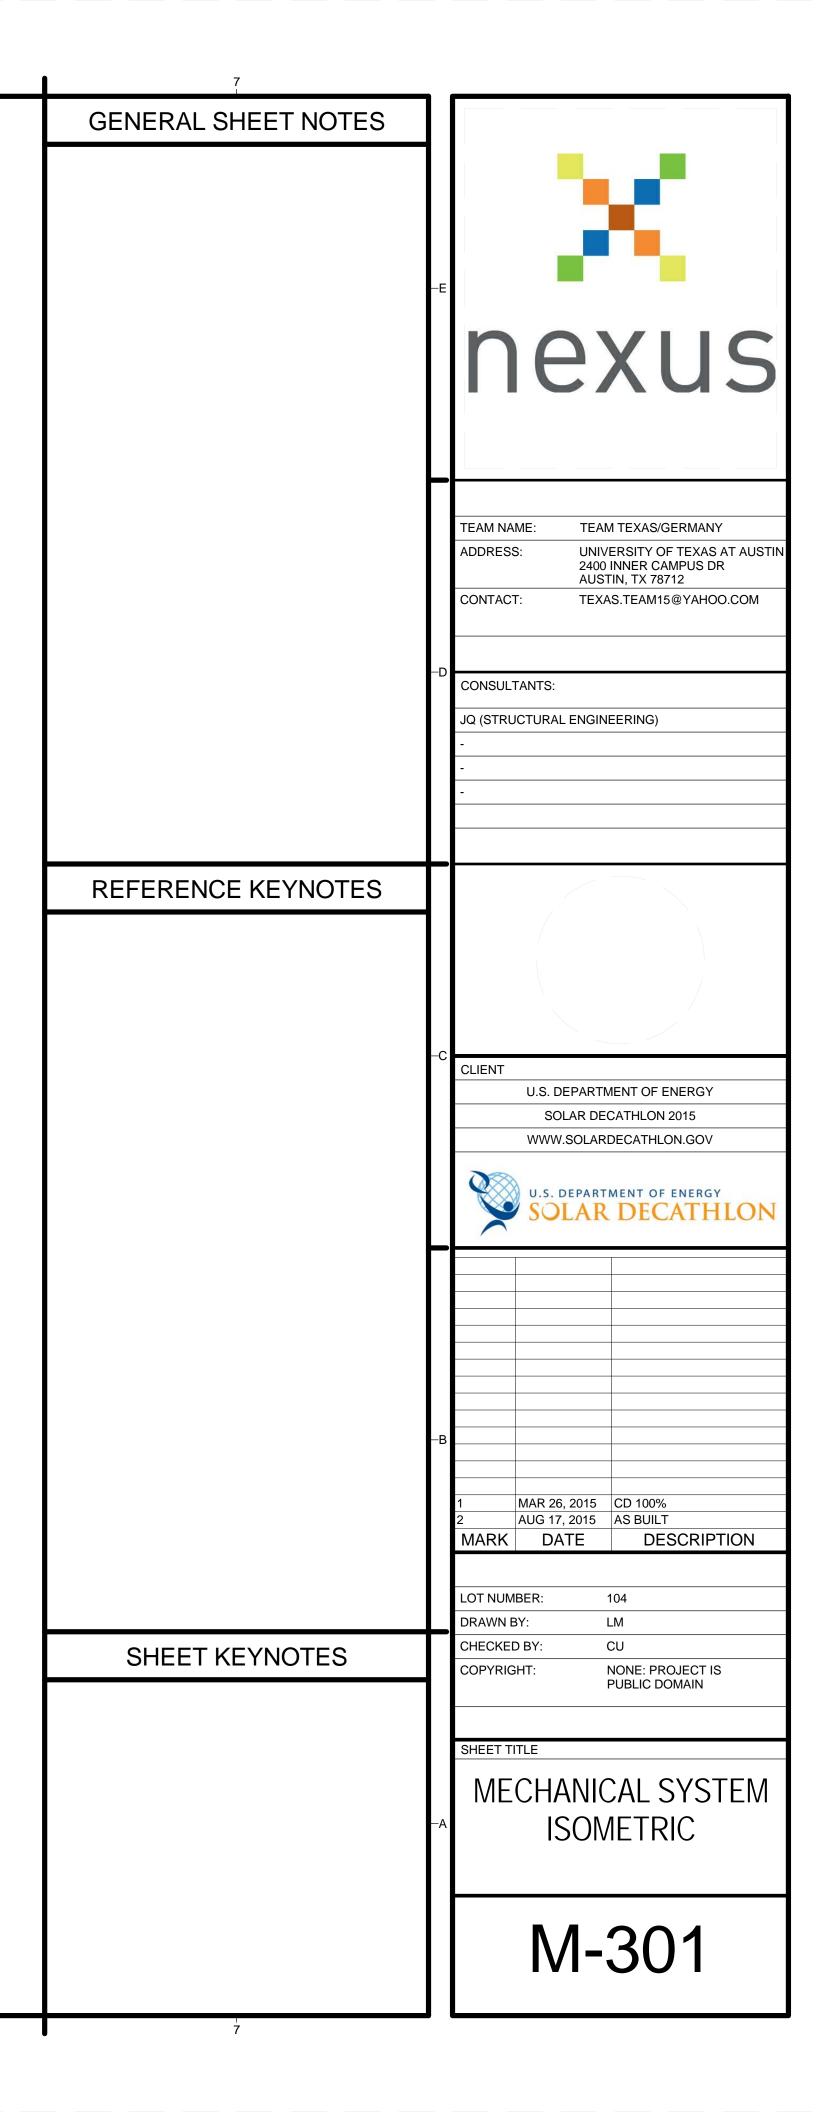
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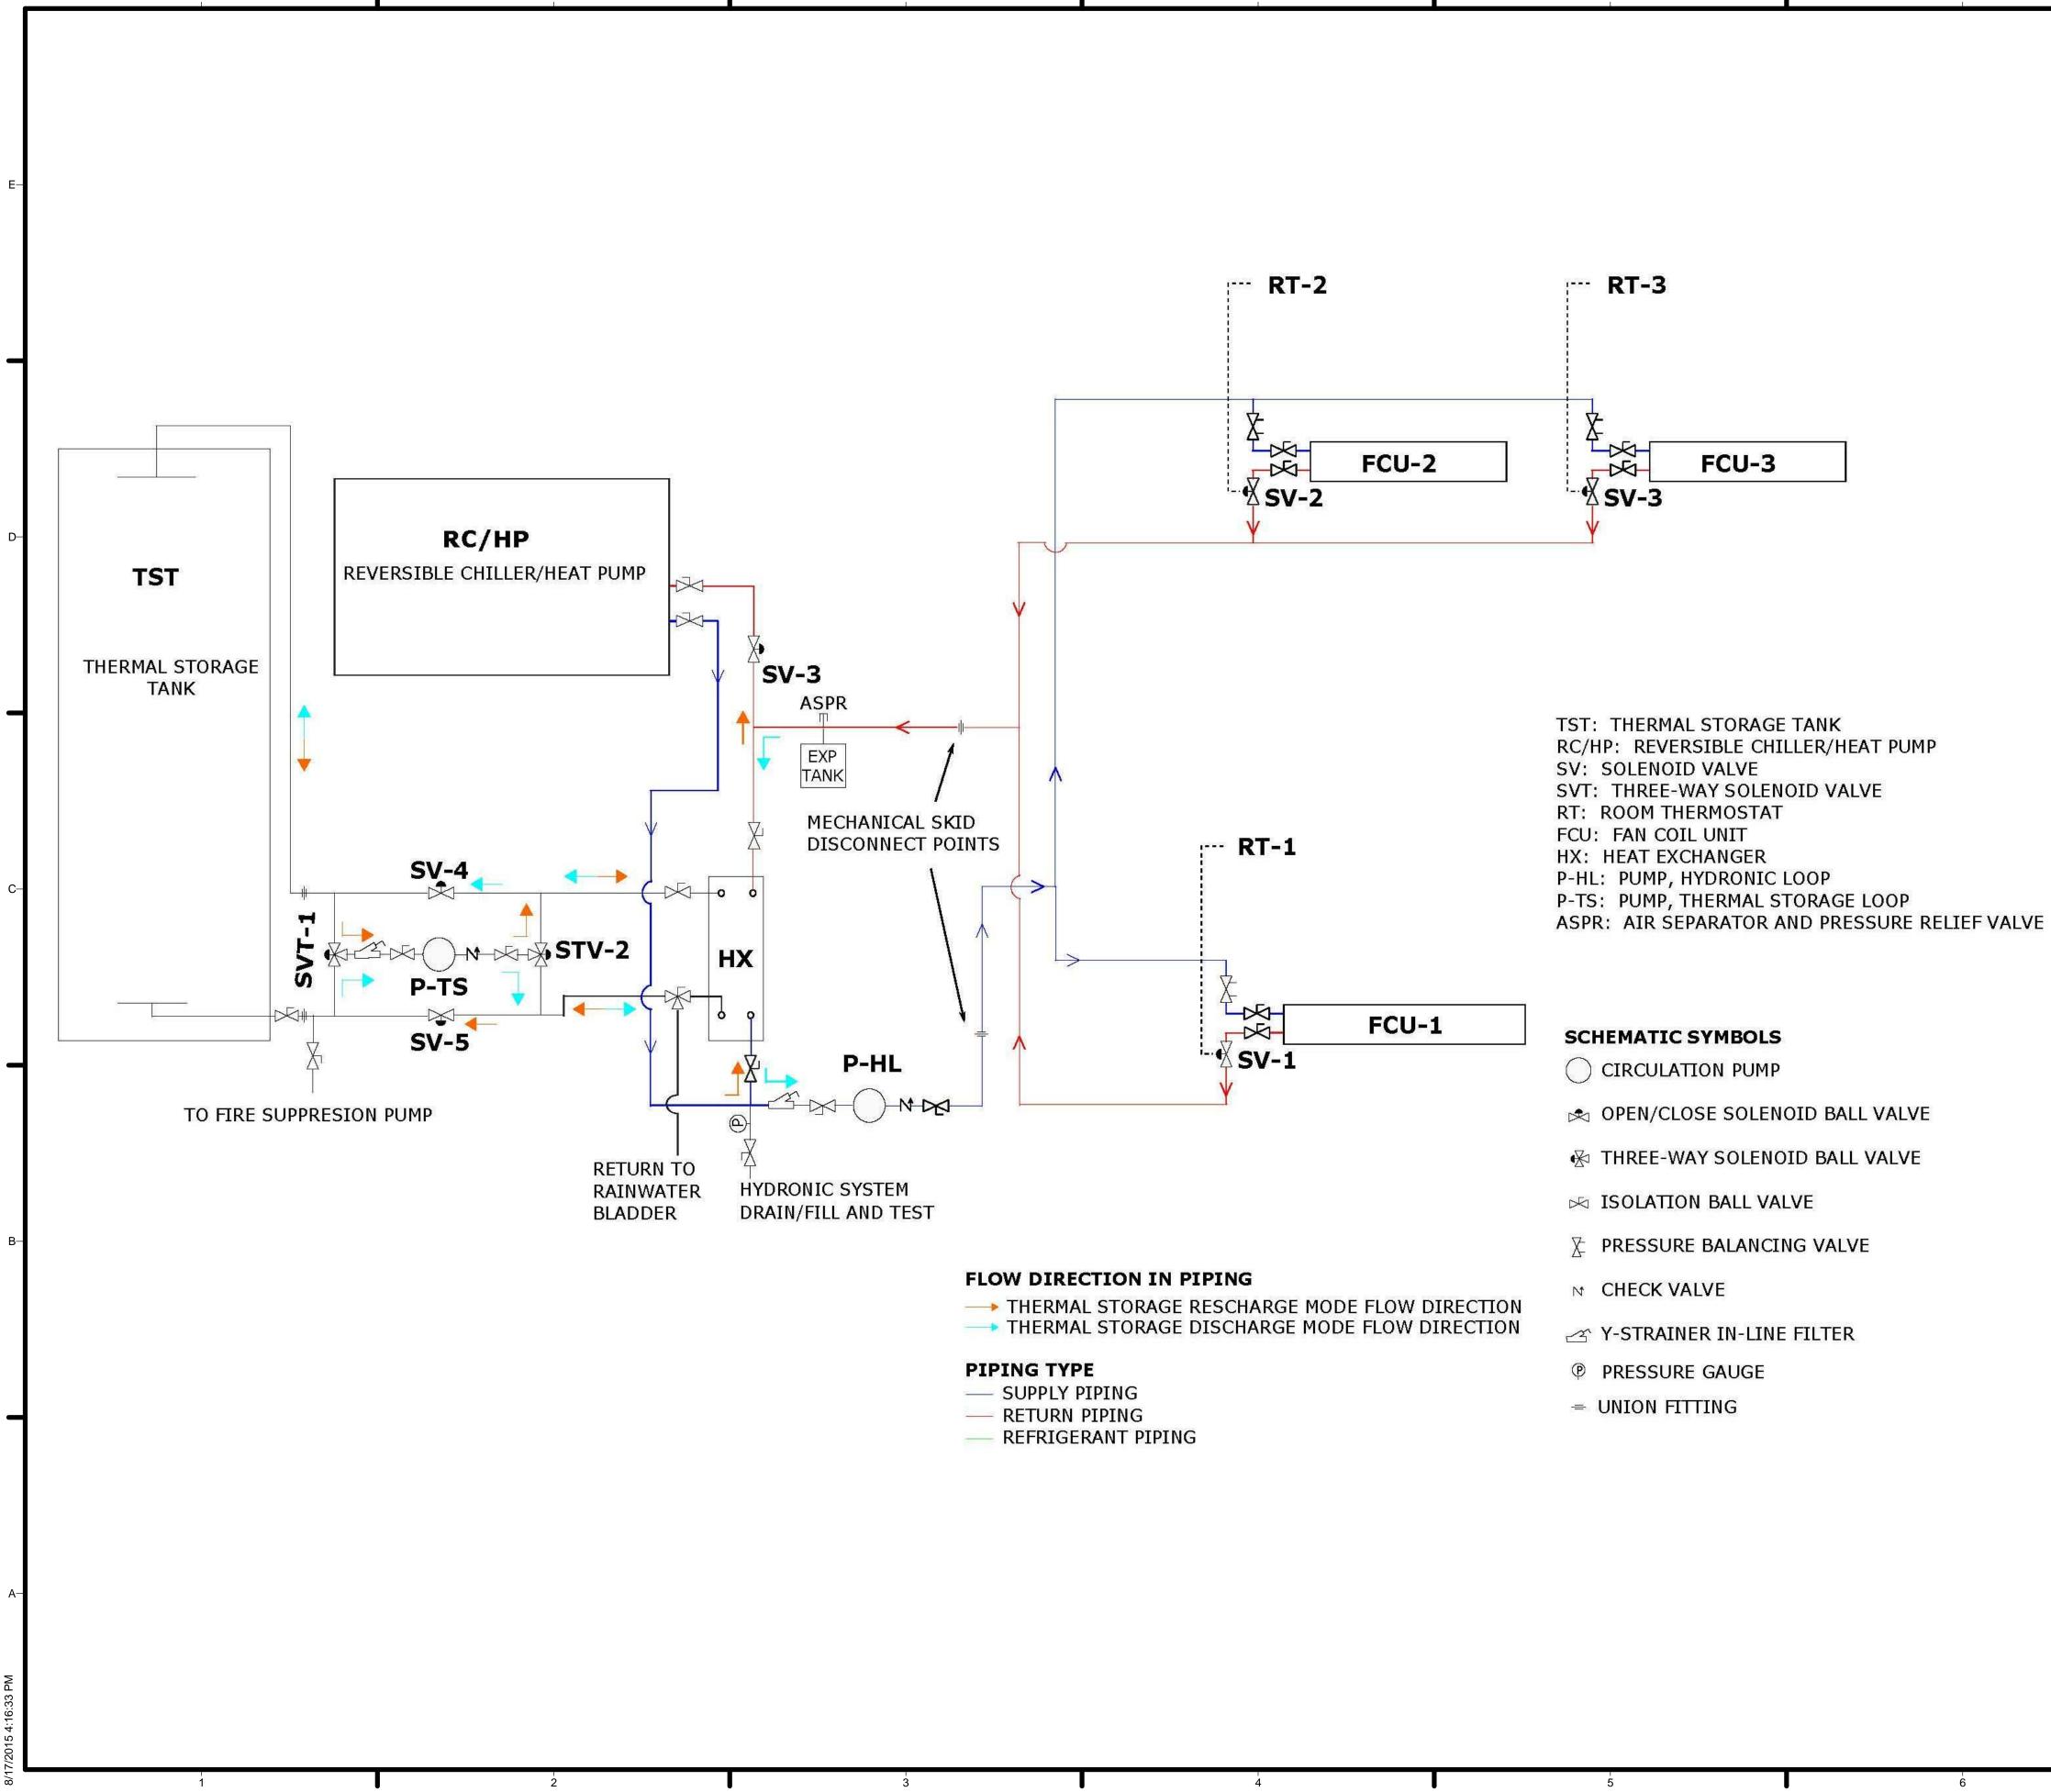
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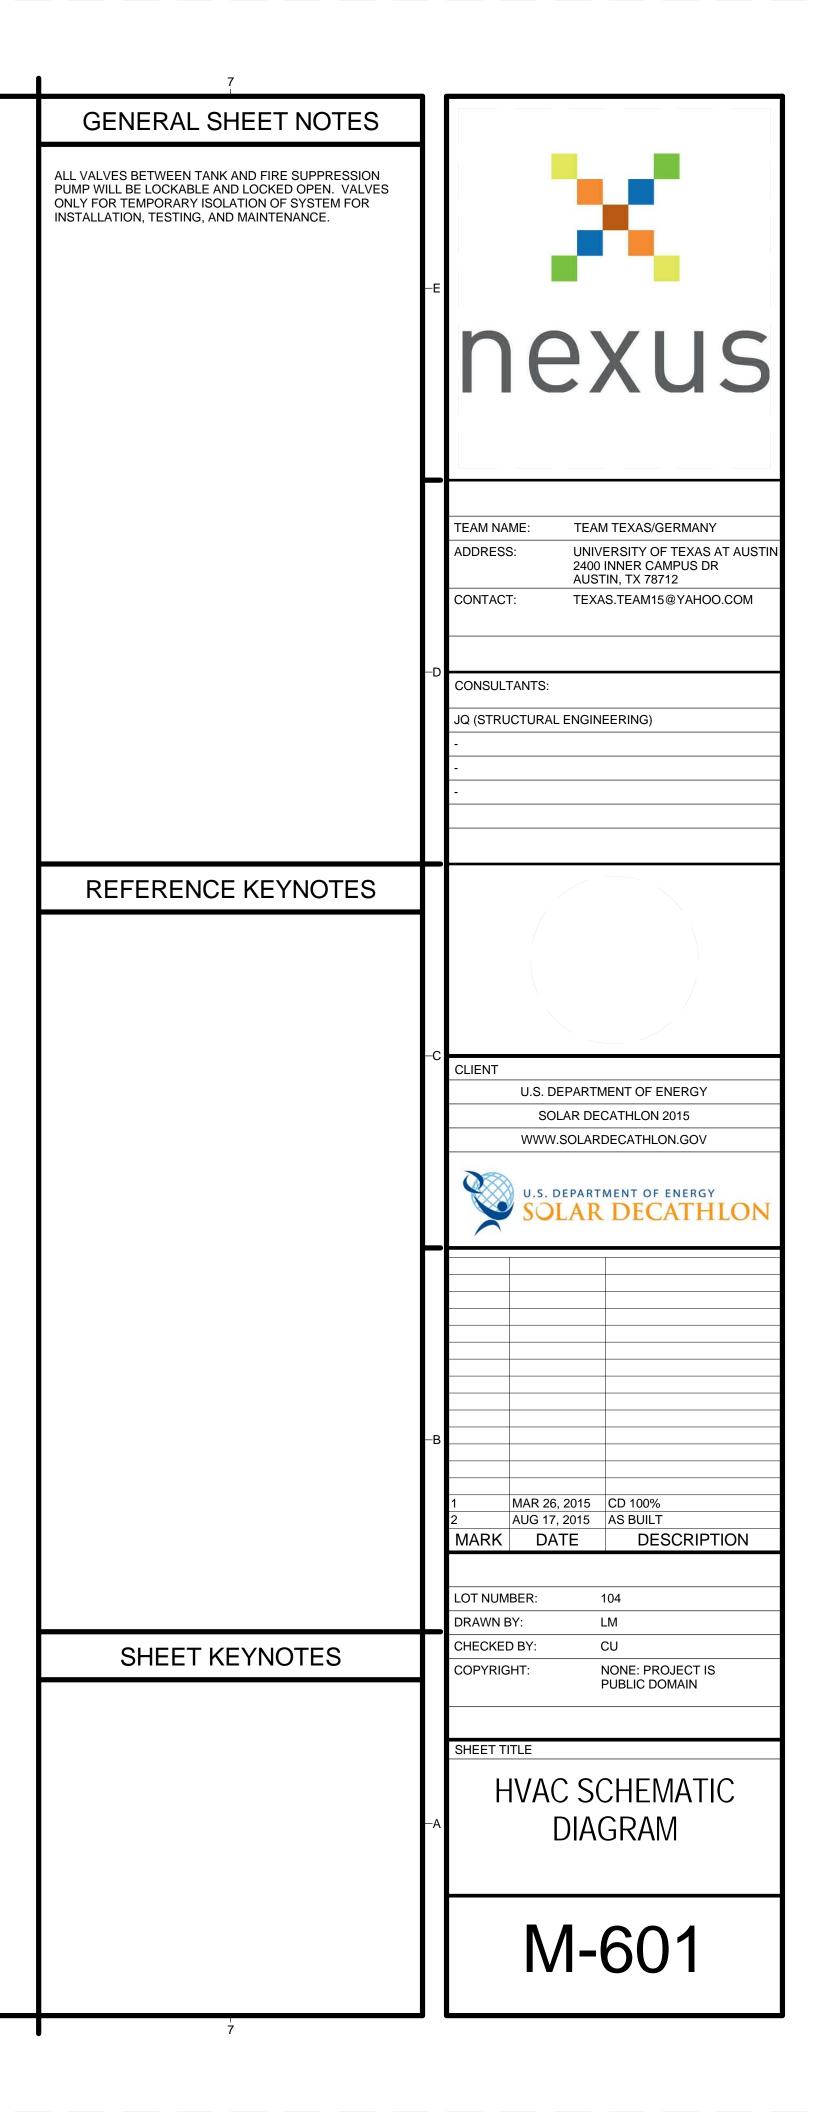
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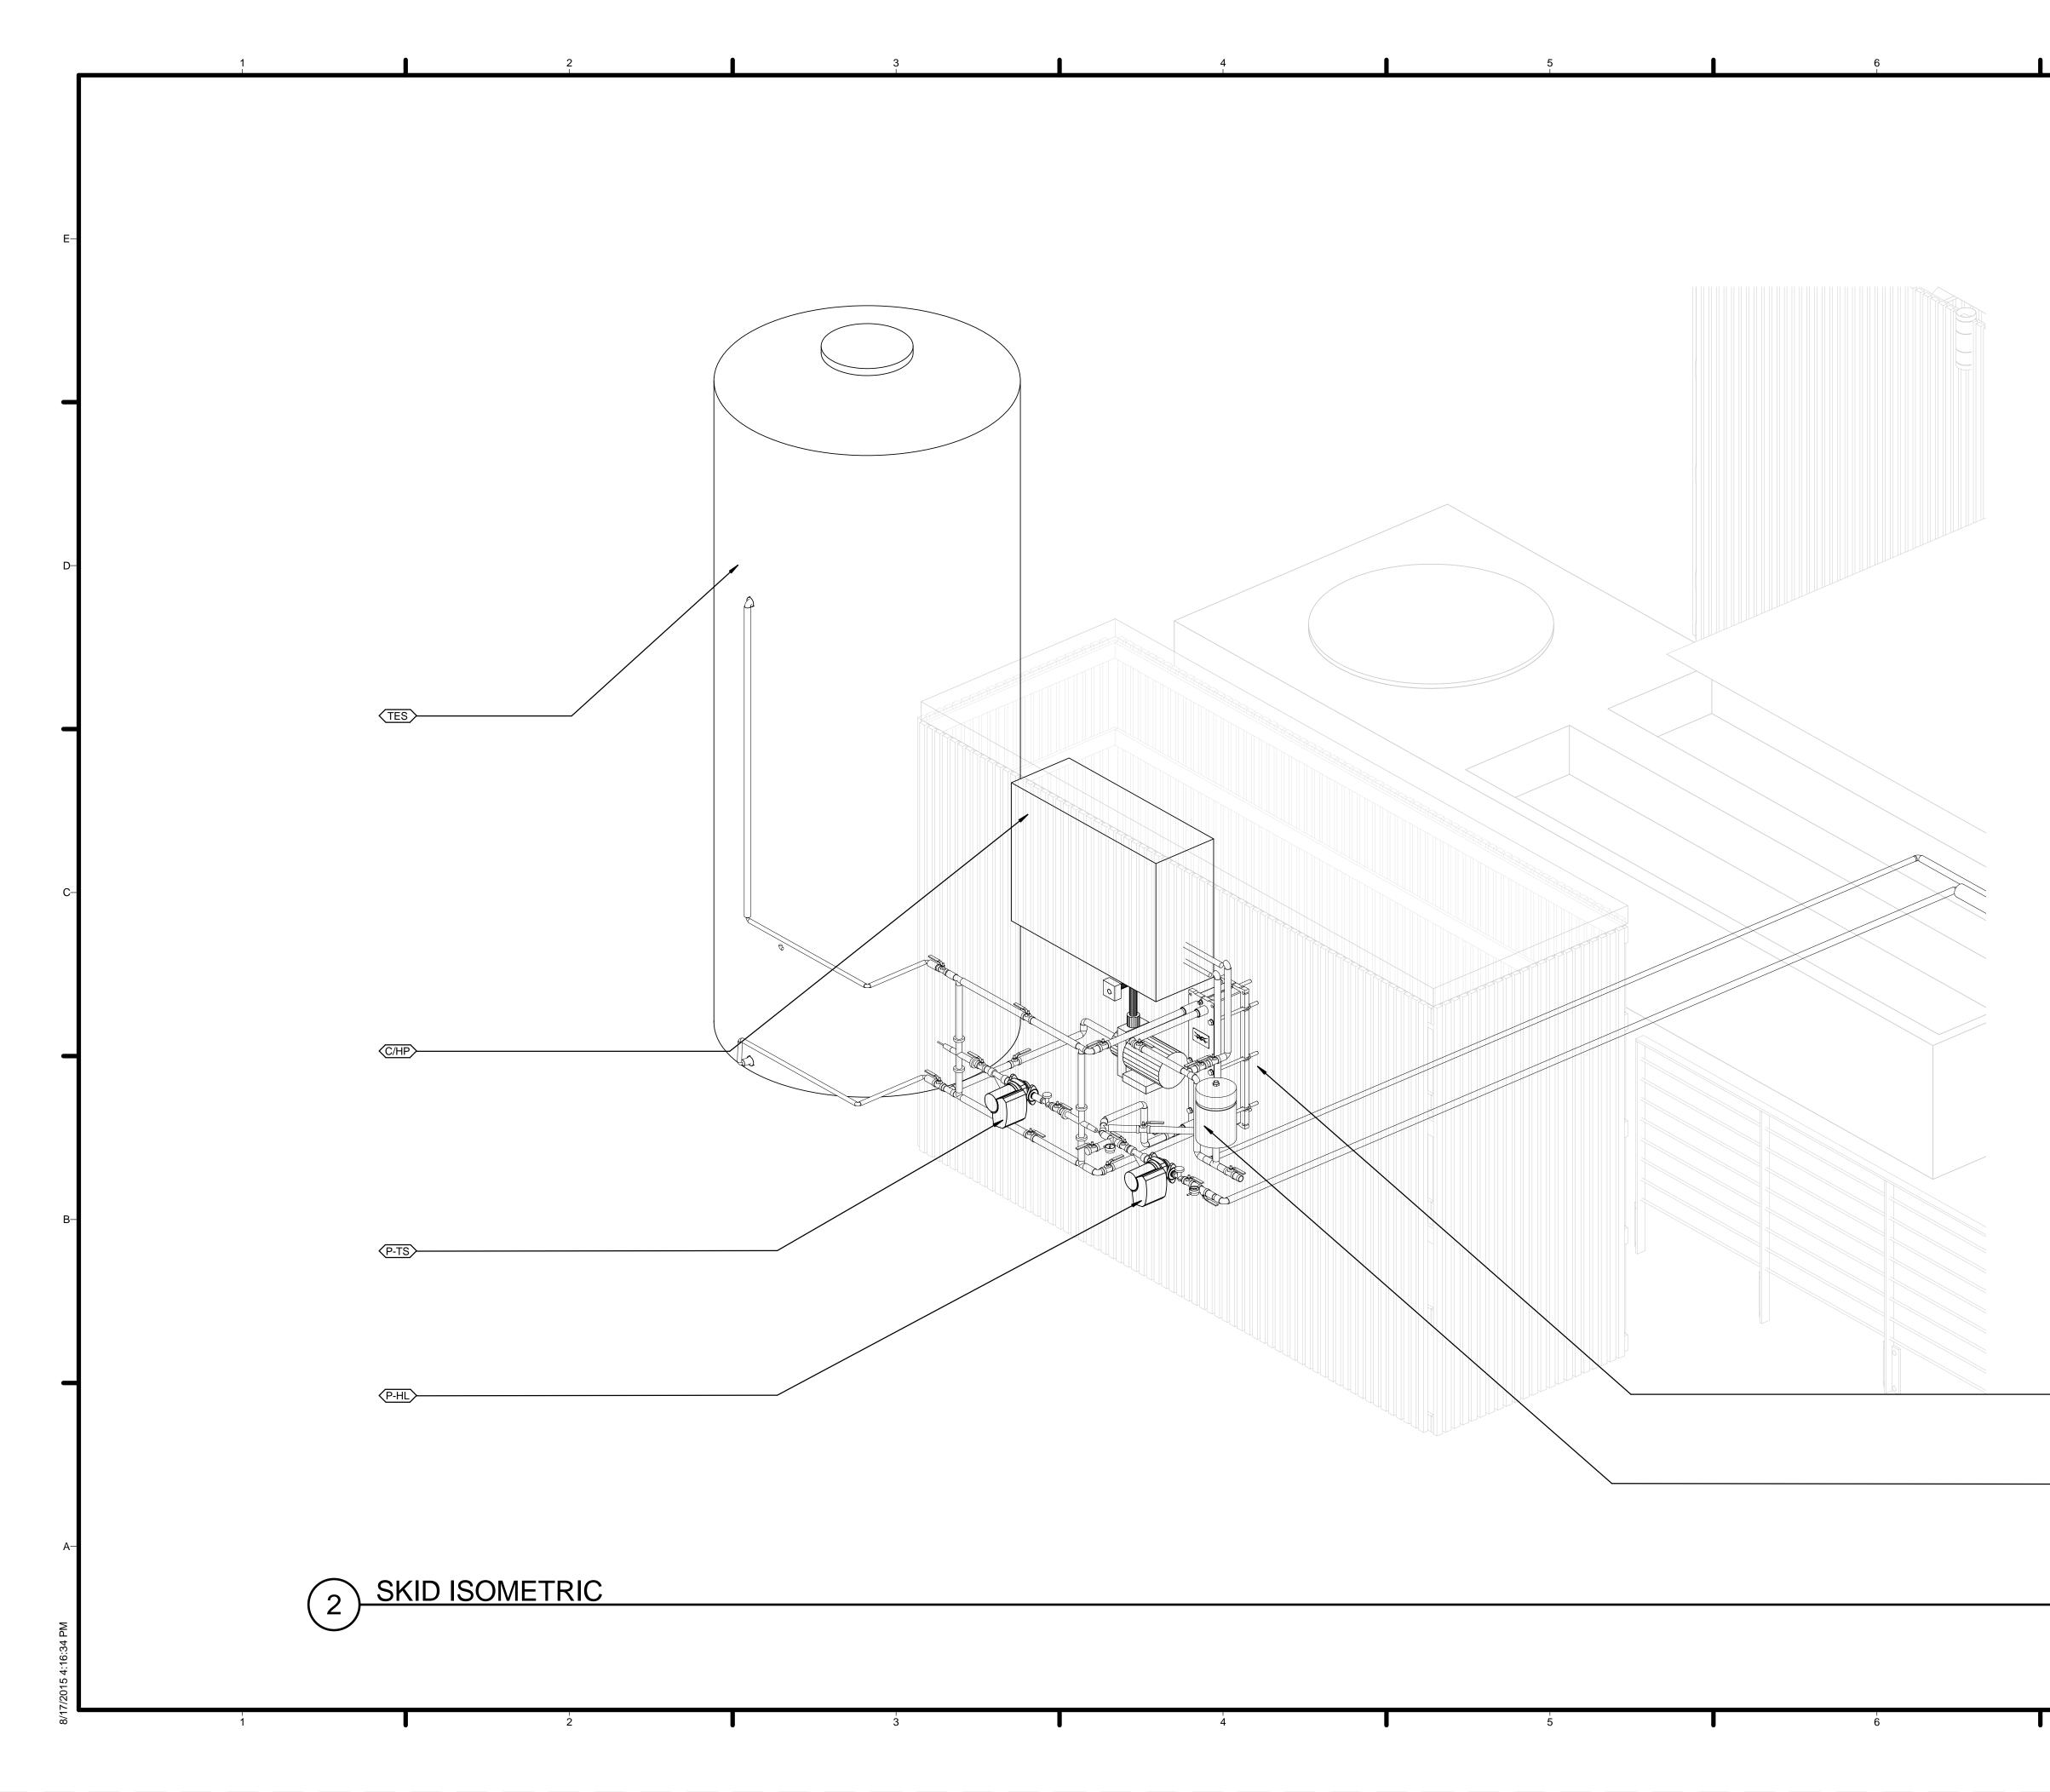


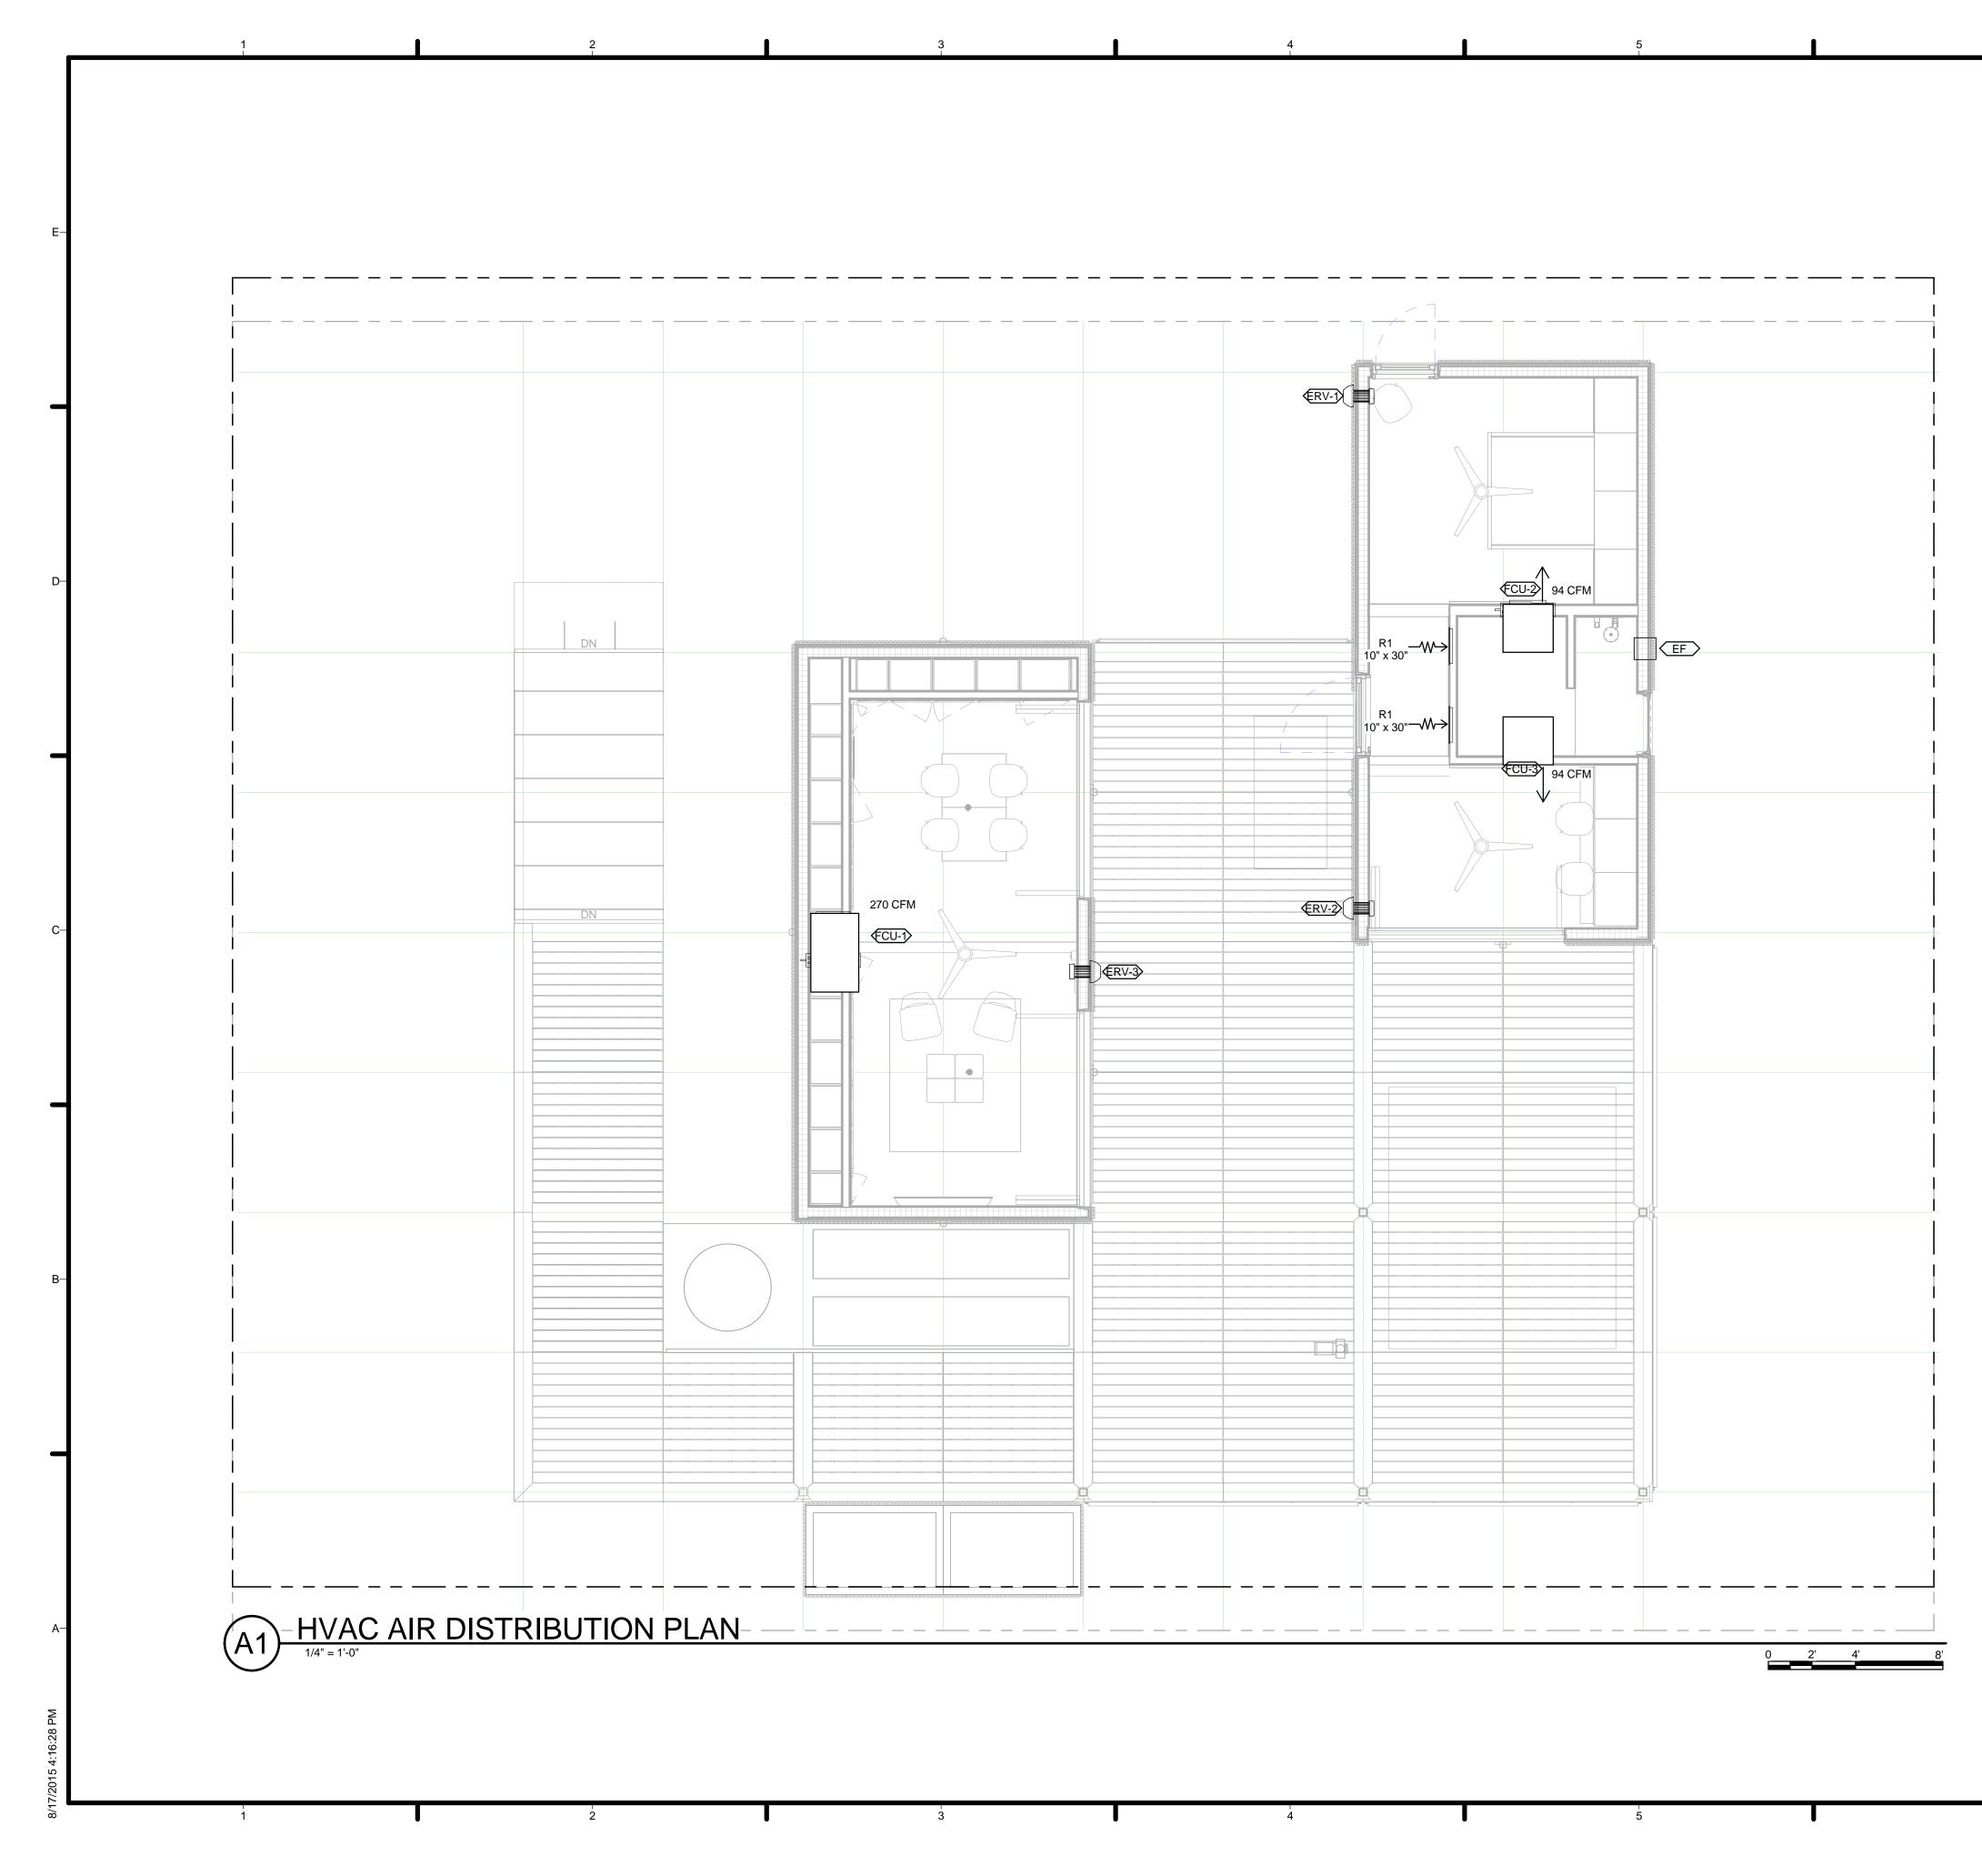

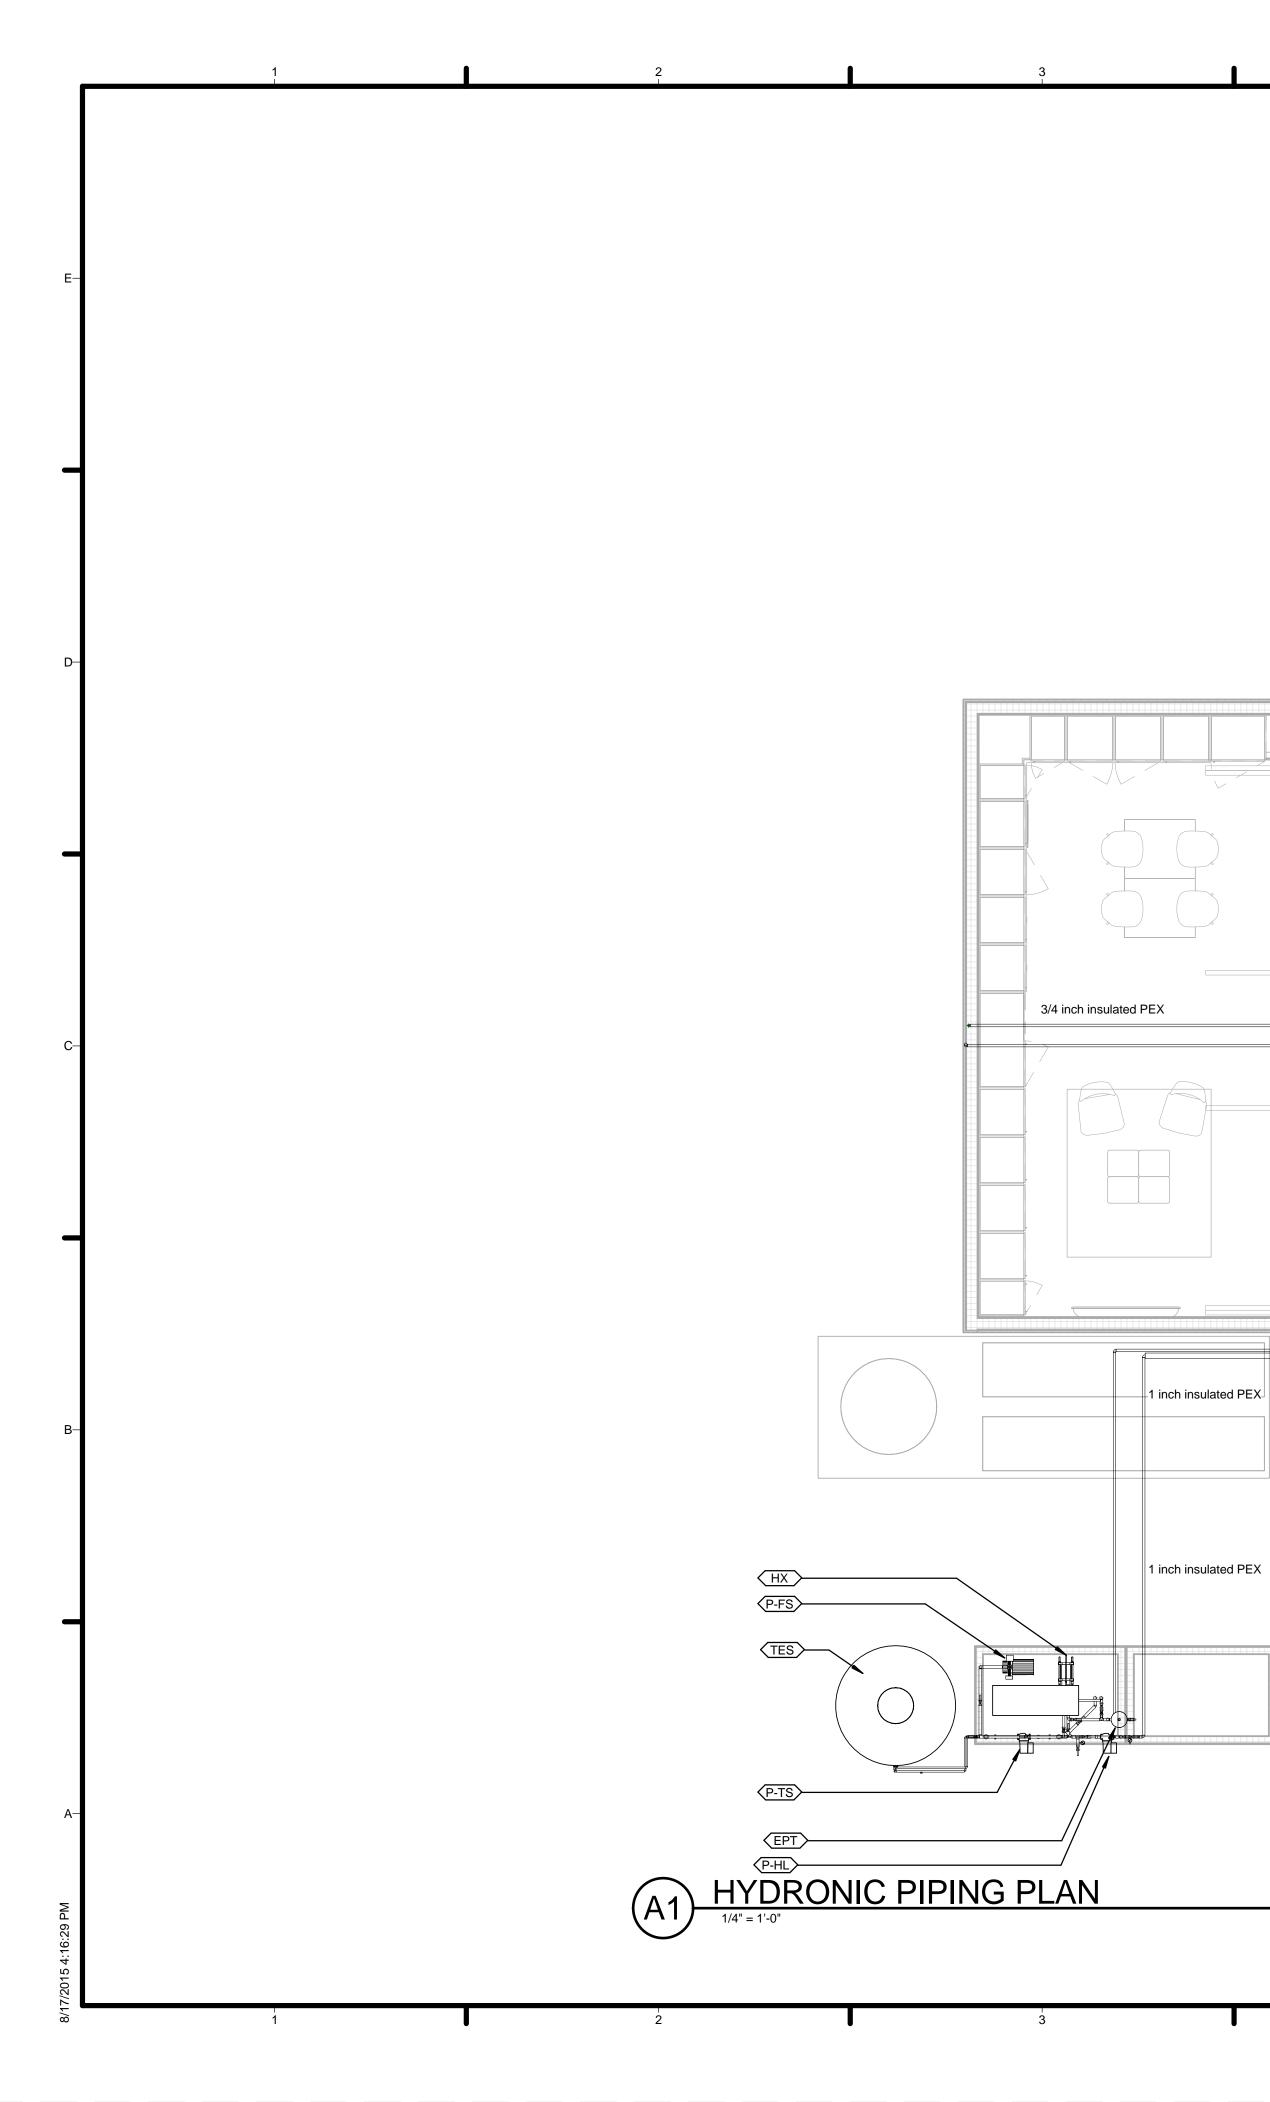

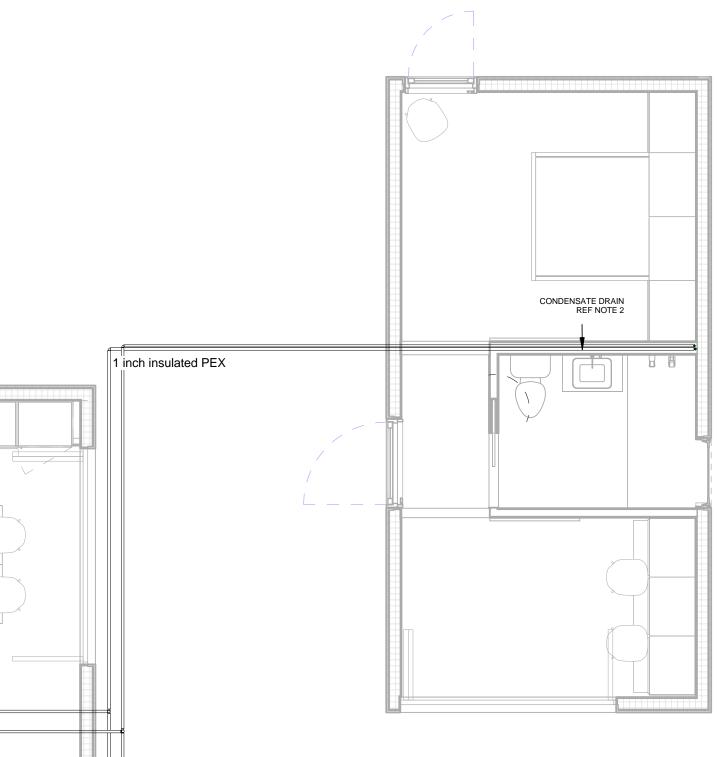



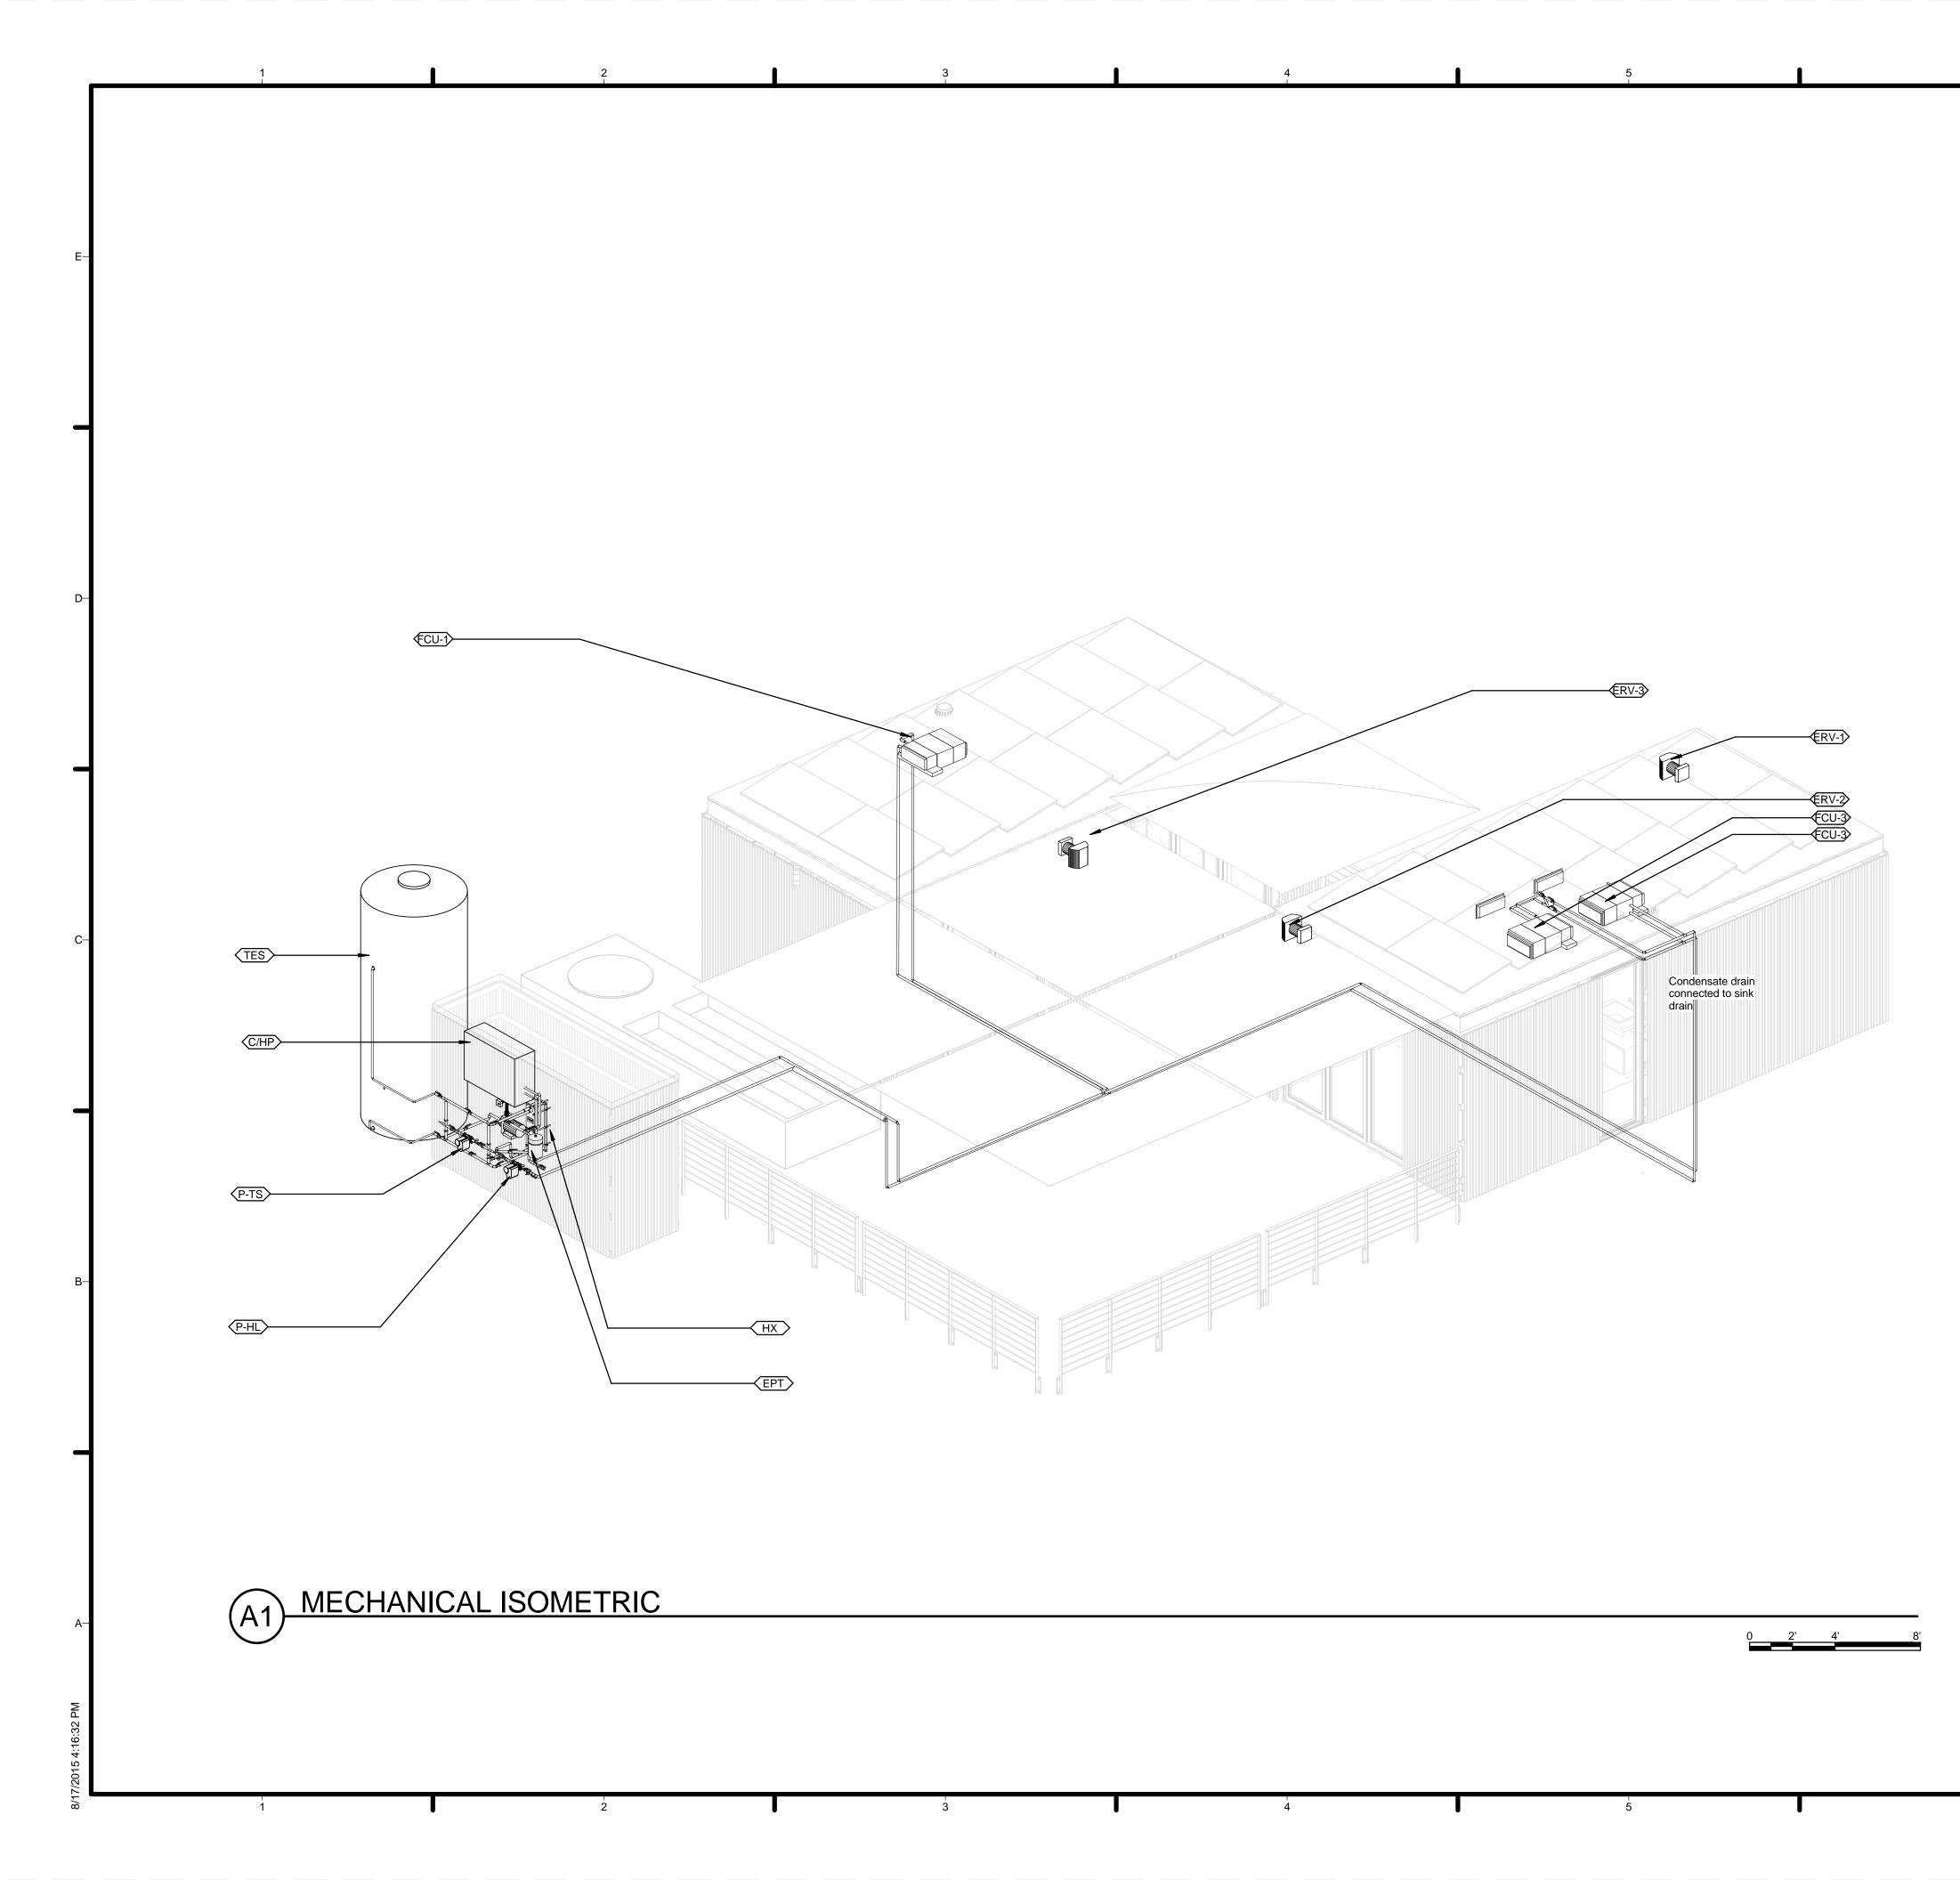

-E	nexus
	TEAM NAME: TEAM TEXAS/GERMANY ADDRESS: UNIVERSITY OF TEXAS AT AUSTIN 2400 INNER CAMPUS DR AUSTIN, TX 78712 CONTACT: TEXAS.TEAM15@YAHOO.COM
-D	CONSULTANTS: JQ (STRUCTURAL ENGINEERING) - - -
-c	CLIENT U.S. DEPARTMENT OF ENERGY SOLAR DECATHLON 2015 WWW.SOLARDECATHLON.GOV
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FPT >

	ABBREVIATIONS
НМ	Home Monitoring
DM	Dimmer
TV	Television
GEC	Grounding Electrodes Conductor
EC	Electrical Connection
I	Inverter
PV	Photovoltaic Panel
GFI	Ground Fault Interrumpter
SP	Sub Panel NOTE: reference Sub Panel schedule for detail
MP	Main Panel NOTE: reference Main Panel schedule for detail
WP	Weather Proof
EGC	Equipment Grounding Conductor
BMW	BMW Wallbox
MP	Electric Panel See panel schedule for specifications

ELECTRICAL LEGEND				
\$	SINGLE SWITCH			
\$3	THREE WAY SWITCH			
Φ	DUPLEX OUTLET			
ŧ	QUADRUPLUX OUTLET			
	GROUND FAULT INTERUPTER DUPLEX OUTLET			
₽GFI	GROUND FAULT INTERUPTER QUADRUPLUX OUTLET			
V	DISTRIBUTION PANEL			
DIST. PANEL	DISTRIBUTION PANEL			
\$	WALL-MOUNTED LIGHTING			
[]	UNDER CABINET LIGHTING			
	SCONCE			
\bigcirc	FAN VENT			
	CEILING FAN			
•	RAIL-MOUNTED LIGHTING			

2

Load Type

- 3

Lighting

Small App Bathroom Washer (W Dryer (T801

Cooking Oven (24" Cooktop (24)

Fixed Appli

Living room Bathroom Exhaust Ho Refrigerato Dishwashe

Car (BMW

Mechanical Thermal St Hydronic C Chiller/He Fire Pump HVAC Contr Heat Pump

Water Equip Rainwater Rainwater Greywater


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6

e	Load Value	Multiplier / Demand	Total [kVA]	
		manaprici / Demana	Total [KVA]	
	800 sq. ft x 3 VA =	8400 VA:		
	2.4 kVA			
	3 x 1500 VA =	3 kVA @ 100%	5.52	
pliance Circuit	4.5 kVA	8.4 kVA @ 35%		
n Circuit	1.5 kVA			
W3038)	1.8 kVA			
019CI)	5.76 kVA		5.76	
		Table 220.55		
' H6560 <mark>B</mark> Countour Line)	7.2 kVA	80%	5.76	
(24" KM 5850)	9.6 kVA	8 kW max	8	
liances				
om Fan Coil	0.18 kVA		0.18	
n Fan Coil	0.228 kVA		0.228	
lood (24" DA 3460)	1.8 kVA	3 appliances	1.44	
tor and Freezer (30" KF 1801SF)	1.8 kVA	@ 75%	1.44	
her (Futura Classic G 4225)	1.8 kVA	ردر <u>ه</u>	1.44	
/ i6)	3.84 kVA		3.84	
al				
Storage Pump	0.345 kVA		0.35	
Circ Pump	0.46 kVA		0.46	
eat Pump Unit	2.88 kVA		2.88	
o (Largest Motor)	2.4 kVA	125%	3.00	
troller	0.18 kVA		0.18	
ip Water Heater	5.29 kVA		5.29	
unmant				
<mark>lipment</mark> er Treatment	0.10 500		0.10	
	0.12 kVA		0.12	
er Pump	1.2 kVA		1.2	
er equipment (under Nexus):	0.46 kVA	Tatal	0.46	1.379
		Total Amps	47.54 198.10	kVA kVA




	L							1					
					Elec	tric Panel	Schedule						
					Panel: Squa	are D by So	hneider E	Electric					
					Fed From	n: Organize	ers Micro-	Grid					
						ocation: G							
					Bus Amps: 20	-		o 400 A)					
						oltage: 12							
	1				1 P	hase. 3 Wi	re + GND	1		1		1	
Pole	AWG Size	Trip [A]	Туре	Material	Load Description	#	#	Load Description	Material	Туре	Trip [A]	AWG Size	Pole
1	. 12	25	THWN	Copper	Bedroom Receptacles	1	2	Junction Box (Indoor)	Copper	THWN	25	12	2
1	. 12	25	THWN	Copper	Lighting and Fans	3	4						
1	. 12	25	THWN	Copper	Smoke and Heat Detectors	5	6	Refrigerator	Copper	THWN	25	12	1
2	12	18.75	THWN	Copper	Washer	7	8	SUBPANEL	Copper				2
-				-		-	10						-
2	8	37.5	THWN	Copper	Dryer	11	12	Cooktop	Copper	THWN	50	8	2
-						-	-				-		
2	8	40	THWN	Copper	Car	15	16	Oven	Copper	THWN	40	8	2
-						-	-				-		
1	. 12	25	THWN	Copper		19	20	Exhaust	Copper	THWN	18.75	12	1
2	12	25	THWN	Copper	Junction Box (Outdoor)	21	22	Water Heater	Copper	THWN	40		
-				-	-	23	24	Bathroom Receptacles		THWN	25		
1				SPARE		25	26	Kitchen Receptacles	Copper	THWN	25	12	1


	Photovoltaic Calculations					
Details	City	October	Year	(DC)	inverter	k١
Tilt: 7.13° (1.5 to 12); Azimuth: 188°. DC to AC Derate Factor: 0.87	Austin	744 W(AC)	9228 W(AC)	6.3	0.87	
(Calculated with NREL PVWatts)	Irvine	712 W(AC)	9643 W(AC)			

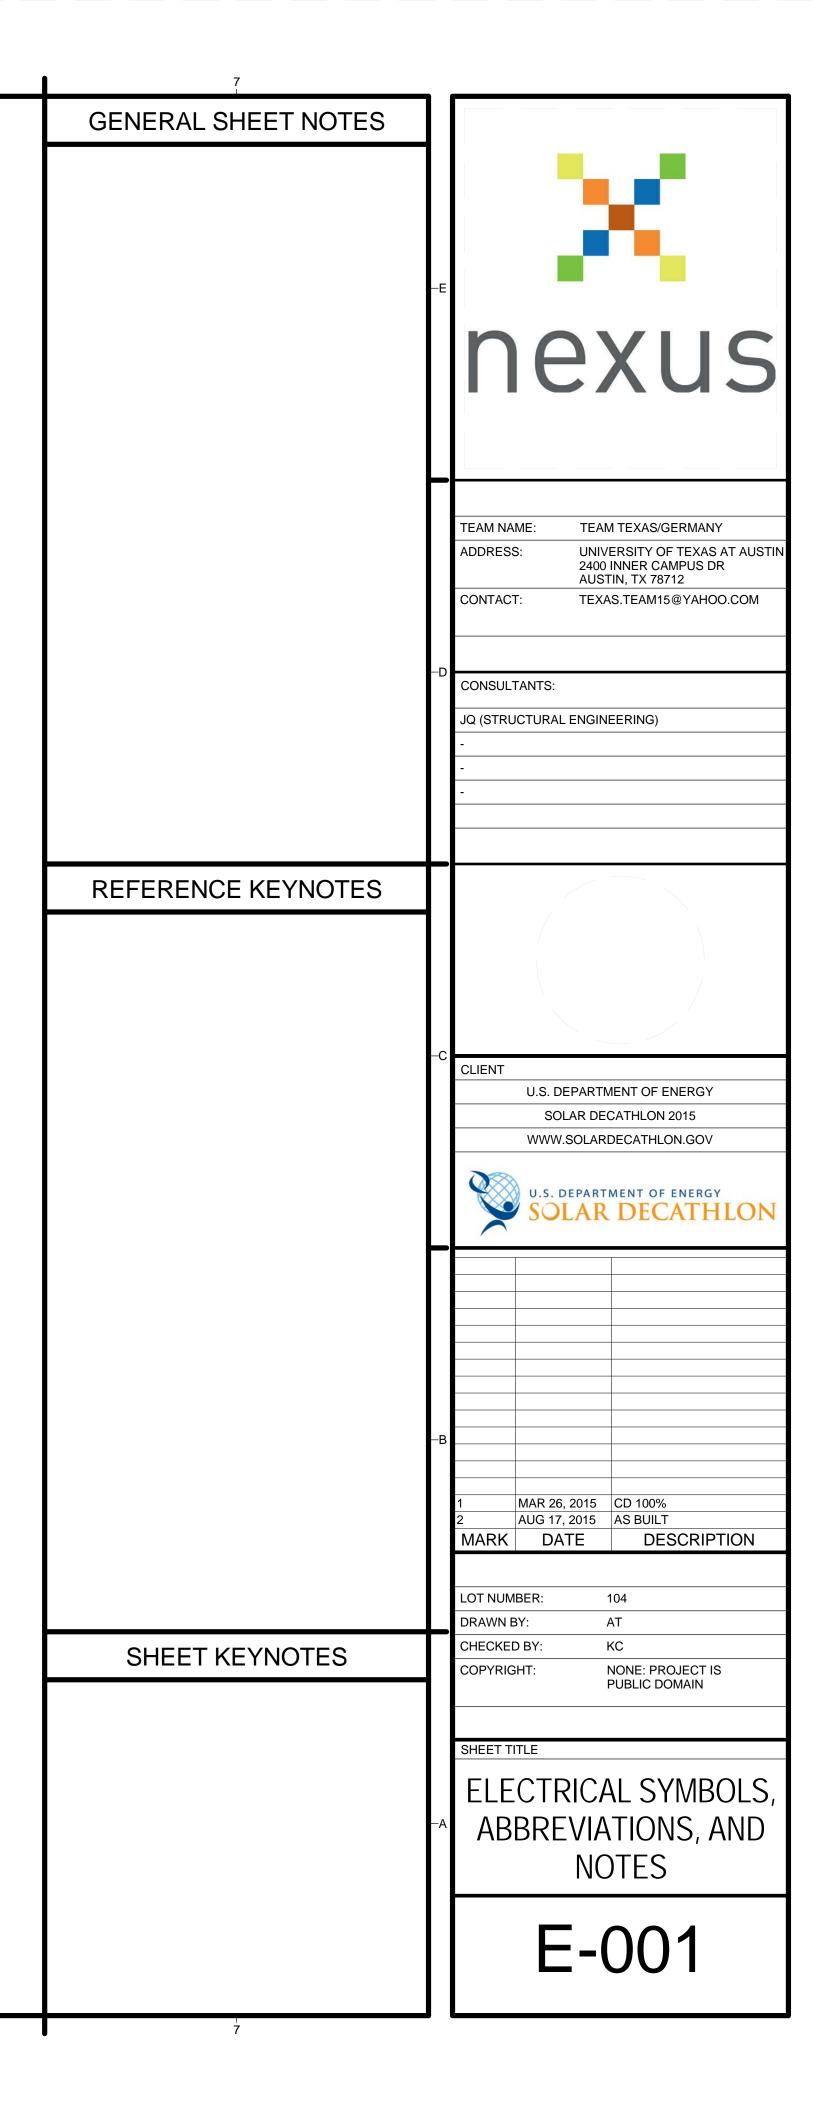
			Specificat	tions		
Photovoltaic M	Iodule	Micro-Inverter:	DC to AC derate f	factor is 0.87		
Brand	1SolTech	Brand	Enphase			
Model	1STH-250	Model	M250			
V(oc)	37.3	INPUT		OUTPUT	208VAC	240VAc
l(sc)	8.66	Max. P(input)	210-300W	Cont. Max P(output)	240W	240W
V(mpp)	30.7	Max. V(input)	48V	Nom. I(output)	1.15A	1A
I(mpp)		Max. I(input)	15A		208- 183-229V	240/ 211-264V
P(max)		Vmpp	27V		60Hz	60Hz
. (Impp	10A		57-61Hz	57-61Hz


	Electric Panel Schedule							
		Panel:	Square D b	y Schneide	r Electric			
	F	ed from: M	ain Service	Panel (8 an	nd 10 breakers)			
		Lo	ocation: Be	droom Hall	way			
			Bus Am	nps: 100A				
			Voltage	: 120/240				
			1 Phase. 3	Wire + GN	D			
Pole	AWG Size	Trip [A]	Туре	Material	Load Description	#		
1	12	25	THWN	Copper	Home Monitoring	s1		
1	12	25	AFCI	Copper	Lights in Module 2	s2		
1	12	25	AFCI	Copper	Sensors	s3		
2	12	25	THWN	Copper	Outdoor Receptacles	s4		


kWpeak (AC 5.481

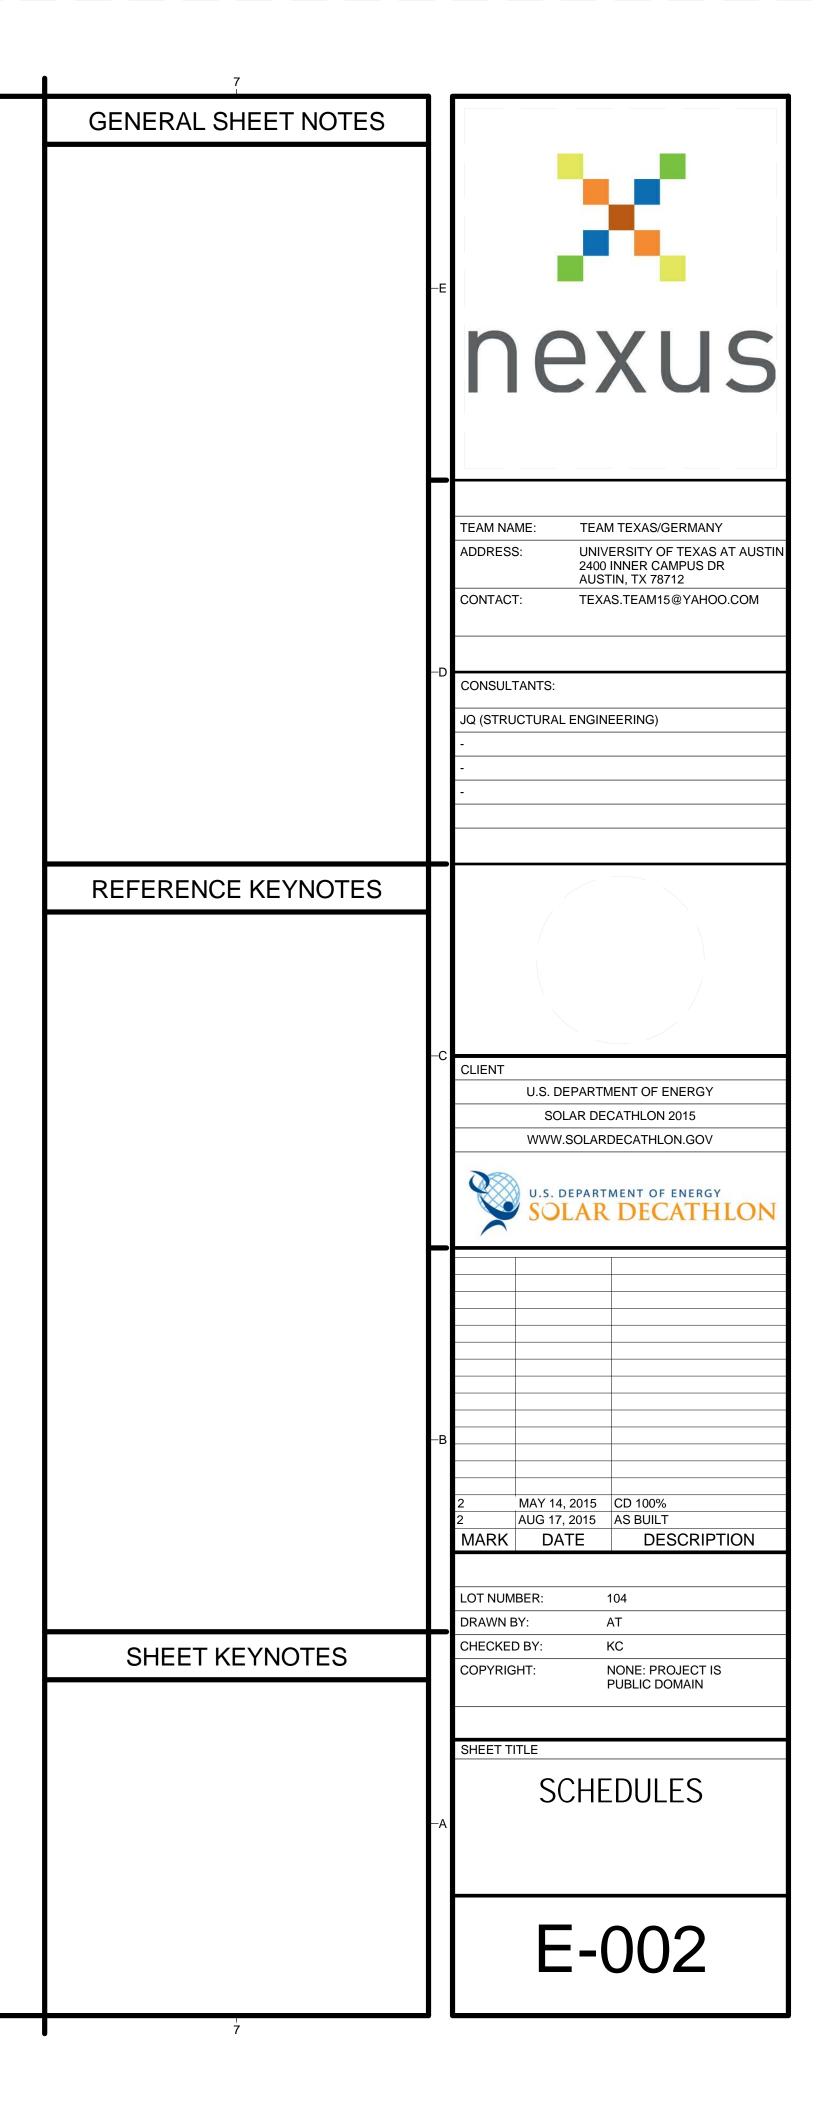

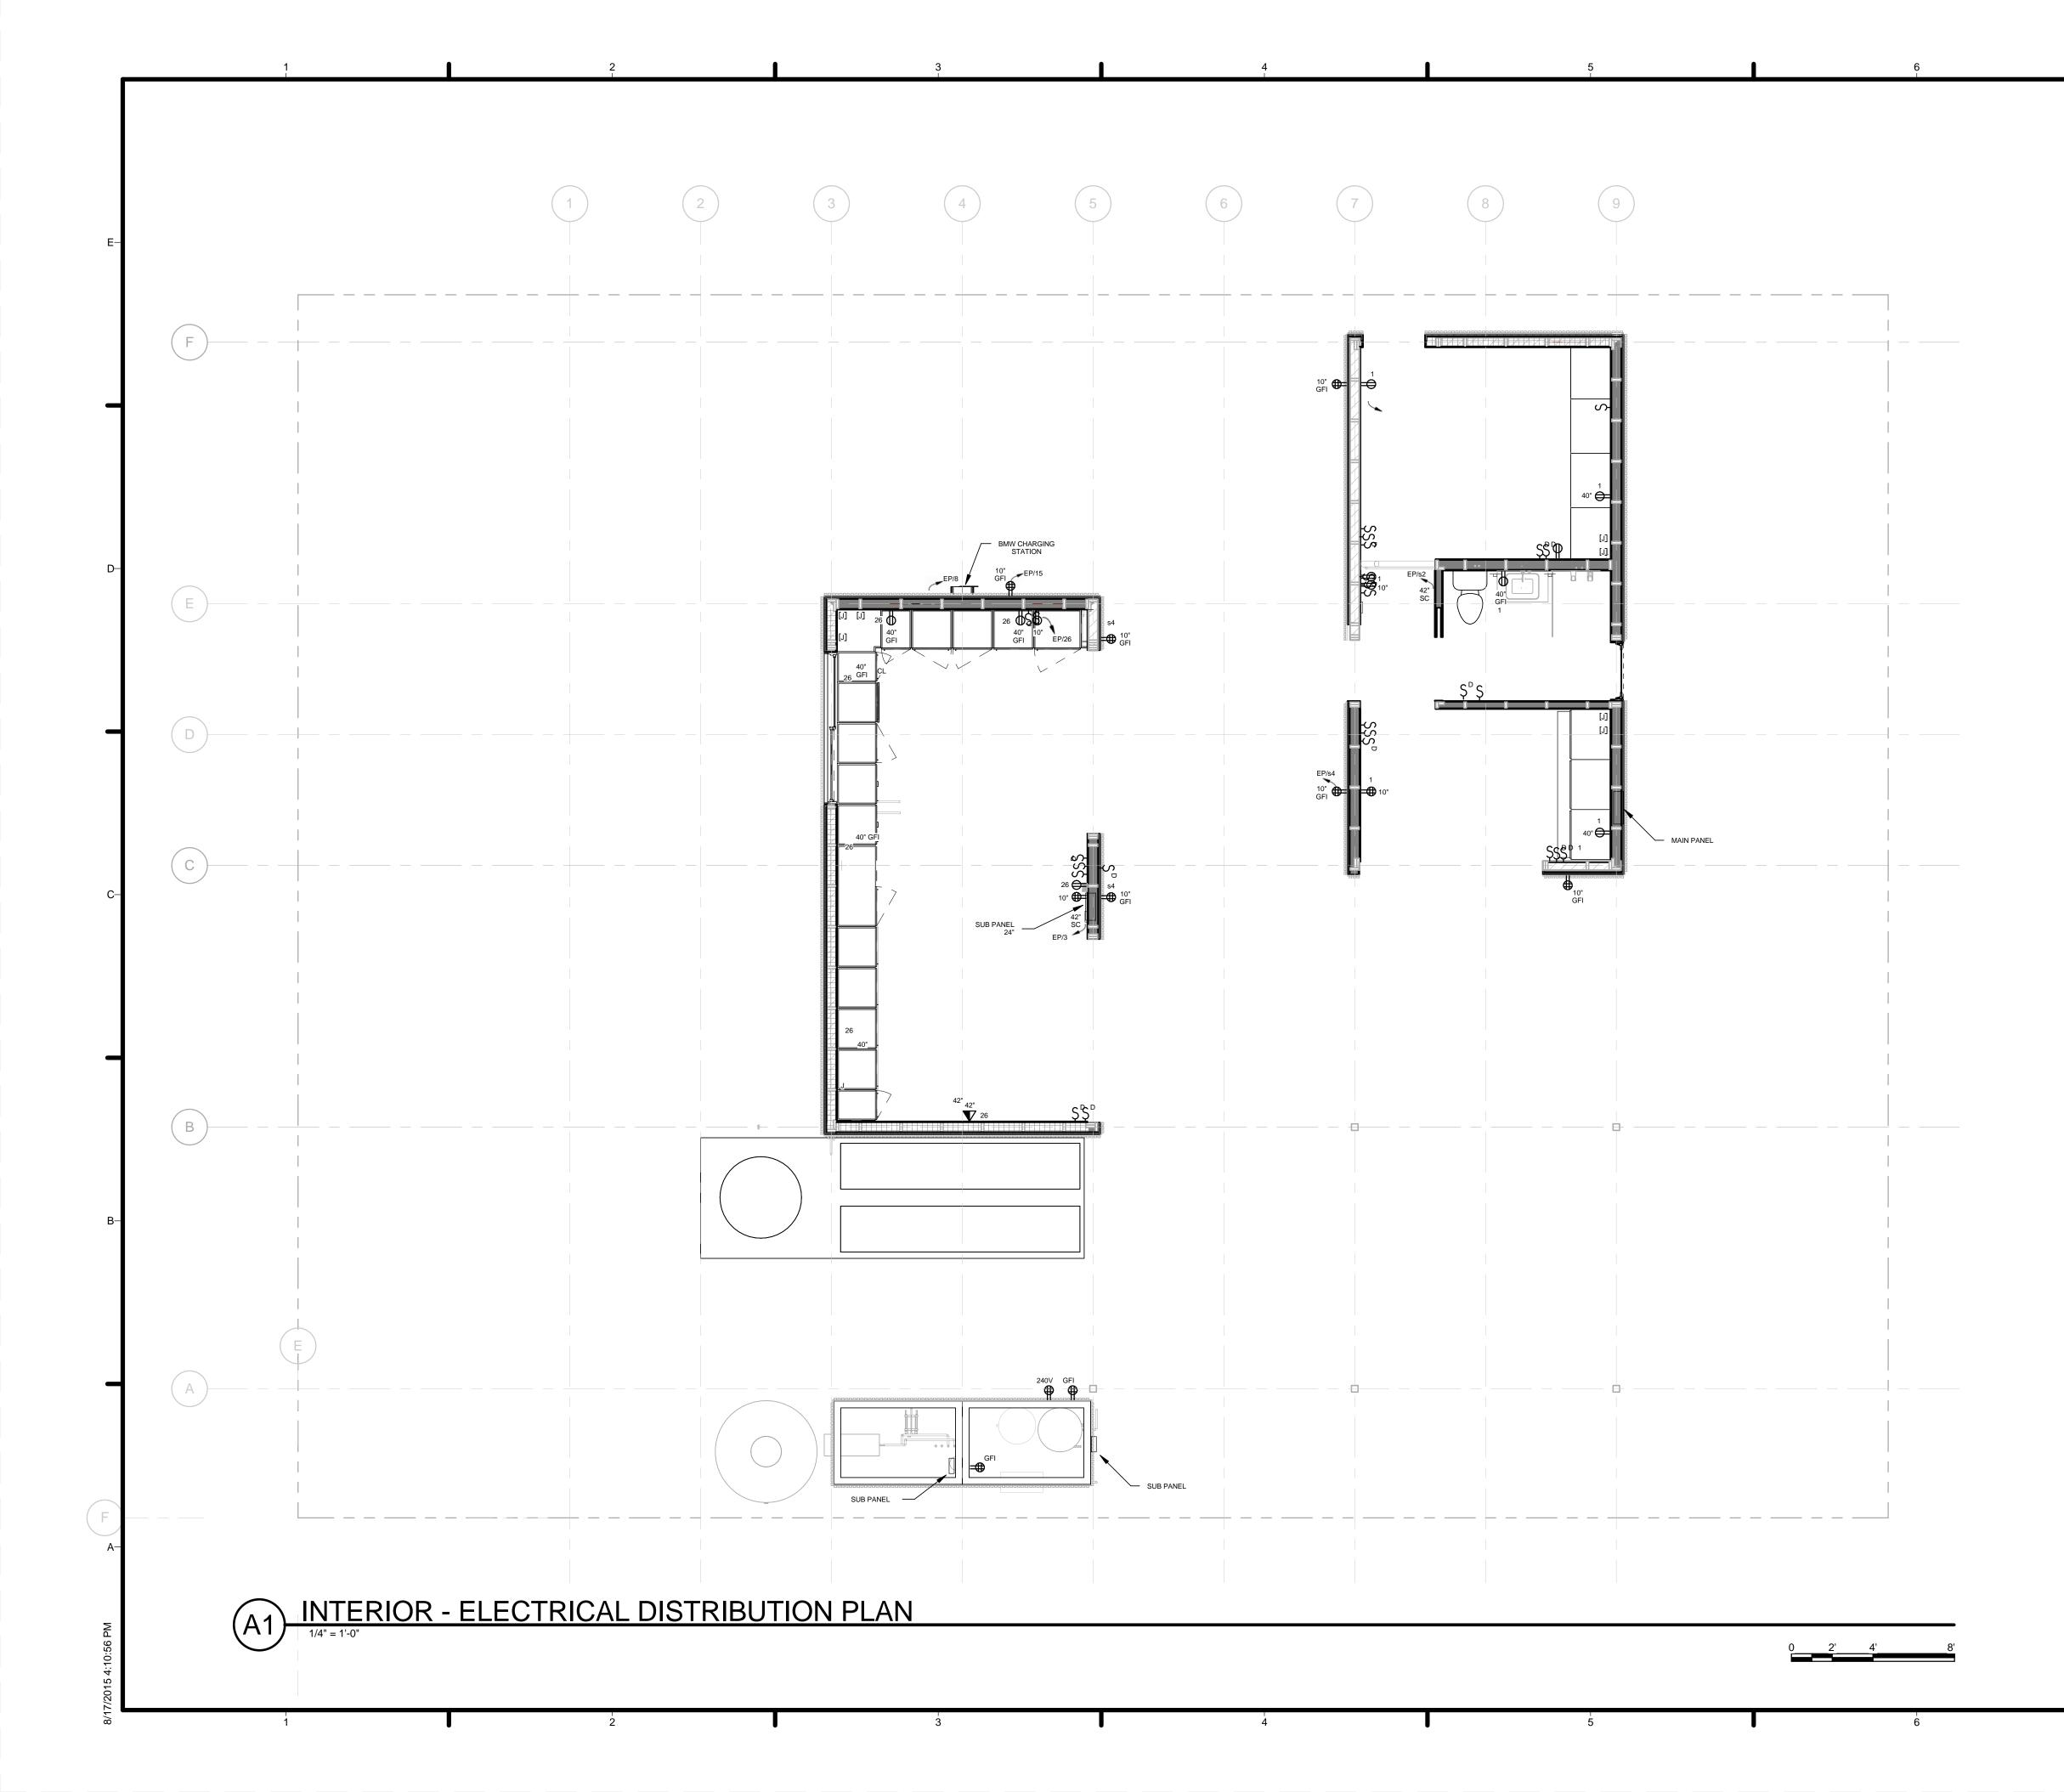

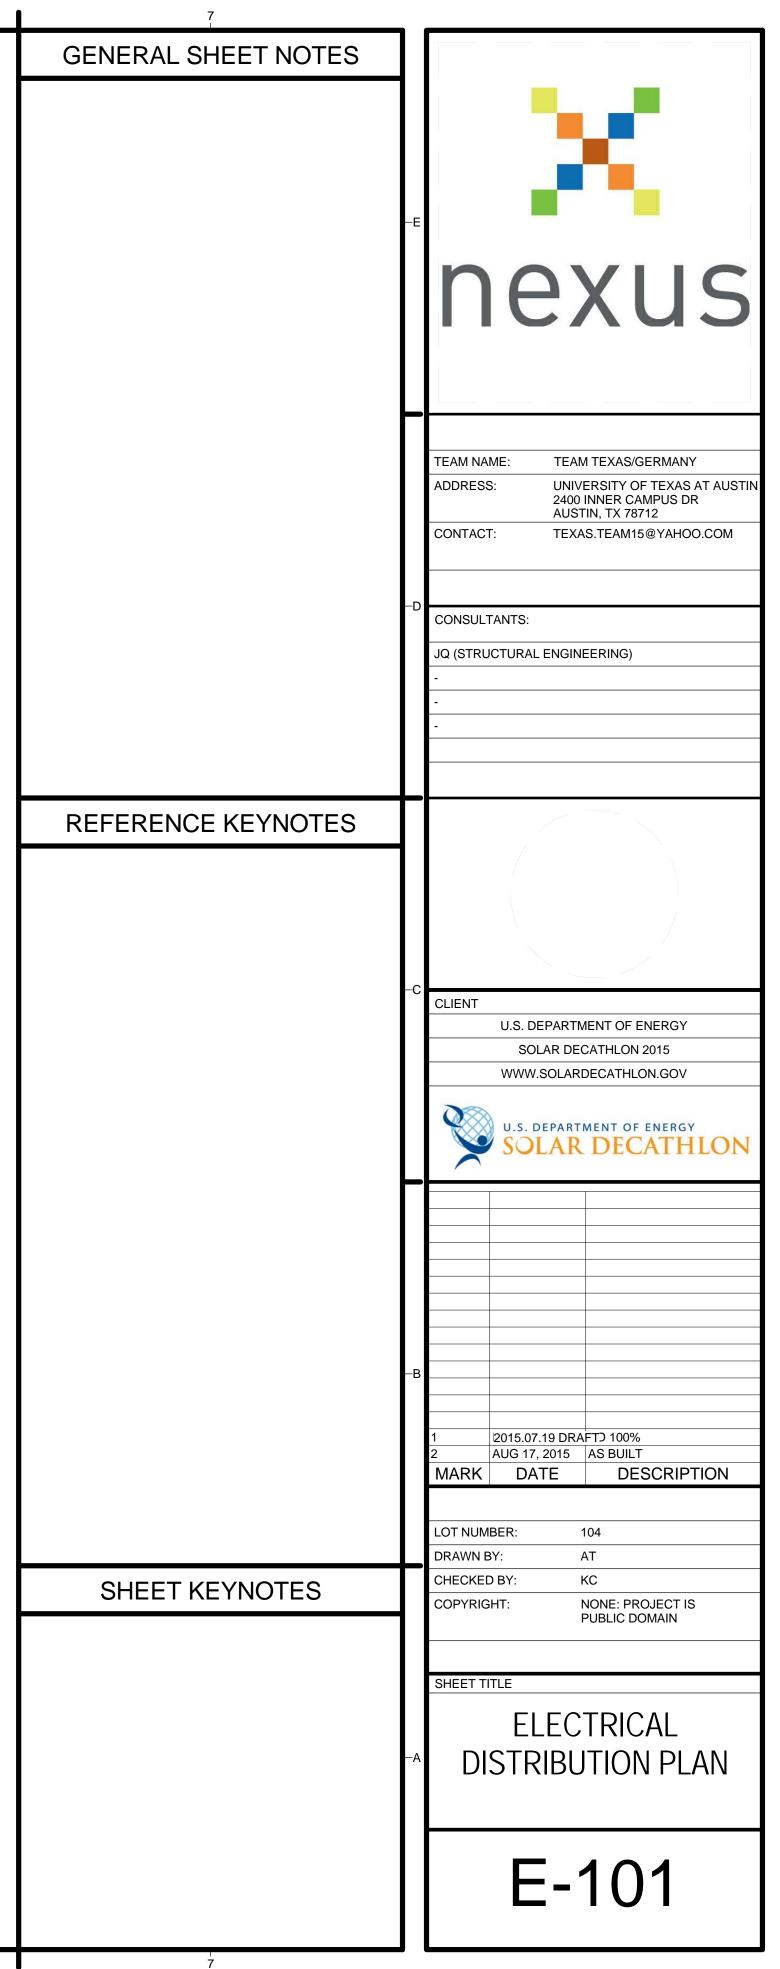


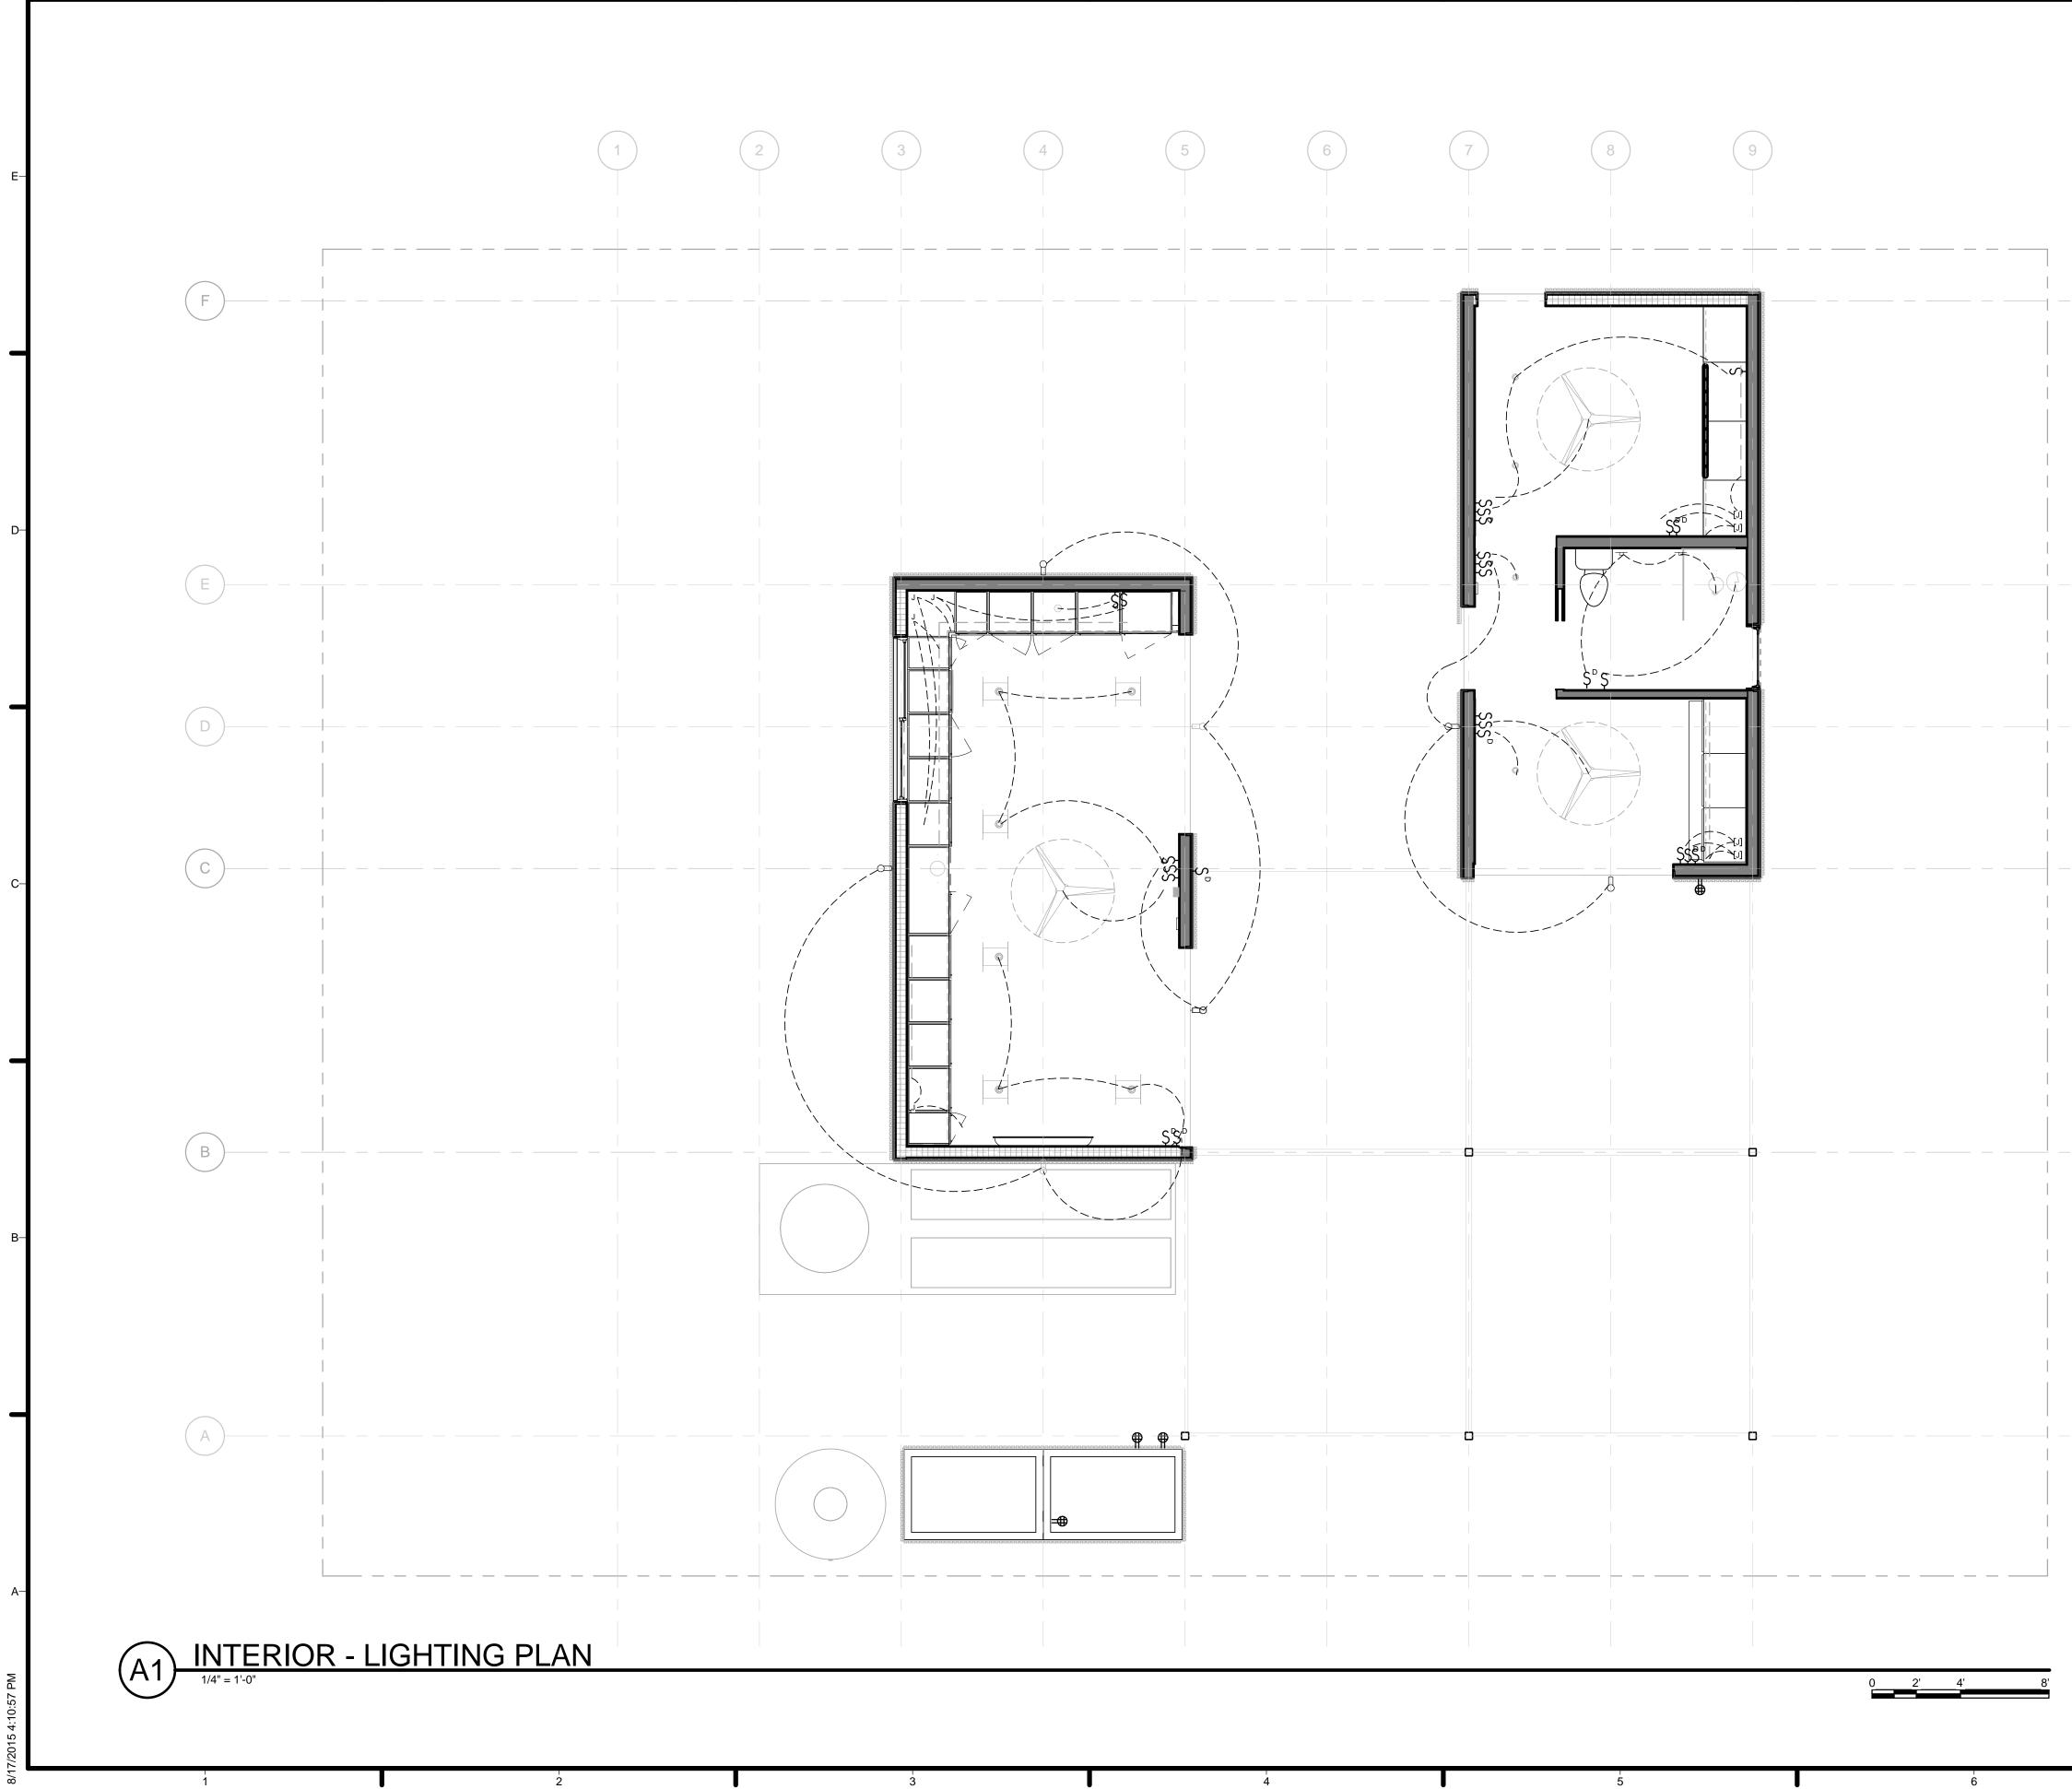

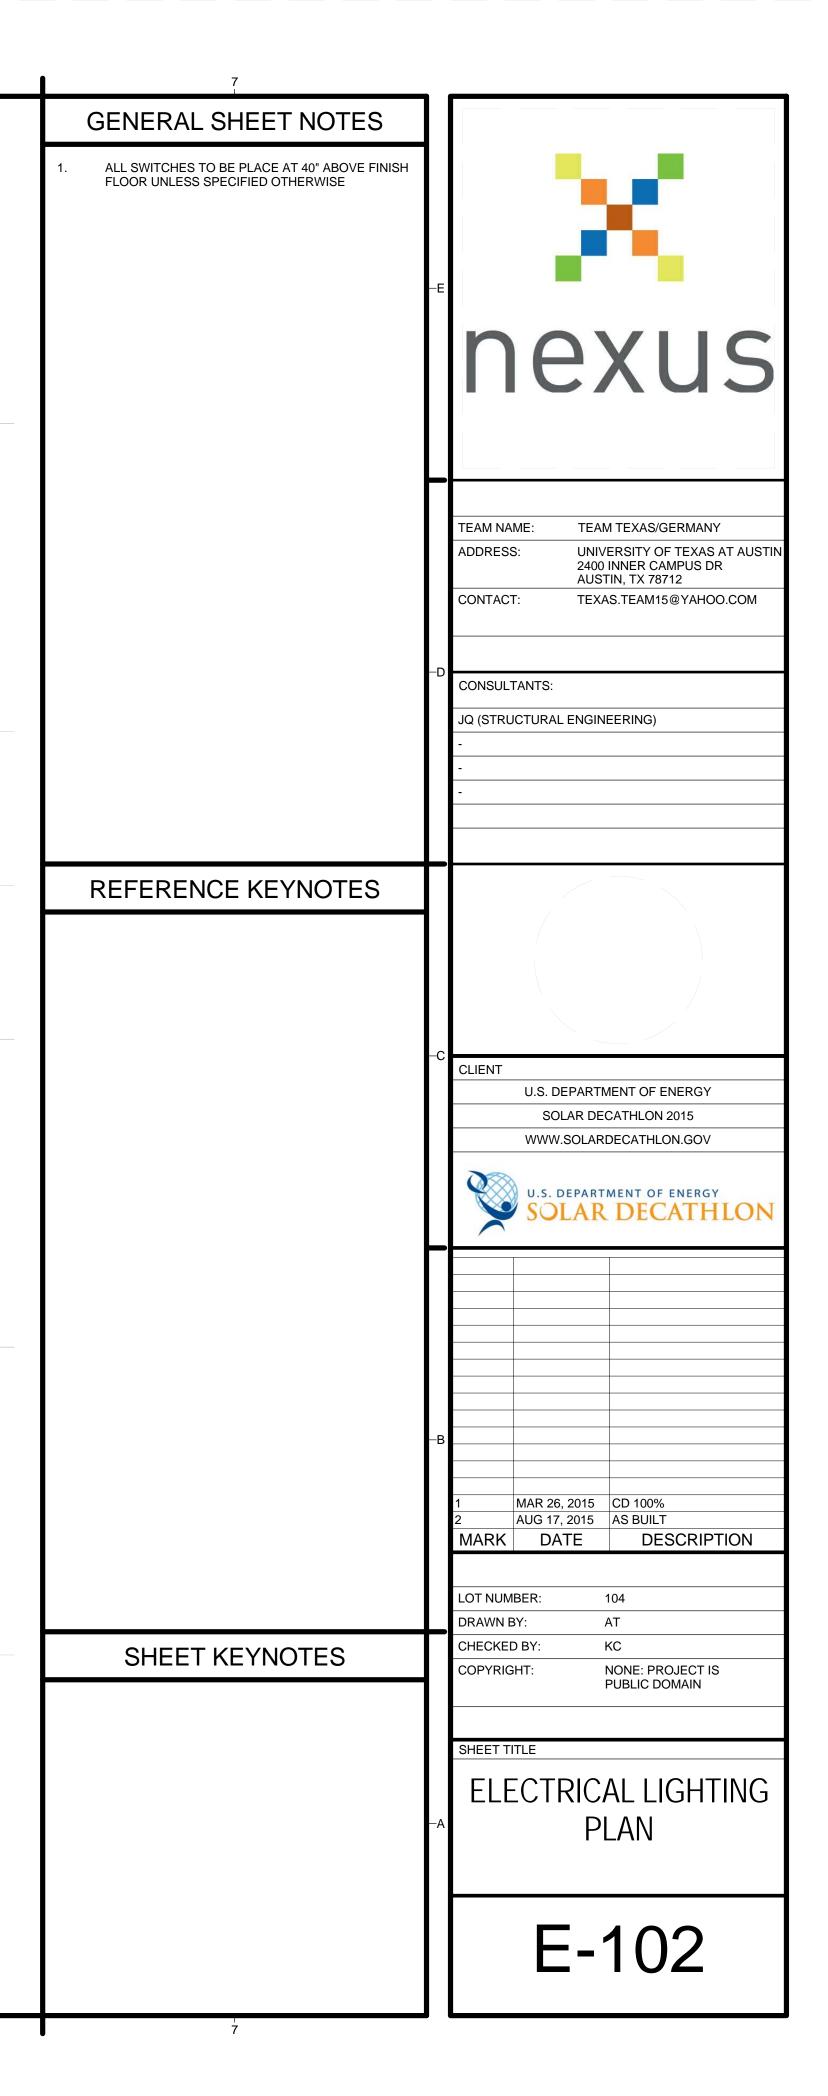



		PHOT
E-		City
1Tilt: 7.13° (1.5 to 12); Azimuth: 188°. DC to AC Derate Factor: 0.87	Austin	
2	Irvine	


		SPECIFICATIONS				
Photovoltaic Mo	odule	Micro-Inverter: DC to AC derate factor is 0.87				
1. Brand	SolarWorld	Brand	Enphase			
2. Model	Sunmodule Plus - SW 290 MONO	Model	M250			
3. V(oc)	37.9	INPUT		OUTPUT	208VAC	240VAc
4. l(sc)	9.97	Max. P(input)	210-300W	Cont. Max P(output)	240W	240W
5. V(mpp)	31.4	Max. V(input)	48V	Nom. I(output)	1.15A	1A
6. l(mpp)	9.33	Max. I(input)	15A	Voltage Range	208- 183-229V	240/ 211-264V
7. P(max)	290	Vmpp	27V	Nom. Frequency	60Hz	60Hz
8		Impp	10A	Frequency Range	57-61Hz	57-61Hz

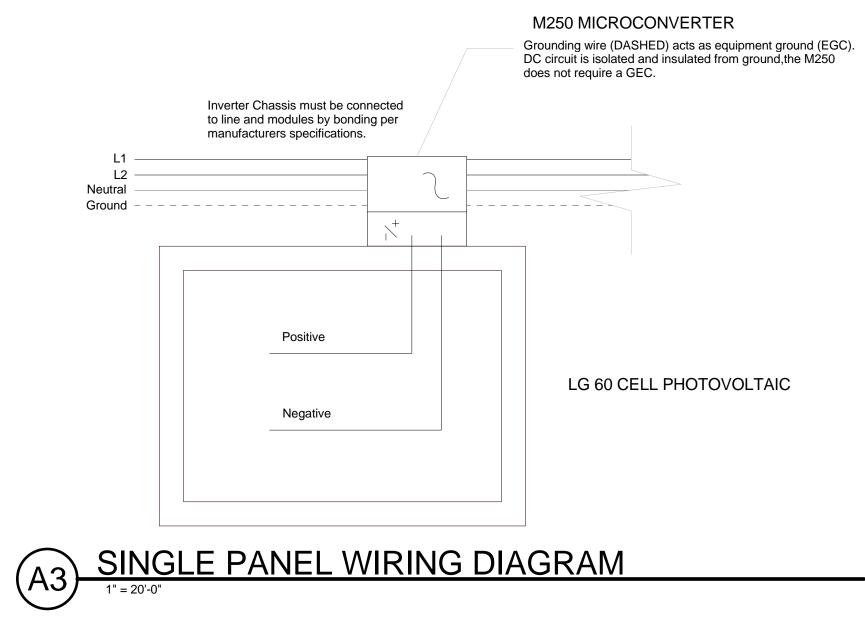



DTOVOLI	FOVOLTAIC CALCULATIONS					
	October	Year				
	744 W(AC)	9228 W(AC)				
	712 W(AC)	9643 W(AC)				

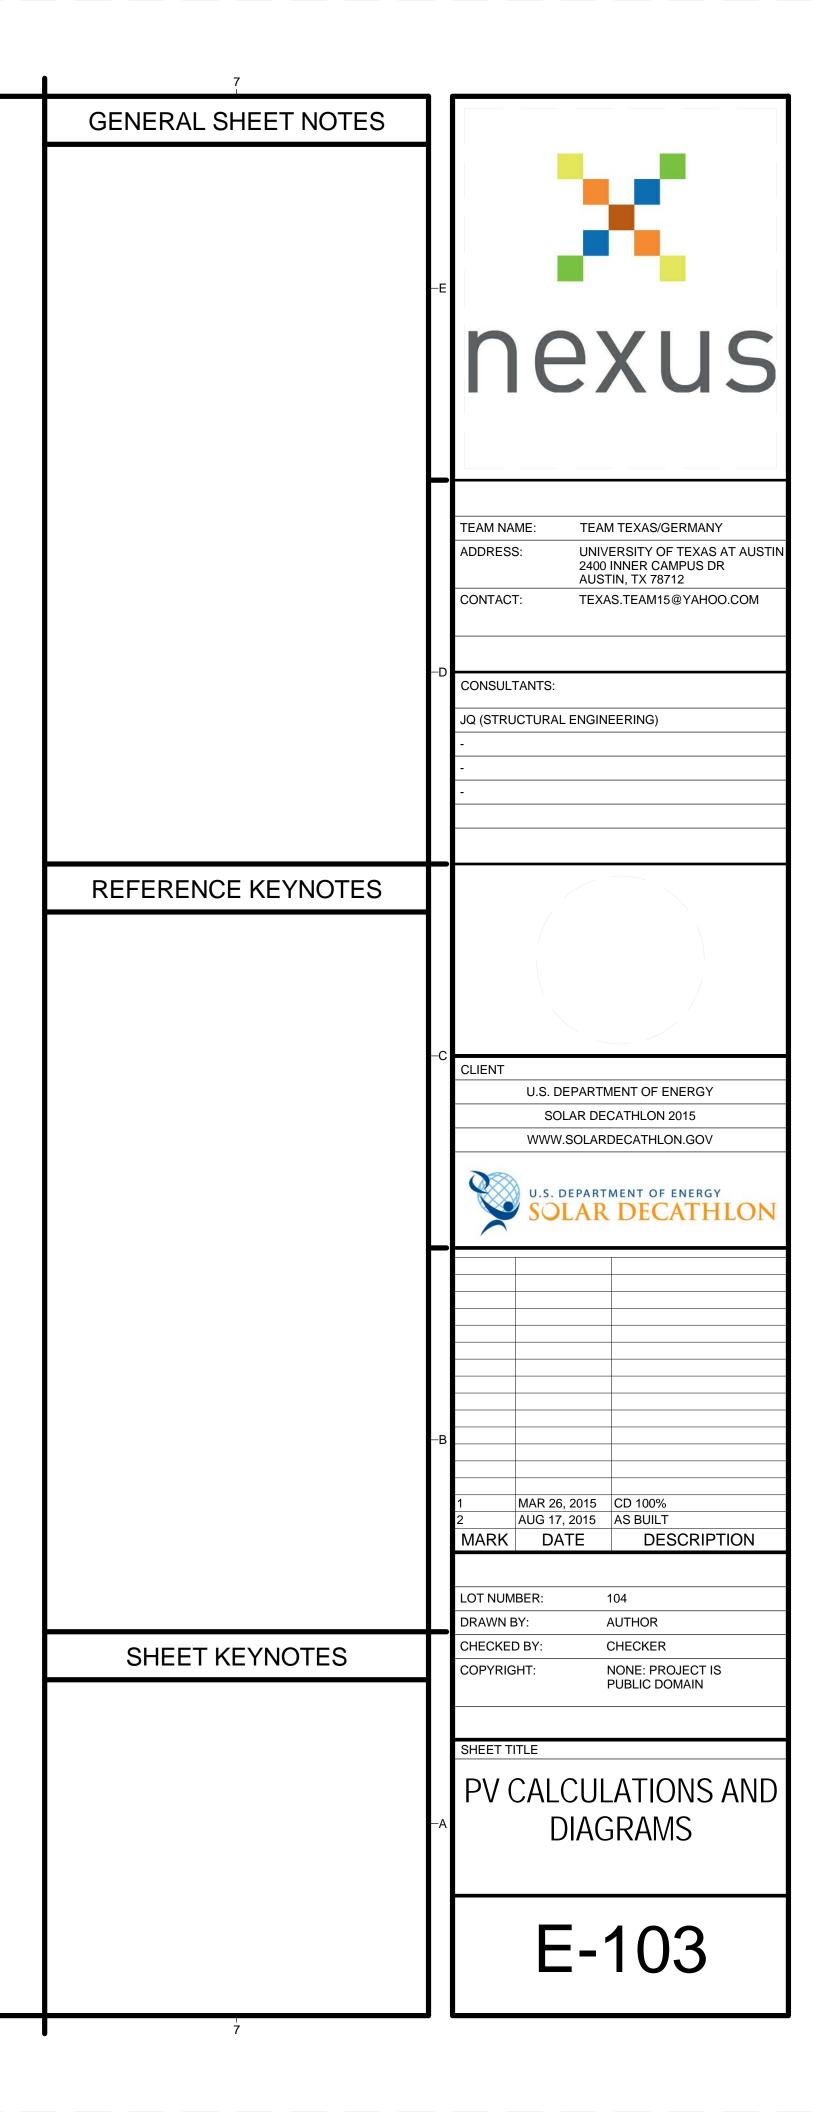


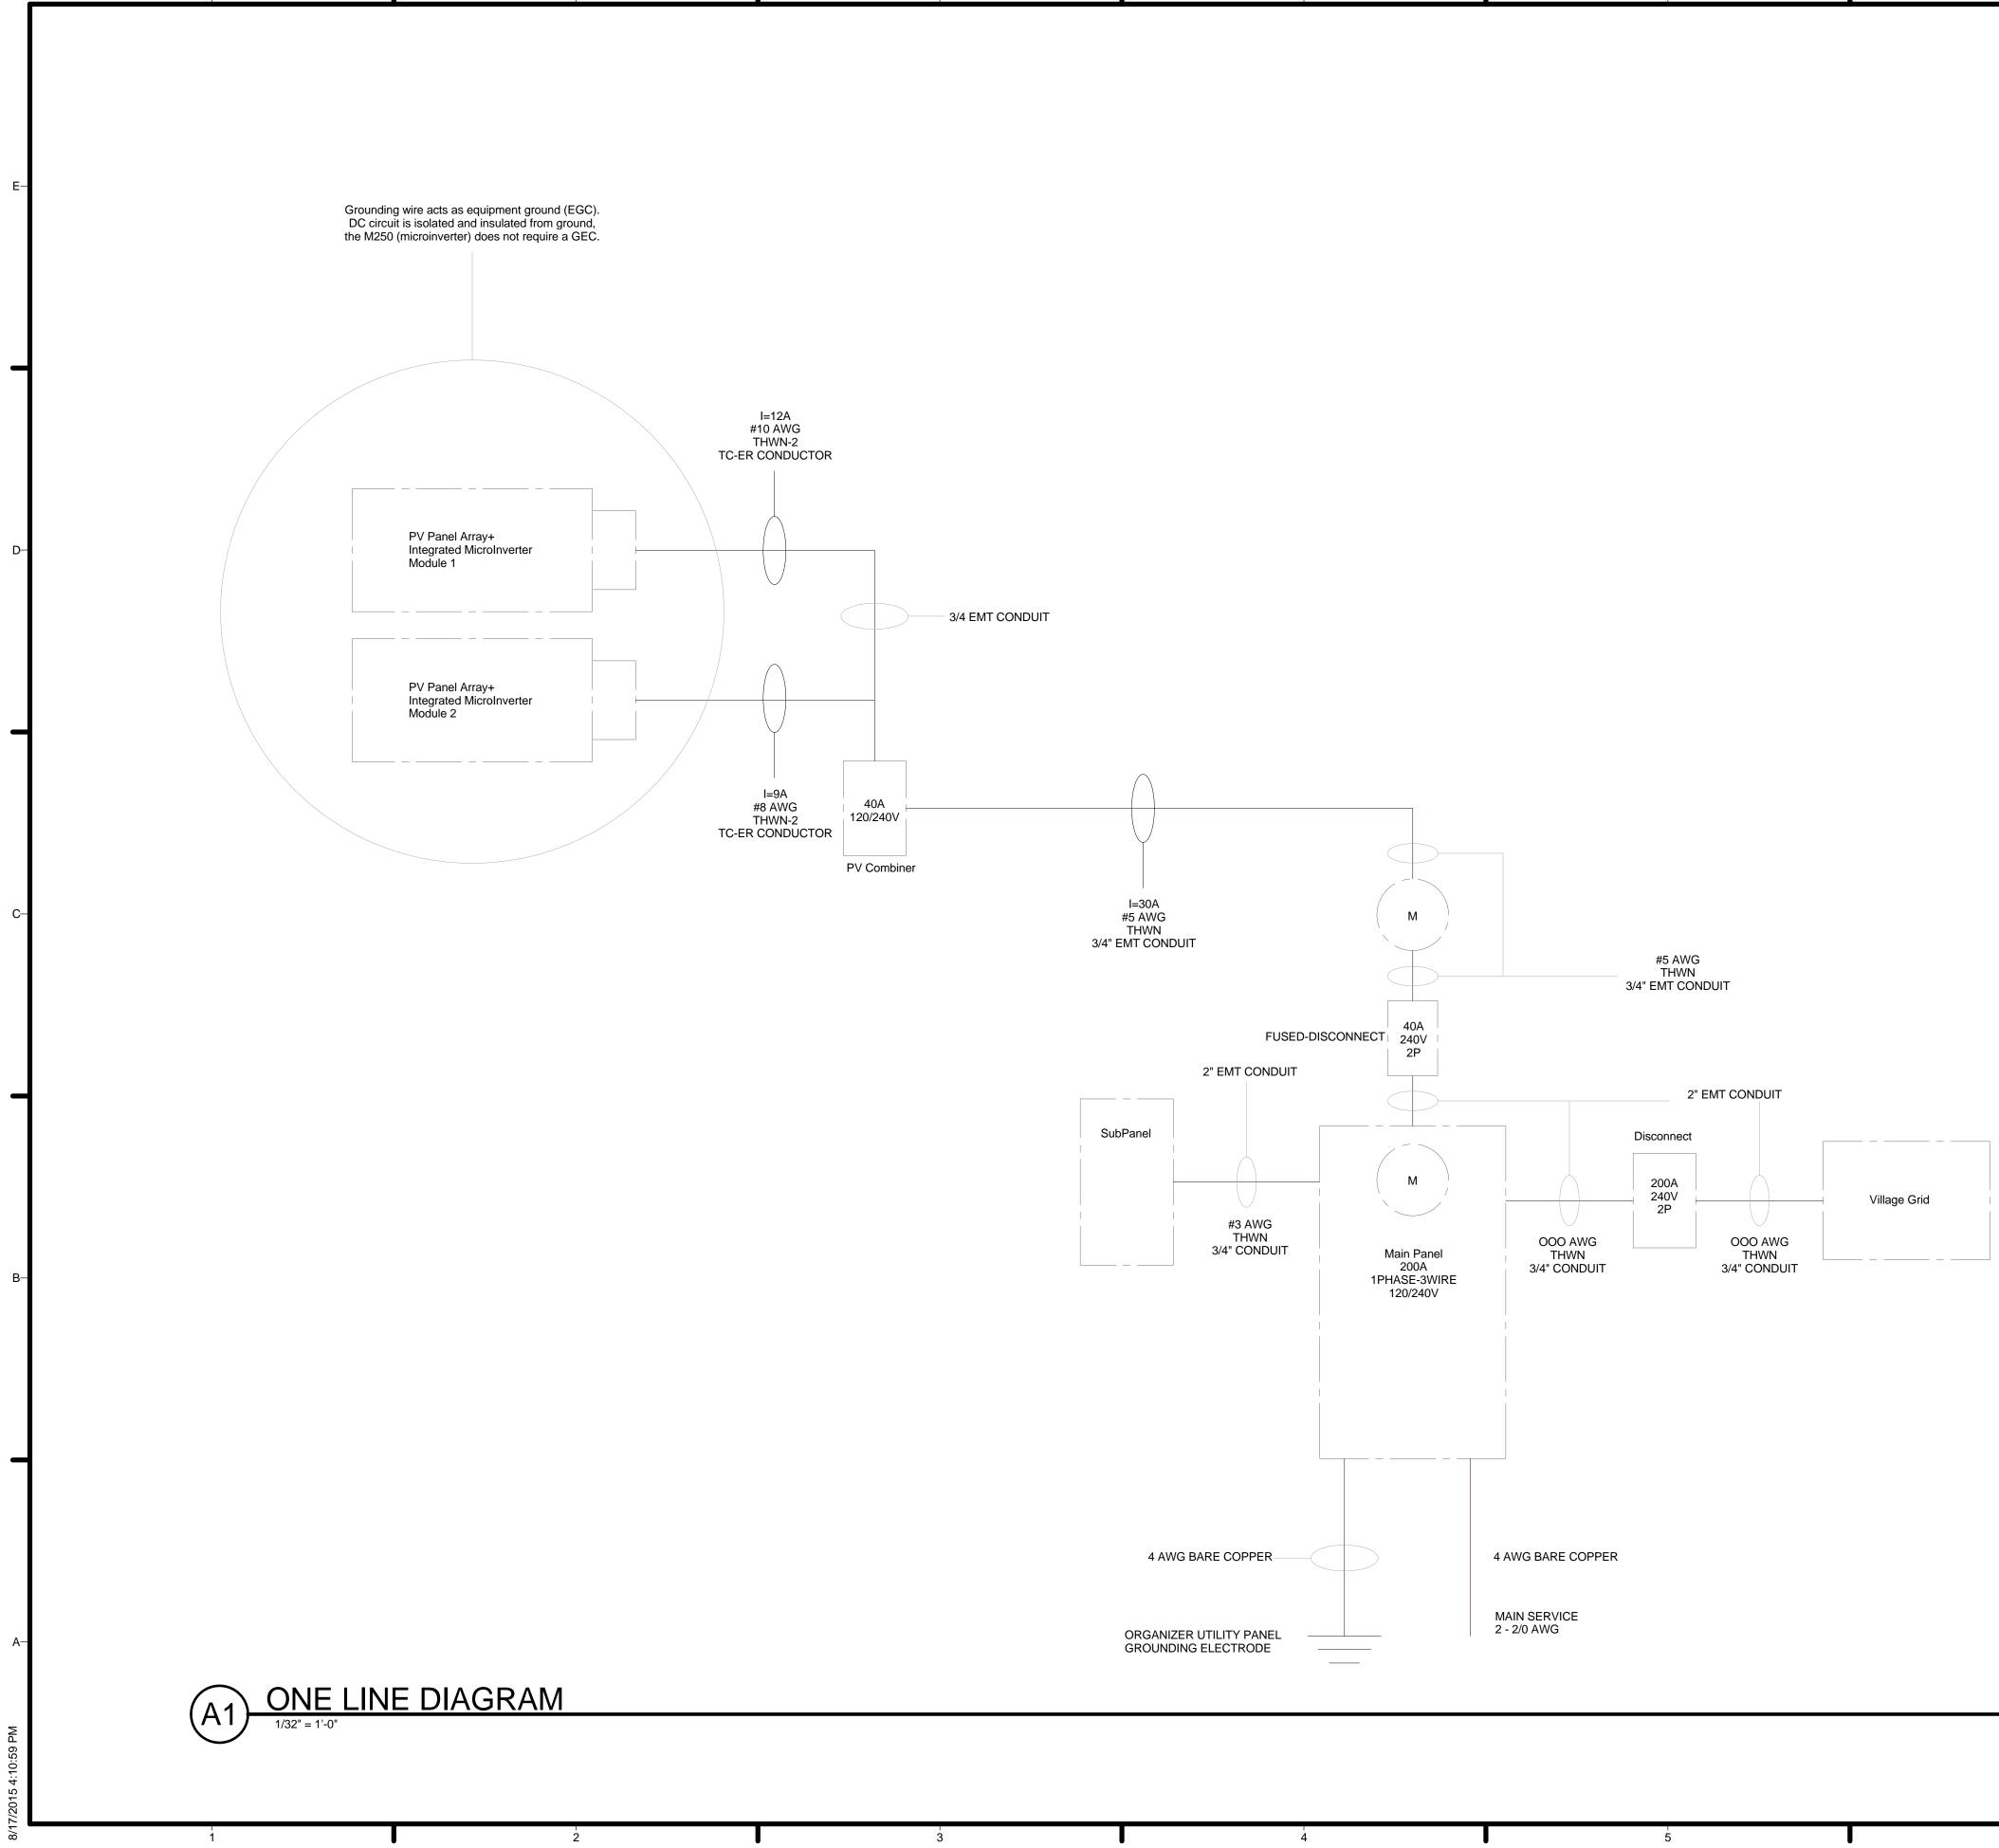

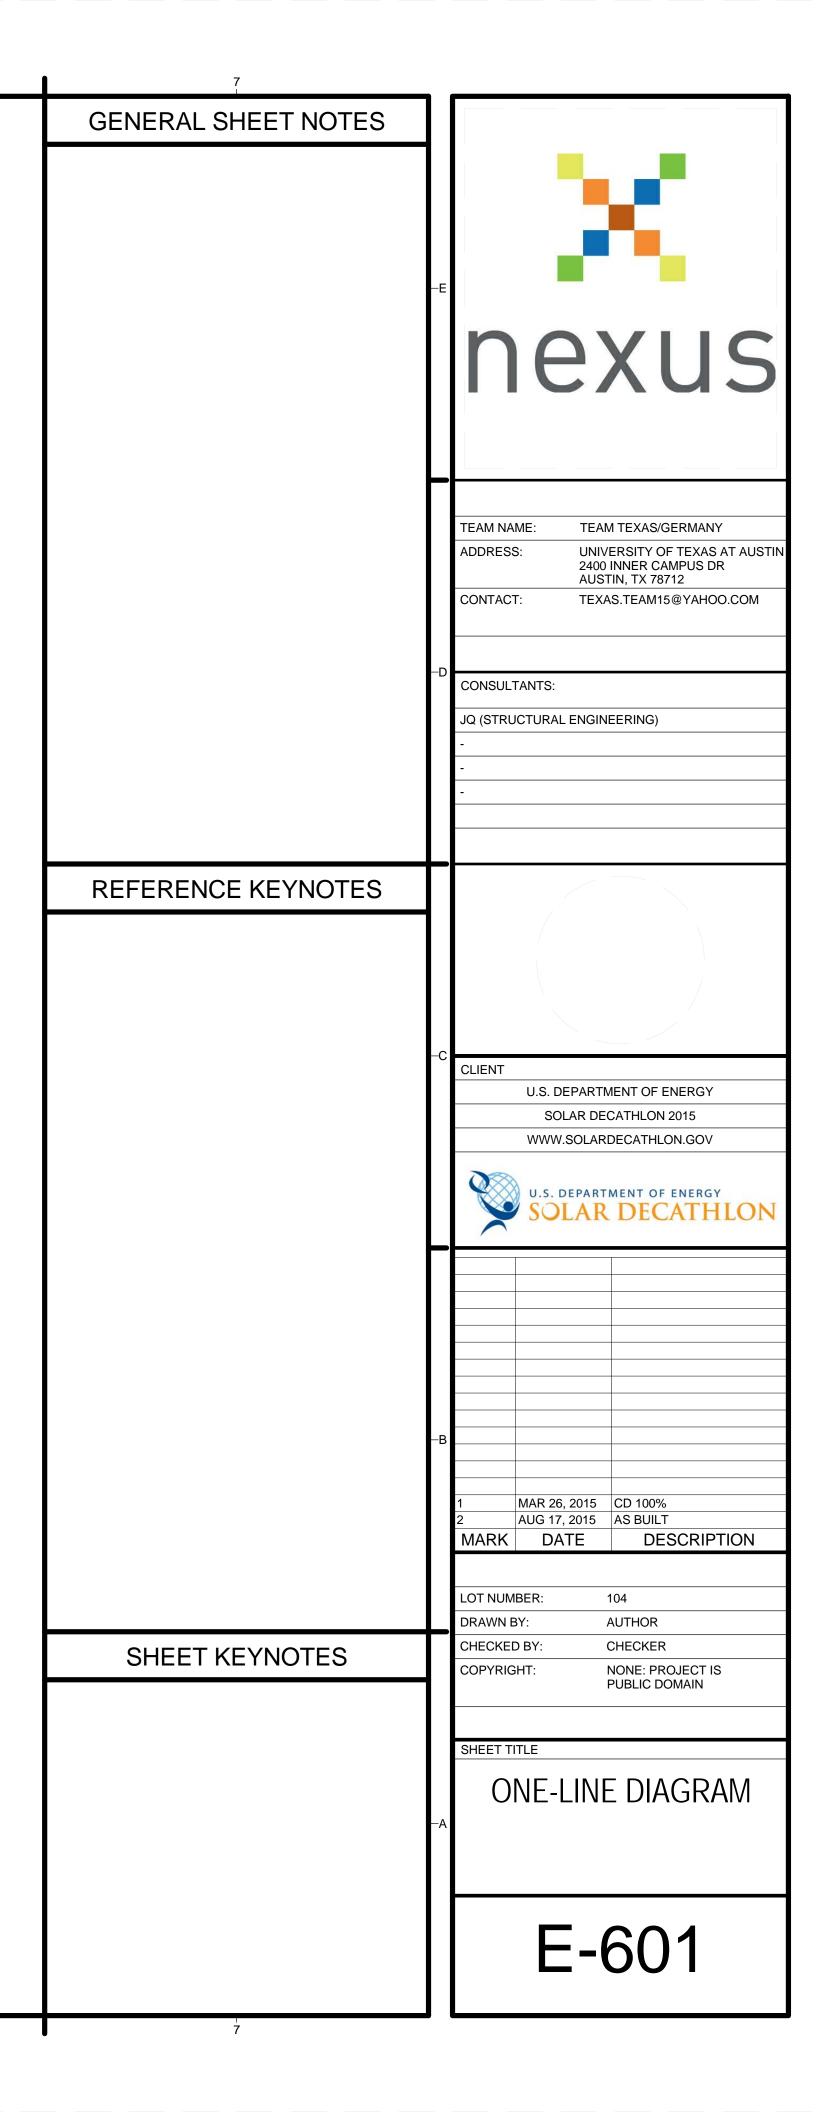

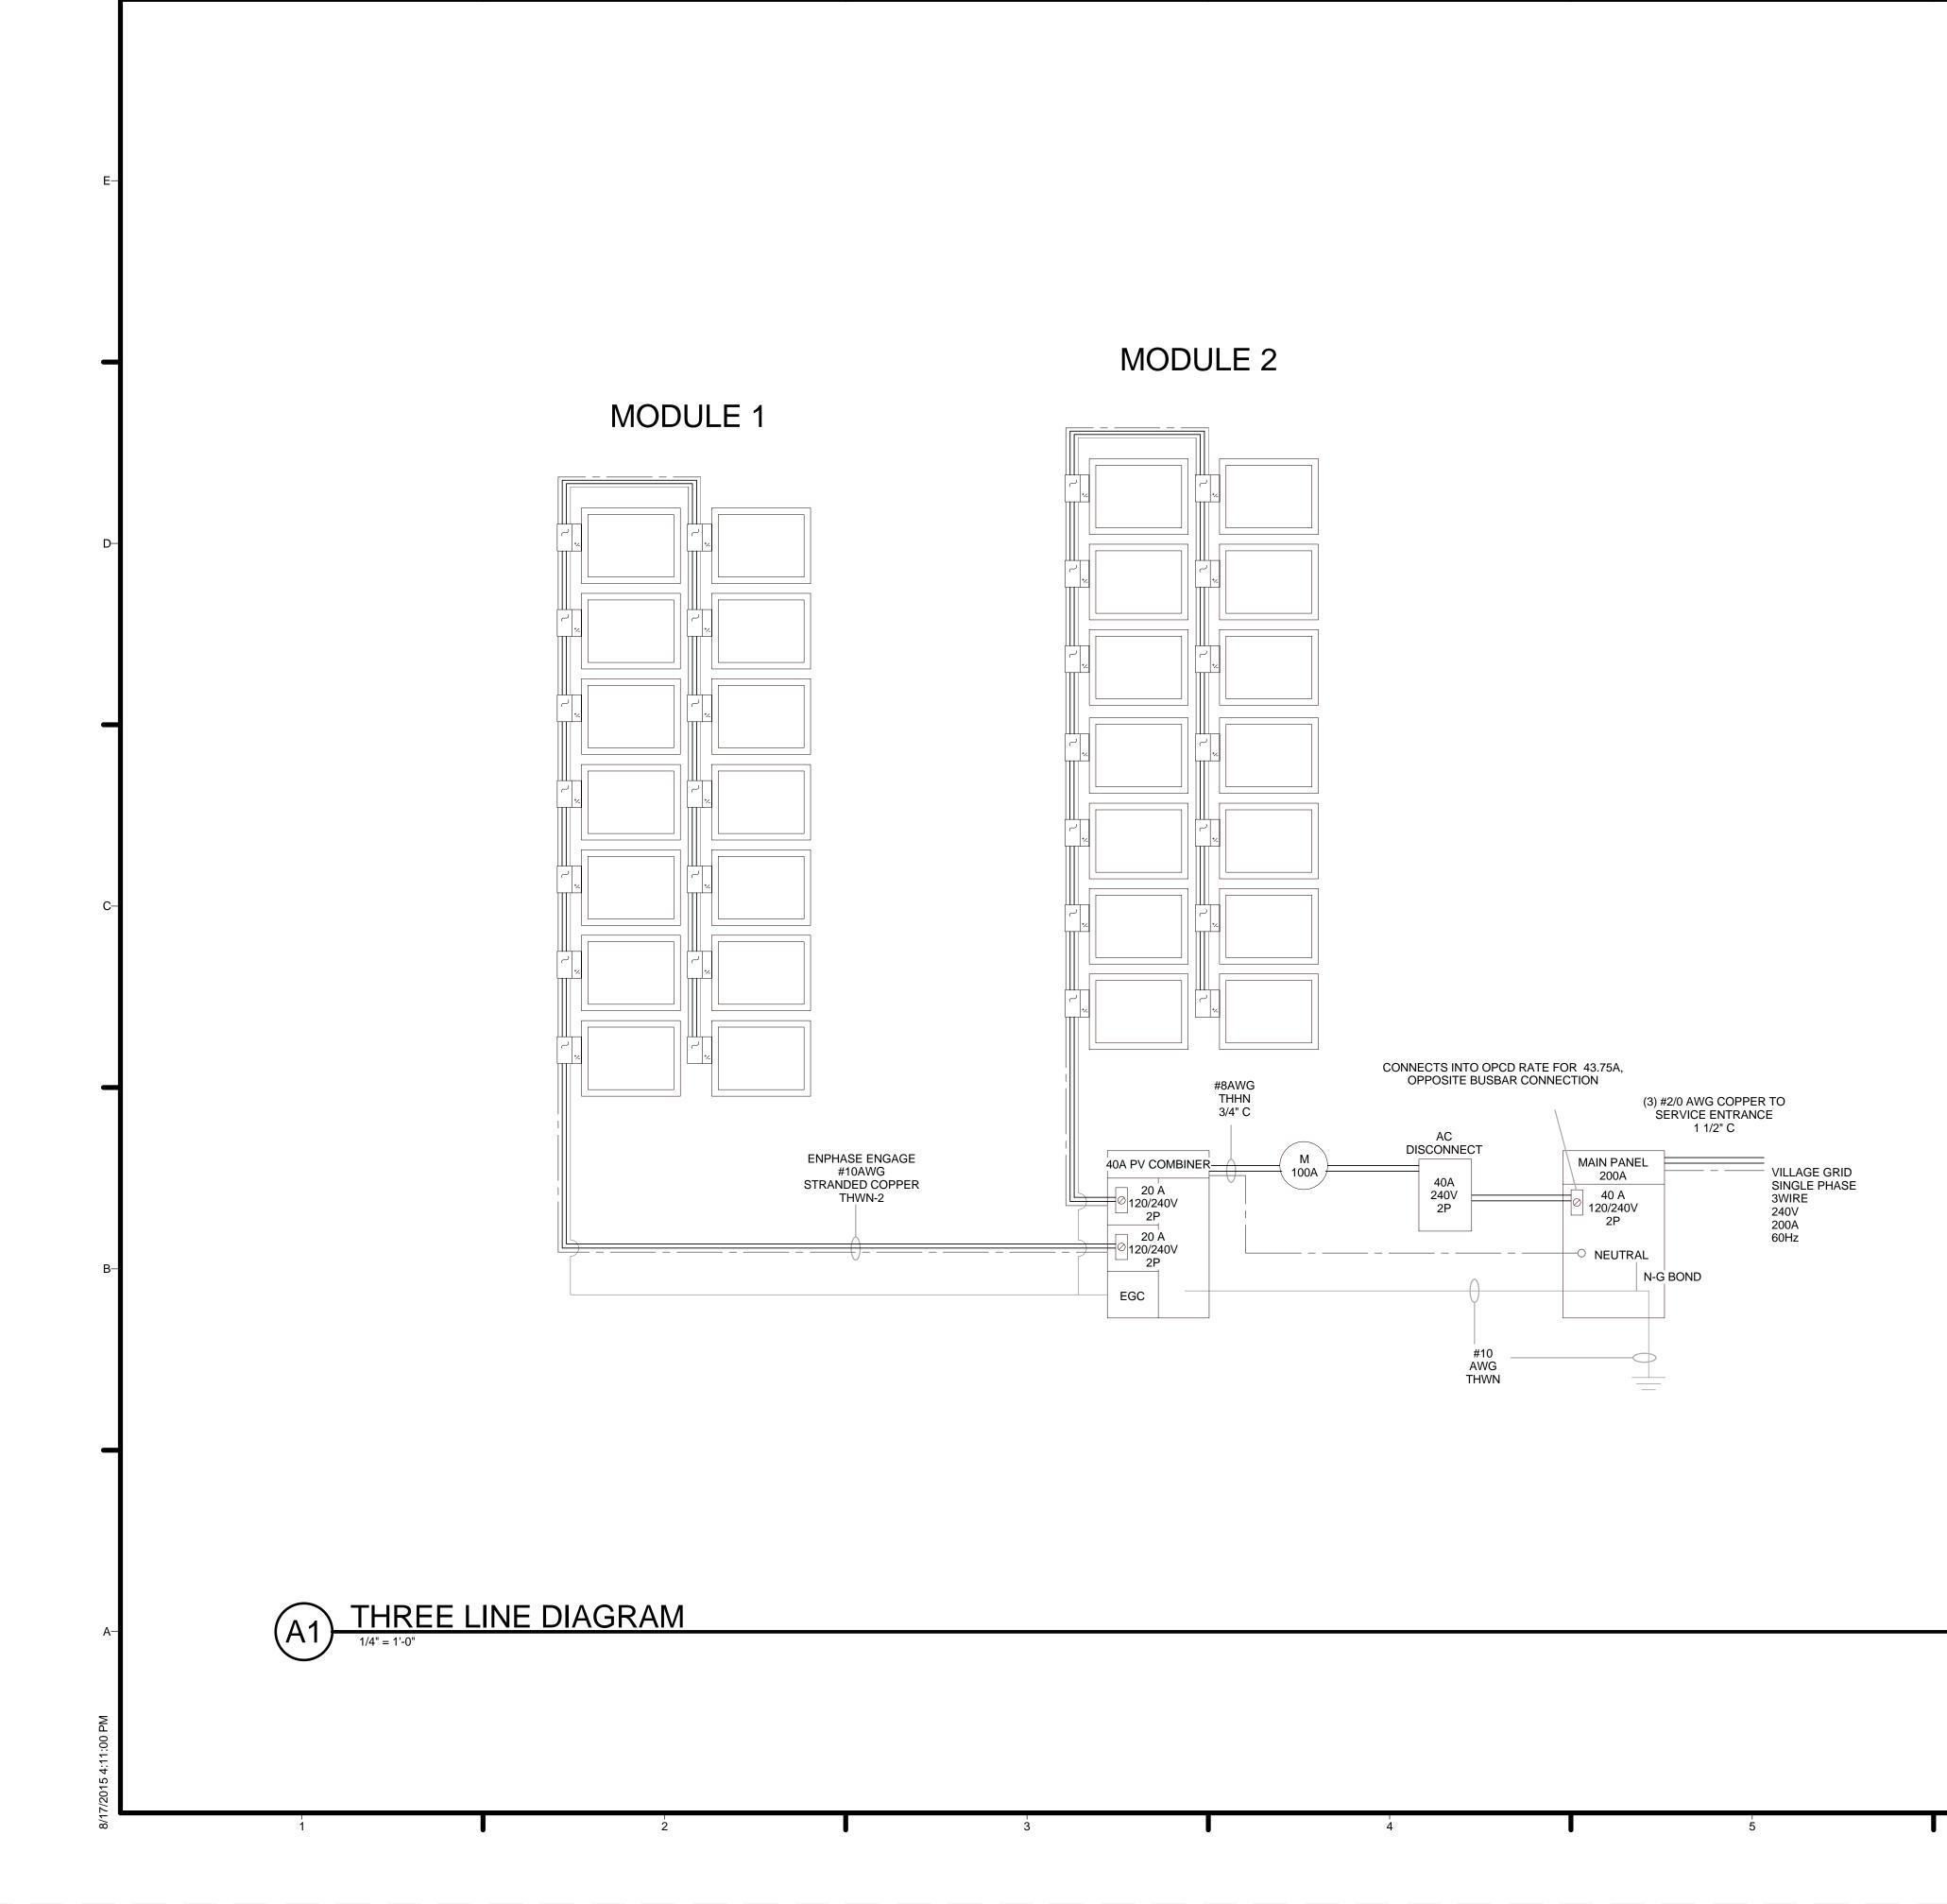


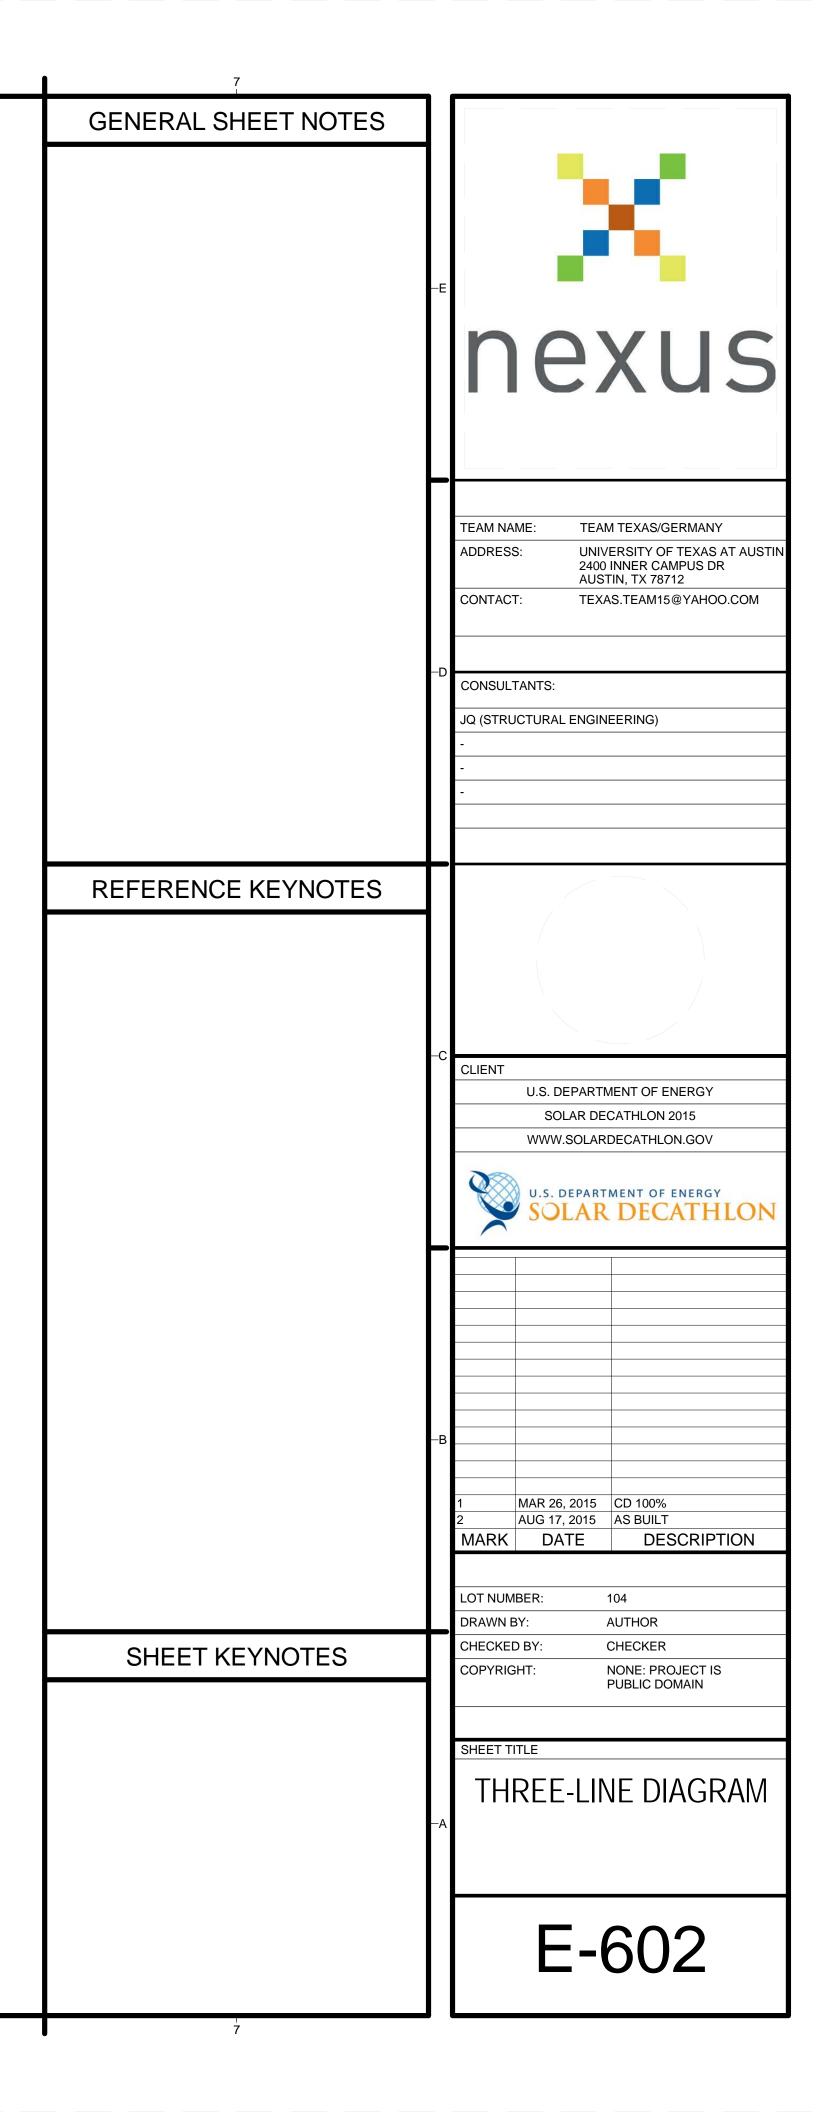


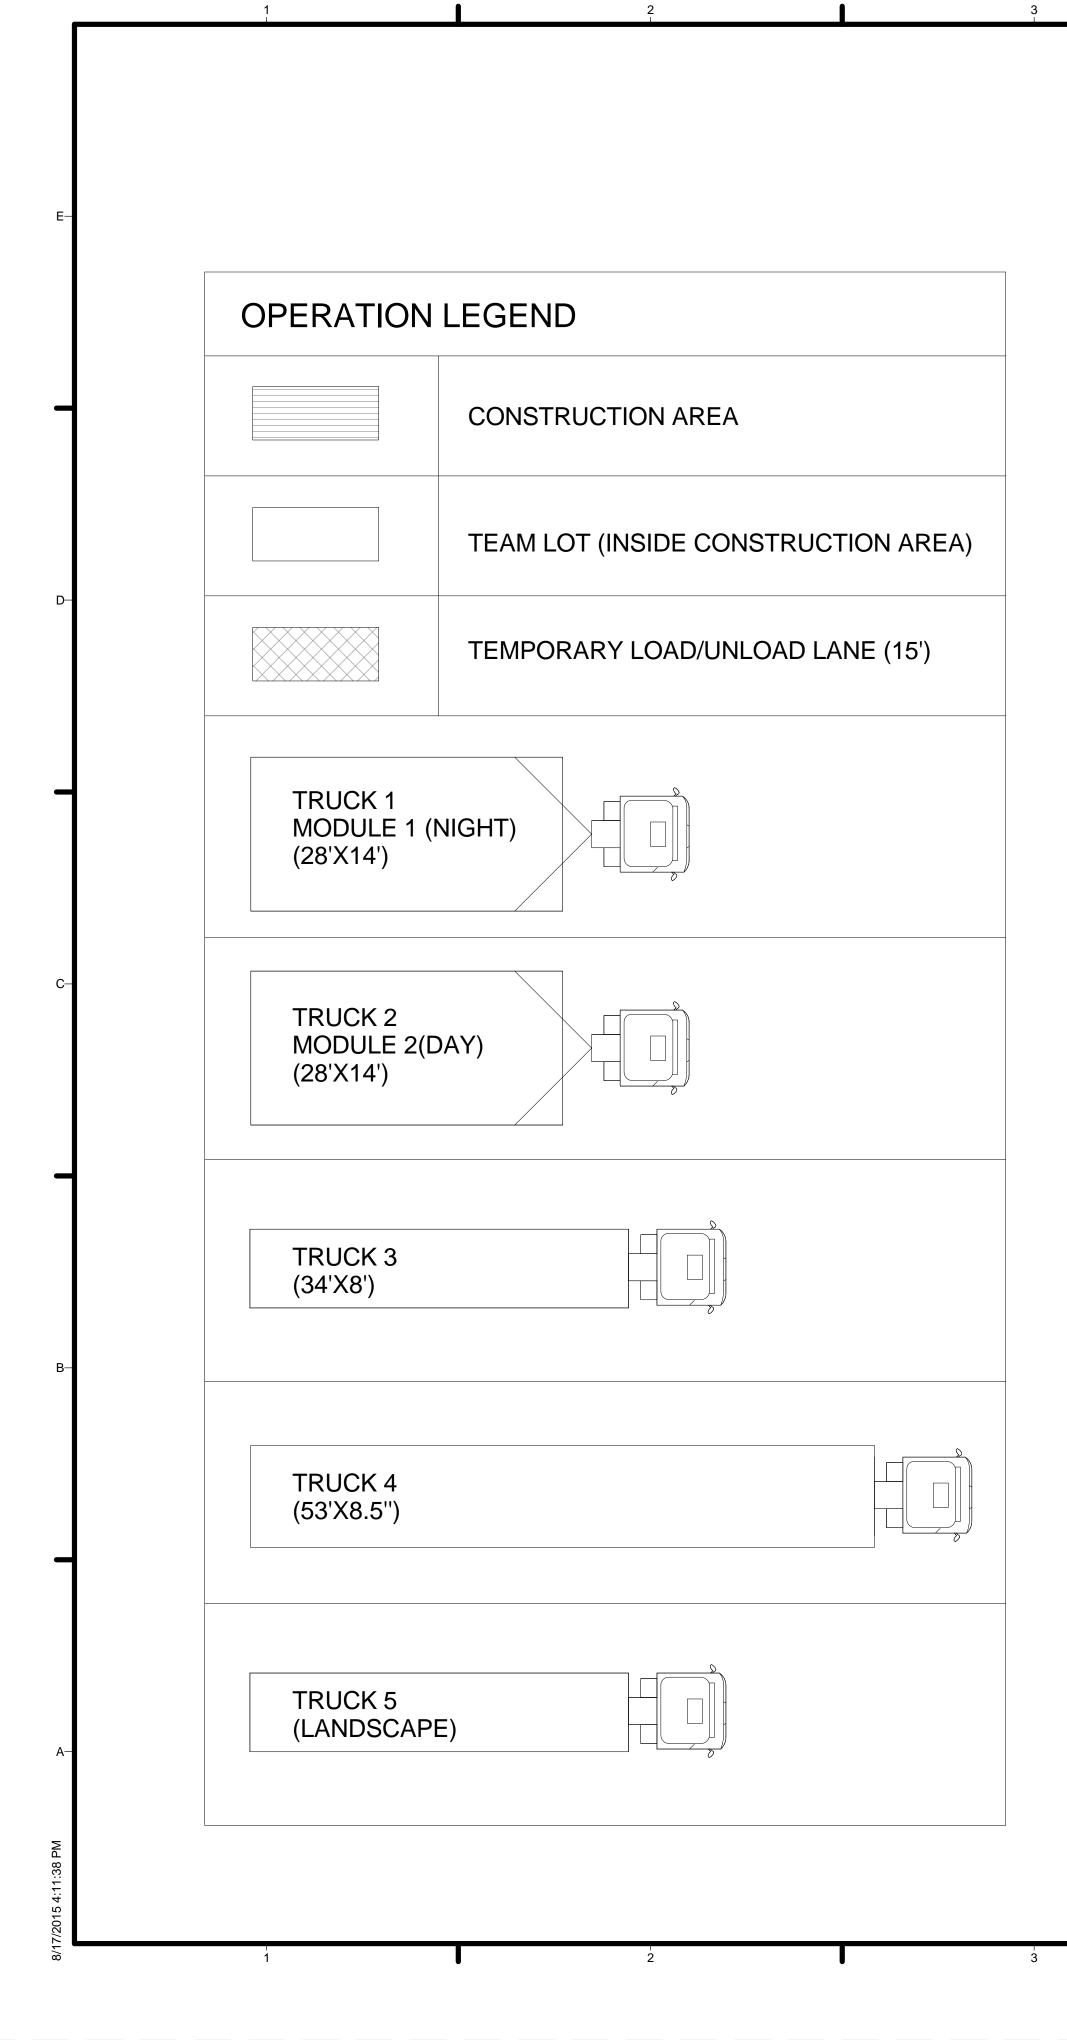


CONSTRUCTION SCHEDULE				
SHIFT 1	7:00 am - 2:00 pm			
SHIFT 2	1:00 pm - 8:00 pm			
SHIFT 3	7:00 pm - 2:00 am			

*subject for change

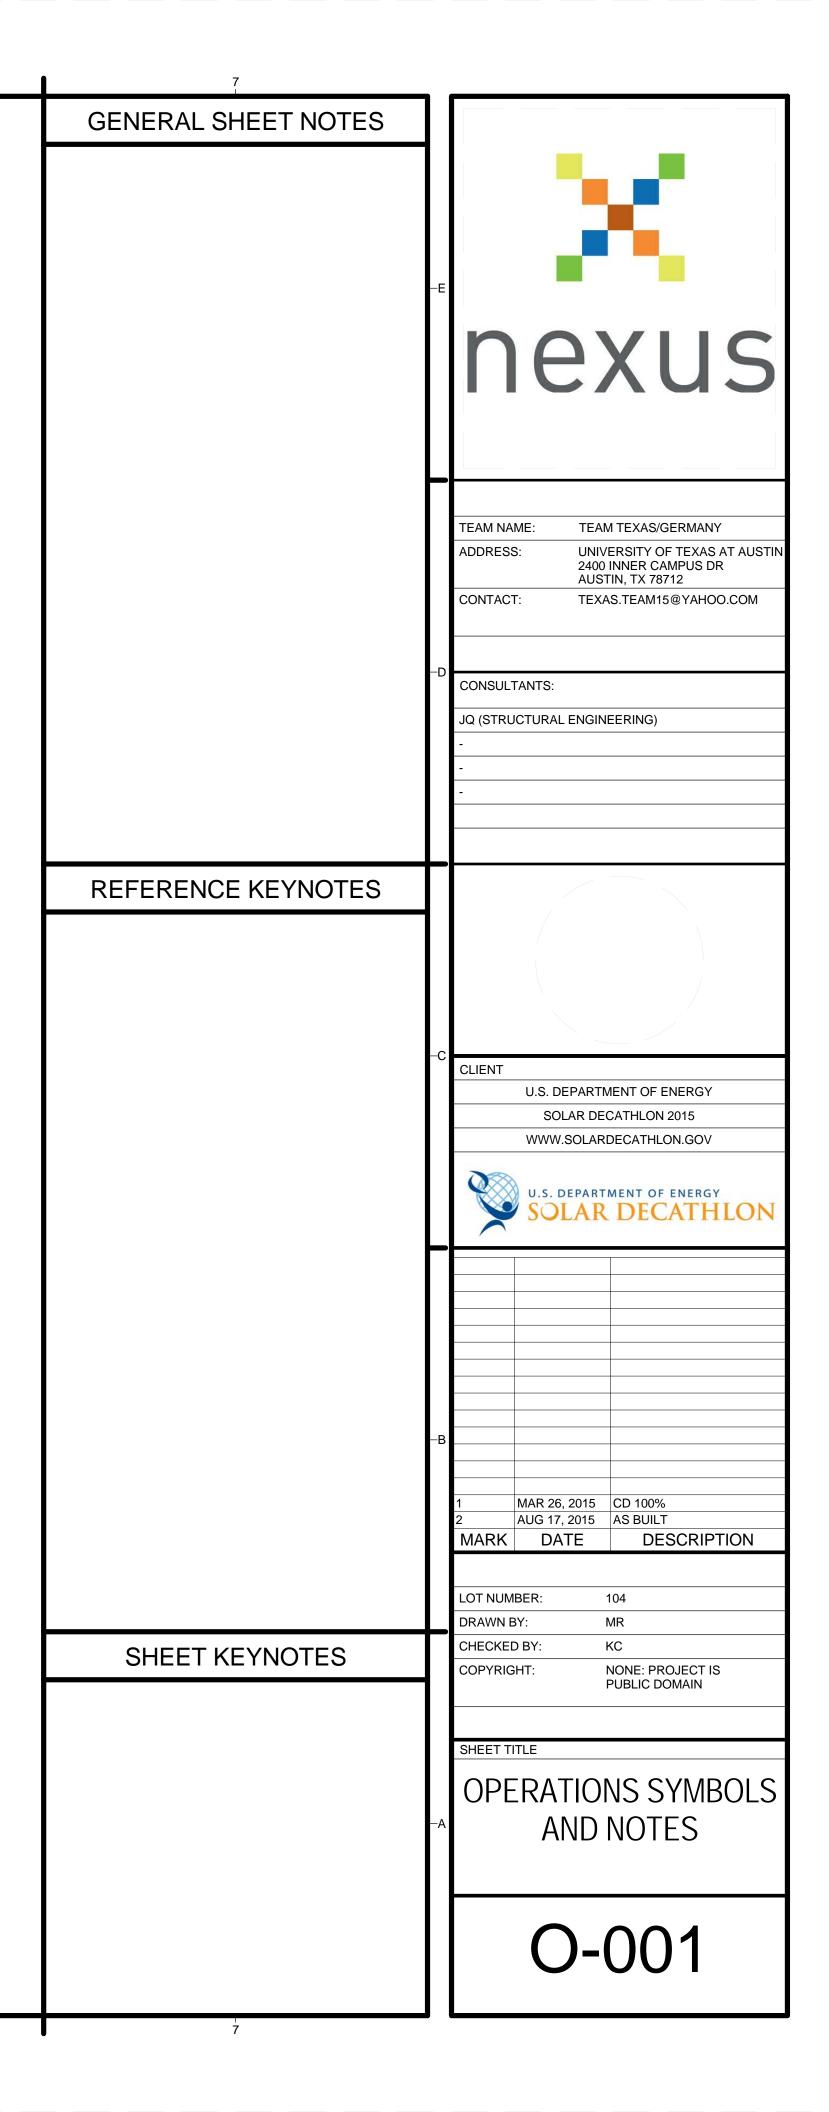

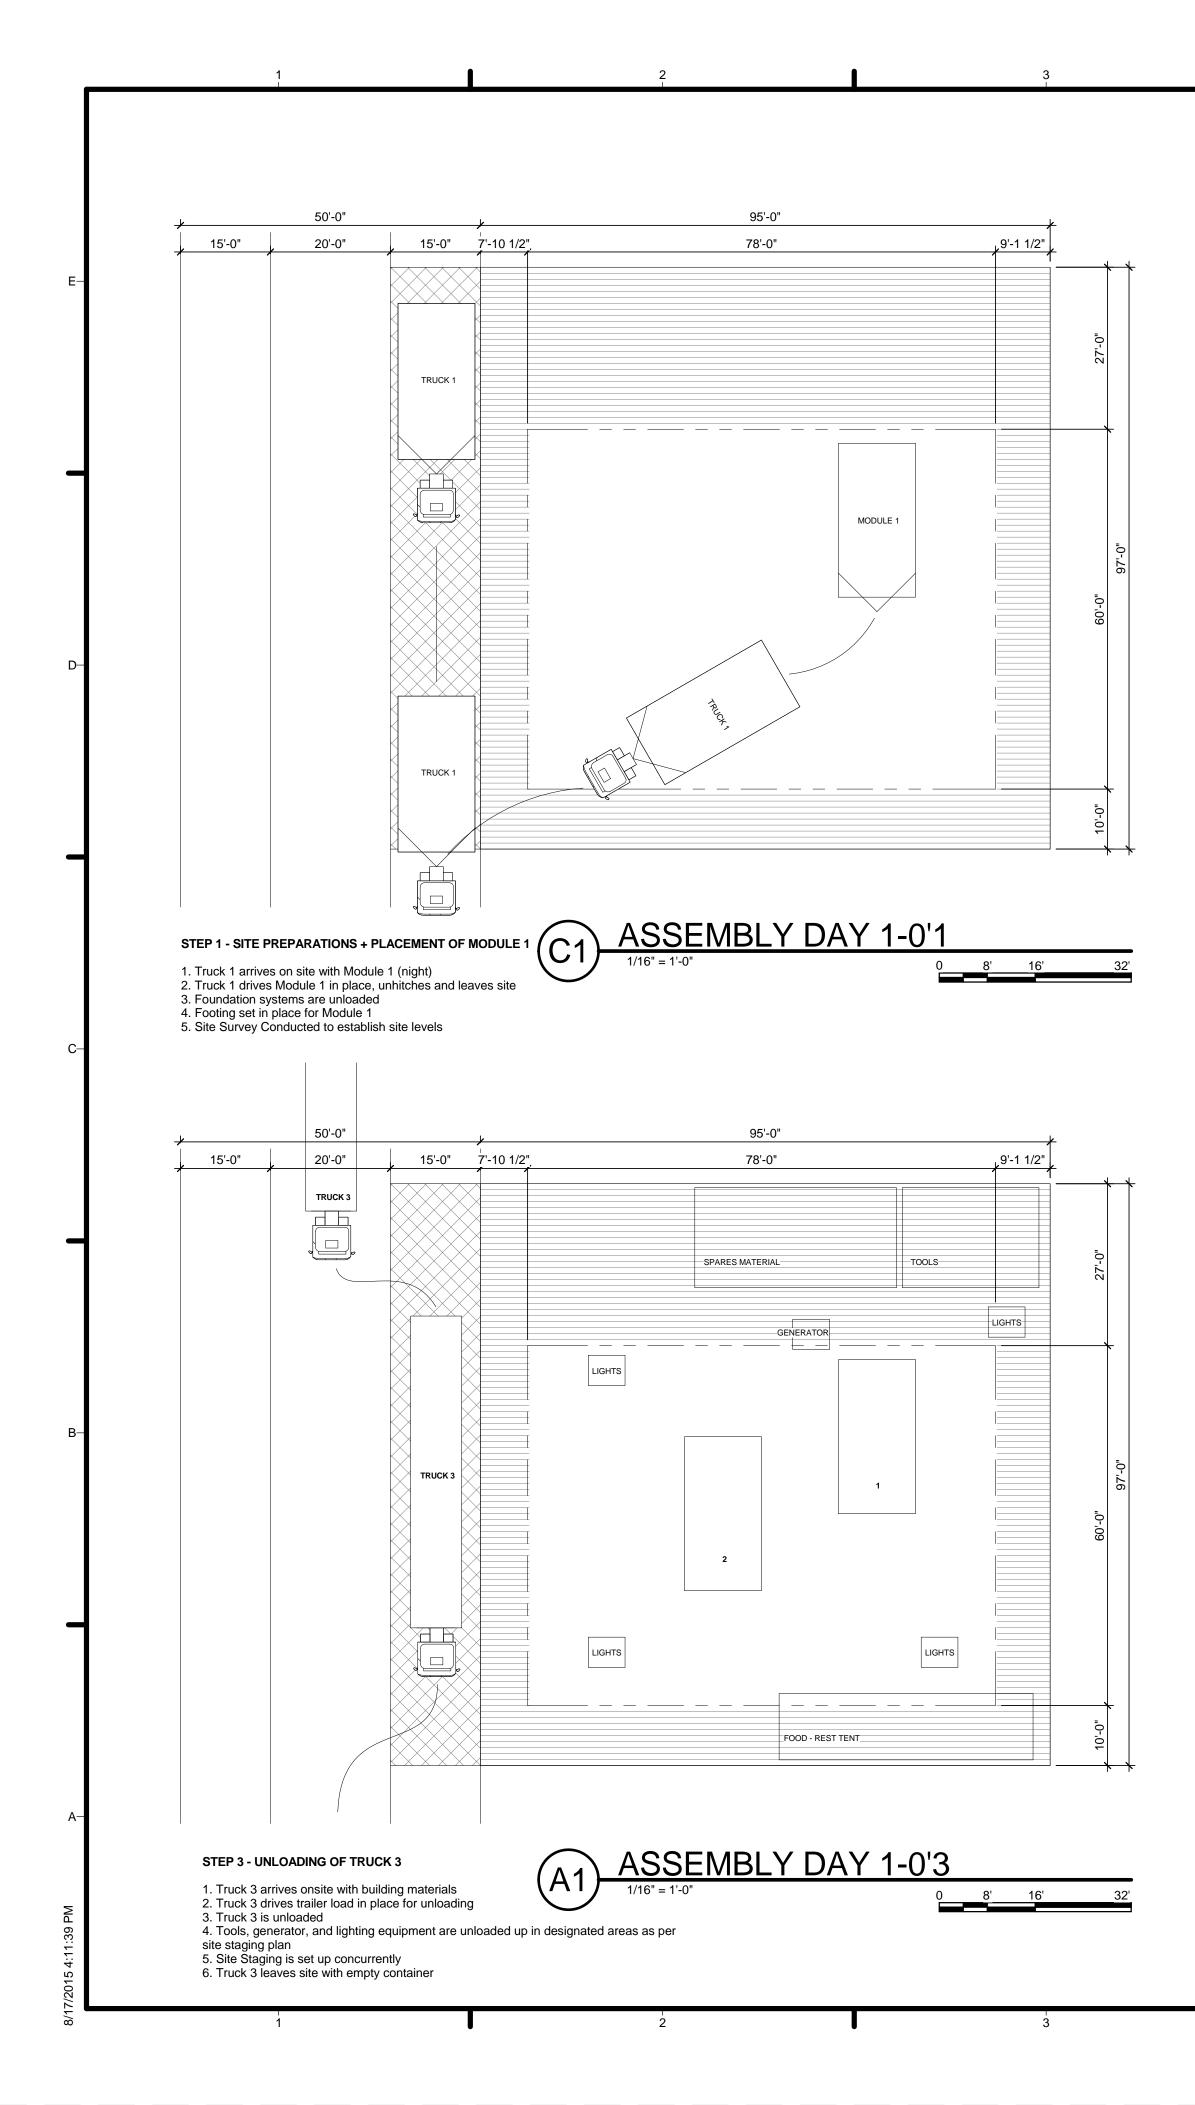

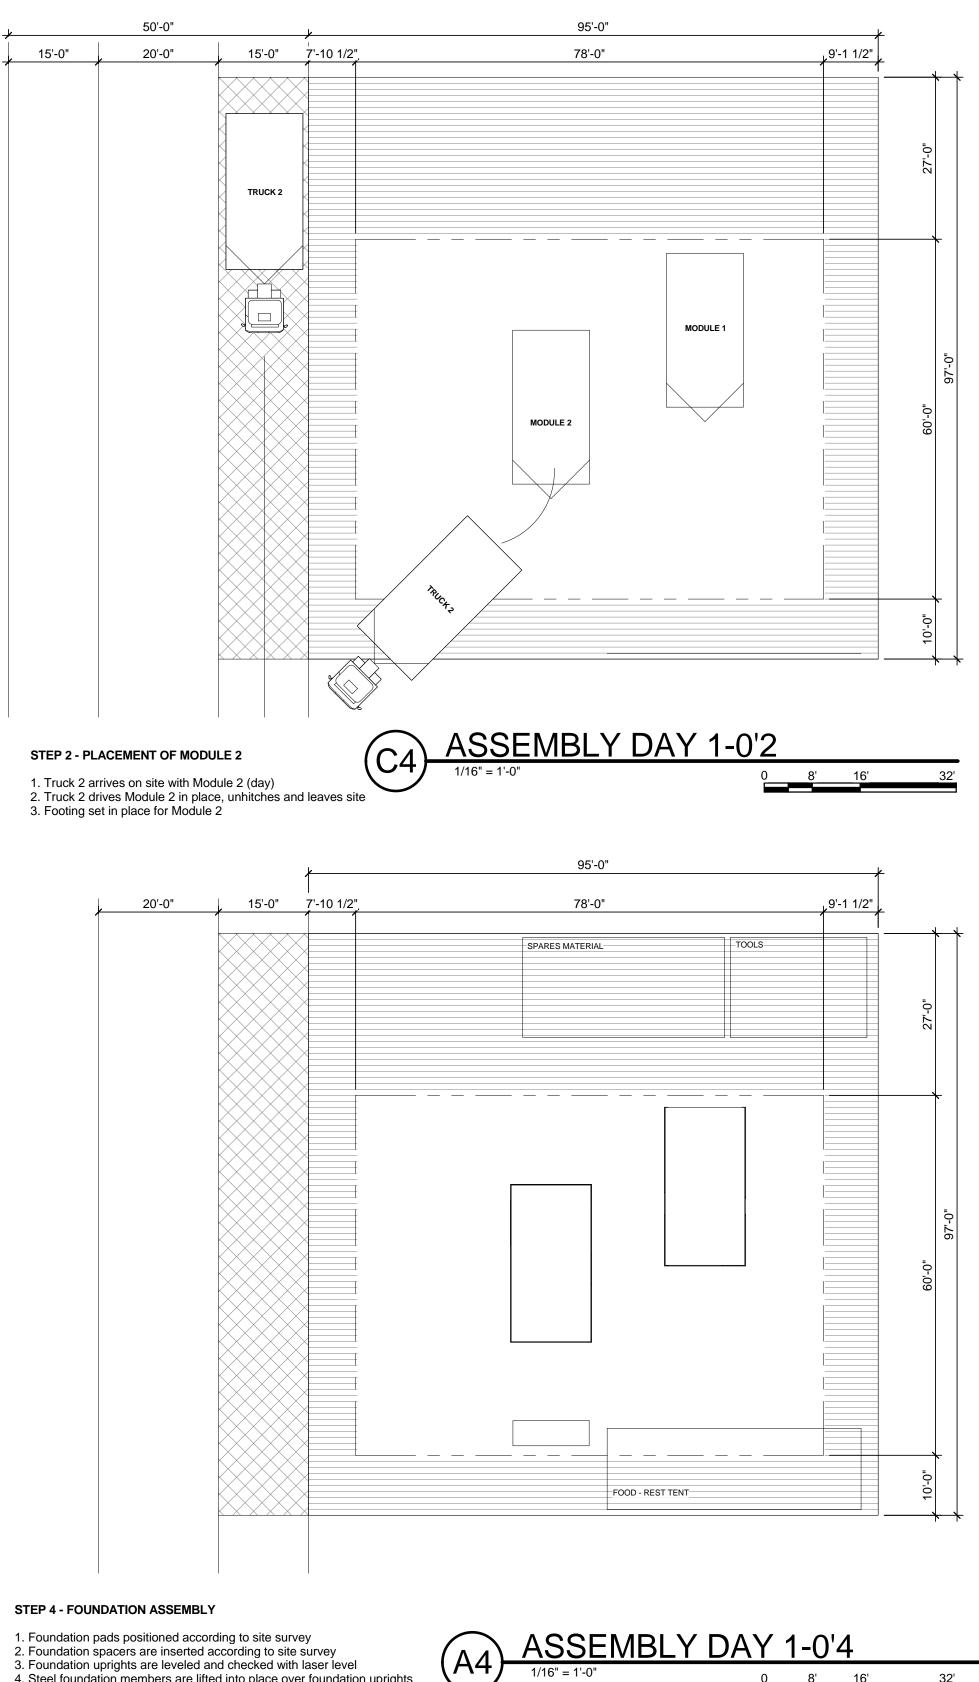



4. Steel foundation members are lifted into place over foundation uprights


5. Steel foundation members fixed togheter

6. Foundation system levels are checked with laser level

4

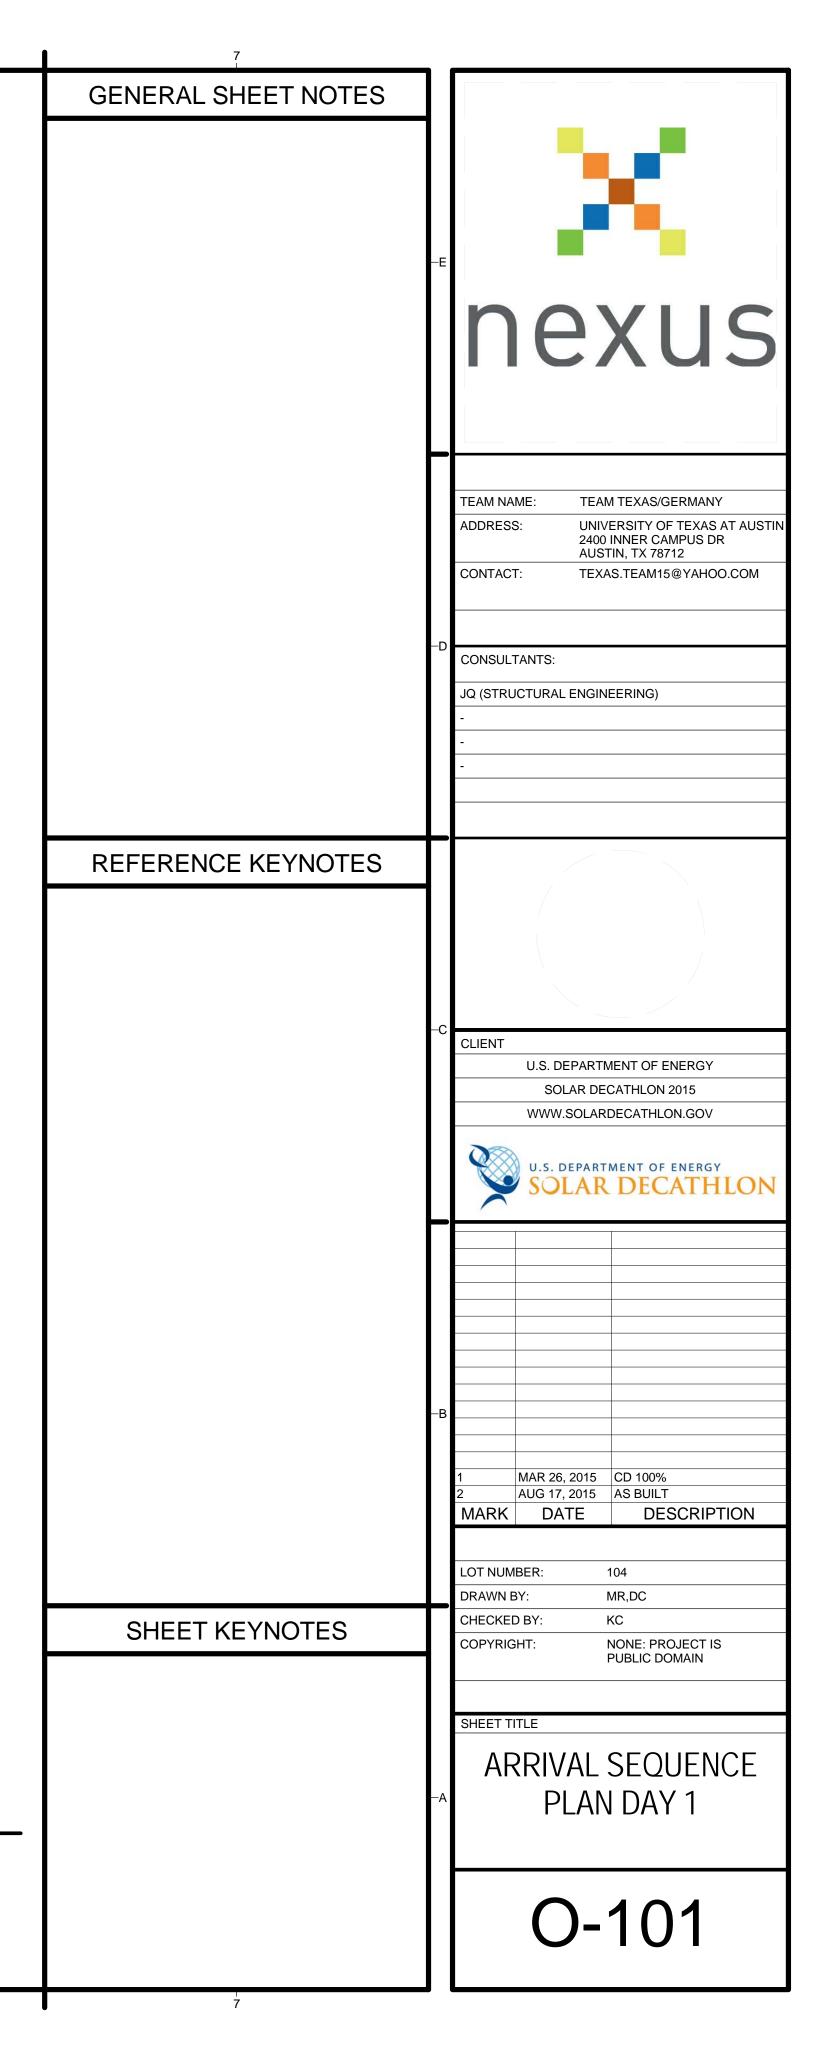

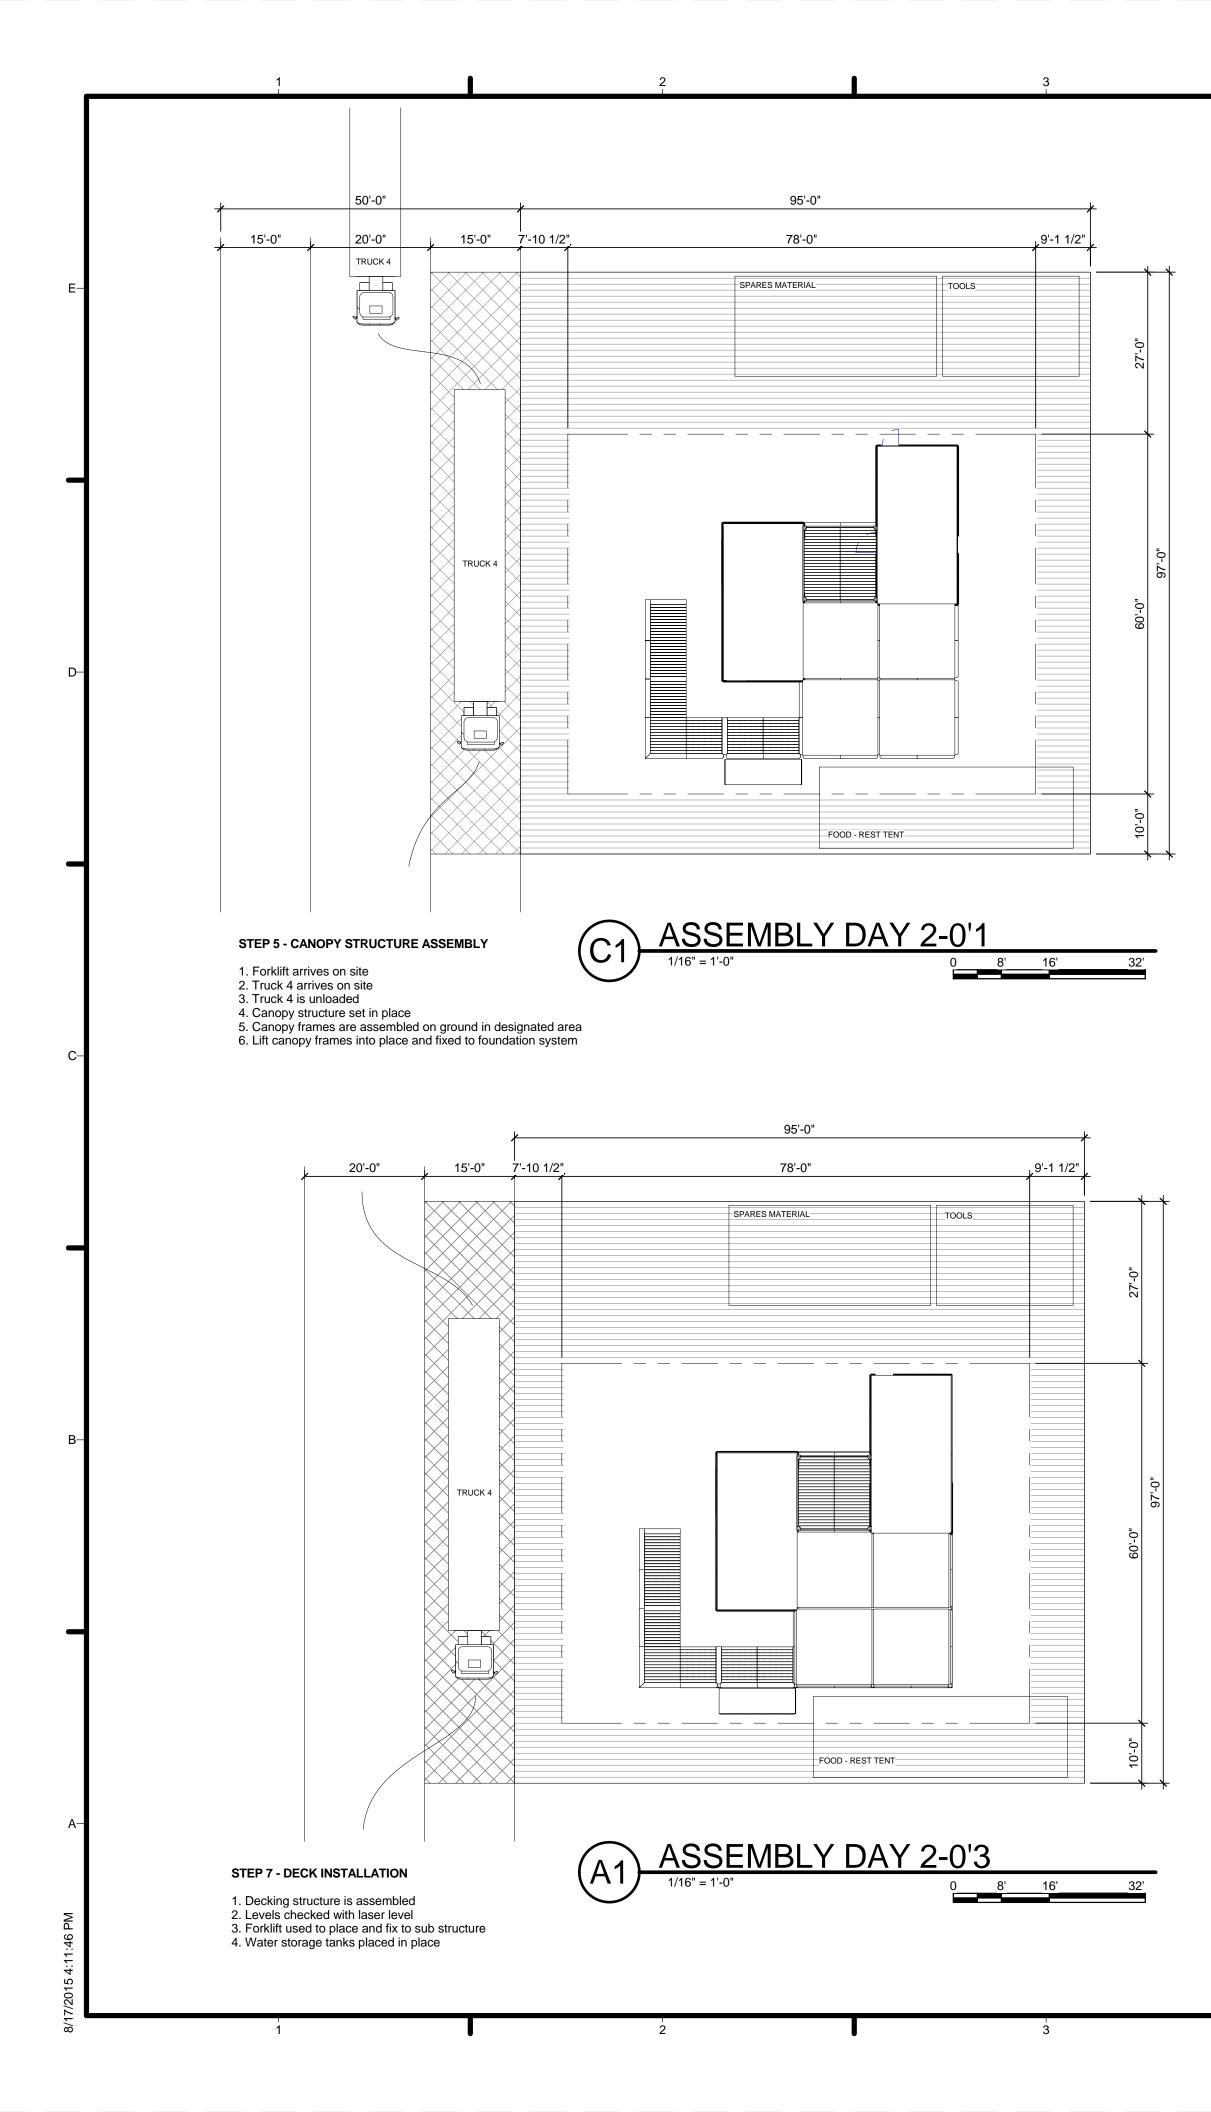

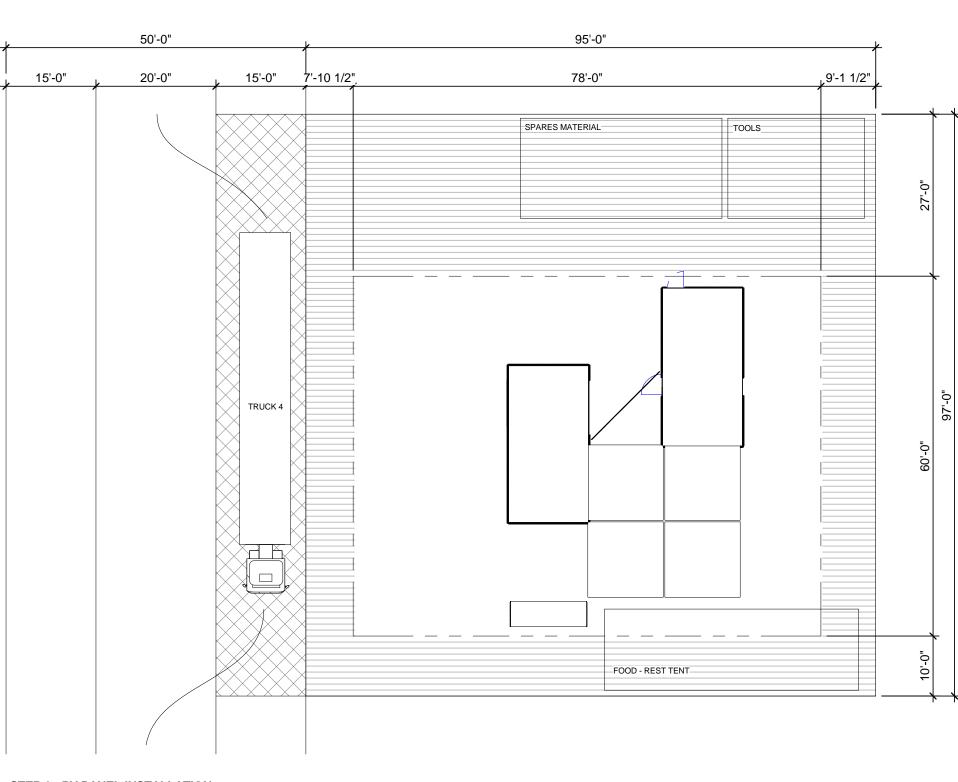


STEP 6 - PV PANEL INSTALLATION

1. Scaffolding set in place


PV panels support fixed to individual PV panels
 Assembled PV panels fixed to roof

(C4) ASSEMBLY DAY 2-0'2 0 8' 16' 32'

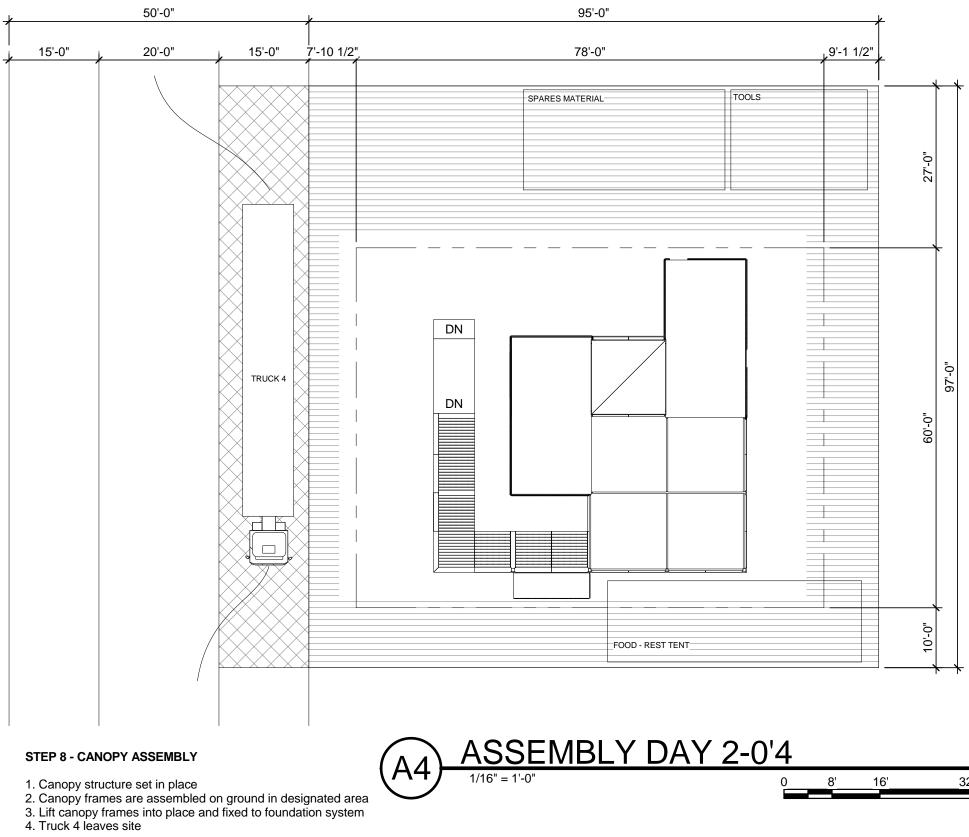


5

6

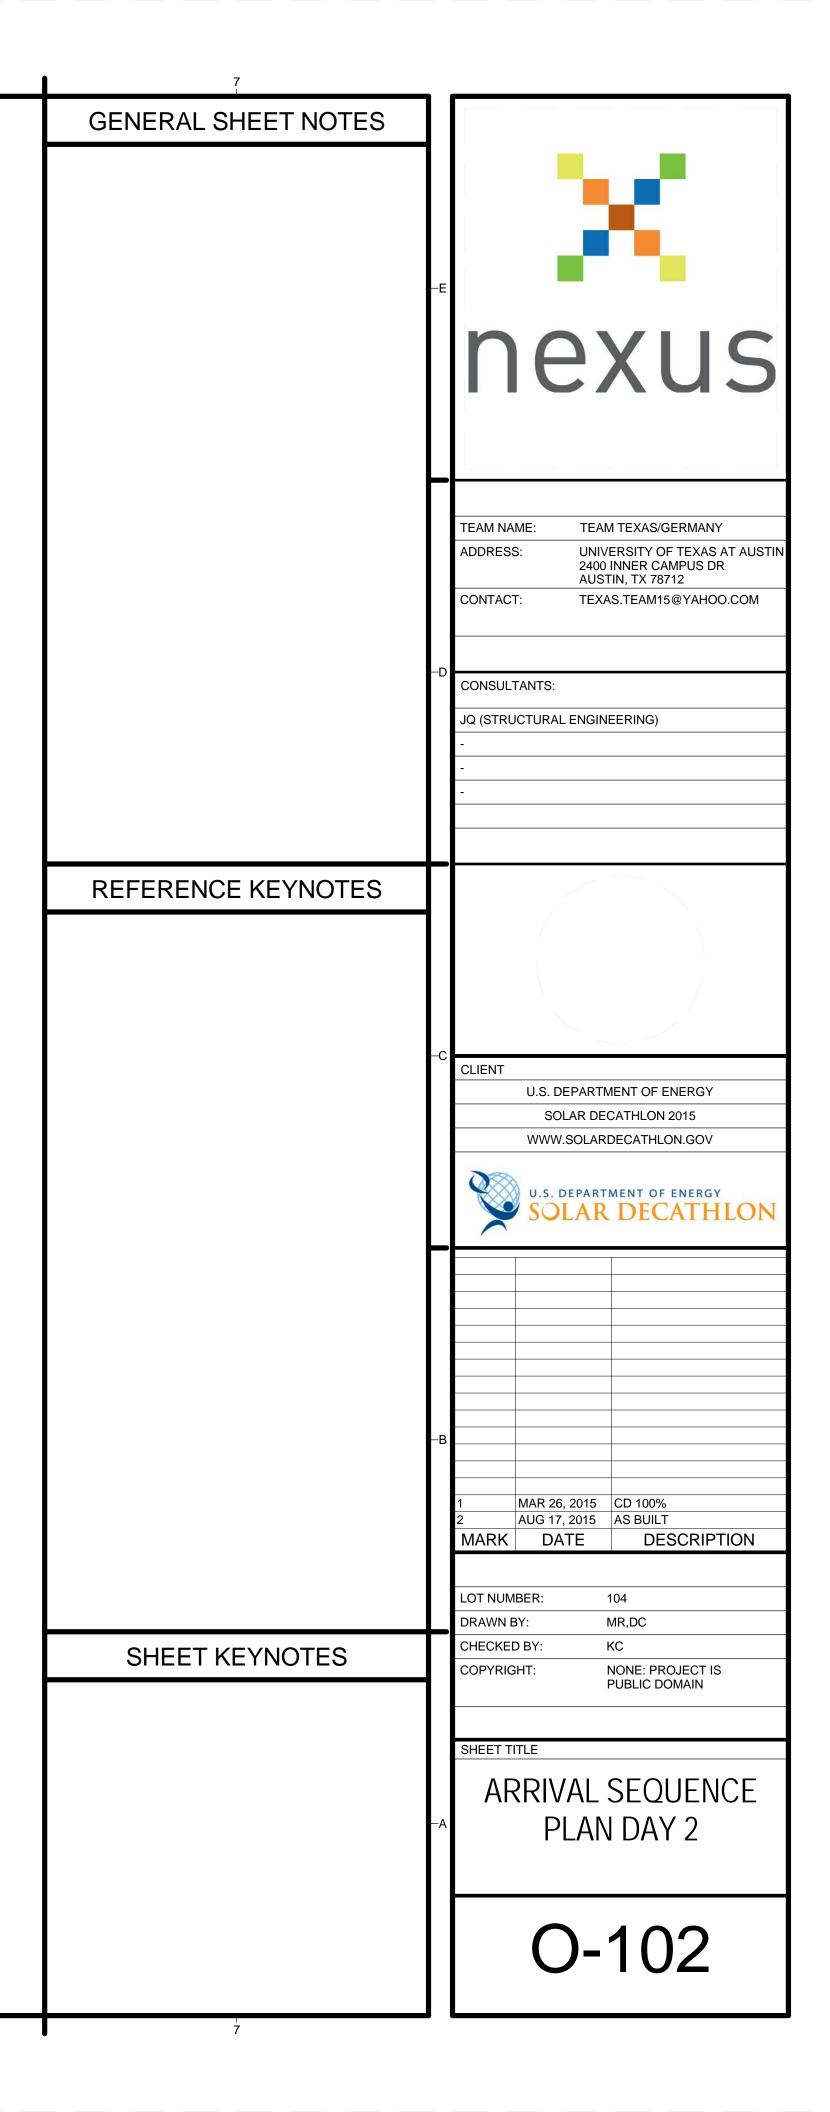

E-				×
		. 20'-0"	15'-0"	, 7'-10 1/2"
D-				
0				
C–				
6				
B–				
				 STEP 9 - SYSTEMS ASSEMBLY 1. Electrical systems set in place and hook 2. Test electrical systems 3. Mechanical systems set in place and hook 2. Test mechanical systems 3. Plumbing systems hooked up to house 4. Test plumbing systems
48 PM –				4. Test plumbing systems
8/17/2015 4:11:48 PM	1	2	l	3

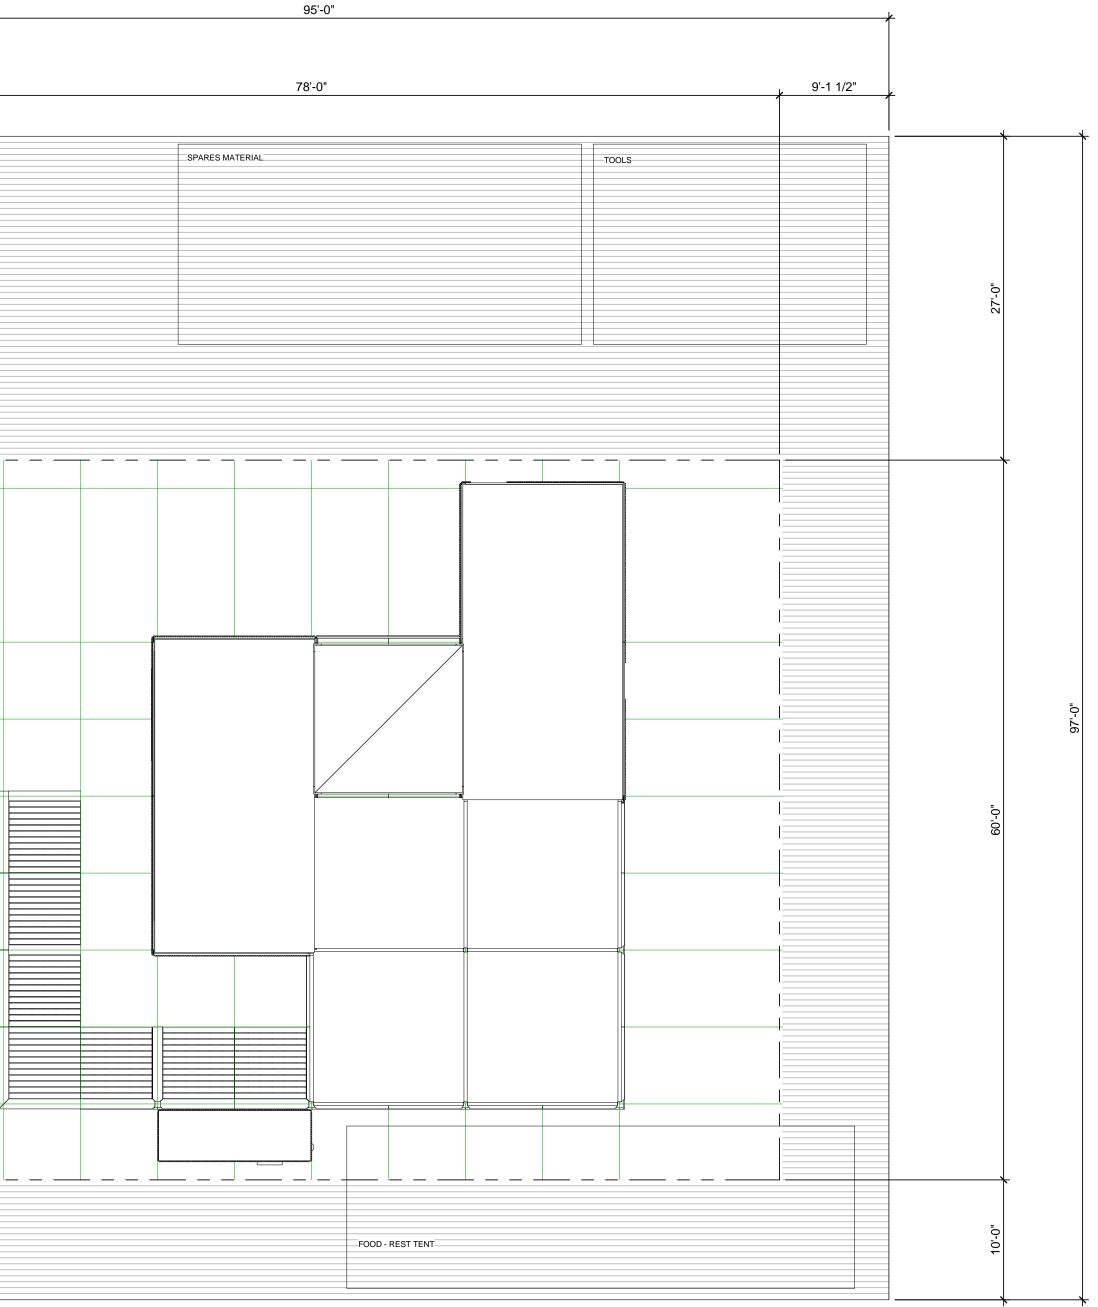





ooked up to house.

hooked up to house


4


ooked up to house

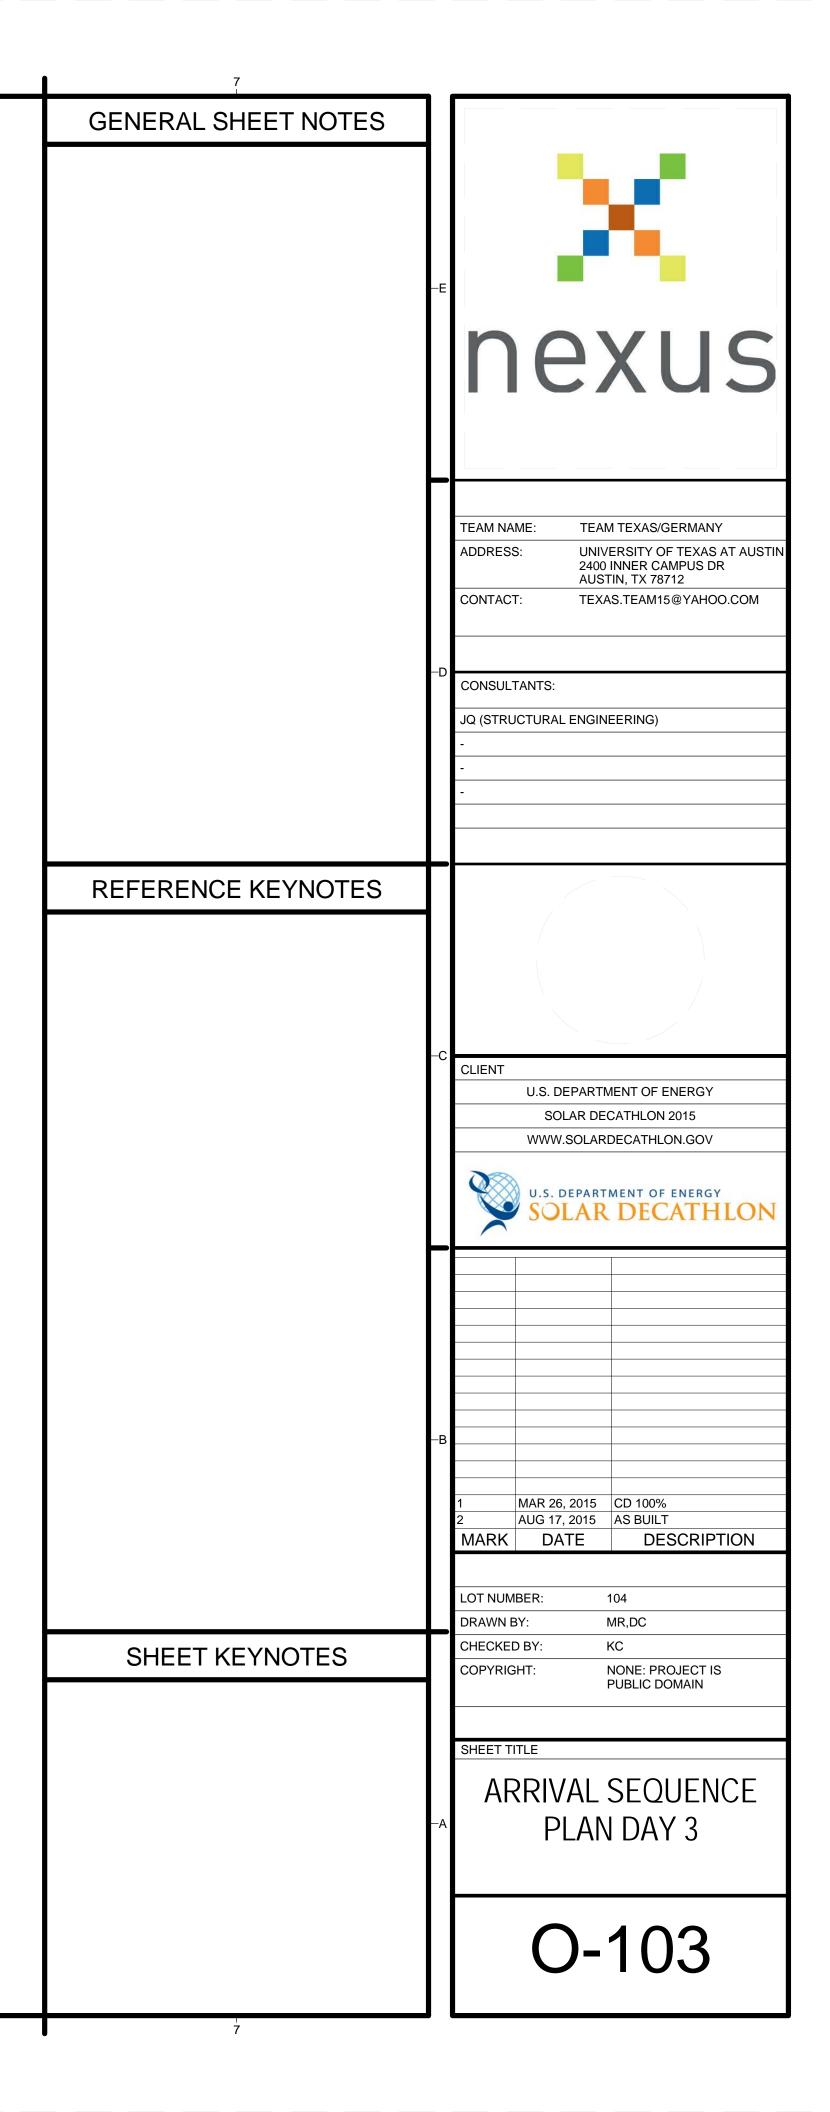


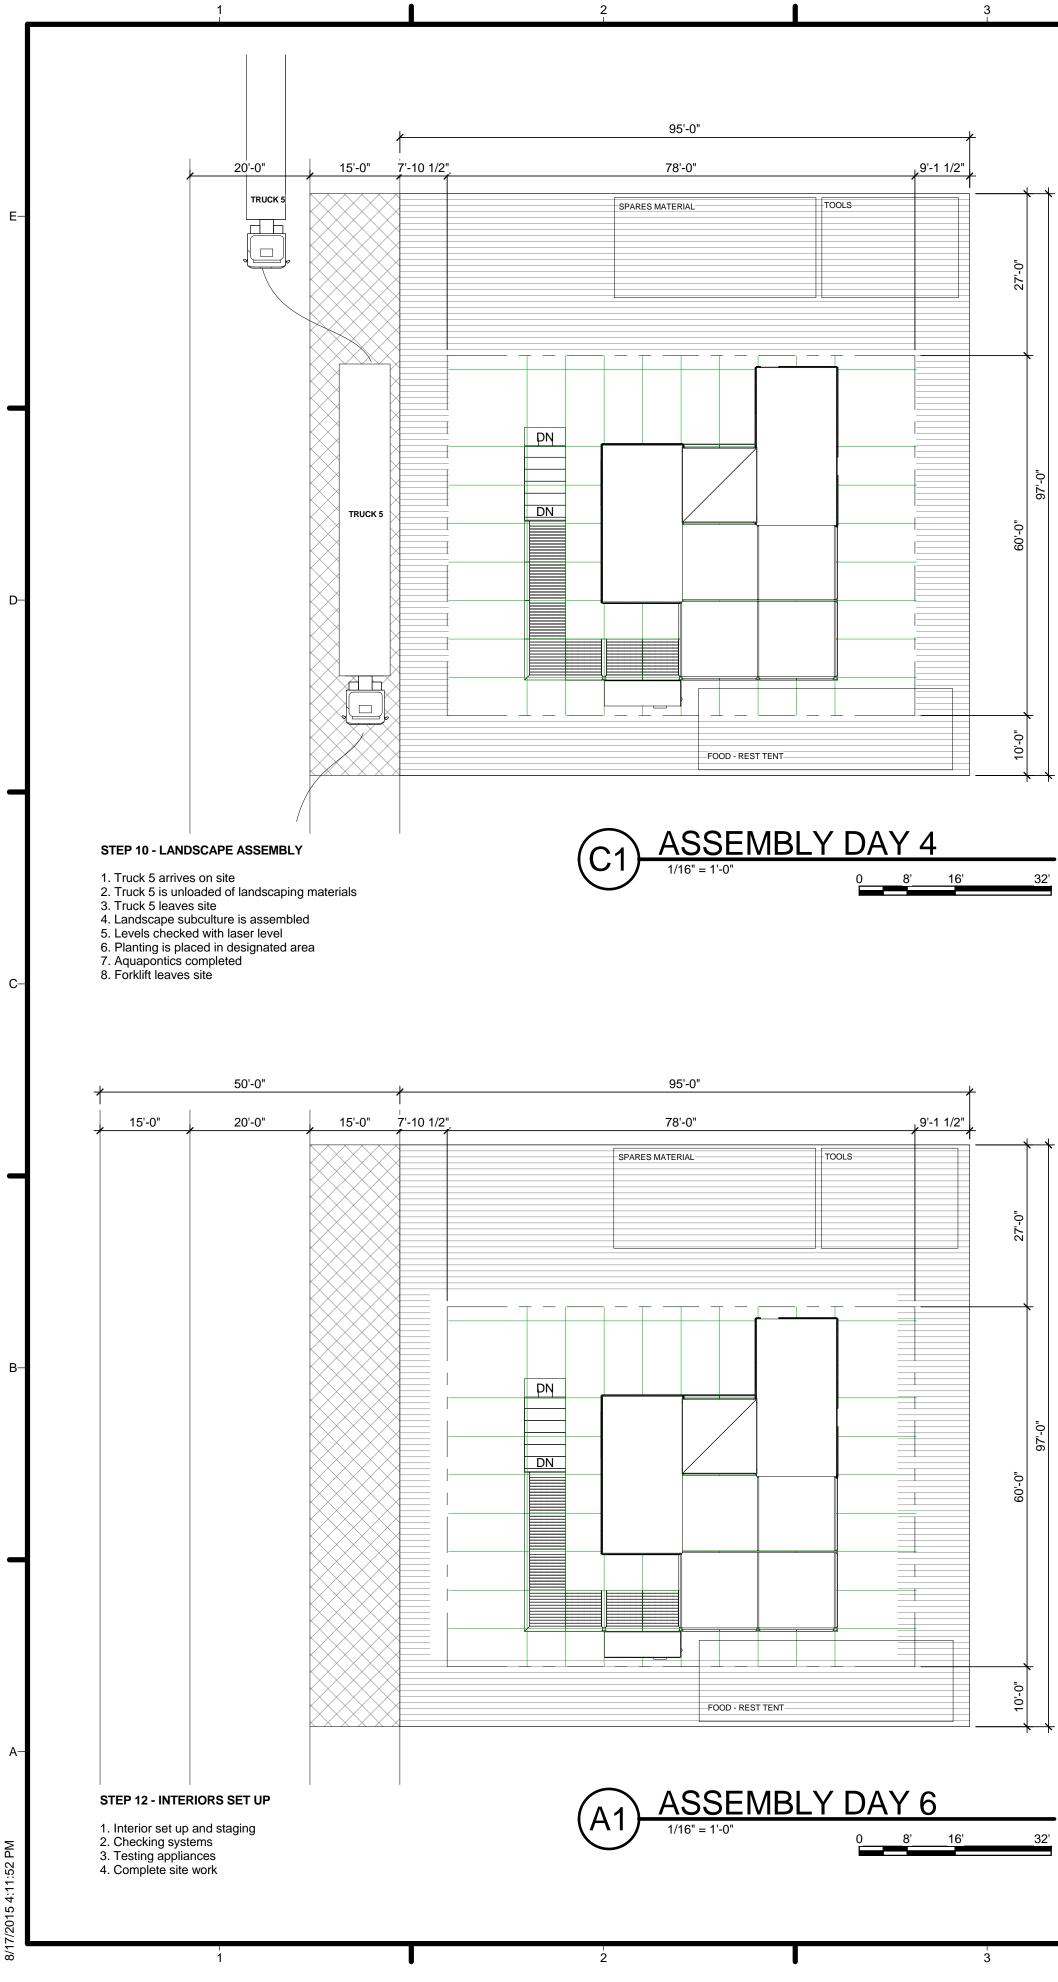


7/2015 4:11:

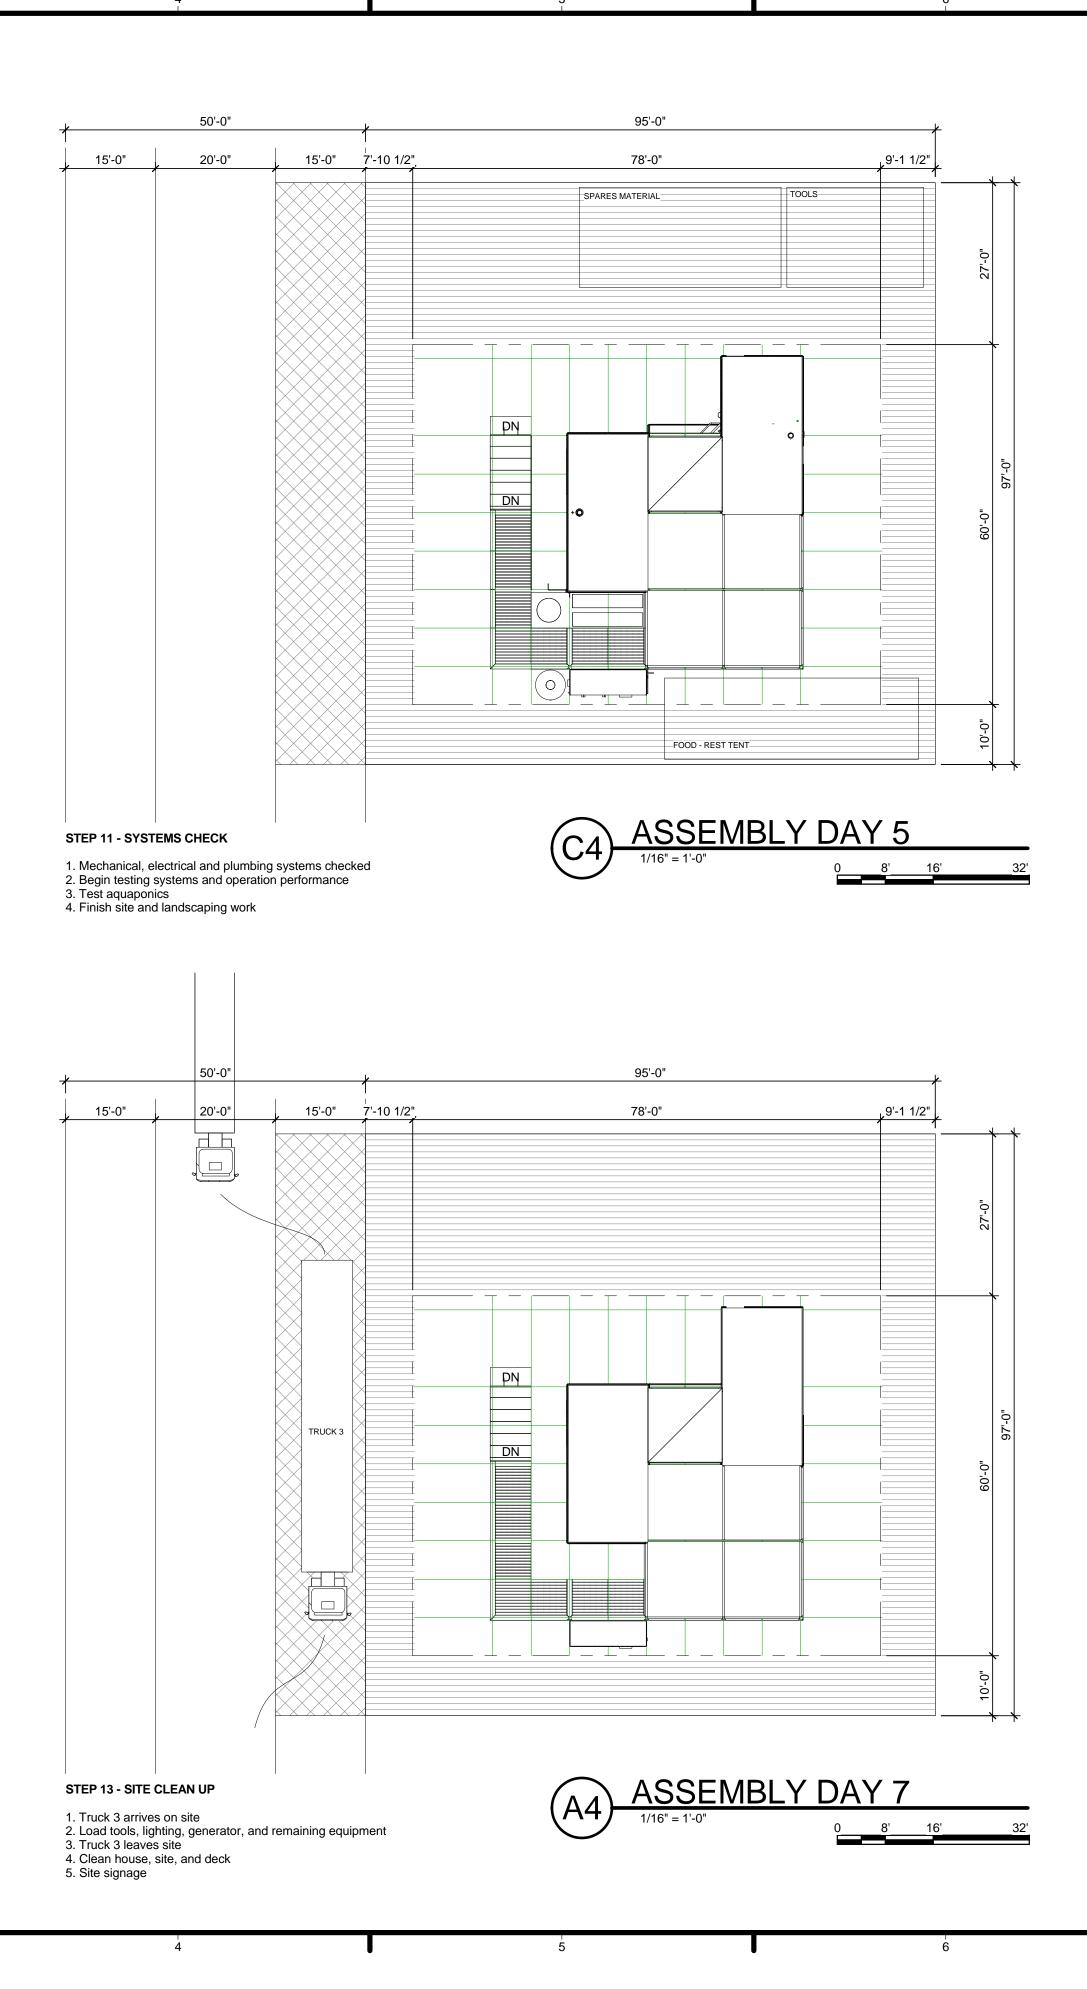

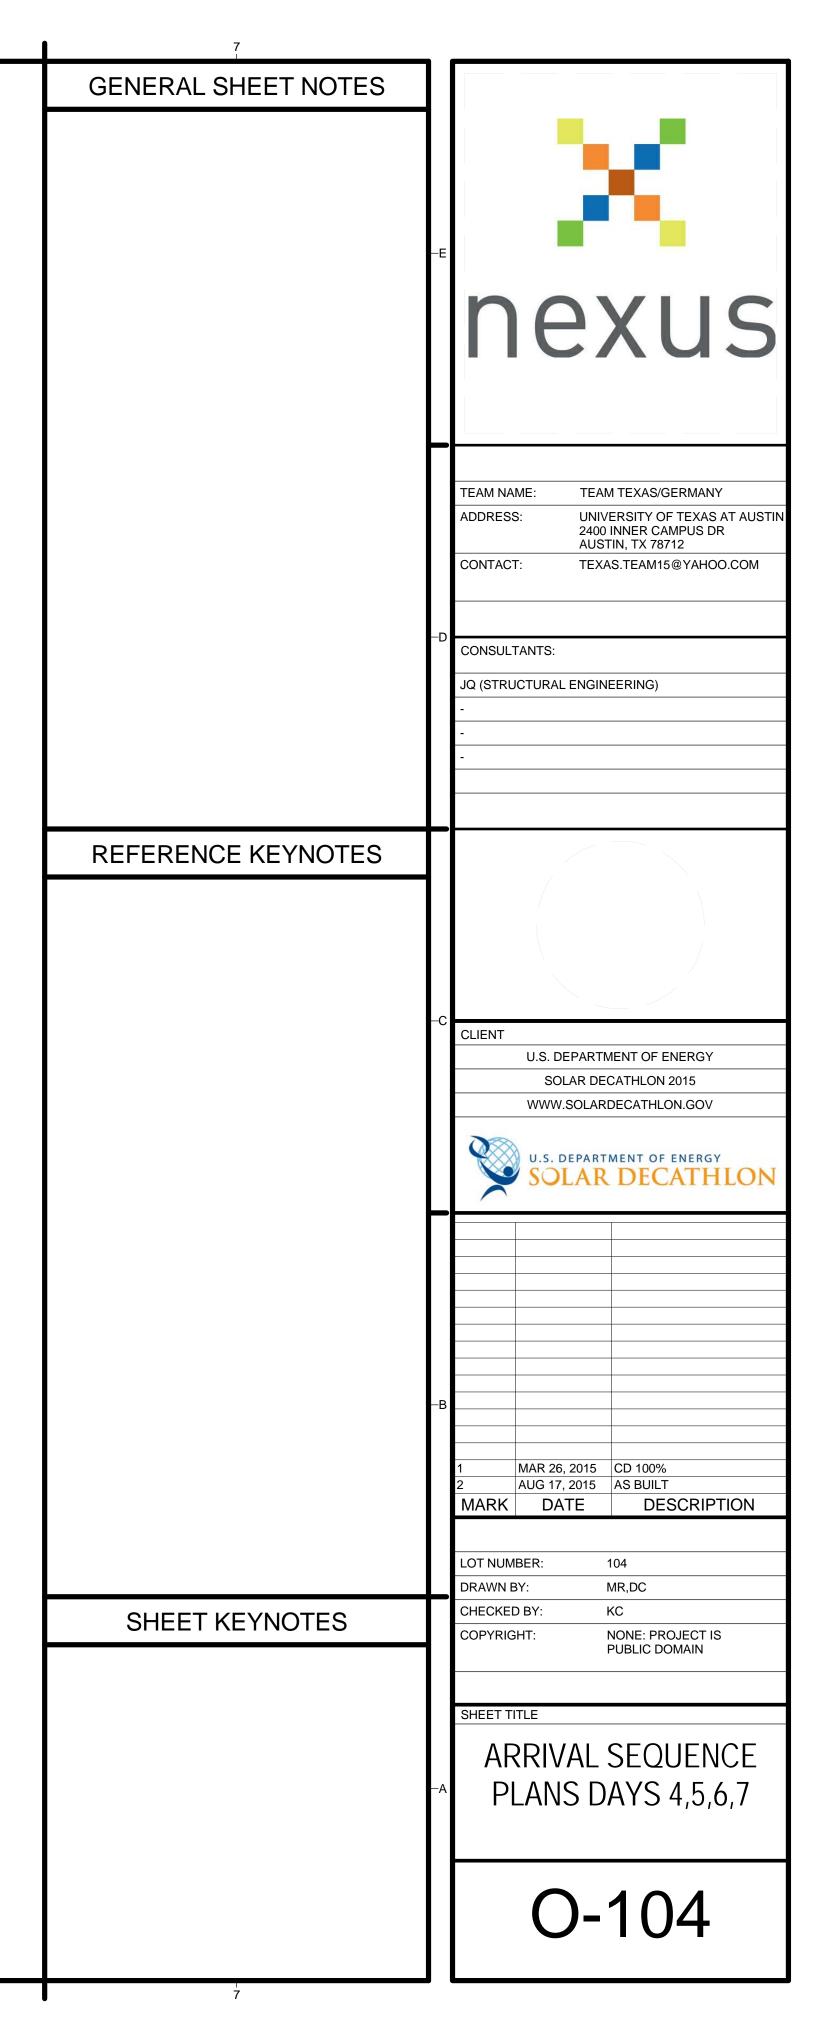

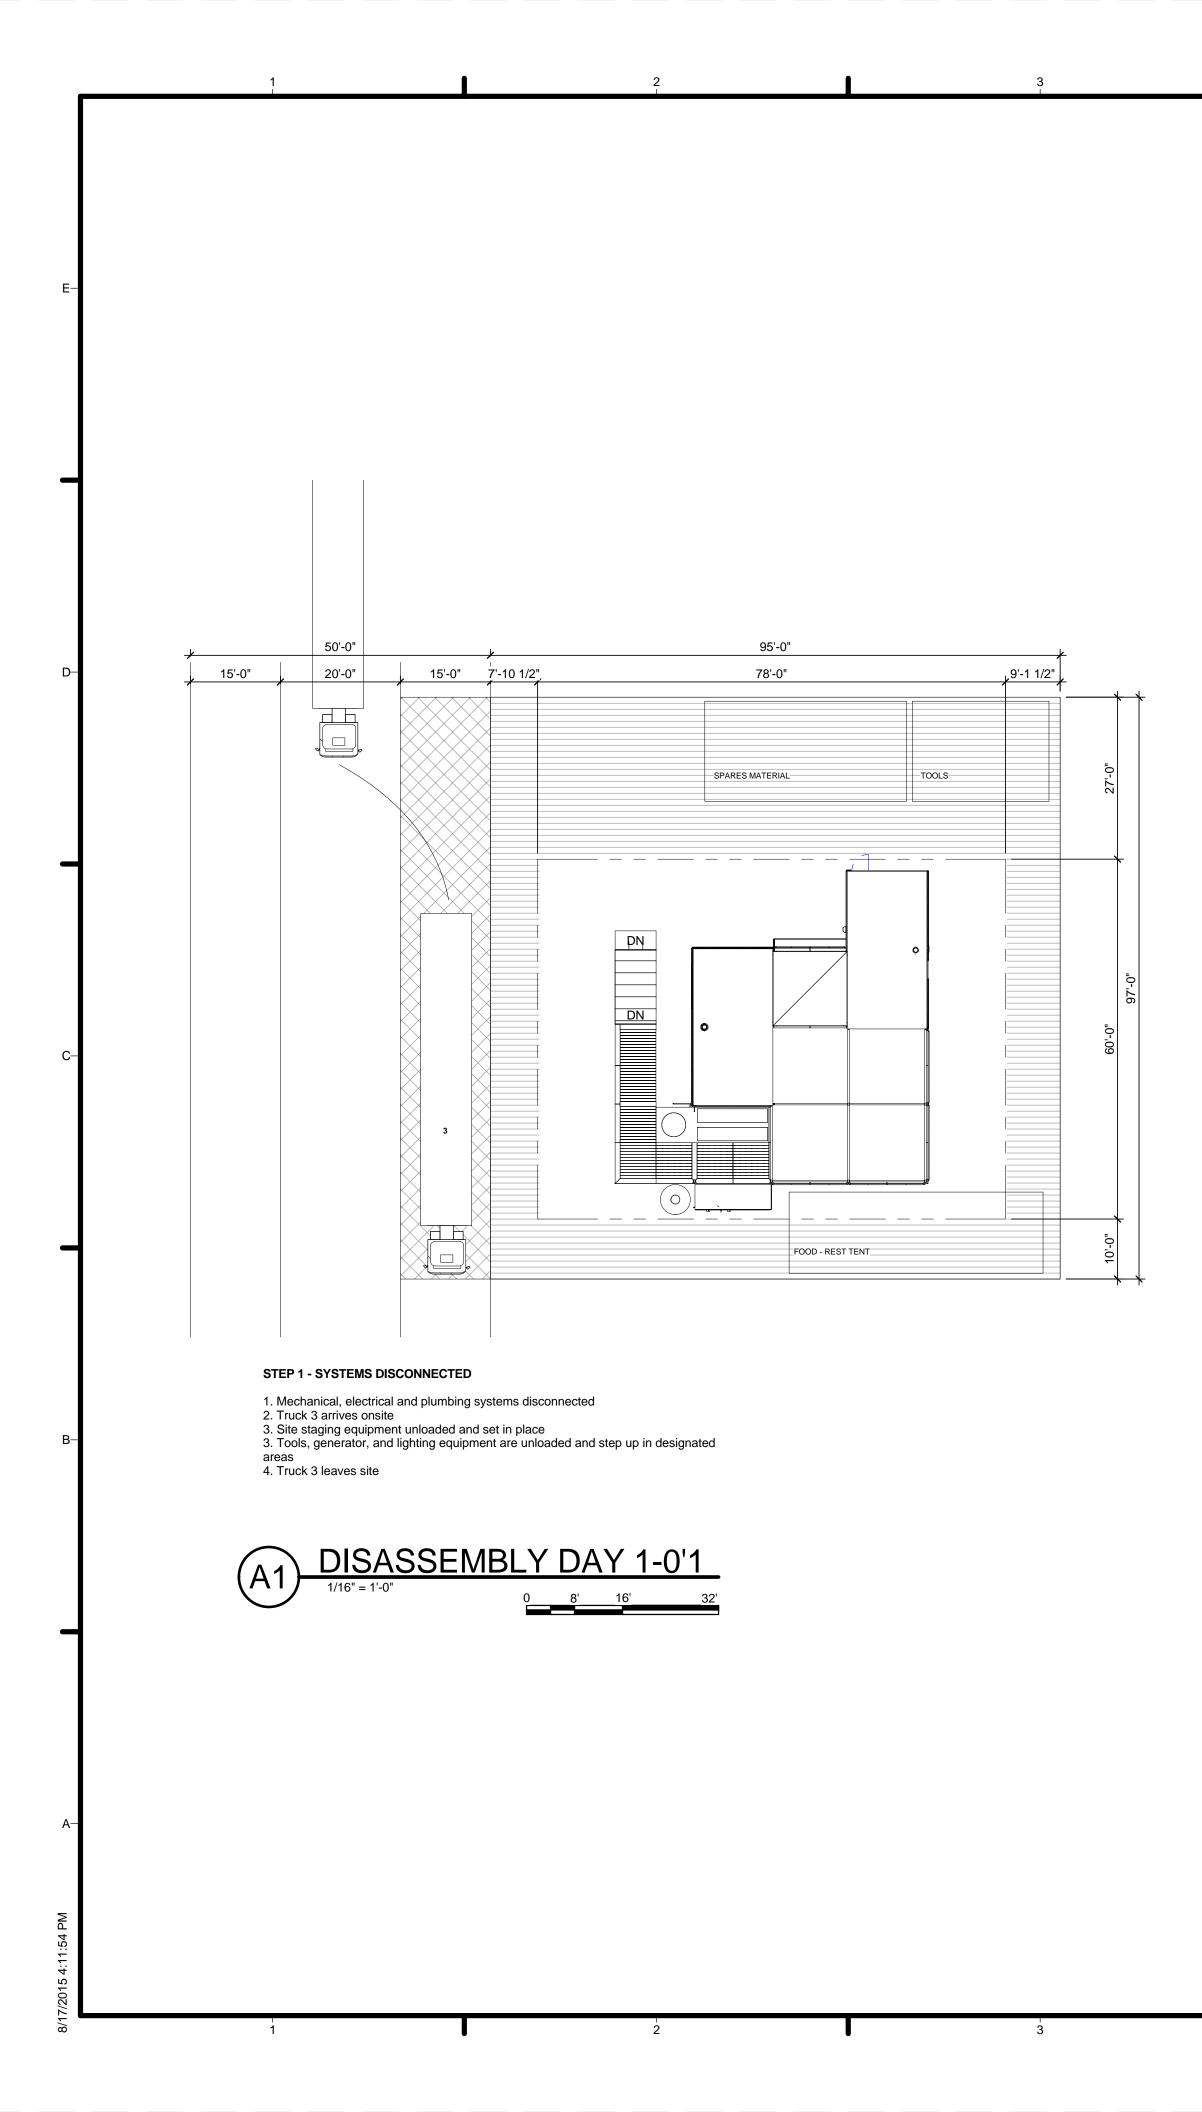

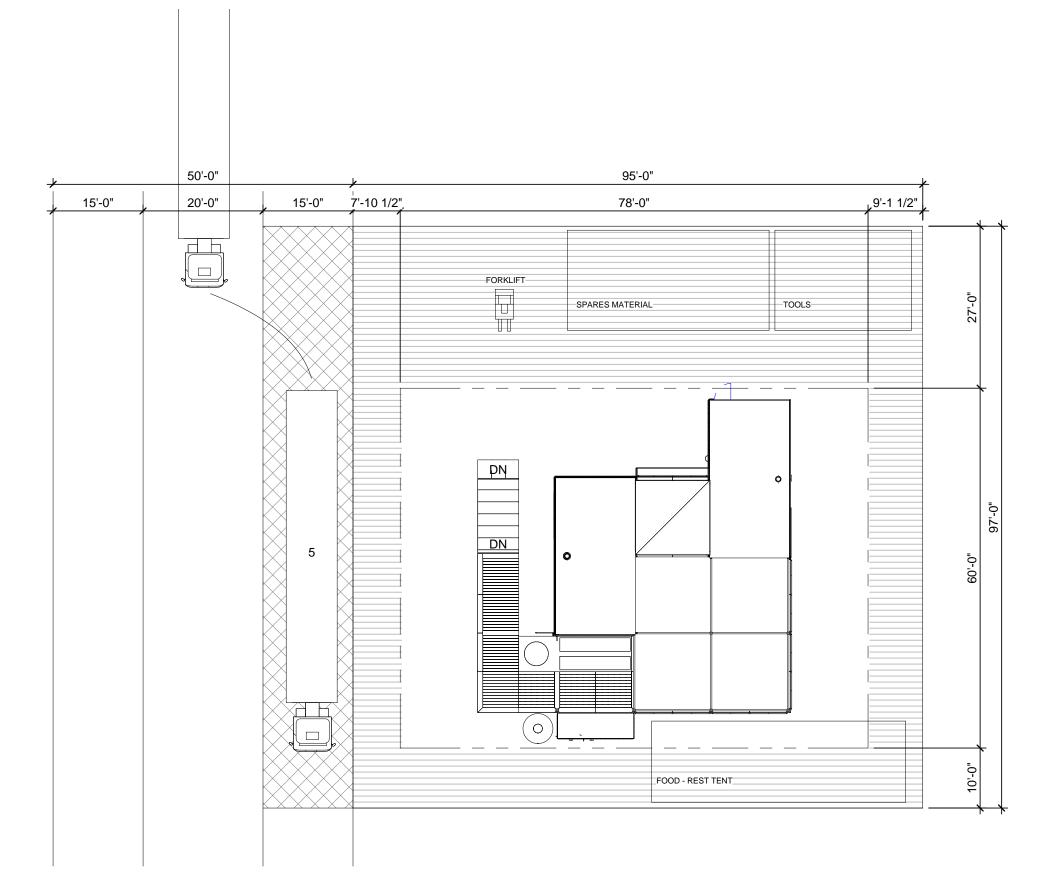



STEP 2 - LANDSCAPE AND PV PANEL DISMANTLING


- Forklift arrives on-site
 Landscape detached and stacked in designated area
 Aquaponics dismanteld and stored in designated area
 Truck 5 arrives on site for landscaping

- Truck 5 arrives of site for faildscaping
 Truck 5 is loaded and leaves site
 Scaffolding set in place and checked for removal of PV
 PV panels detached from PV substructure
 PV panels package for transport



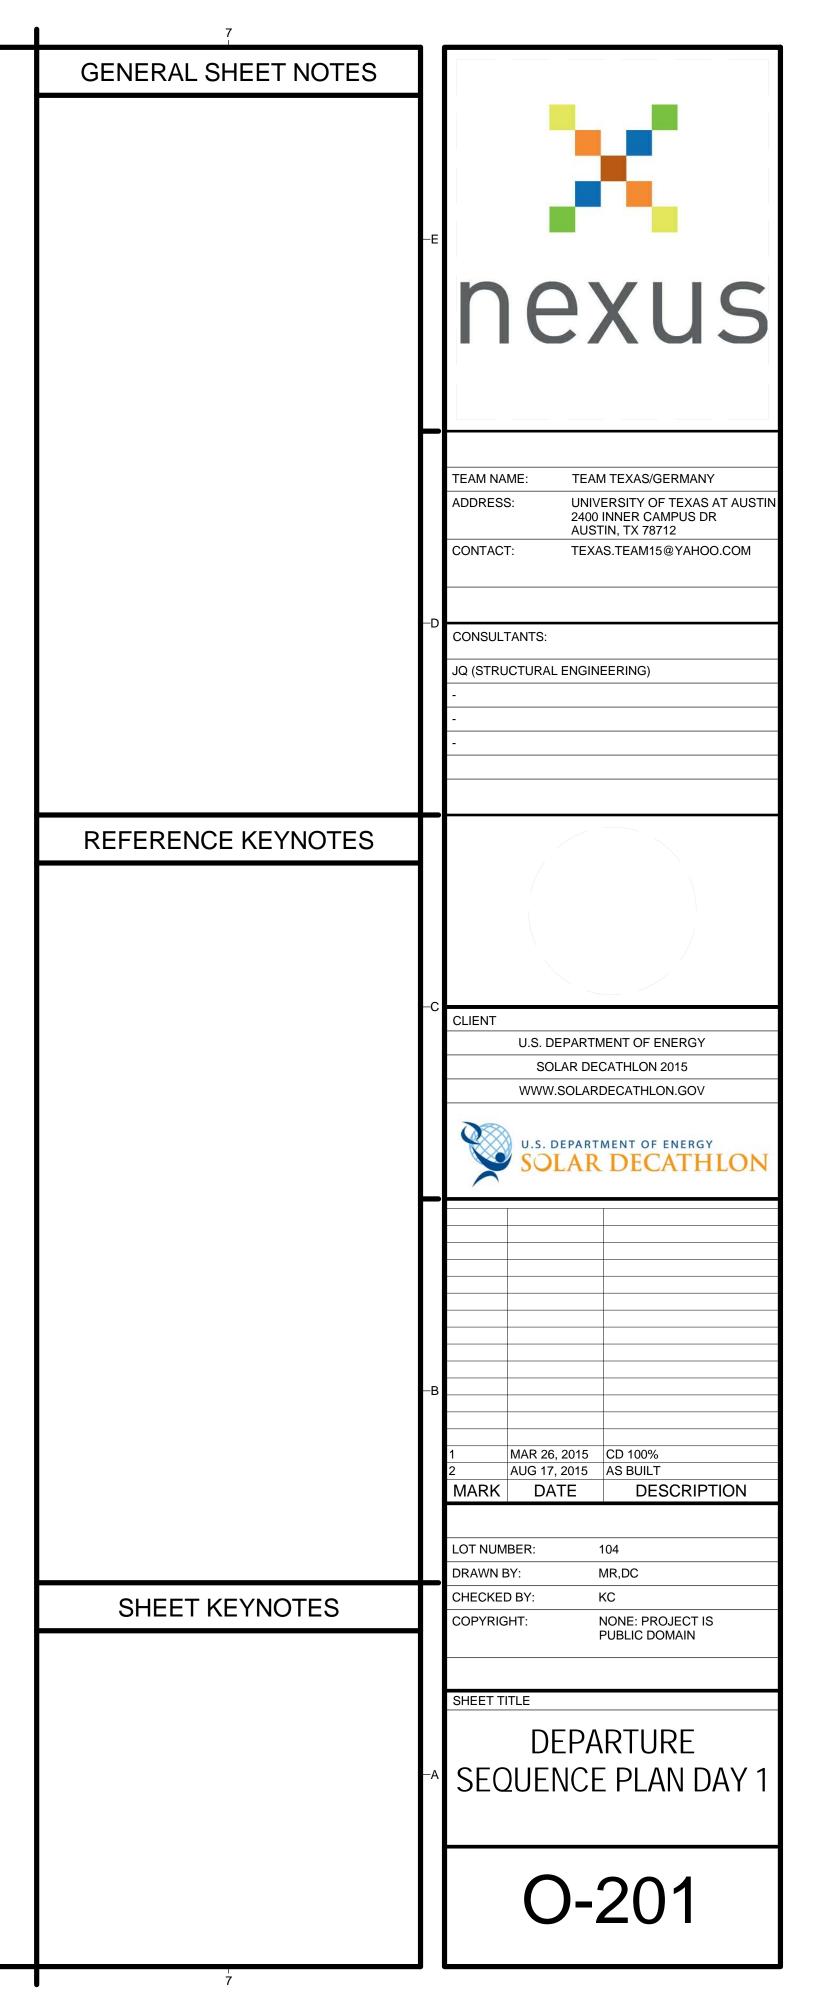

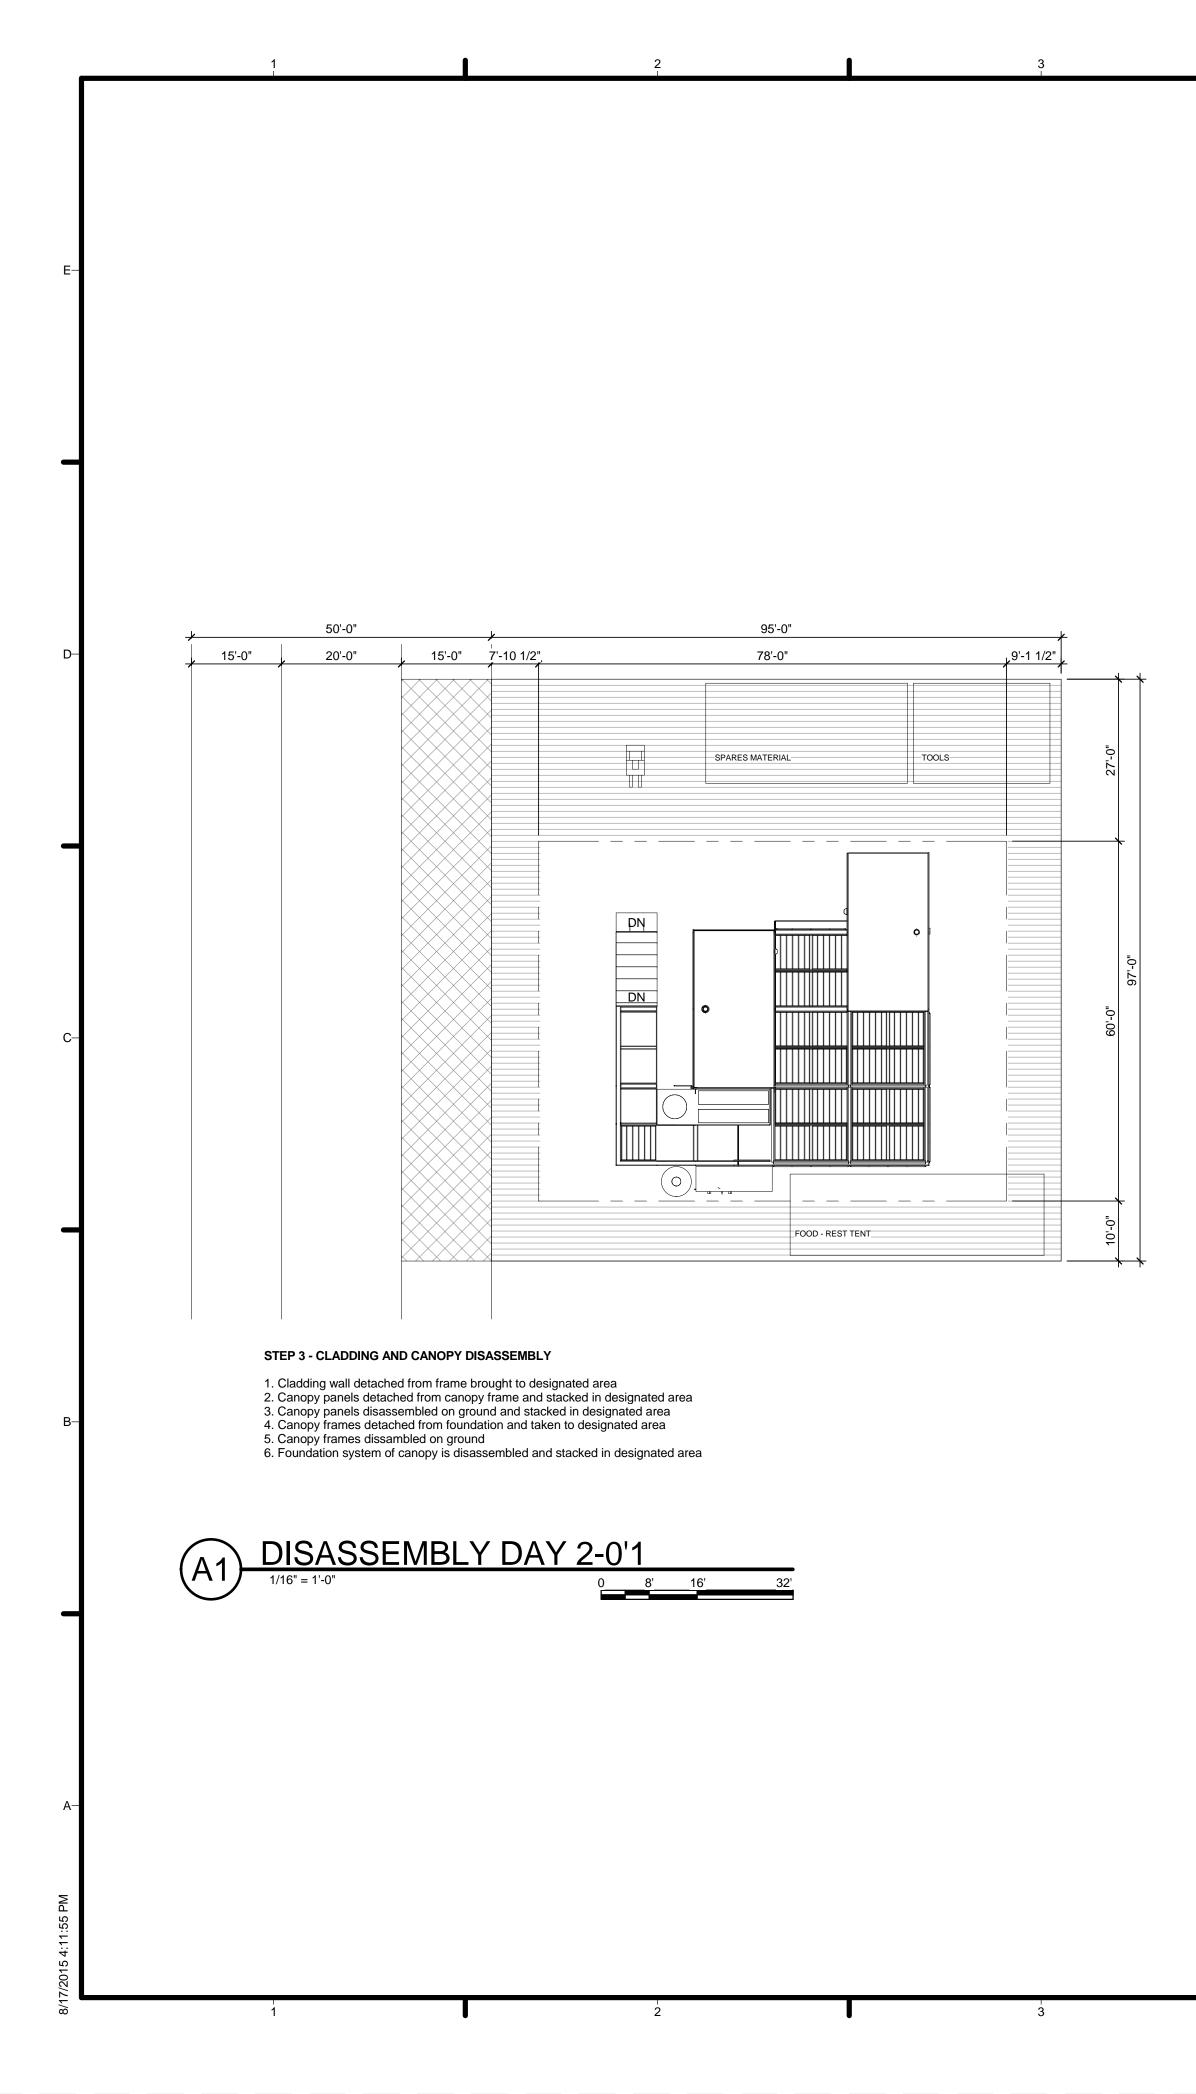

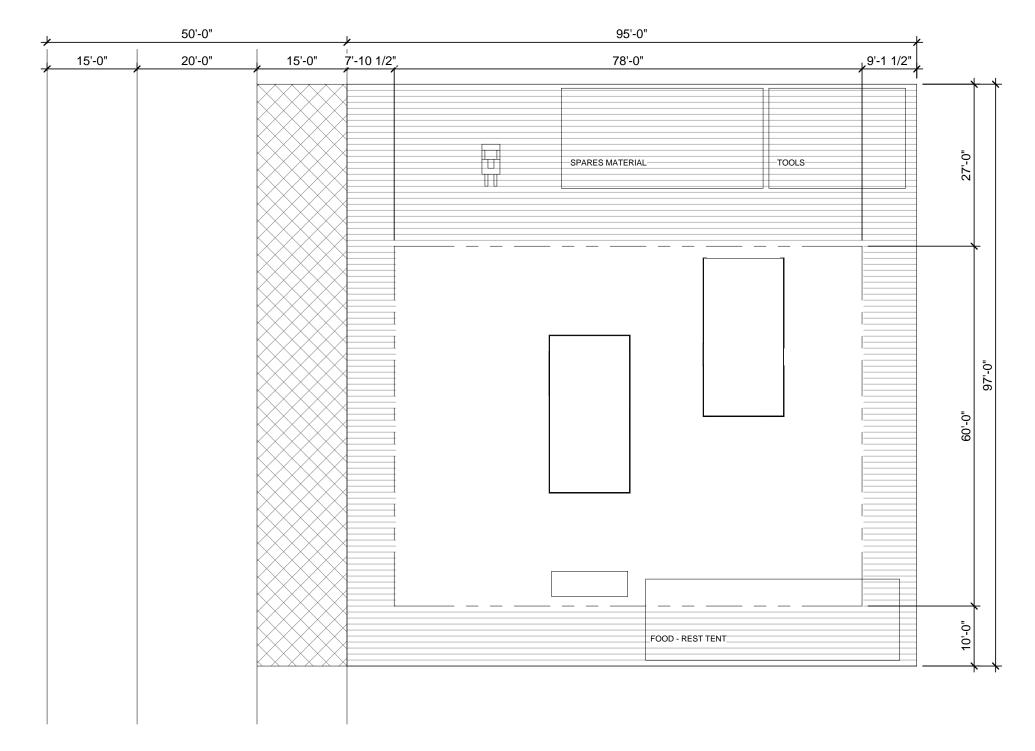



STEP 4 - DECK REMOVAL

4

Handrails are removed and stached in designated area
 Deck panels detached from foundation and taken to designated area
 Deck foundation disassembled and stacked in designated area




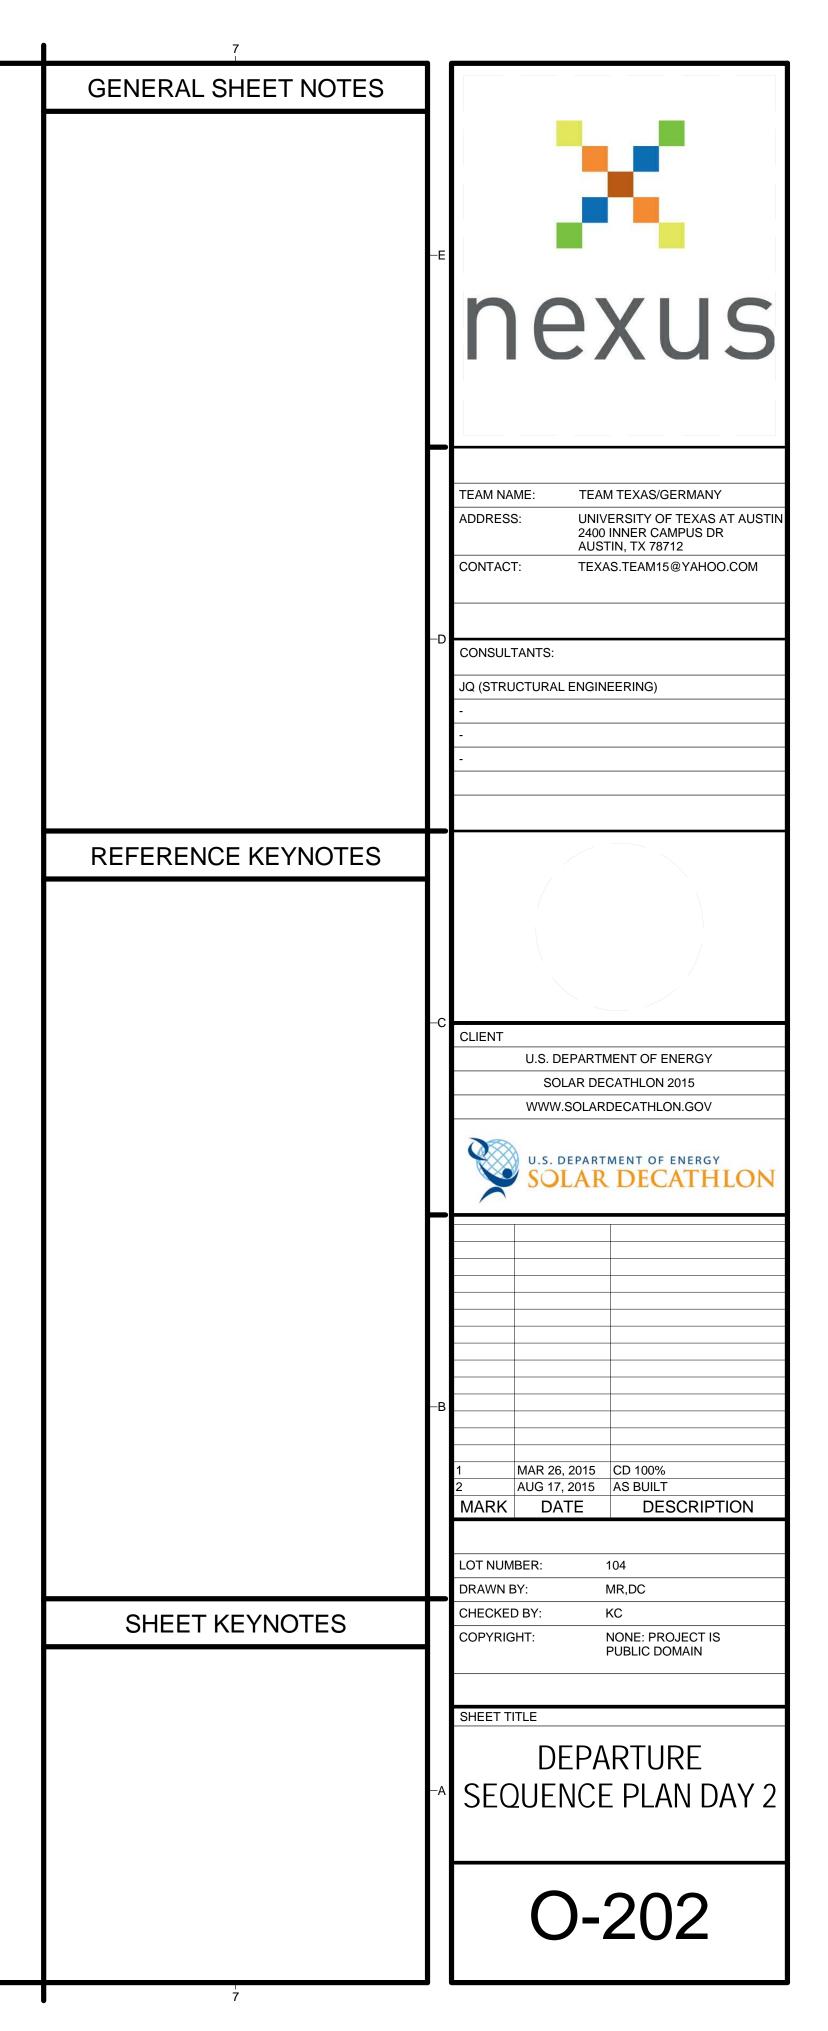

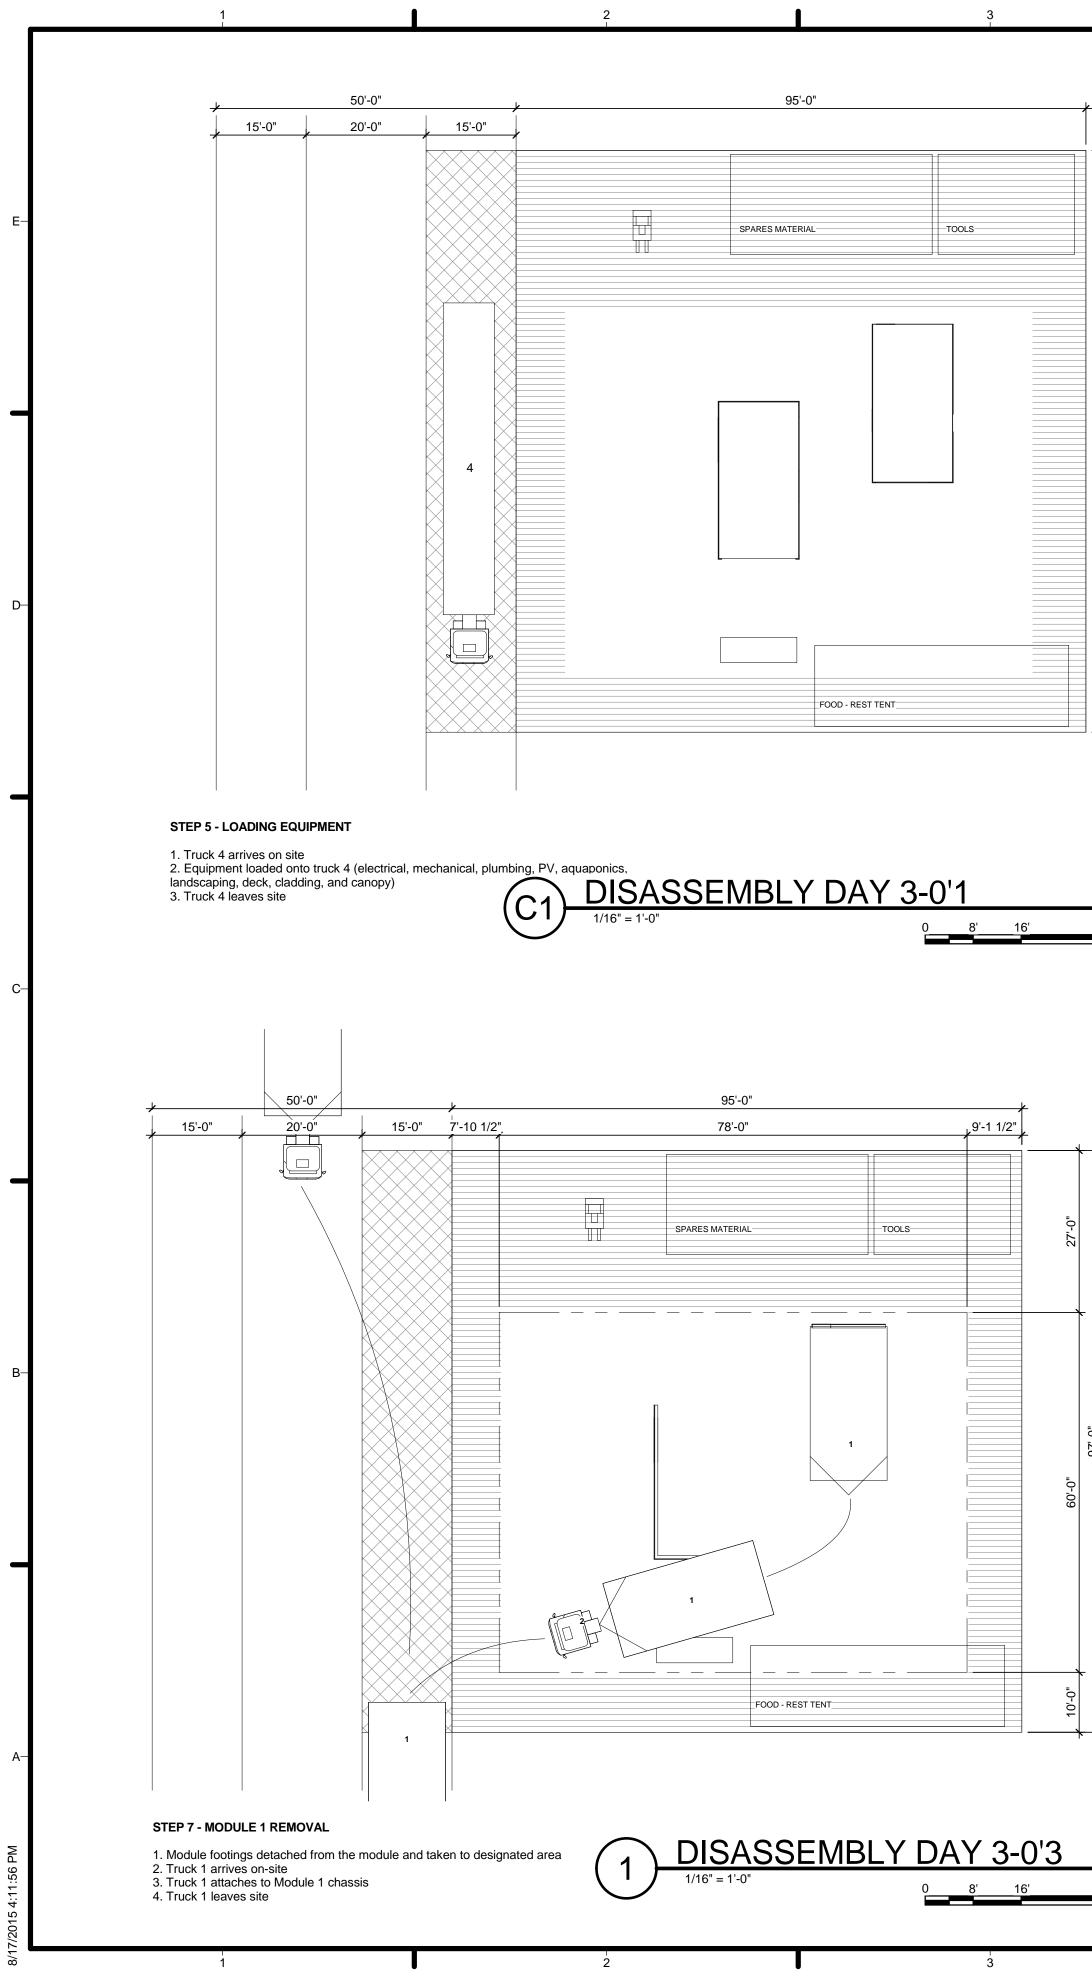





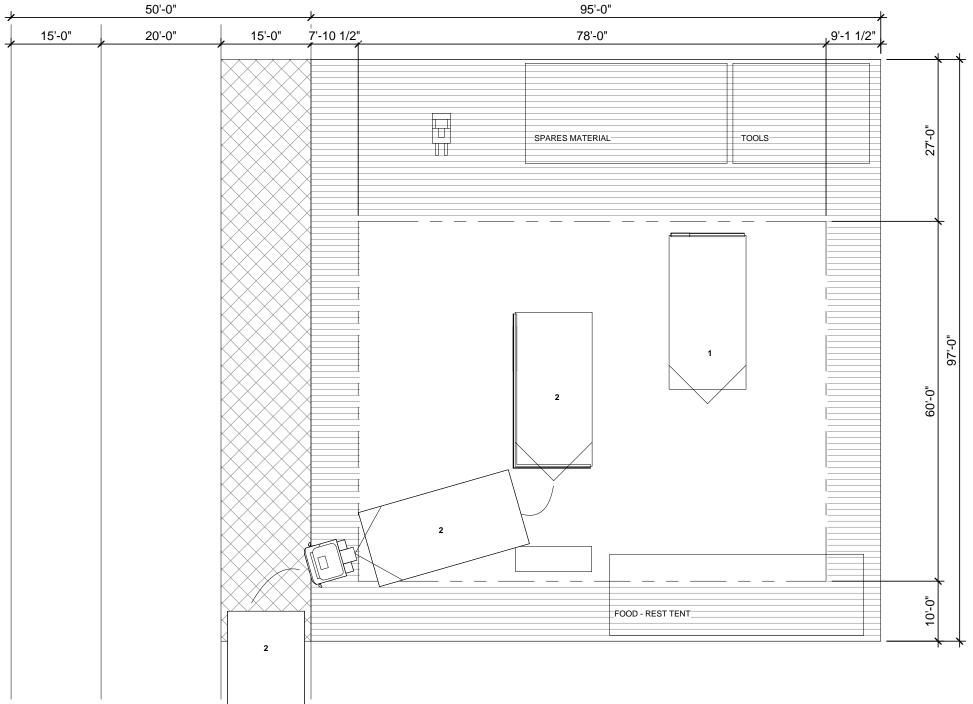

6

STEP 6 - MODULE 2 REMOVAL


4


1. Footing detached from the module and taken to designated area 2. Truck 2 arrives on site

Truck 2 attaches to module 2 (day) chassis
 Truck 2 leaves site

C4 DISASSEMBLY DAY 3-0'2

"O-" _ O

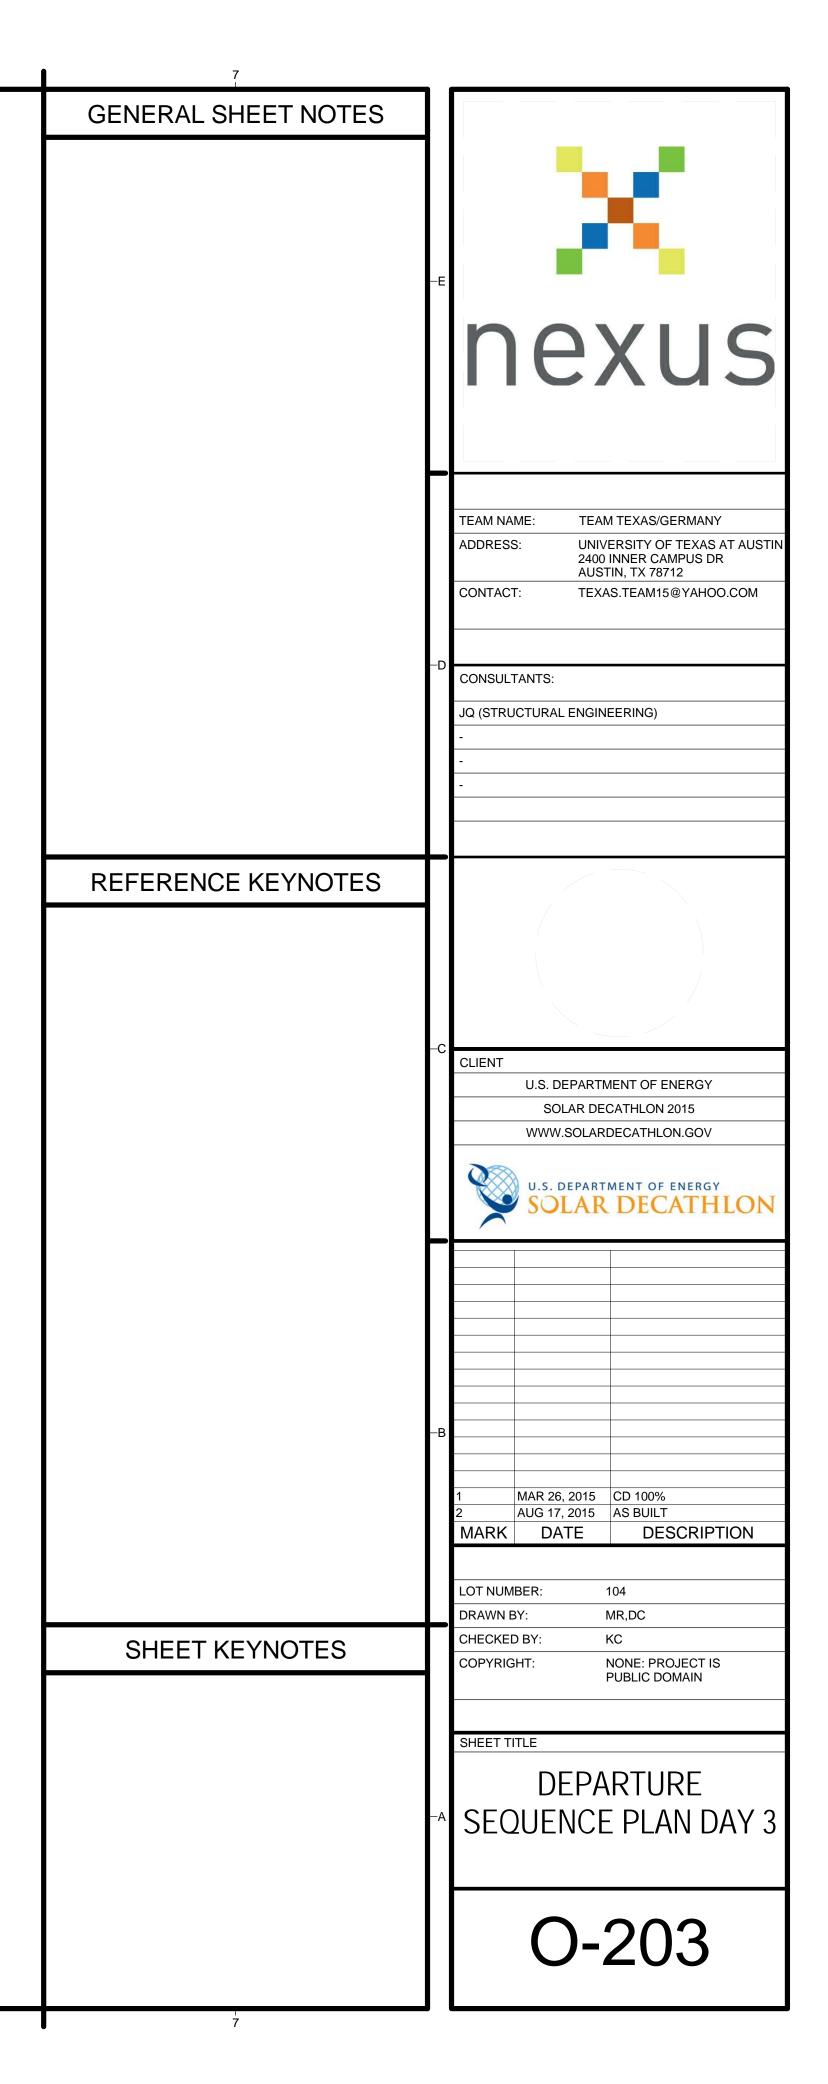

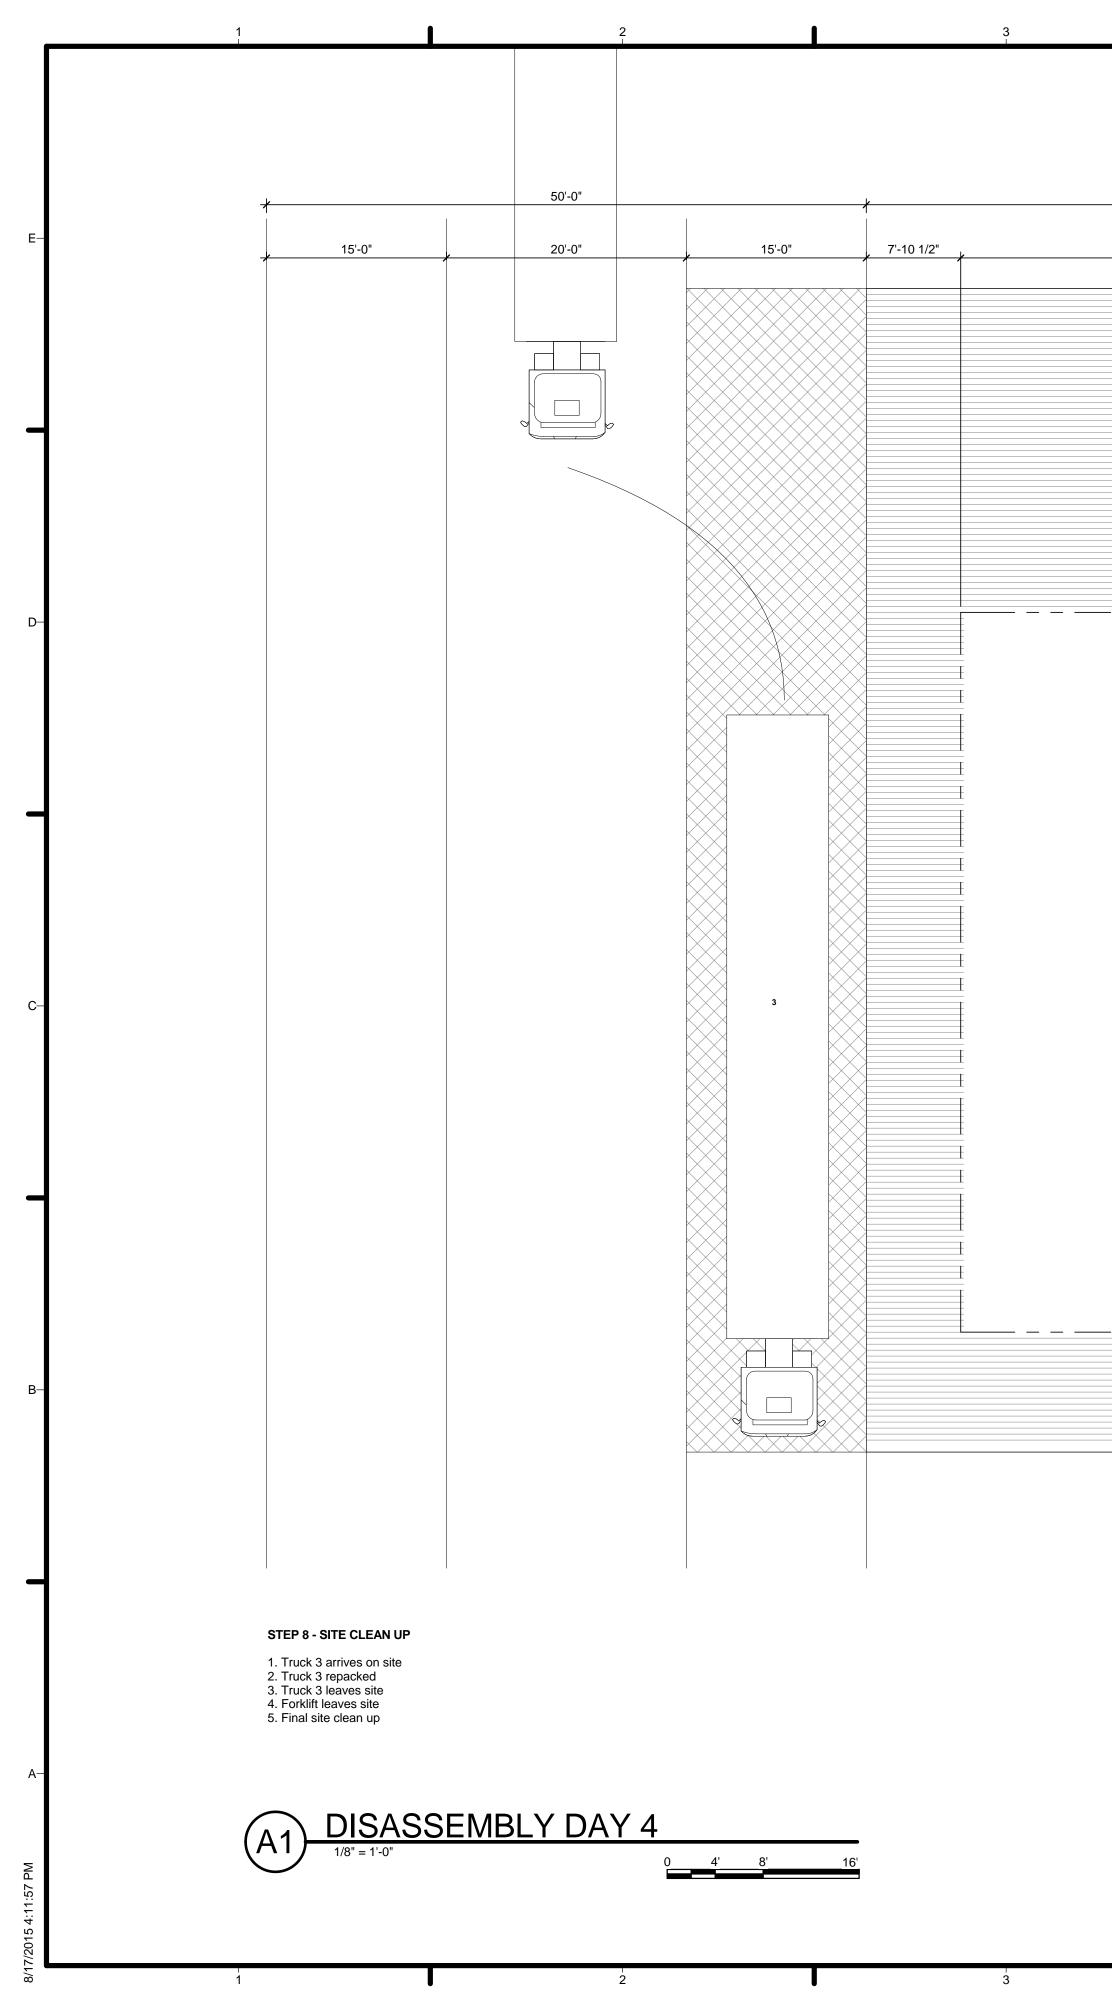

		95'-0"
	. 9'-1 1/2"	 78'-0"
	-	
27'-0"		
-0-0		
00		
10'-0"		

