

TEAM CAPIT

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TOL DC SOL PROJECT INFOR	AR DECATHLON 2013		1120 CON AVENUE, I WASHING TEL: 202.7 MEP ENGINE ARUP ENG 1120 CON AVENUE, WASHING TEL: 202.7	NECTICUT NW., SUITE TON, DC 20 29.8220 ER GINEERING NECTICUT NW., SUITE TON, DC 20 29.8220 DF RECOR	200 0036 200 0036
PROJECT NAME: LOCATION:	HARVEST ORANGE COUNTY NATIONAL GREAT PARK IRVINE, CA		WILLIAM J 620 MICHI CROUGH WASHING TEL: 202.3	ELEN, AIA GAN AVE N CENTER TON, DC 20	IE
OCCUPANCY: CONSTRUCTION TYPE: BUILDING TYPE: DESIGN TEAM:	RESIDENTIAL TYPE V NEW SINGLE STORY MODULAR HOME THE CATHOLIC UNIVERSITY OF AMERICA GEORGE WASHINGTON UNIVERSITY AMERICAN UNIVERSITY	-c -			
FACULTY PROJECT COORDINATOR: PROJECT MANAGER: ARCHITECTURE PROJECT MANAGER: PROJECT ENGINEER:	BILL JELEN ROBERT BLABOLIL JEREMY HAAK LAUREN WINGO		w	SOLAR DI WW.SOLAI	MENT OF ENERGY ECATHLON 2013 RDECATHLON.GOV
CONSTRUCTION MANAGER:	KYLE NOELL				
		—В 4 3 2 1 1	201 201	3.08.22 3.02.04 2.11.20 2.10.11 DATE	As-Built Submission 100% CD Submission 80% DD Revisions 80% DD Submission DESCRIPTION
		[LOT NUMBER DRAWN BY: CHECKED BY COPYRIGHT:		115 TEAM CAPITOL DC TEAM CAPITOL DC NONE: PROJECT IS PUBLIC DOMAIN
		_A	SHEET TITLE		R SHEET
	6 ¹ 7		C	CS	-001

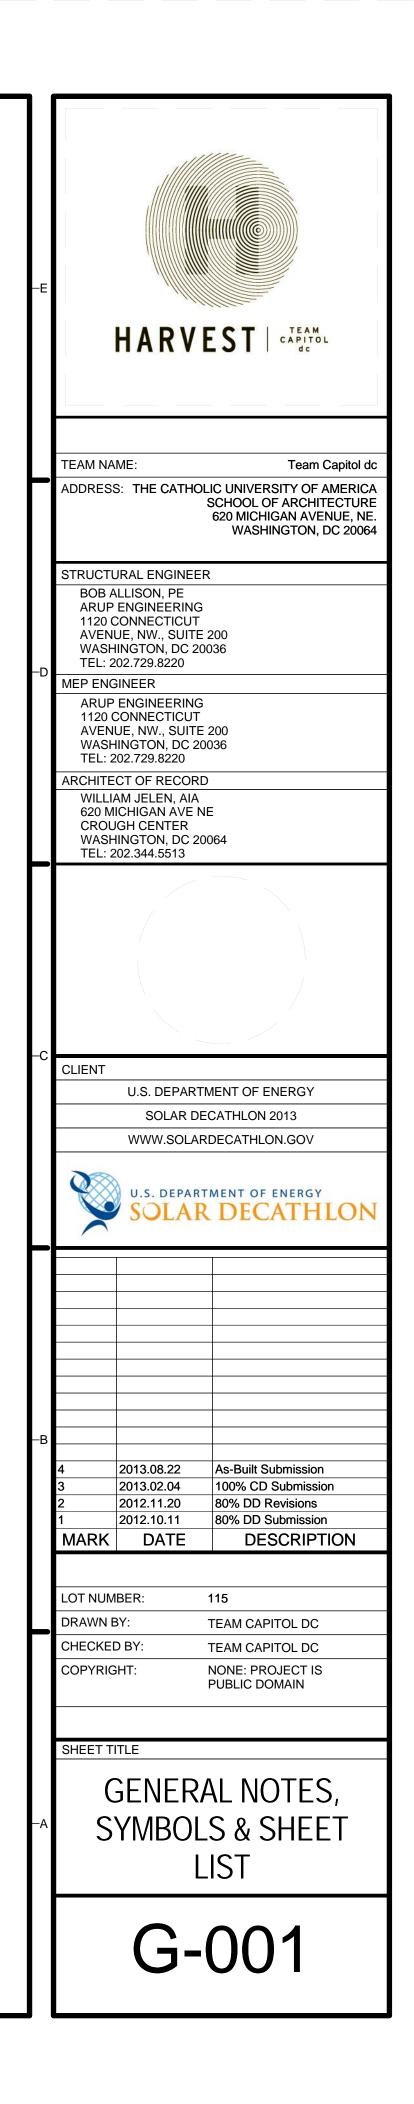
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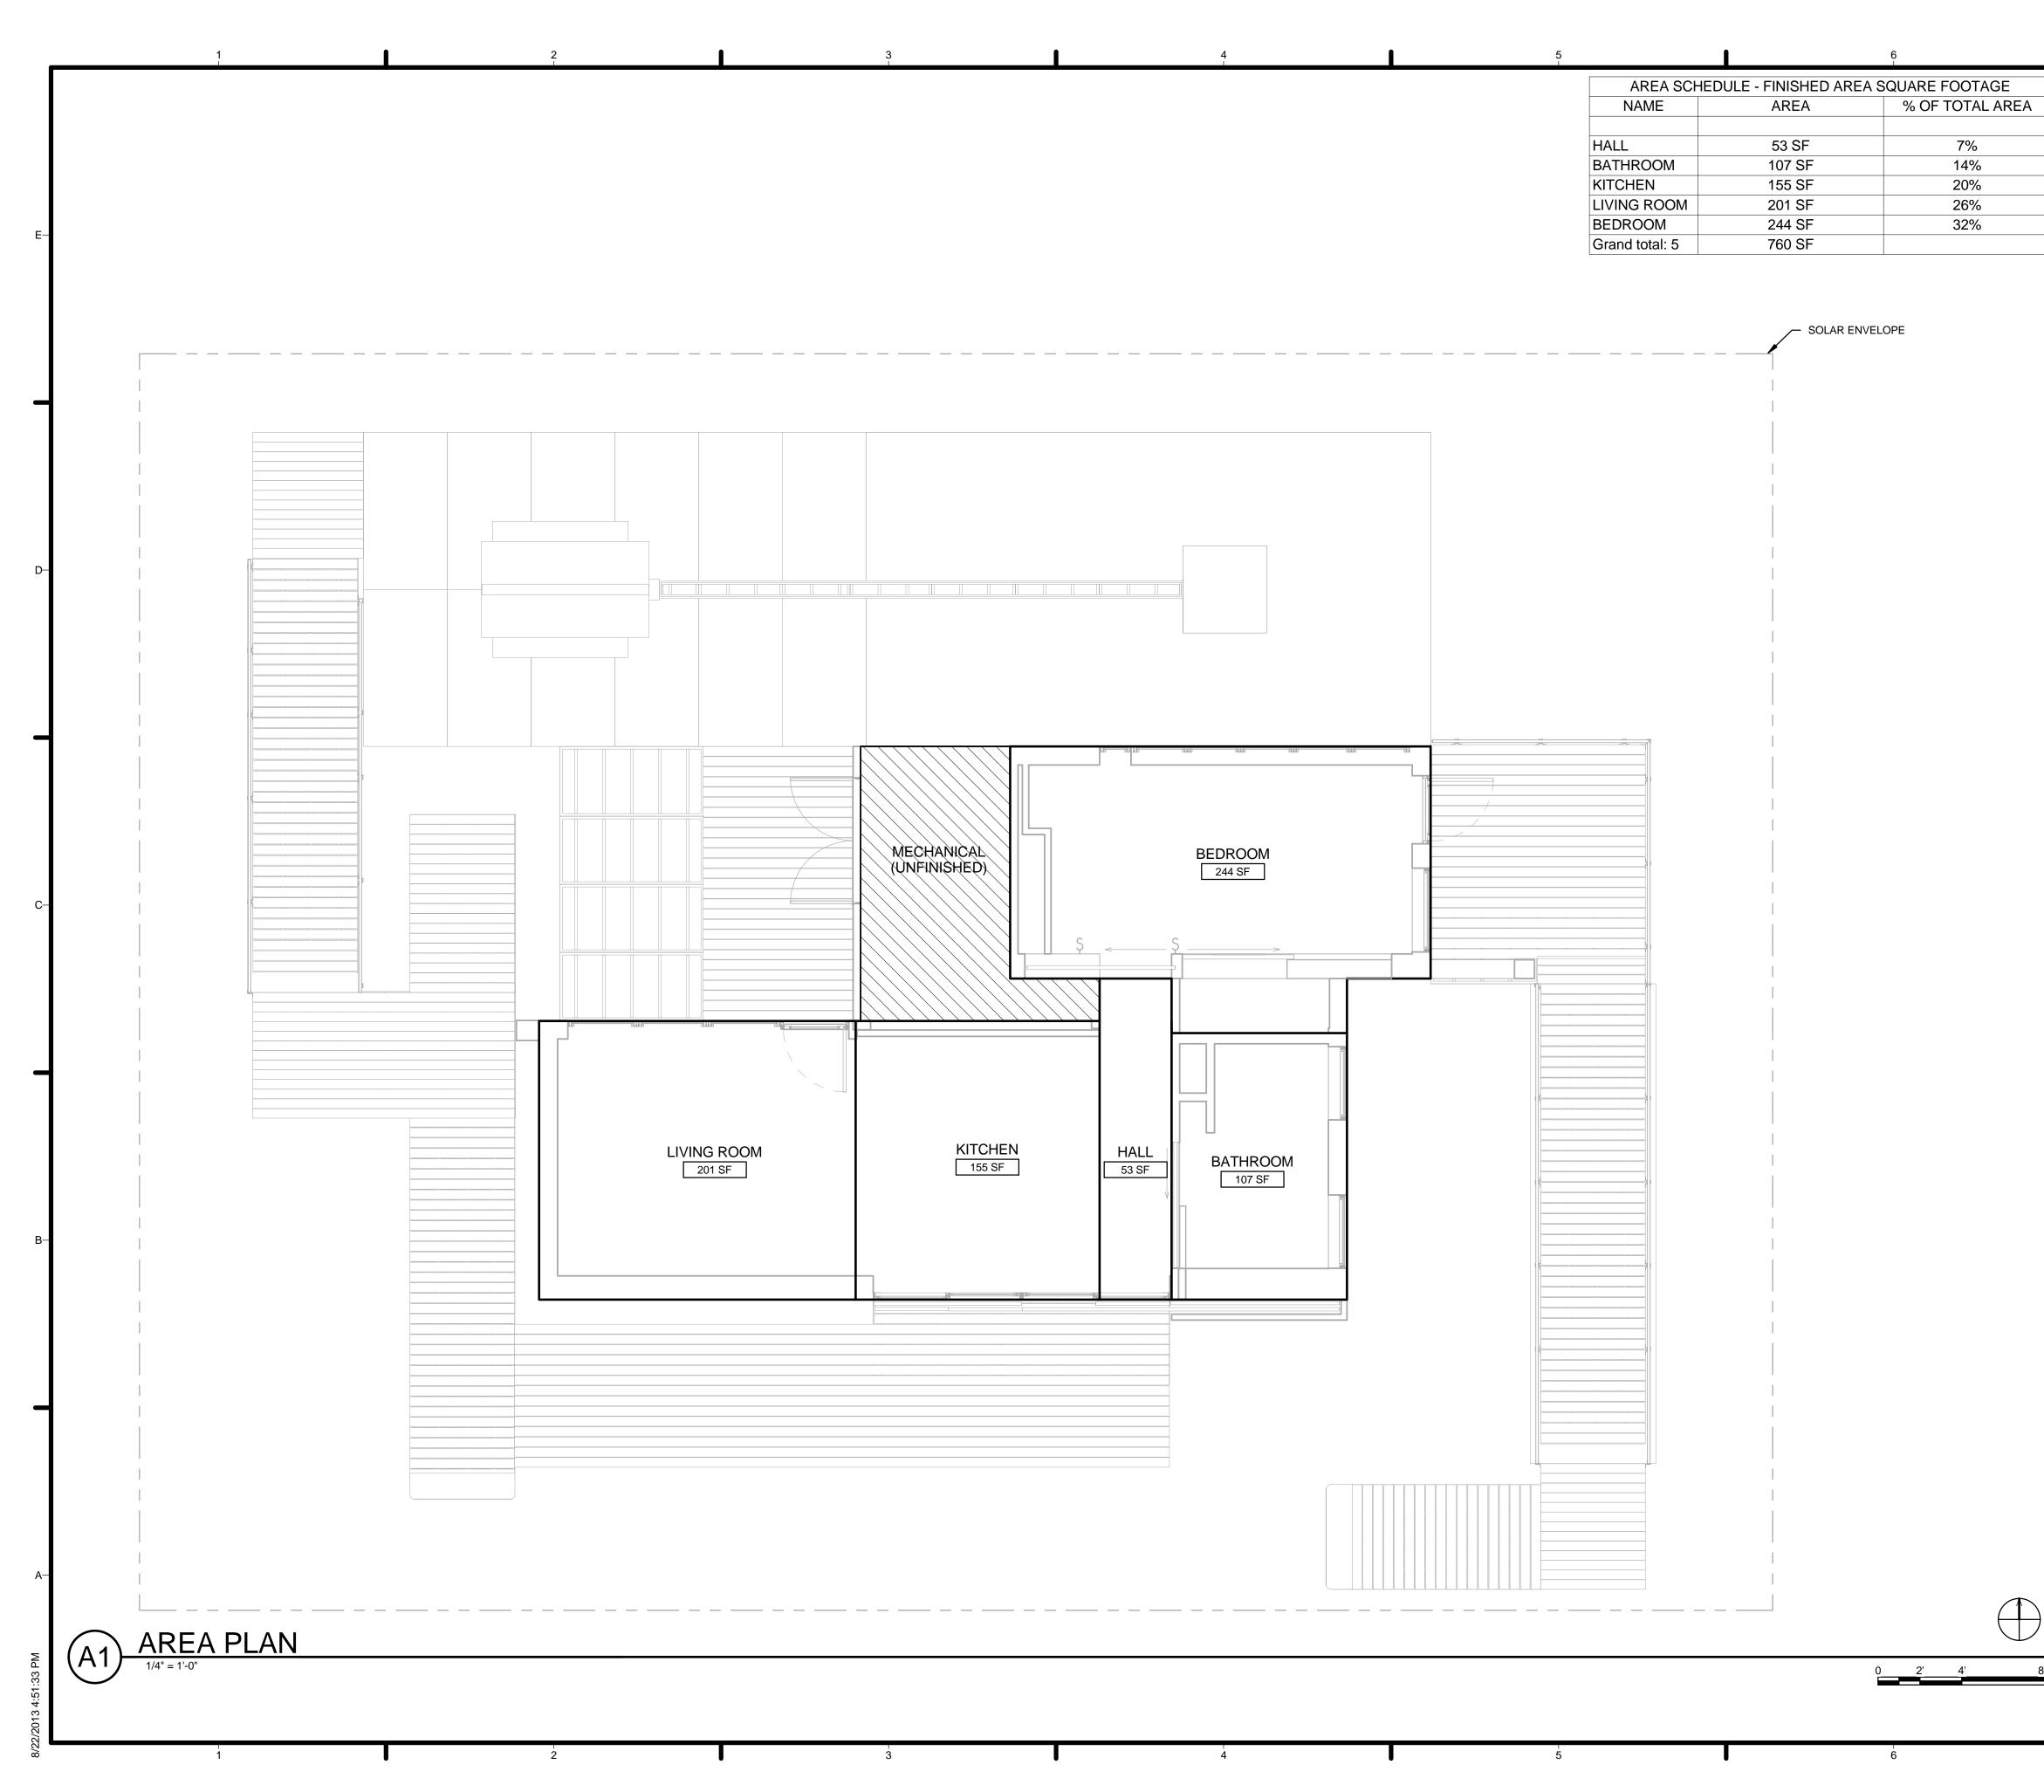
SYMBOL LEGEND		
	DESCRIPTION	
ROOM NAME 150 SF	AREA TAG	
	BREAK LINE	
1 A101 SIM	CALL OUT TAG	
1i 1'-0" A.F.F.	CEILING TAG WITH HEIGHT	
¢_	CENTERLINE	
<u>5'-0"</u> ★	DIMENSION LINE	
6	DOOR TAG	
1 A101	EXTERIOR ELEVATION TAC	
0 2' 4' 8'	GRAPHIC SCALE	
0	GRID HEAD TAG	
1 Ref 1 A101 1 Ref	INTERIOR ELEVATION TAG	
•	LEVEL HEAD TAG	
	NORTH ARROW	
	PROPERTY LINE	
	REVISION TAG	
ROOM NAME	ROOM TAG	
A4 A101	SECTION CUT TAG	
	SOLAR ENVELOPE LINE	
◆	SPOT ELEVATION	
C4 DRAWING BLOCK TITLE	VIEW TITLE	
<u>(1i)</u>	WALL TAG	
	WINDOW TAG	

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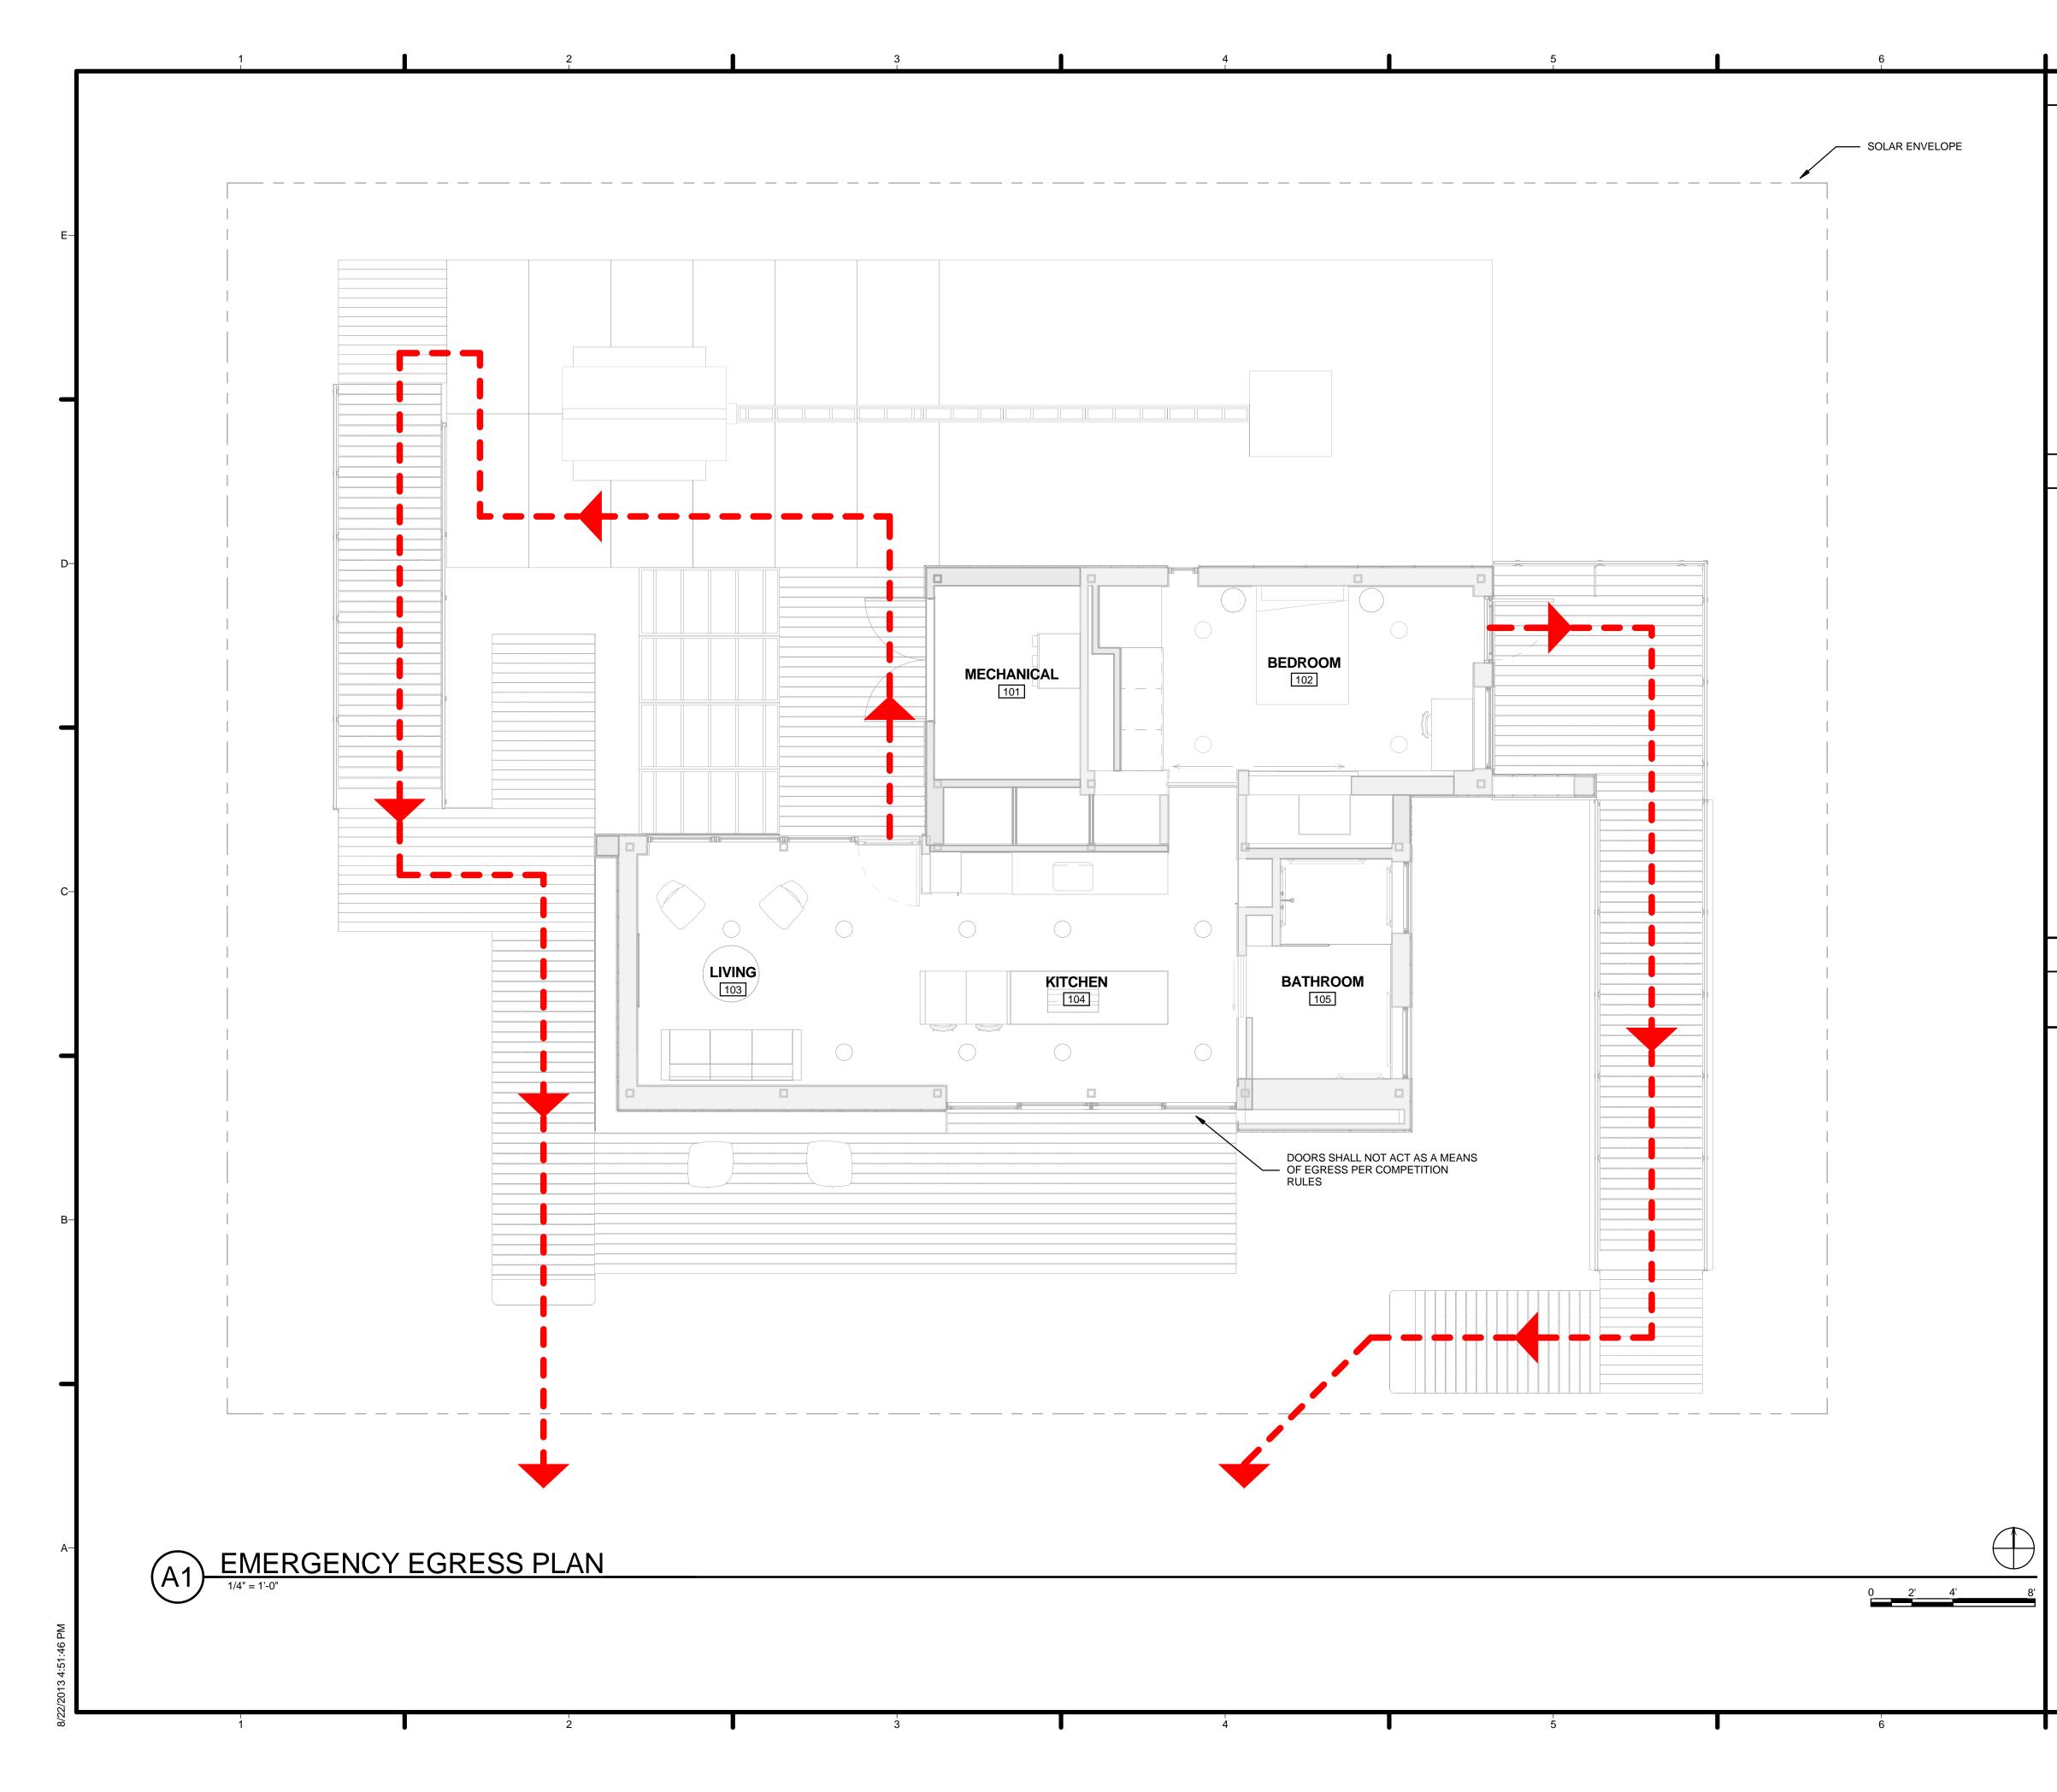
SHEET NO	
	SHEET NAME
	SHEETNAME
CS-001	COVER SHEET
G-001	GENERAL NOTES, SYMBOLS & SHEET LIST
G-101	FINISHED SQUARE FOOTAGE COMPLIANCE PLAN
G-102	EMERGENCY EGRESS PLAN
G-103	ADA TOUR ROUTE COMPLIANCE PLAN
G-104	PUBLIC EXHIBIT PLAN
G-901	SHADING DIAGRAMS
C-101	SITE LOCATION PLAN
C-102	SITE PLAN
C-103	GROUND CONTACT PLAN
C-201	SOLAR ENVELOPE COMPLIANCE ELEVATIONS
C-202	SOLAR ENVELOPE COMPLIANCE ELEVATIONS
L-001	LANDSCAPE NOTES, SYMBOLS AND SCHEDULES
L-101	LANDSCAPE MASTER PLAN
L-102	LANDSCAPE DECKING LAYOUT PLAN
L-103	LANDSCAPE PLANTING PLAN
L-202	
L-301	ENLARGED SOUTHERN DECK
L-302	
L-302	ENLARGED DIVING DECK
L-501	RAMP DETAILS
• • • • •	
S-001	STRUCTURAL NOTES AND SYMBOLS
S-101	FOUNDATION PLAN
S-102	FLOOR FRAMING PLAN
S-103	ROOF FRAMING PLAN
S-104	PV FRAMING PLAN
S-105	DECK FRAMING PLAN
S-106	DECK FRAMING PLAN
S-107	LANDSCAPE DECK FRAMING PLAN
S-201	FRAMING ELEVATIONS
S-301	FRAMING SECTIONS
S-401	TYPICAL PLAN DETAILS
S-411	TYPCIAL SECTION DETAILS
S-501	PLAN DETAILS
S-511	SECTION DETAILS
S-512	SECTION DETAILS
S-512	DECK CONNECTION DETAILS
S-521	DECK FOOTING DETAILS
S-601	
0 704	
S-701	PV DETAILS
S-901	FRAMING ISOMETRICS
S-901 S-902	FRAMING ISOMETRICS FRAMING ISOMETRICS
S-901 S-902 A-101	FRAMING ISOMETRICS FRAMING ISOMETRICS FLOOR PLAN
S-901 S-902 A-101 A-102	FRAMING ISOMETRICS FRAMING ISOMETRICS FLOOR PLAN FINISH & FURNITURE PLAN
S-901 S-902 A-101 A-102 A-111	FRAMING ISOMETRICS FRAMING ISOMETRICS FLOOR PLAN FINISH & FURNITURE PLAN ROOF PLAN
S-901 S-902 A-101 A-102	FRAMING ISOMETRICS FRAMING ISOMETRICS FLOOR PLAN FINISH & FURNITURE PLAN
S-901 S-902 A-101 A-102 A-111	FRAMING ISOMETRICS FRAMING ISOMETRICS FLOOR PLAN FINISH & FURNITURE PLAN ROOF PLAN
S-901 S-902 A-101 A-102 A-111 A-112	FRAMING ISOMETRICS FRAMING ISOMETRICS FLOOR PLAN FINISH & FURNITURE PLAN ROOF PLAN PV ARRAY PLAN
S-901 S-902 A-101 A-102 A-111 A-112 A-121	FRAMING ISOMETRICS FRAMING ISOMETRICS FLOOR PLAN FINISH & FURNITURE PLAN ROOF PLAN PV ARRAY PLAN REFLECTED CEILING PLAN
S-901 S-902 A-101 A-102 A-111 A-112 A-121 A-201	FRAMING ISOMETRICS FRAMING ISOMETRICS FLOOR PLAN FINISH & FURNITURE PLAN ROOF PLAN PV ARRAY PLAN REFLECTED CEILING PLAN BUILDING ELEVATIONS
S-901 S-902 A-101 A-102 A-111 A-112 A-121 A-201 A-202	FRAMING ISOMETRICS FRAMING ISOMETRICS FLOOR PLAN FINISH & FURNITURE PLAN ROOF PLAN PV ARRAY PLAN REFLECTED CEILING PLAN BUILDING ELEVATIONS BUILDING ELEVATIONS
S-901 S-902 A-101 A-102 A-111 A-112 A-121 A-201 A-202 A-301	FRAMING ISOMETRICS FRAMING ISOMETRICS FLOOR PLAN FINISH & FURNITURE PLAN ROOF PLAN PV ARRAY PLAN REFLECTED CEILING PLAN BUILDING ELEVATIONS BUILDING ELEVATIONS BUILDING SECTIONS
S-901 S-902 A-101 A-102 A-111 A-112 A-121 A-201 A-202 A-301 A-302	FRAMING ISOMETRICS FRAMING ISOMETRICS FLOOR PLAN FINISH & FURNITURE PLAN ROOF PLAN PV ARRAY PLAN REFLECTED CEILING PLAN BUILDING ELEVATIONS BUILDING SECTIONS BUILDING SECTIONS
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S-901 S-902 A-101 A-102 A-111 A-102 A-111 A-202 A-201 A-202 A-301 A-302 A-303 A-304 A-305 A-311 A-312 A-313	FRAMING ISOMETRICS FRAMING ISOMETRICS FLOOR PLAN FINISH & FURNITURE PLAN ROOF PLAN PV ARRAY PLAN REFLECTED CEILING PLAN BUILDING ELEVATIONS BUILDING SECTIONS BUILDING SECTIONS BUILDING SECTIONS BUILDING SECTIONS BUILDING SECTIONS BUILDING SECTIONS BUILDING SECTIONS BUILDING SECTIONS BUILDING SECTIONS BUILDING SECTIONS WALL SECTIONS WALL SECTIONS
S-901 S-902 A-101 A-102 A-111 A-112 A-201 A-201 A-202 A-301 A-302 A-303 A-304 A-305 A-311 A-312 A-313 A-314	FRAMING ISOMETRICS FRAMING ISOMETRICS FLOOR PLAN FINISH & FURNITURE PLAN ROOF PLAN PV ARRAY PLAN REFLECTED CEILING PLAN BUILDING ELEVATIONS BUILDING SECTIONS BUILDING SECTIONS BUILDING SECTIONS BUILDING SECTIONS BUILDING SECTIONS BUILDING SECTIONS BUILDING SECTIONS WALL SECTIONS WALL SECTIONS WALL SECTIONS WALL SECTIONS
S-901 S-902 A-101 A-102 A-111 A-112 A-121 A-201 A-202 A-301 A-302 A-303 A-304 A-305 A-311 A-312 A-313 A-314 A-315	FRAMING ISOMETRICS FRAMING ISOMETRICS FLOOR PLAN FINISH & FURNITURE PLAN ROOF PLAN PV ARRAY PLAN REFLECTED CEILING PLAN BUILDING ELEVATIONS BUILDING SECTIONS BUILDING SECTIONS BUILDING SECTIONS BUILDING SECTIONS BUILDING SECTIONS BUILDING SECTIONS WALL SECTIONS WALL SECTIONS WALL SECTIONS WALL SECTIONS WALL SECTIONS
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A-532	WINDOW DETAILS
A-533	WINDOW DETAILS
A-541	INTERIOR DOOR DETAILS
A-551	PV MOUNTING DETAILS
A-601	SCHEDULES
A-602	WINDOW SCHEDULE
A-603	DOOR SCHEDULE
A-604	SCREEN SYSTEM
A-605	SCREEN ELEVATION
A-701	
A-711	
A-712 A-713	MODULE A SOUTH WALL MODULE A EAST/WEST WALL
A-713 A-714	MODULE A INTERIOR WALLS
A-715	MODULE A INTERIOR WALLS
A-716	MODULE B NORTH WALL
A-717	MODULE B EAST WALL
A-718	MODULE B SOUTH WALLS
A-719	MODULE B INTERIOR WALLS
A-720	EXTENSION WALLS
A-721	SOFFITS
A-722	PLANTER
A-723	FRAMING SECTION
A-731	
A-732 A-733	SIP ROOF PLAN SIP CEILING PLAN
A-733 A-734	SIP ELEVATIONS
A-735	SIP SEPERATION SECTIONS
A-736	SIP OVERHANG SECTIONS
A-901	AXONS
F-101	FIRE SUPPRESSION PLAN & SCHEDULES
D 004	
P-001	PLUMBING NOTES AND SYMBOLS PLUMBING SITE PLAN
P-101 P-102	DOMESTIC SUPPLY PLAN
P-102 P-103	DOMESTIC SUPPLY PLAN
P-501	DOMESTIC SUPPLY RISER DIAGRAM
P-502	DOMESTIC RETURN RISER DIAGRAM
P-503	SOLAR THERMAL DIAGRAM
M-001	MECHANICAL NOTES, SYMBOLS AND SCHEDULES
M-101	MECHANICAL HVAC PLAN - FLOOR
M-102	MECHANICAL HVAC PLAN - CEILING
M-201	MECHANICAL ELEVATIONS
M-501	MECHANICAL SYSTEM DIAGRAM
E-001	ELECTRICAL NOTES, SYMBOLS AND SCHEDULES
E-001 E-101	ELECTRICAL NOTES, STRIBULS AND SCHEDOLES
E-101	ELECTRICAL LIGHTING PLAN
E-601	DETAILS AND ONE-LINE DIAGRAM
	PV 3-LINE WIRING DIAGRAM
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E-602 E-603	INTERCONNECTION DIAGRAM
E-603	INTERCONNECTION DIAGRAM

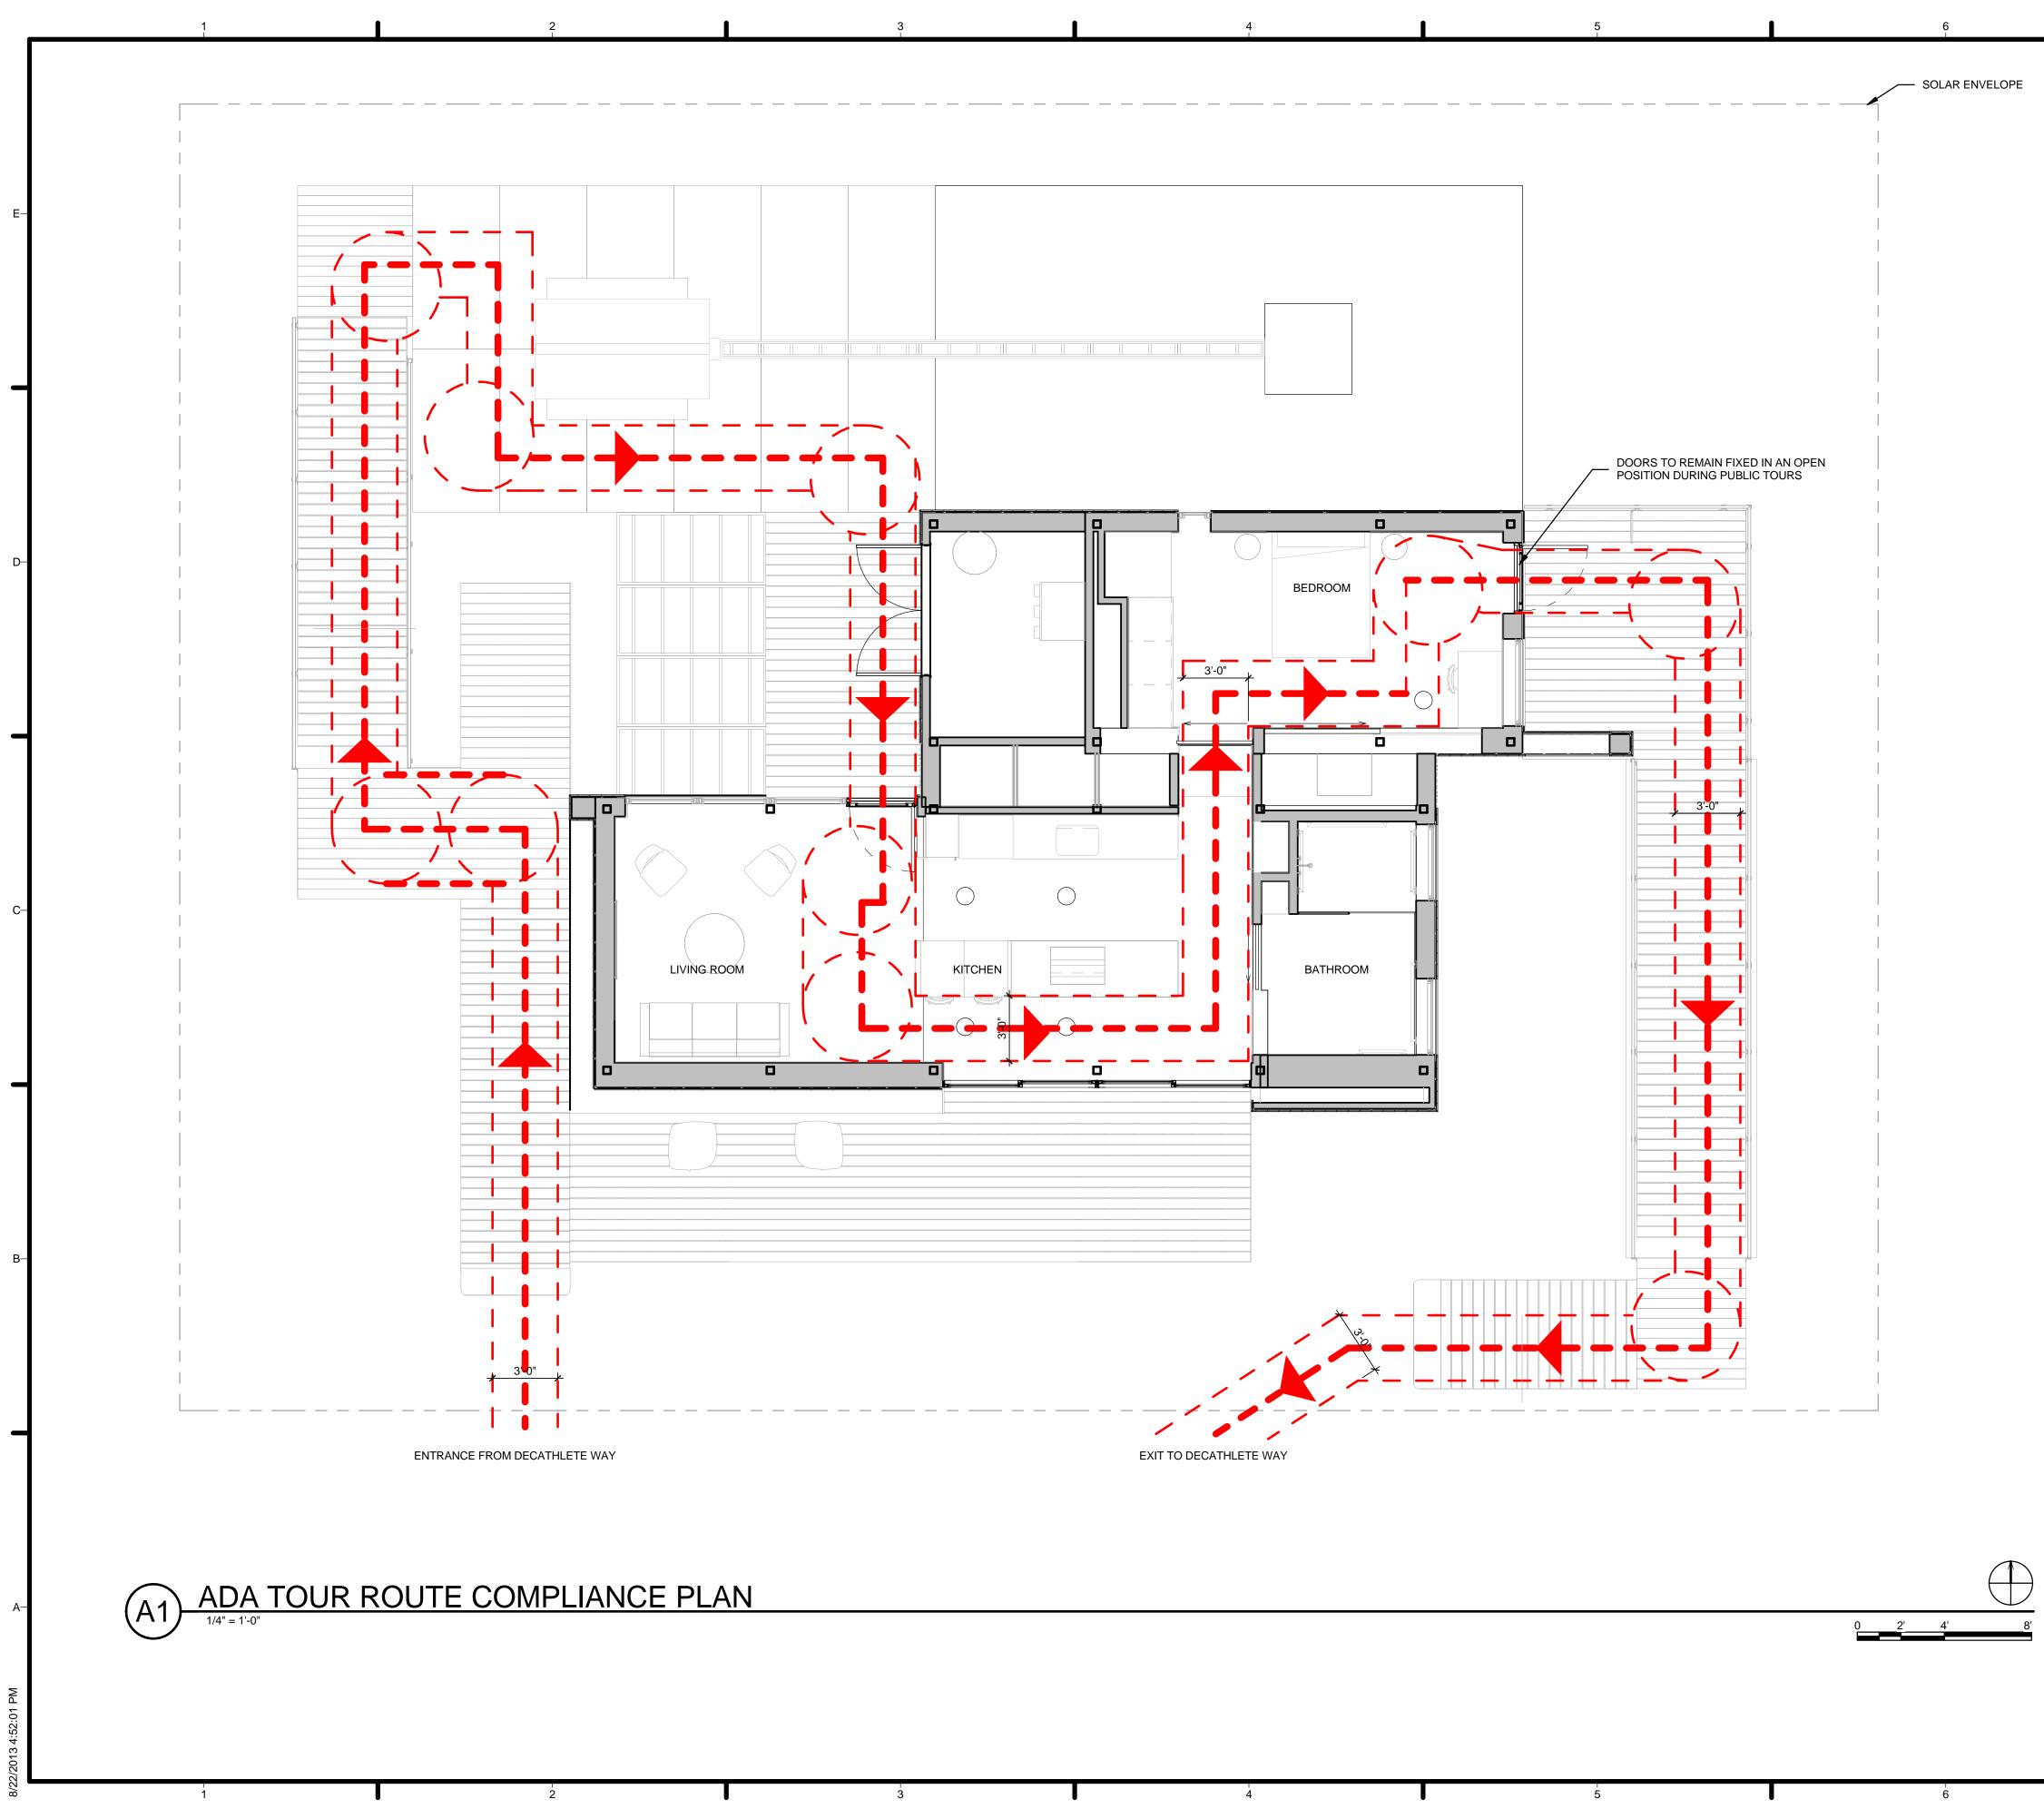




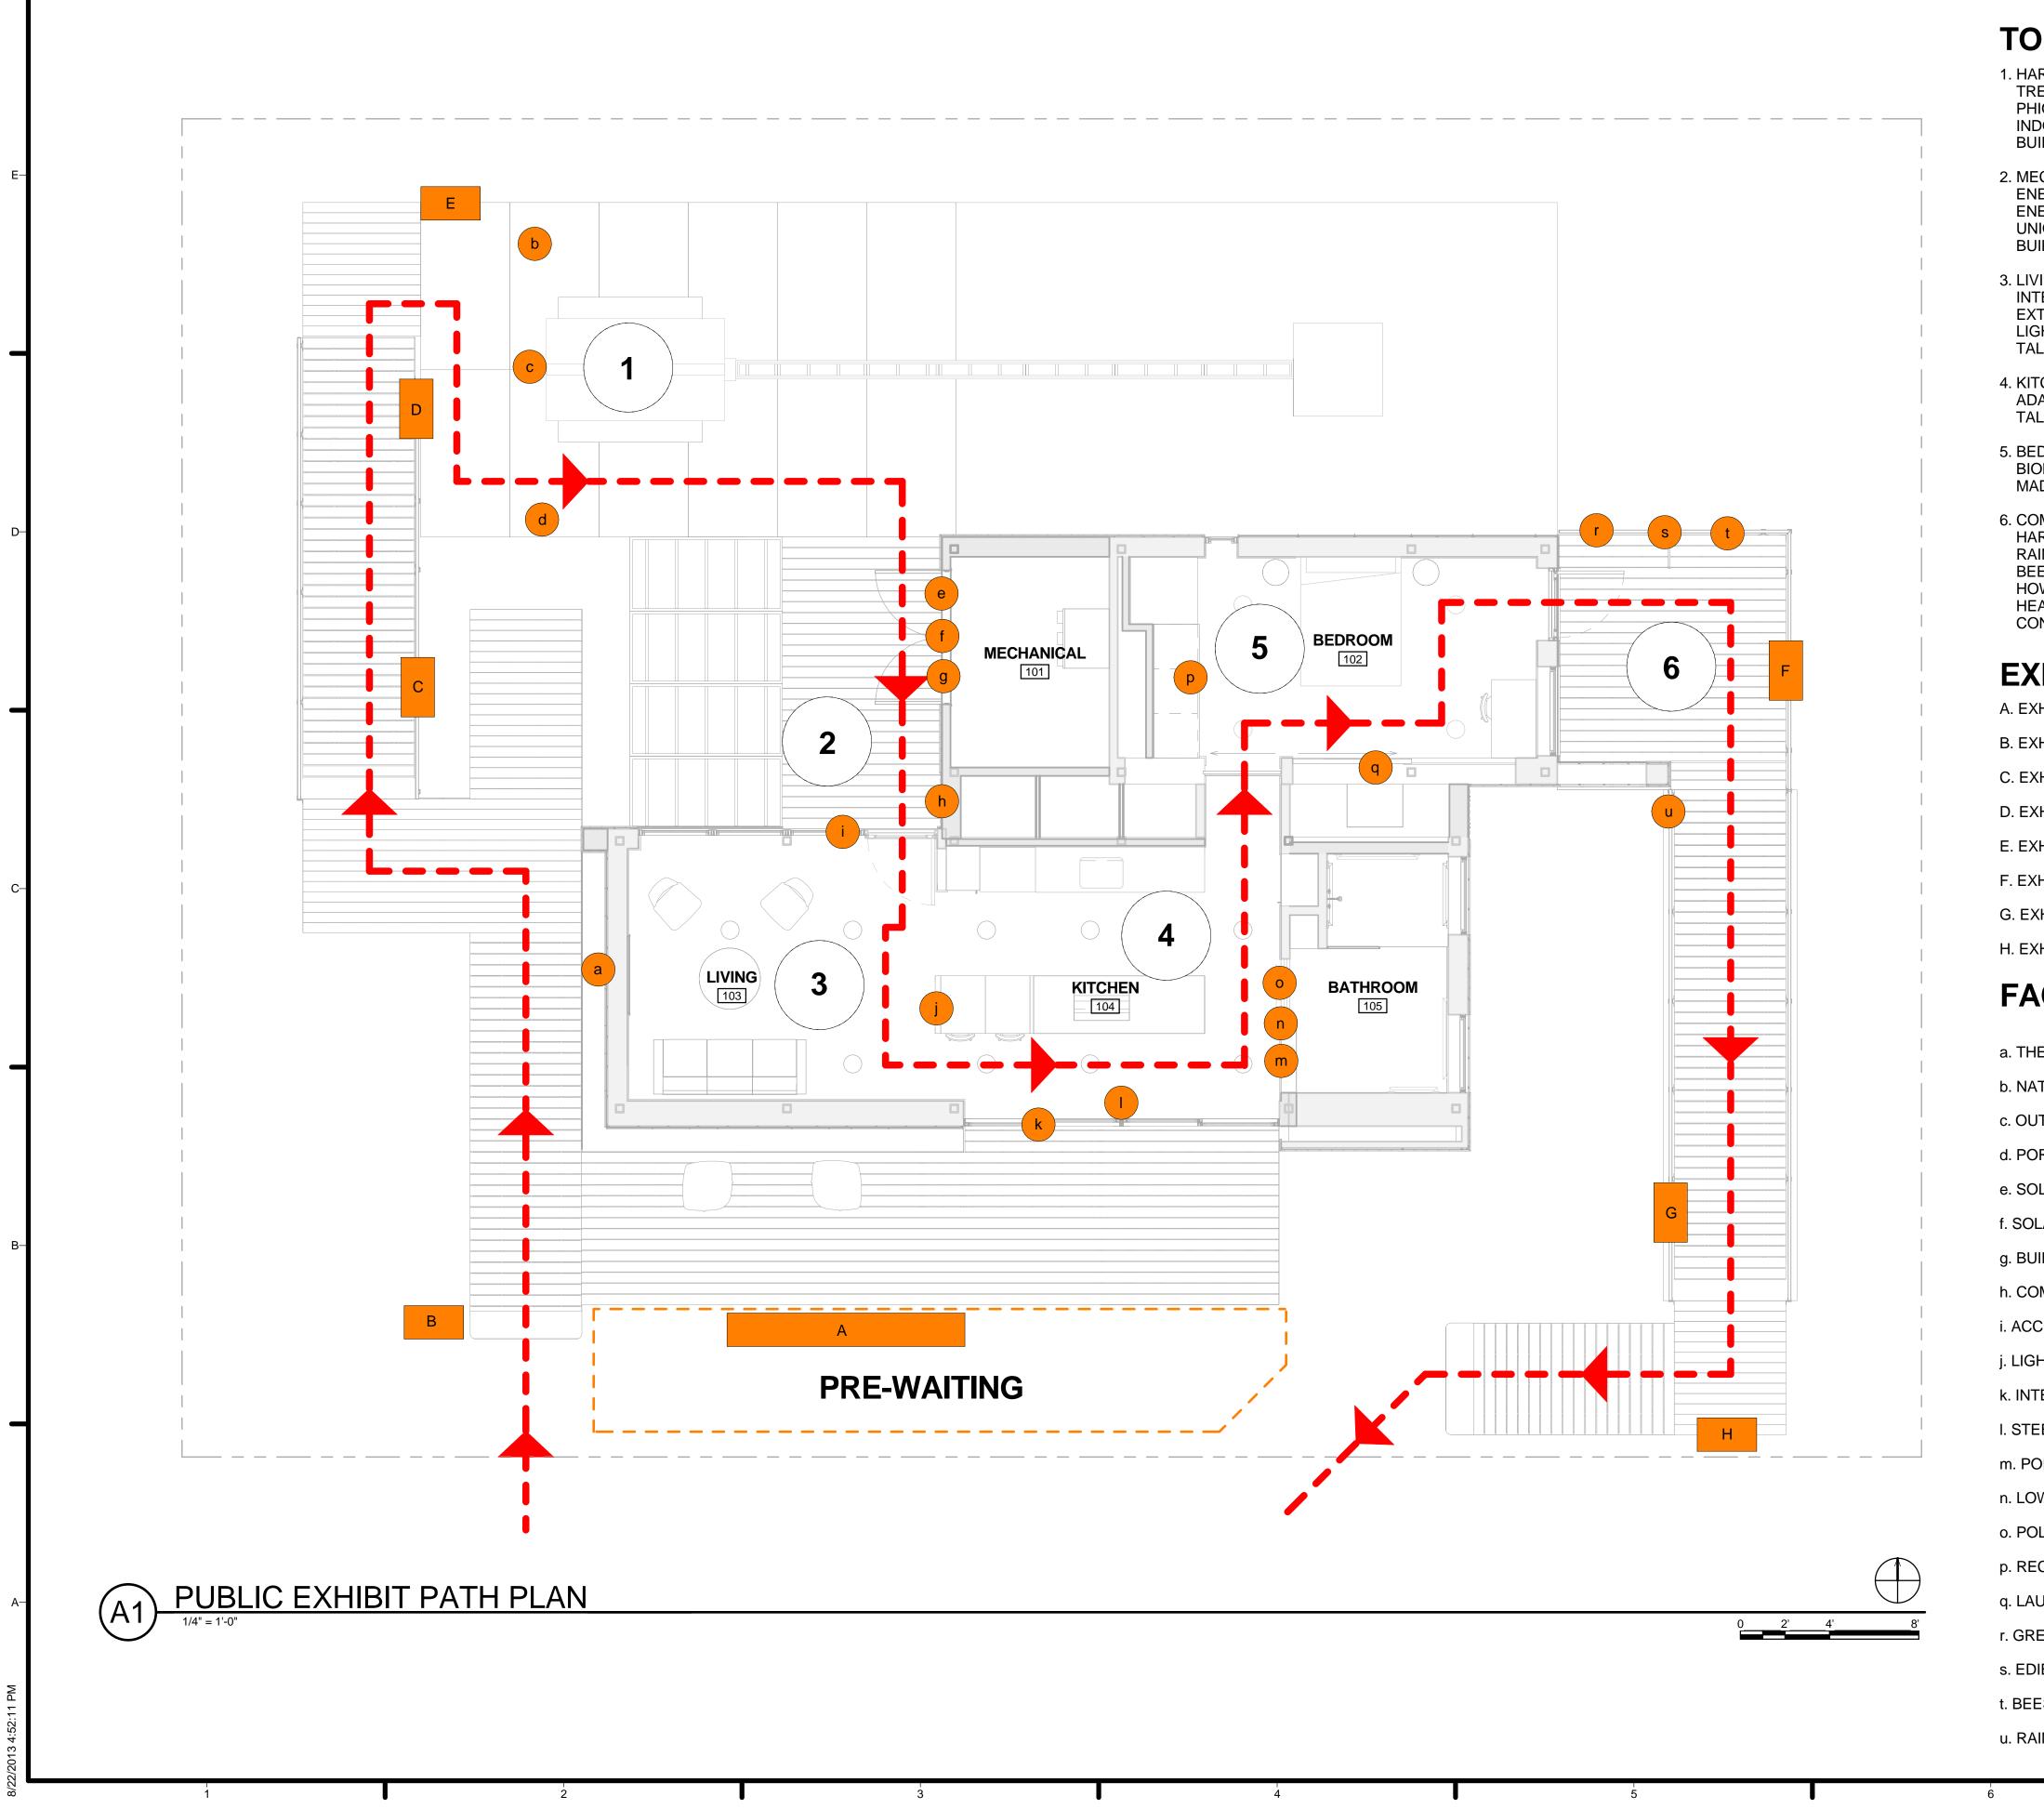
7	GENERAL SHEET NOTES		
	 1. THE FINISHED AREA OF THE HOUSE HAS BEEN CALCULATED IN ACCORDANCE WITH THE AMERICAN NATIONAL STANDARD FOR DETACHED SINGLEFAMILY RESIDENTIAL BUILDING Z765-2003. SQUARE FOOTAGE OF MECHANICAL ROOM NOT INCLUDED IN FINAL SQAURE FOOTAGE OF HOUSE PER ANSI REQUIREMENTS. 3. FINISHED SQUARE FOOTAGE CALCULATIONS FOR THIS HOUSE WERE MADE BASED ON PLAN DIMENSIONS ONLY AND MAY VARY FROM THE FINISHED SQUARE FOOTAGE OF THE HOUSE AS BUILT. 4. FOR FINISHED AREAS ADJACENT TO UNFINISHED AREAS, THE FINISHED SQUARE FOOTAGE IS CALCULATED TO EXTERIOR EDGE OF UNFINISHED SURFACE OF ANY INTERIOR PARTITION BETWEEN SPACES IN COMPLIANCE WITH ANSI-Z765 2003. 5. ALL MEASUREMENTS ARE ROUNDED TO THE NEAREST WHOLE SQUARE FOOT IN ACCORDANCE WITH ANSI Z765-2003. 	–E	TEAM NAME: Team Capitol dc TEAM NAME: Team Capitol dc ADDRESS: THE CATHOLIC UNIVERSITY OF AMERICA SCHOOL OF ARCHITECTURE 620 MICHIGAN AVENUE, NE. WASHINGTON, DC 20064
	REFERENCE KEYNOTES	-D	STRUCTURAL ENGINEER BOB ALLISON, PE ARUP ENGINEERING 1120 CONNECTICUT AVENUE, NW., SUITE 200 WASHINGTON, DC 20036 TEL: 202.729.8220 MEP ENGINEER ARUP ENGINEERING 1120 CONNECTICUT AVENUE, NW., SUITE 200 WASHINGTON, DC 20036 TEL: 202.729.8220 ARCHITECT OF RECORD WILLIAM JELEN, AIA 620 MICHIGAN AVE NE CROUGH CENTER WASHINGTON, DC 20064 TEL: 202.344.5513
	SHEET KEYNOTES 21 SOLAR ENVELOPE	-c	CLIENT U.S. DEPARTMENT OF ENERGY SOLAR DECATHLON 2013 WWW.SOLARDECATHLON.GOV
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7	
GENERAL SHEET NOTES	
	-E HARVEST CAPITOL
	TEAM NAME: Team Capitol dc
	ADDRESS: THE CATHOLIC UNIVERSITY OF AMERICA SCHOOL OF ARCHITECTURE 620 MICHIGAN AVENUE, NE. WASHINGTON, DC 20064
REFERENCE KEYNOTES	STRUCTURAL ENGINEER
	BOB ALLISON, PE ARUP ENGINEERING 1120 CONNECTICUT AVENUE, NW., SUITE 200 WASHINGTON, DC 20036 TEL: 202.729.8220 MEP ENGINEER ARUP ENGINEERING 1120 CONNECTICUT AVENUE, NW., SUITE 200 WASHINGTON, DC 20036 TEL: 202.729.8220 ARCHITECT OF RECORD WILLIAM JELEN, AIA 620 MICHIGAN AVE NE CROUGH CENTER WASHINGTON, DC 20064 TEL: 202.344.5513
	-C CLIENT U.S. DEPARTMENT OF ENERGY SOLAR DECATHLON 2013
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GENERAL SHEET NOTES	
	-E HARVEST TEAM dc
	TEAM NAME: Team Capitol dc ADDRESS: THE CATHOLIC UNIVERSITY OF AMERICA SCHOOL OF ARCHITECTURE 620 MICHIGAN AVENUE, NE.
	WASHINGTON, DC 20064
REFERENCE KEYNOTES	STRUCTURAL ENGINEER BOB ALLISON, PE ARUP ENGINEERING 1120 CONNECTICUT AVENUE, NW., SUITE 200 WASHINGTON, DC 20036 TEL: 202.729.8220 MEP ENGINEER ARUP ENGINEERING 1120 CONNECTICUT AVENUE, NW., SUITE 200 WASHINGTON, DC 20036 TEL: 202.729.8220 ARCHITECT OF RECORD WILLIAM JELEN, AIA 620 MICHIGAN AVE NE CROUGH CENTER WASHINGTON, DC 20064 TEL: 202.344.5513
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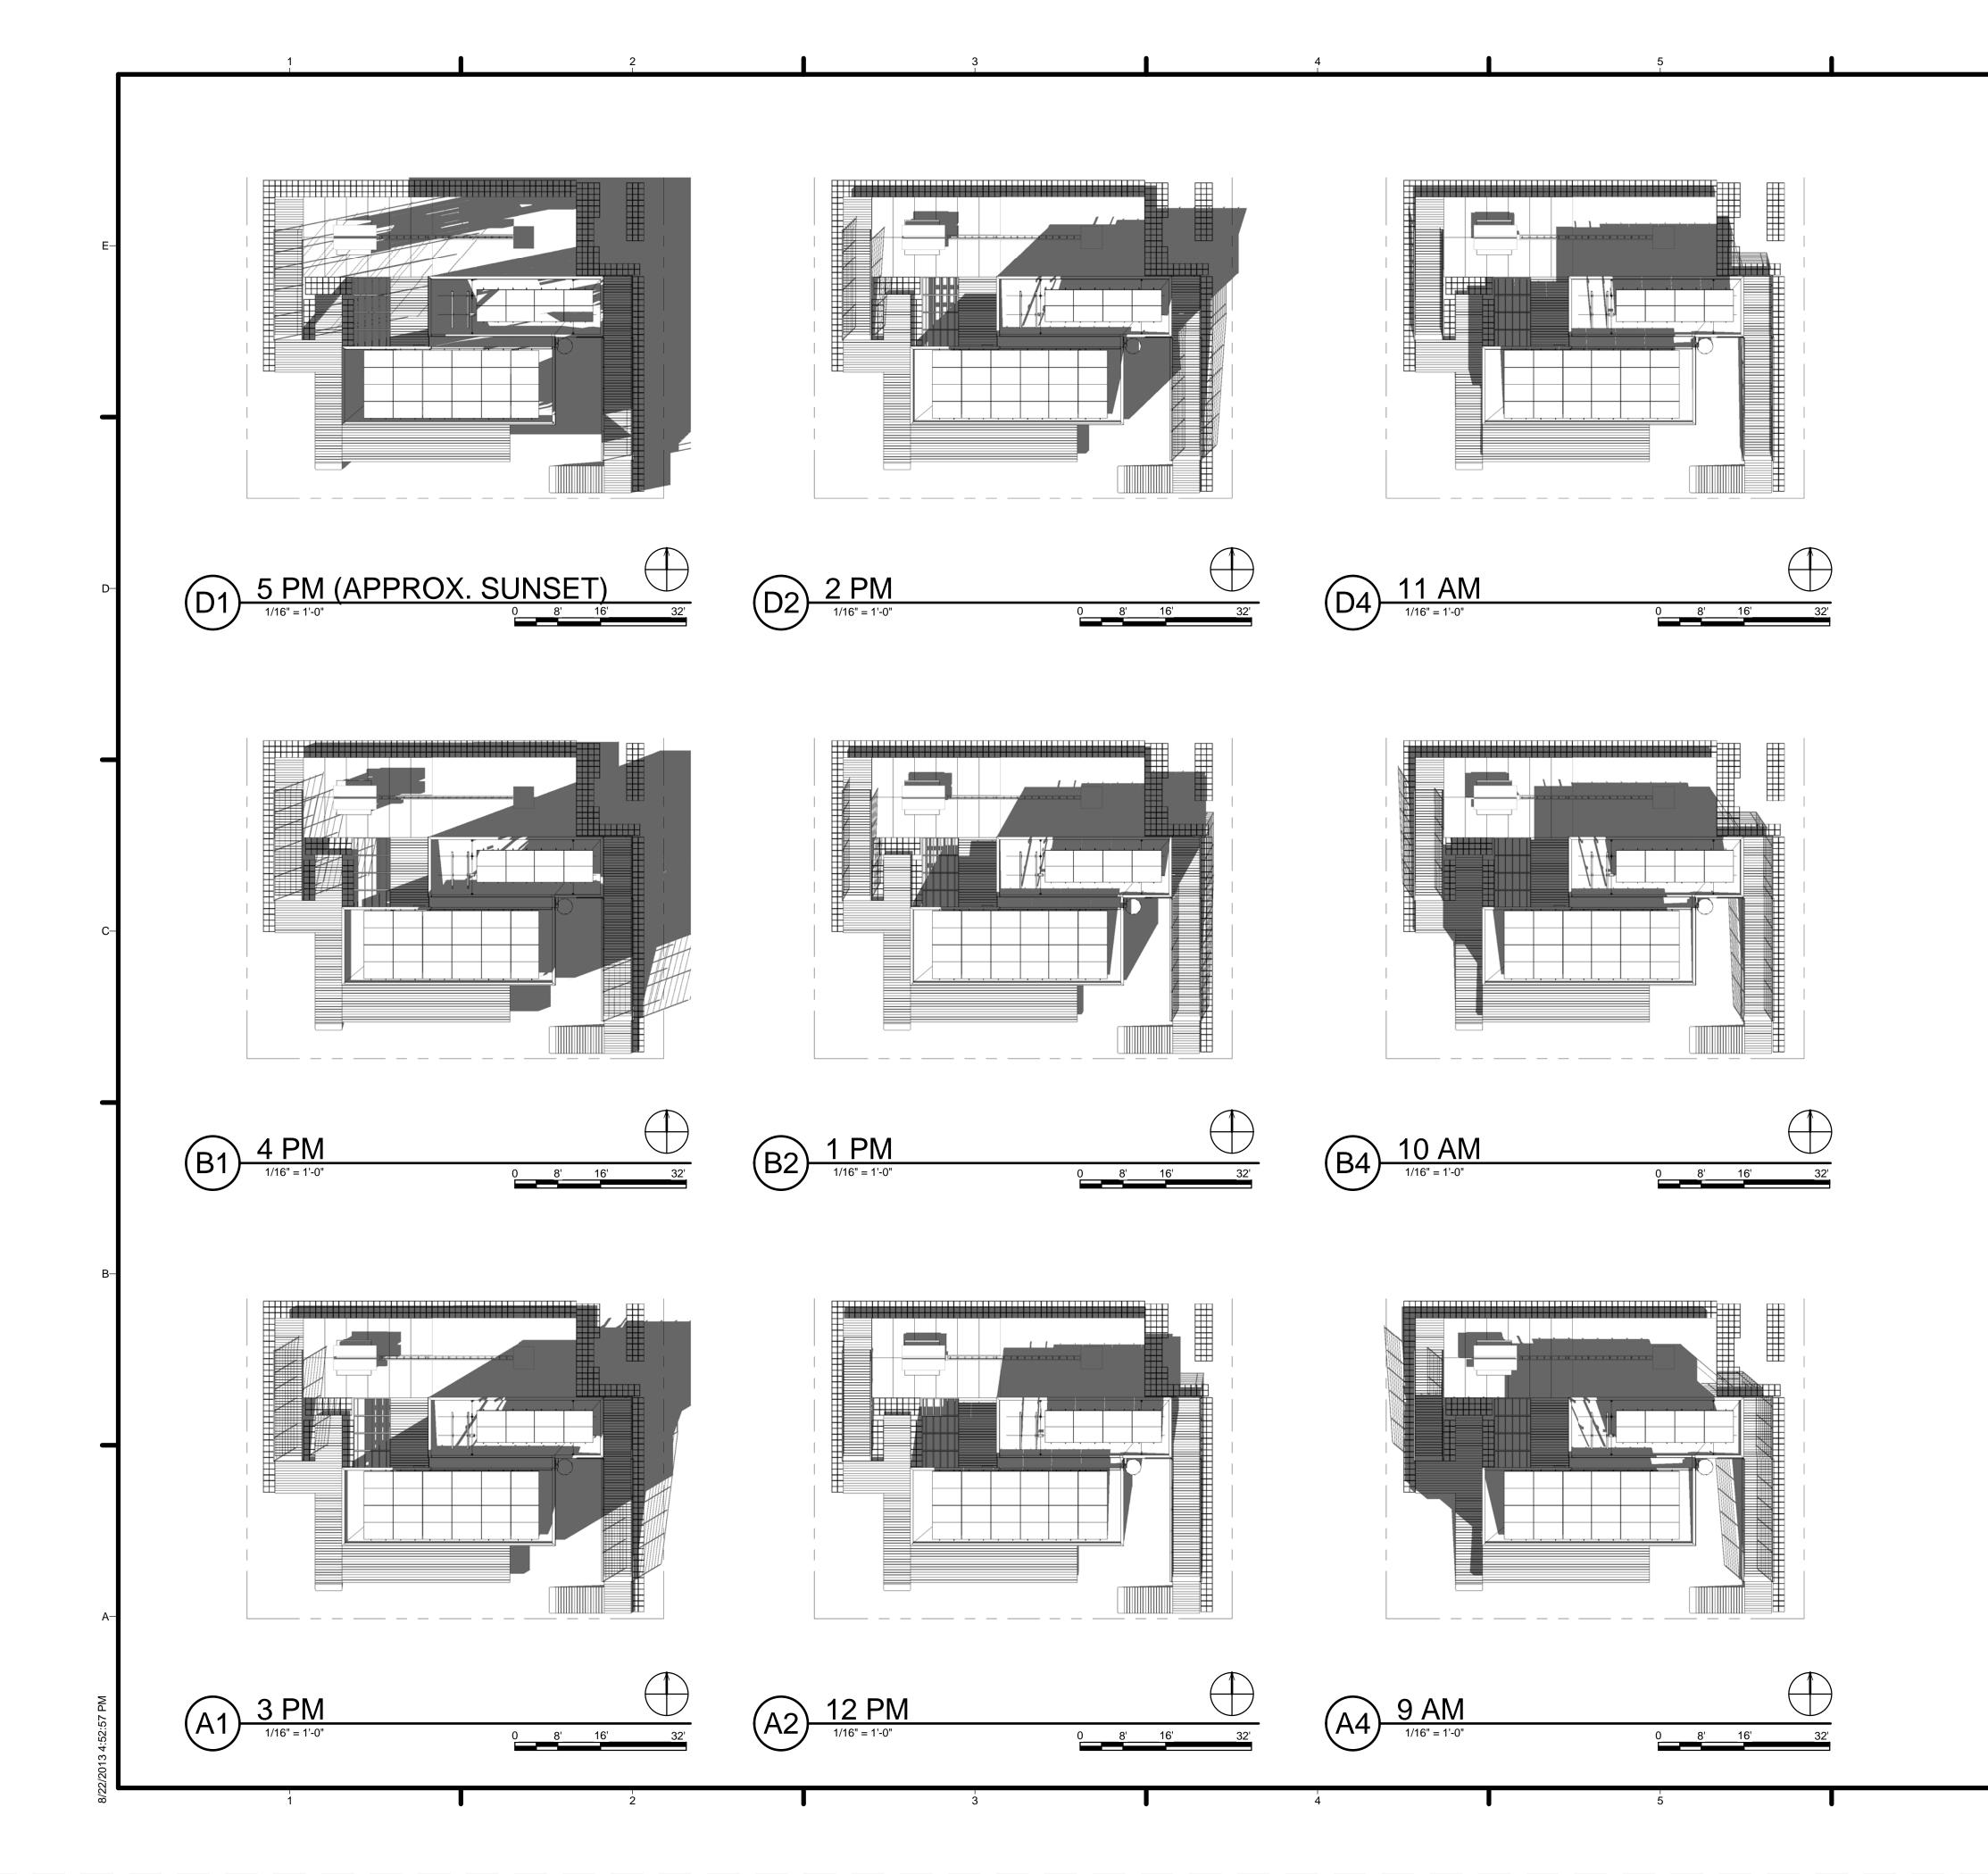
TOUR STOPS TREE OF LIFE PHIOSOPHY OF HOUSE DESIGN INDOOR-OUTDOOR MESSAGE BUILT FOR A MILITARY VETERAN ENERGY OF PERFORMANCE ENERY MODEL, PROJECTED PERFORMANCE HARVEST | CAPITOL UNIQUE ABOUT DESIGN AND PERFORMANCE BUILDING OF THE FUTURE INTERIORS EXTERIOR AND INTERIOR CONNECTION LIGHTING, COLOR TEAM NAME: Team Capitol dc TALK ABOUT SCREENS ADDRESS: THE CATHOLIC UNIVERSITY OF AMERICA SCHOOL OF ARCHITECTURE 620 MICHIGAN AVENUE, NE. ADA COMPLIANCE WASHINGTON, DC 20064 TALK ABOUT CONTROLS AND MONITORING STRUCTURAL ENGINEER BOB ALLISON, PE **BIOMEDICAL ENGINEERING** ARUP ENGINEERING 1120 CONNECTICUT AVENUE, NW., SUITE 200 MADE FOR THE VETERAN; HOW CAN WE HELP HEAL SOMEONE? WASHINGTON, DC 20036 TEL: 202.729.8220 HARVEST GARDEN MEP ENGINEER RAINWATER HARVESTING ARUP ENGINEERING BEE HIVE 1120 CONNECTICUT AVENUE, NW., SUITE 200 HOW IS THIS HOUSE REALLY A HARVEST HOUSE? WASHINGTON, DC 20036 HEATING CONTINUES TEL: 202.729.8220 CONCLUSION ARCHITECT OF RECORD WILLIAM JELEN, AIA 620 MICHIGAN AVE NE CROUGH CENTER WASHINGTON, DC 20064 TEL: 202.344.5513 CLIENT U.S. DEPARTMENT OF ENERGY SOLAR DECATHLON 2013 WWW.SOLARDECATHLON.GOV U.S. DEPARTMENT OF ENERGY SOLAR DECATHLON 2013.08.22 As-Built Submission DESCRIPTION MARK DATE LOT NUMBER: 115 DRAWN BY: TEAM CAPITOL DC CHECKED BY: TEAM CAPITOL DC NONE: PROJECT IS PUBLIC DOMAIN COPYRIGHT: SHEET TITLE PUBLIC EXHIBIT PLAN G-104

- 5. BEDROOM

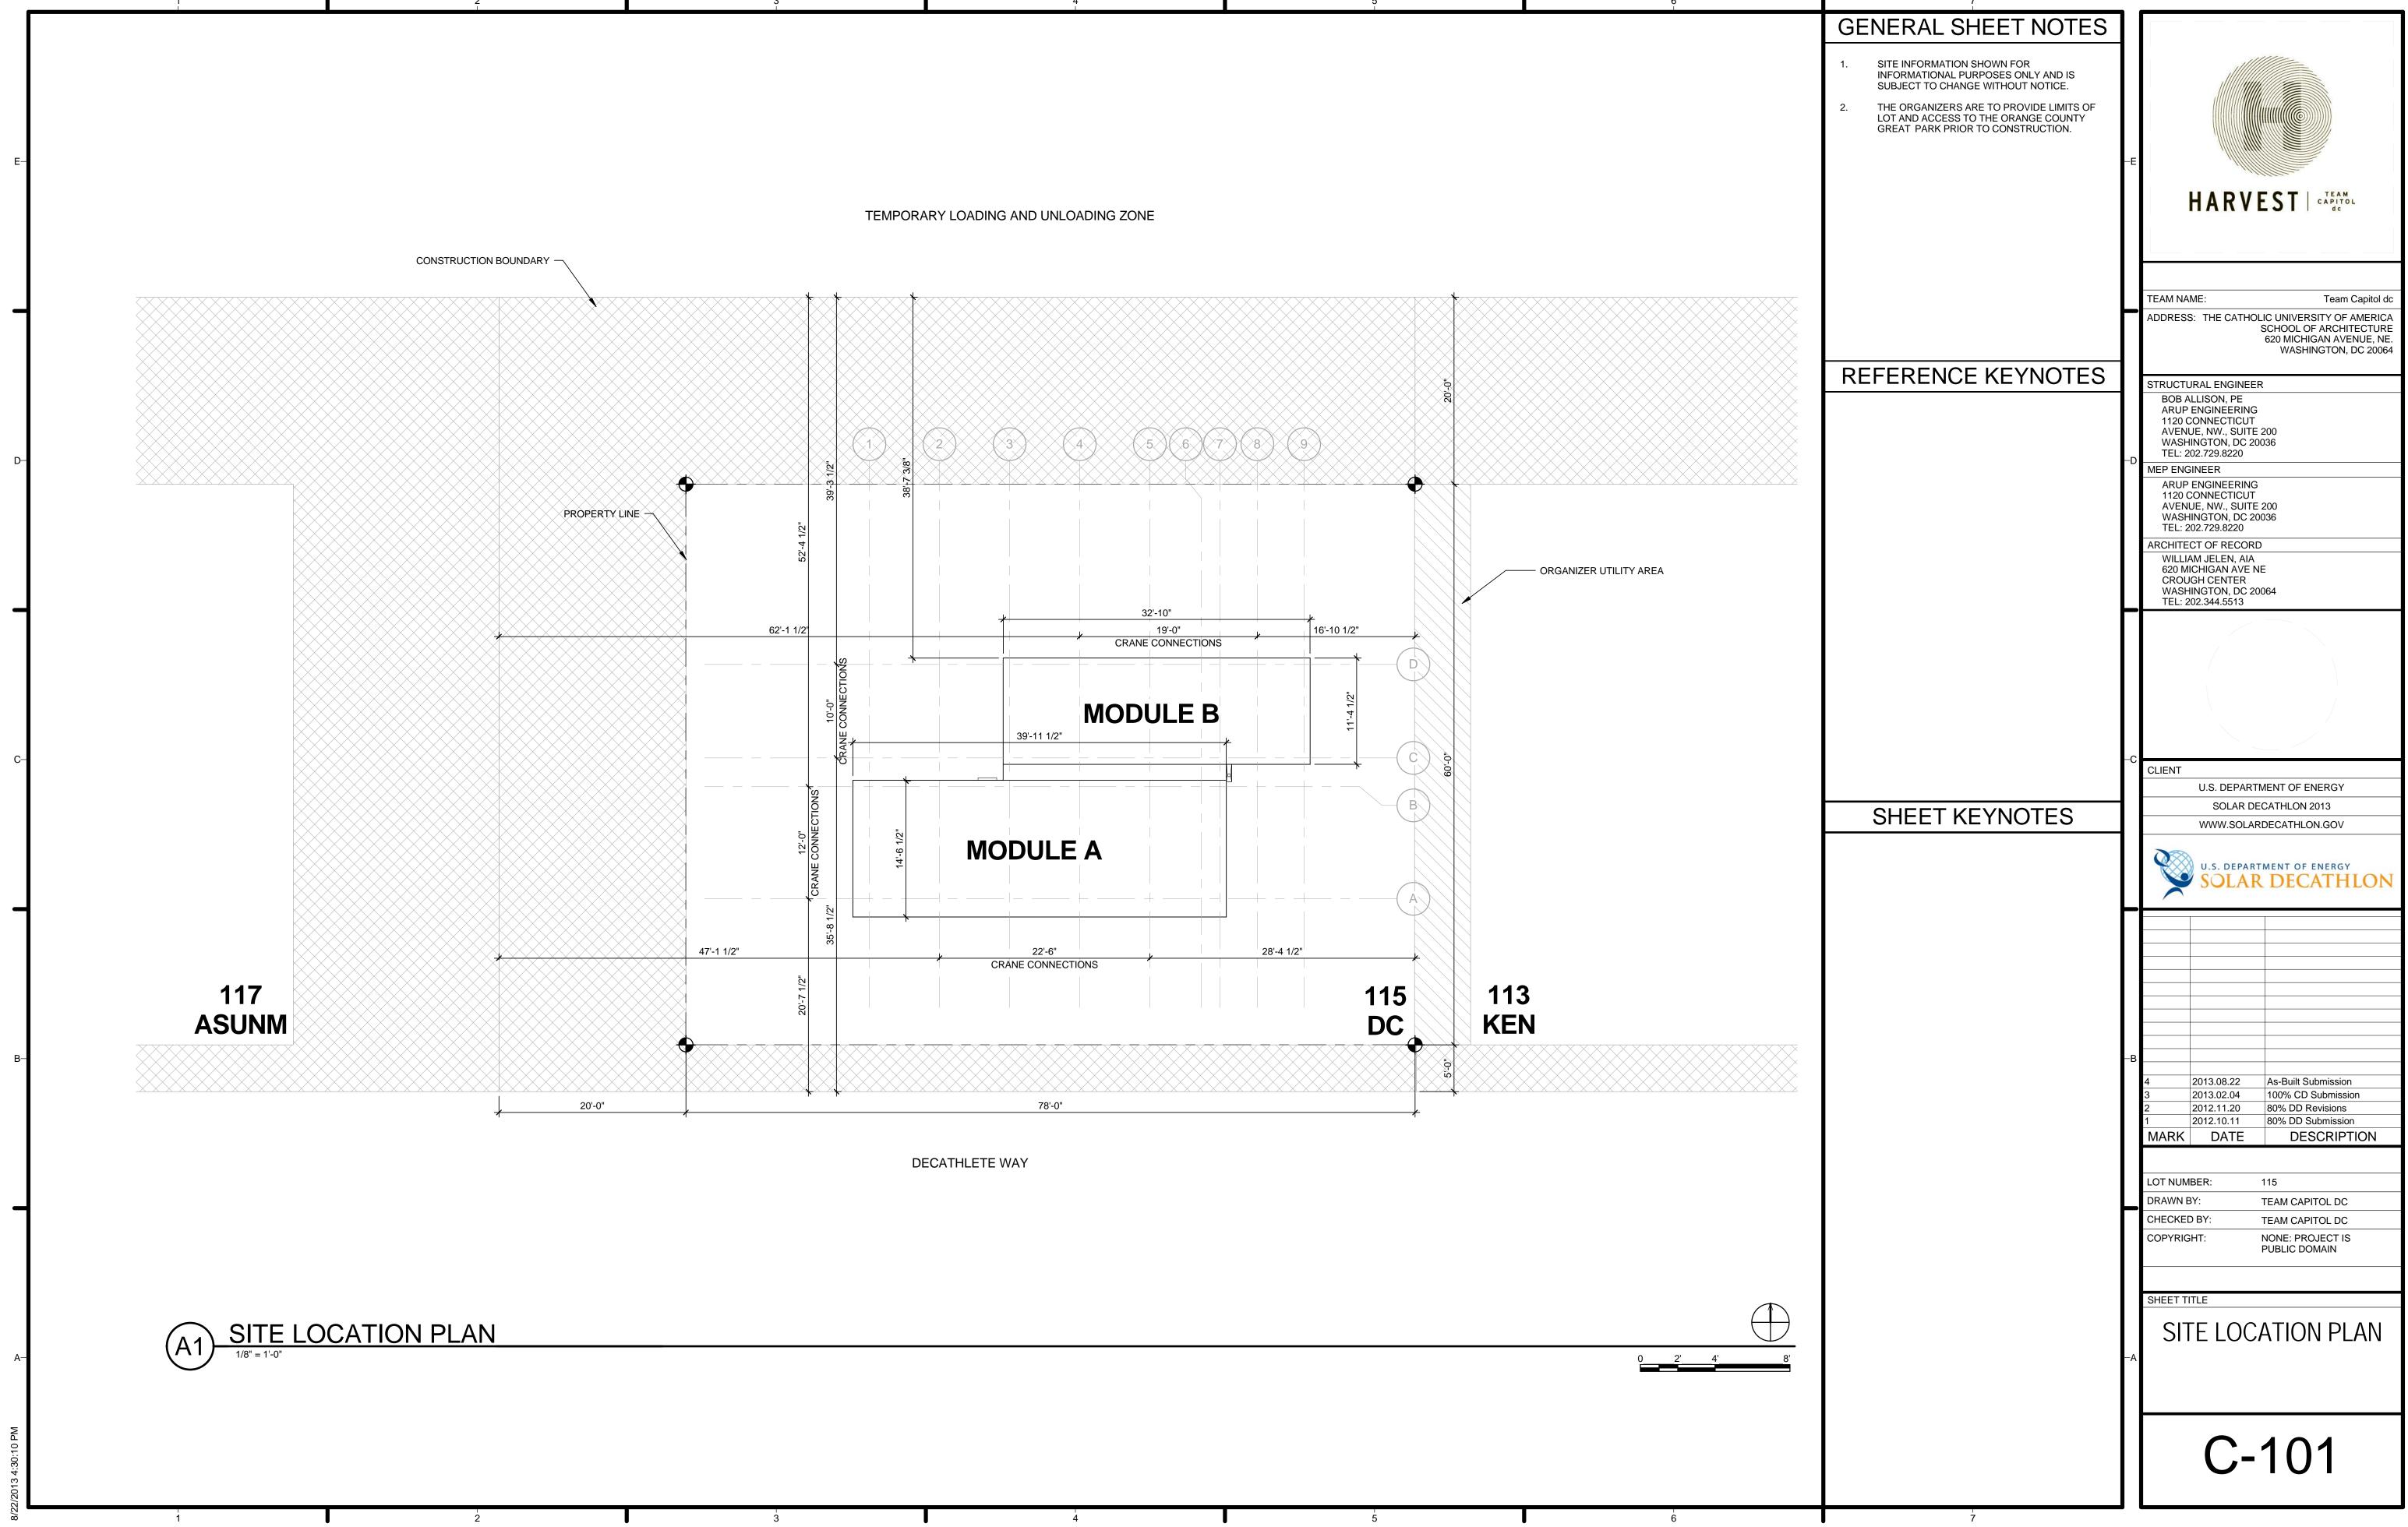
1. HARVEST TABLE DECK 2. MECHANICAL ROOM 3. LIVING ROOM 4. KITCHEN (AND BATHROOM) 6. COMING OUT OF THE HOUSE; DECK **EXHIBIT SIGNS** A. EXHIBIT SIGN #1: THE STORY OF HARVEST B. EXHIBIT SIGN #2: WELCOME C. EXHIBIT SIGN #3: RECLAIMED MATERIAL D. EXHIBIT SIGN #4: SUSTAINABLE LANDSCAPE PT.1 E. EXHIBIT SIGN #5: SUSTAINABLE LANDSCAPE PT.2 F. EXHIBIT SIGN #6: WOUNDED WARRIOR HOME G. EXHIBIT SIGN #7: INTERACTIVE SCREEN H. EXHIBIT SIGN #8: THANK YOU **FACTOID SIGNS** a. THERMAL ENVELOPE b. NATIVE PLANTS c. OUTDOOR LIVING d. PORTABLE GROWING SYSTEMS e. SOLAR ARRAY f. SOLAR THERMAL SYSTEM g. BUILDING CONTROL SYSTEM j. LIGHTING k. INTERACTIVE SCREEN I. STEEL STRUCTURE m. PORCELAIN TILES n. LOW FLOW FIXTURES **0. POLYPROPYLENE PIPING SYSTEM** p. RECLAIMED WOOD q. LAUNDRY LINE s. EDIBLE GARDEN **u. RAINWATER COLLECTION**

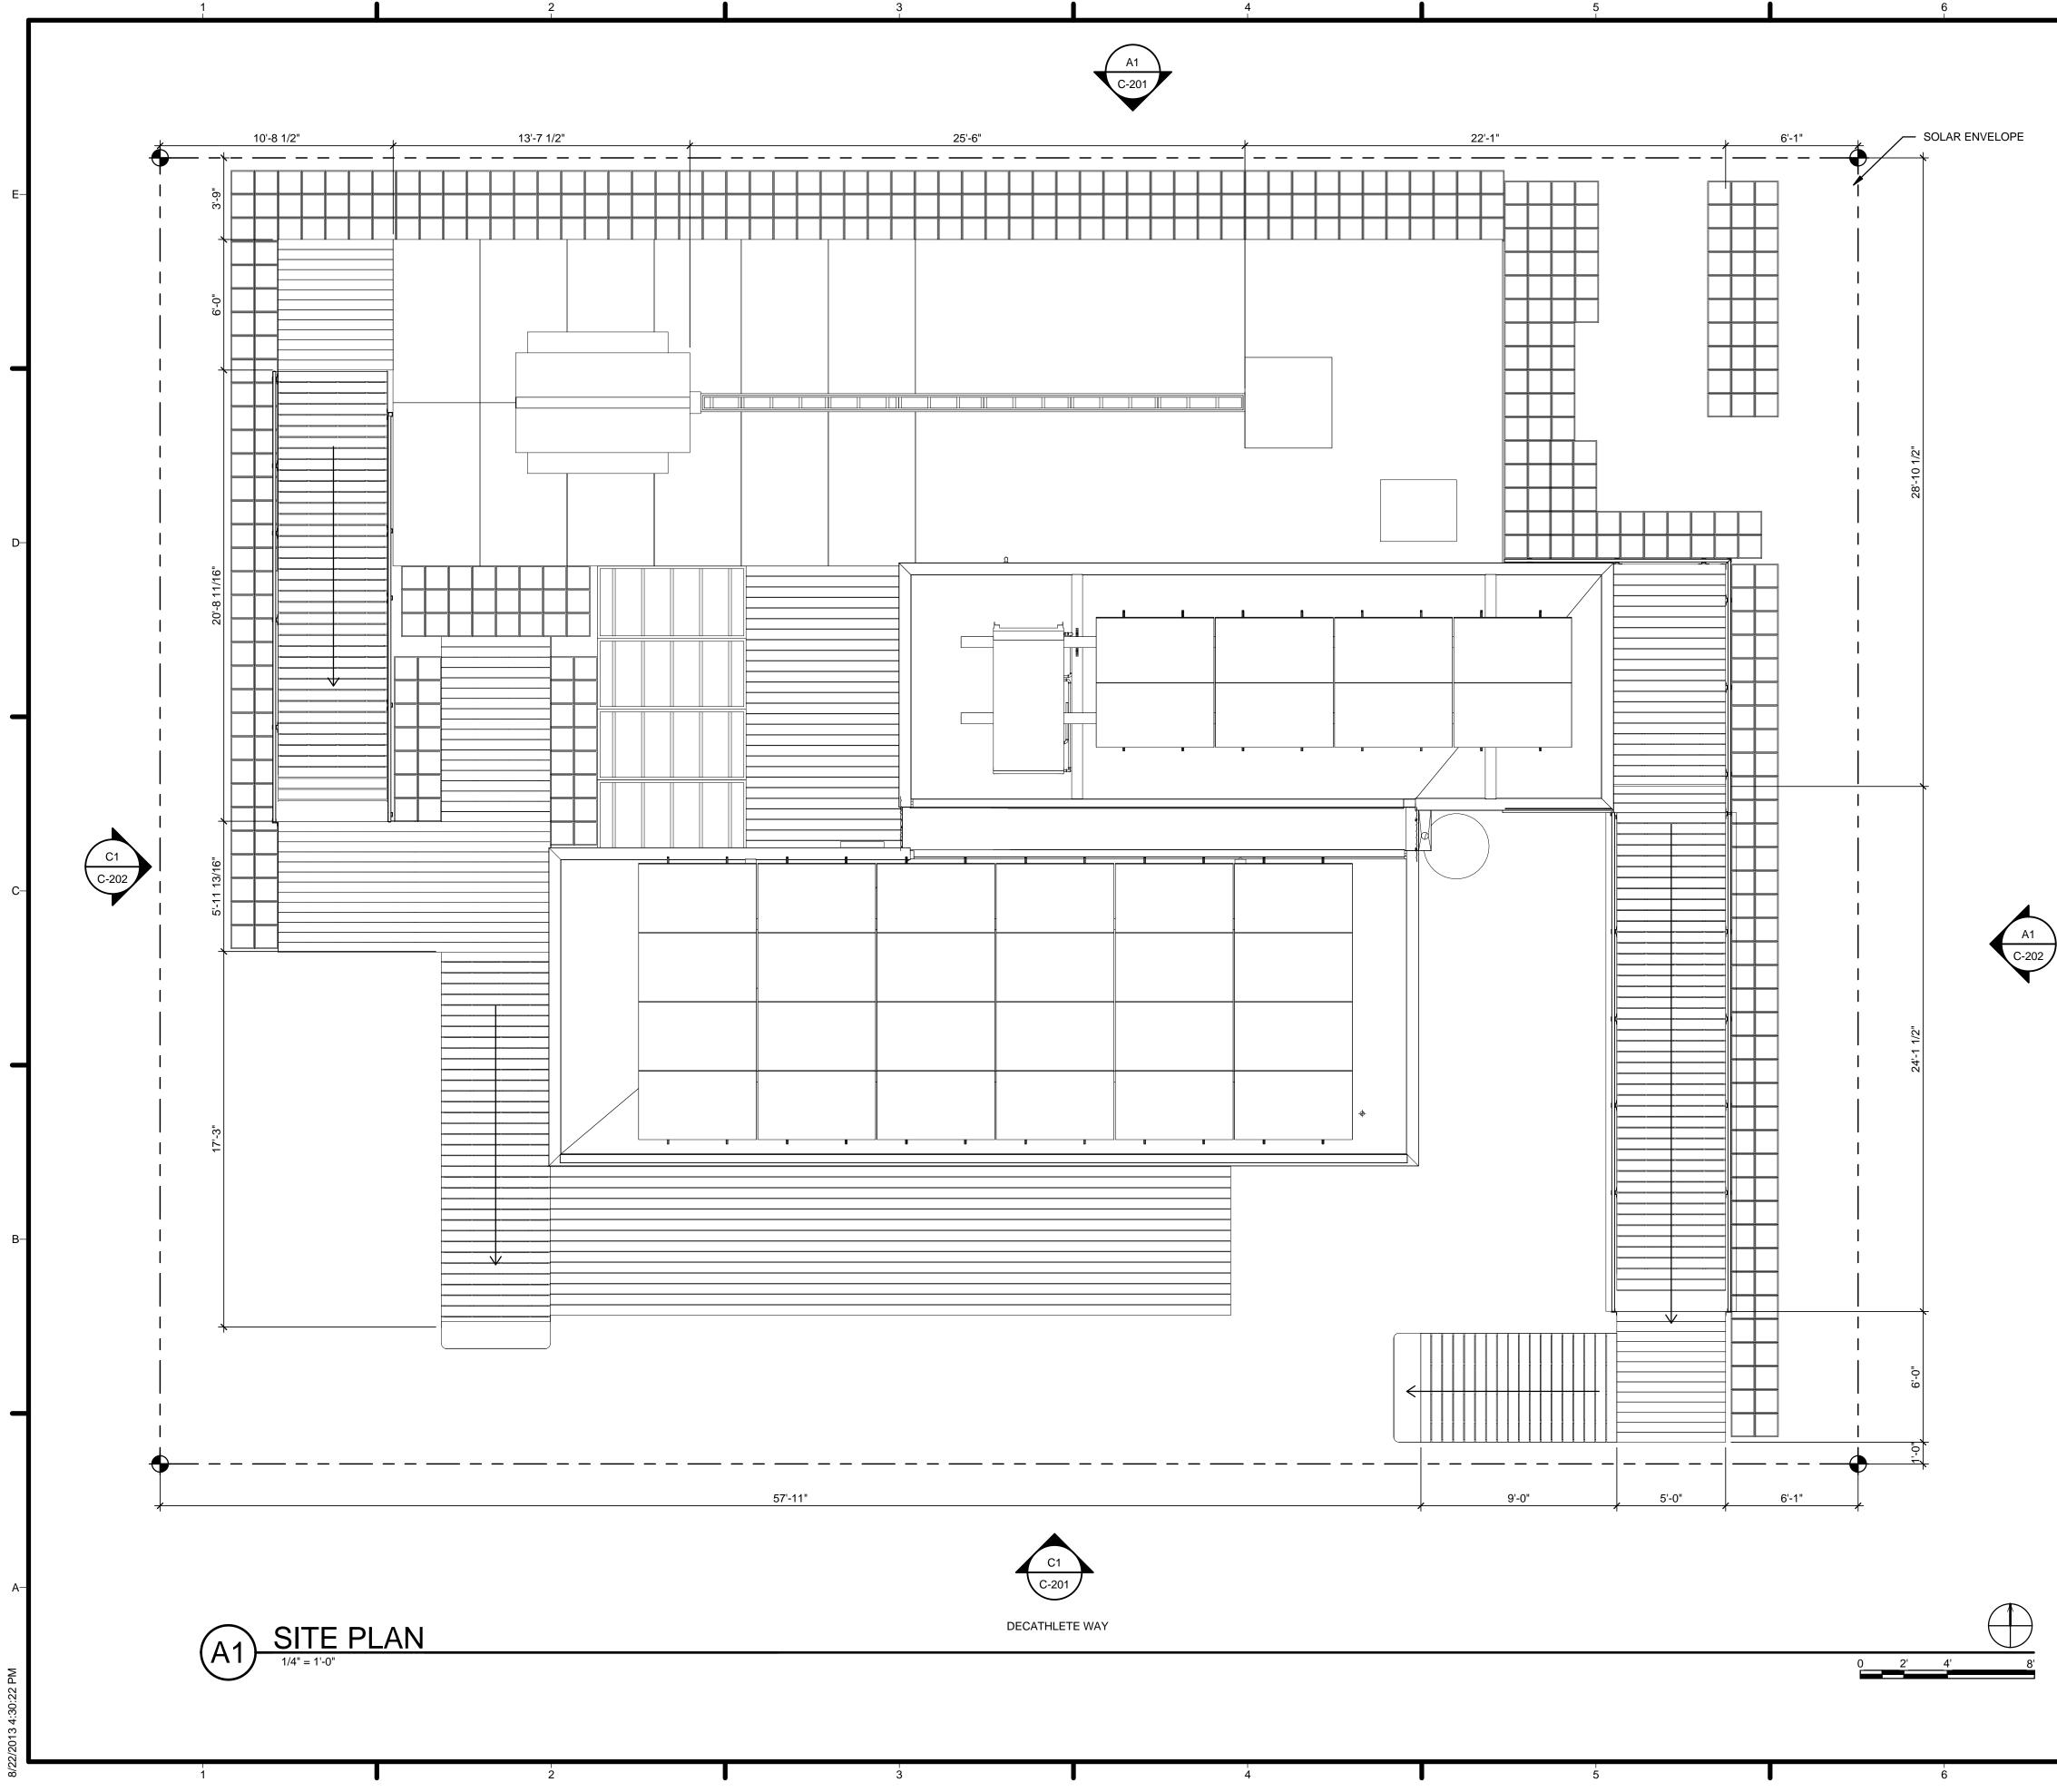
- h. COMPOSTING i. ACCESSIBILITY

- r. GREYWATER
- t. BEES

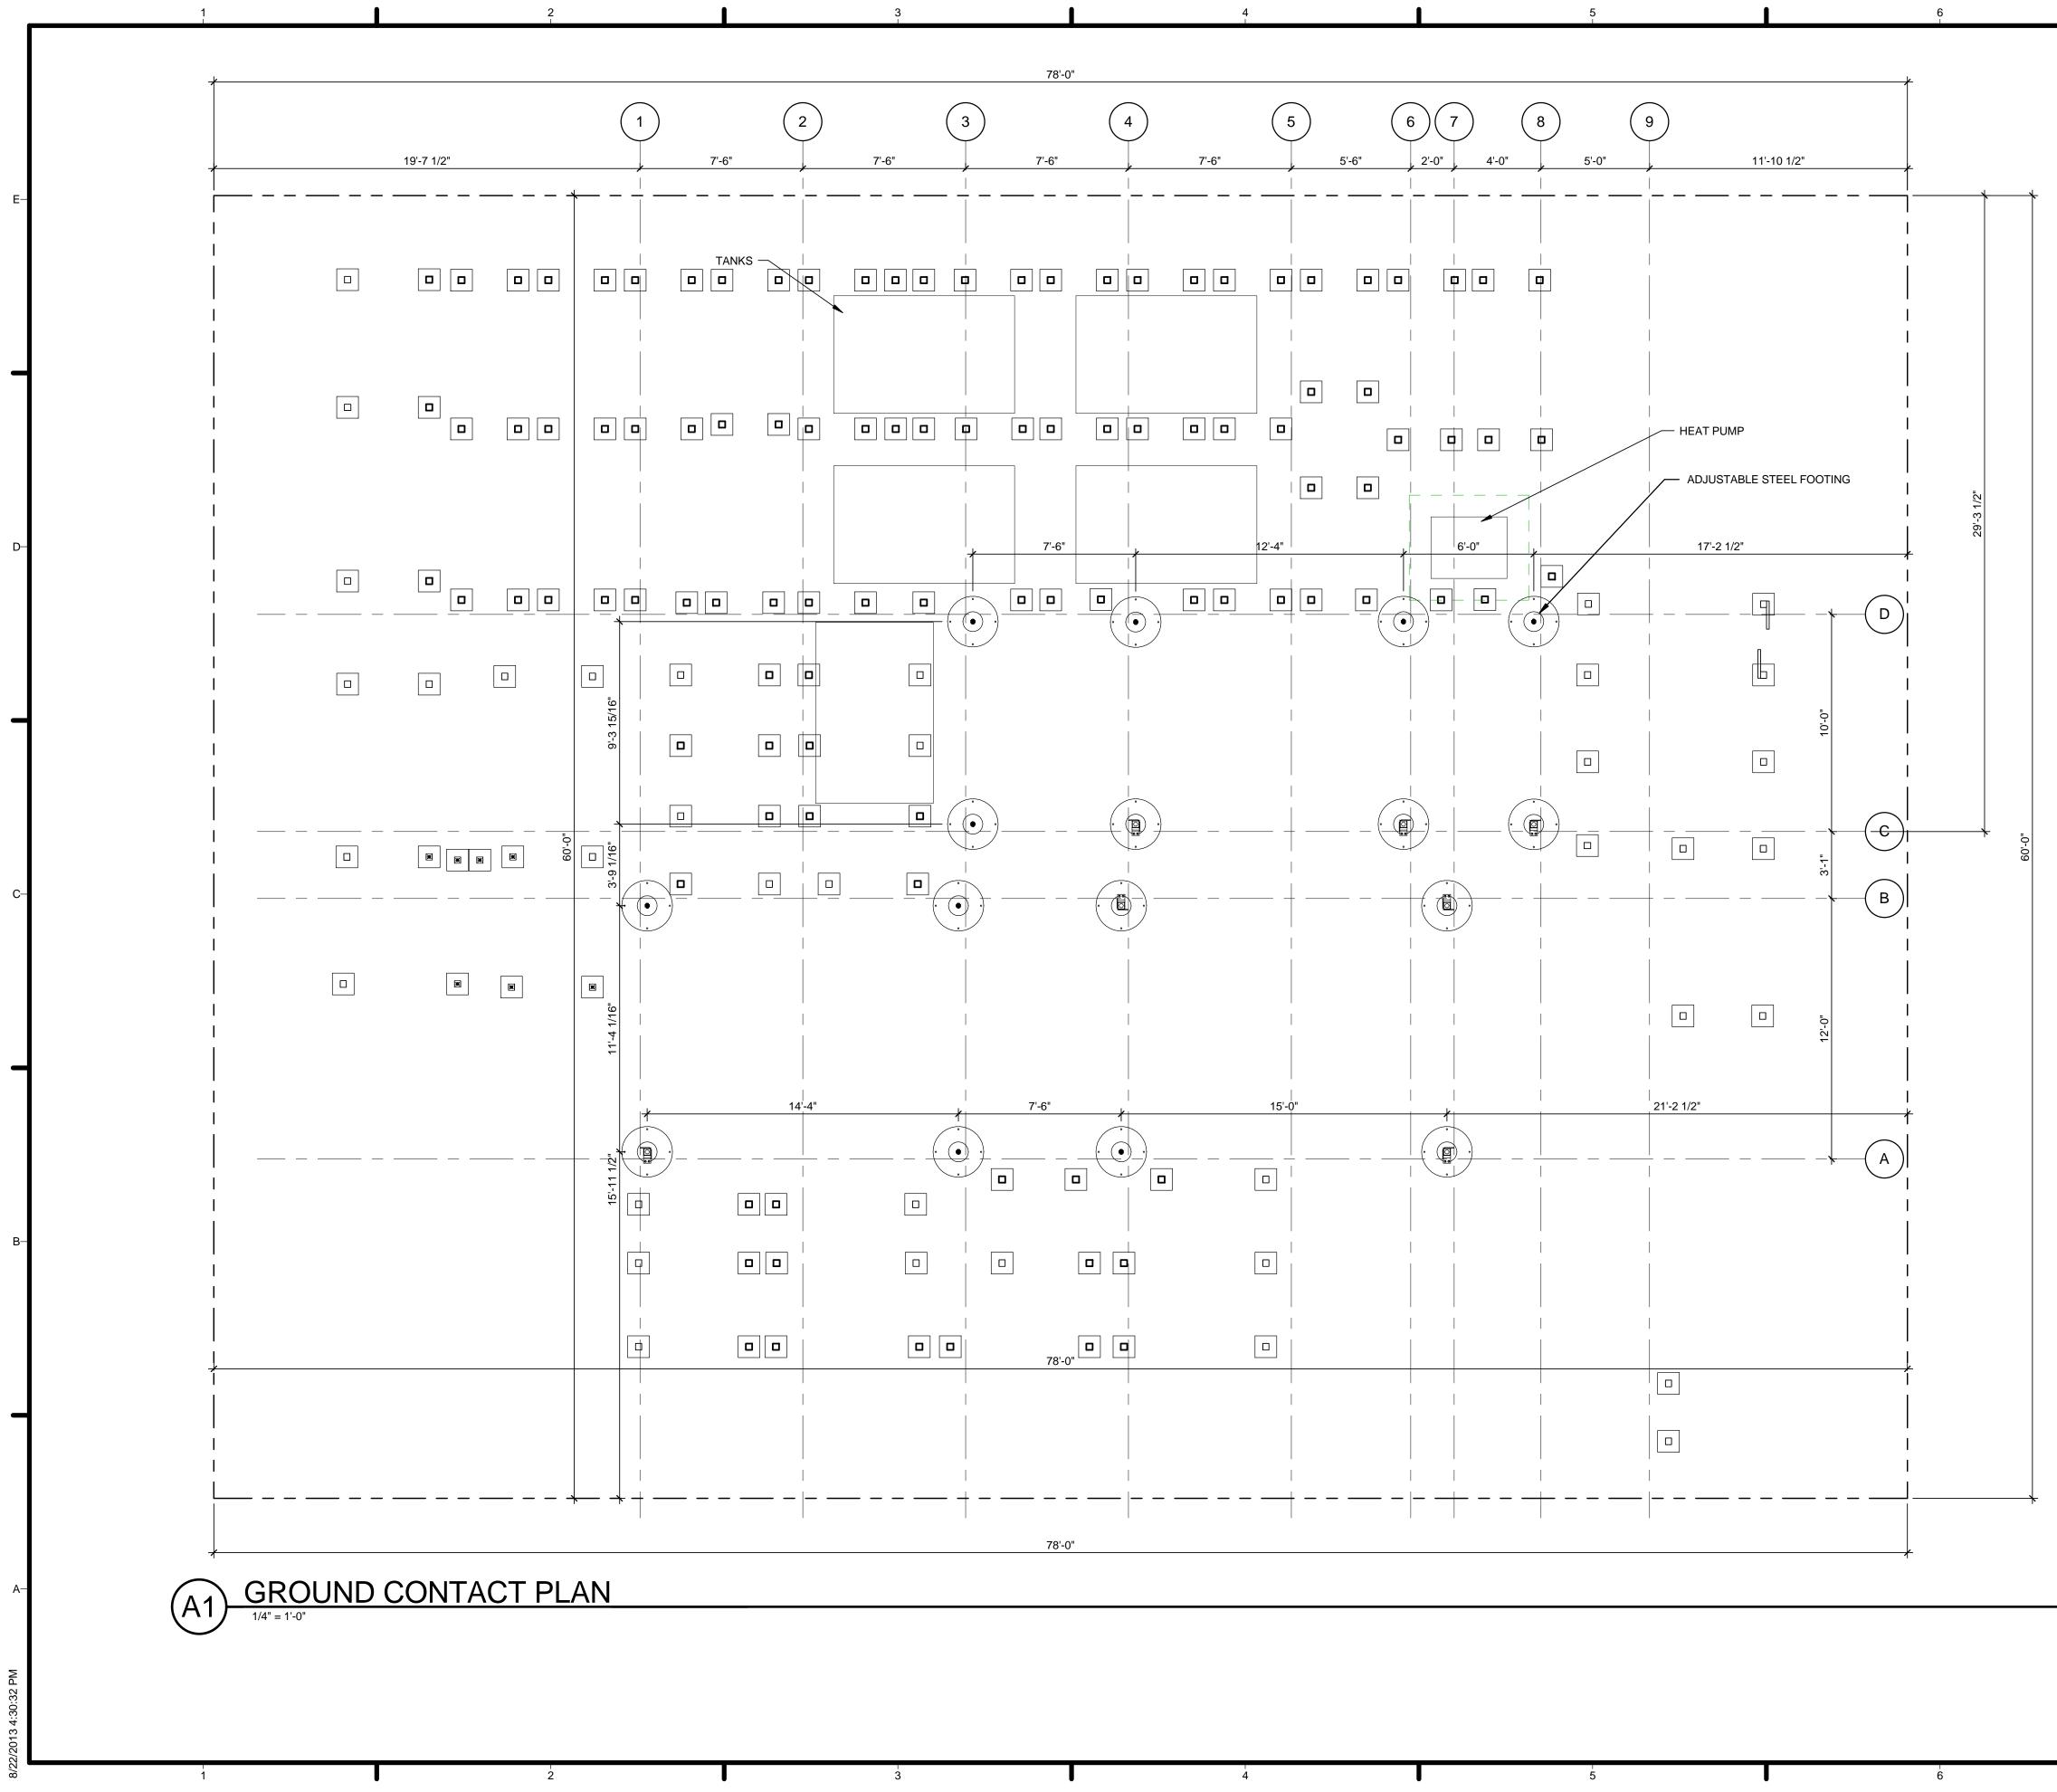


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REFERENCE KEYNOTES	TEAM NAME: Team Capitol dc ADDRESS: THE CATHOLIC UNIVERSITY OF AMERICA SCHOOL OF ARCHITECTURE 620 MICHIGAN AVENUE, NE. WASHINGTON, DC 20064 STRUCTURAL ENGINEER BOB ALLISON, PE ARUP ENGINEERING 1120 CONNECTICUT
	AVENUE, NW., SUITE 200 WASHINGTON, DC 20036 TEL: 202.729.8220 MEP ENGINEER ARUP ENGINEERING 1120 CONNECTICUT AVENUE, NW., SUITE 200 WASHINGTON, DC 20036 TEL: 202.729.8220 ARCHITECT OF RECORD WILLIAM JELEN, AIA 620 MICHIGAN AVE NE CROUGH CENTER WASHINGTON, DC 20064
	TEL: 202.344.5513
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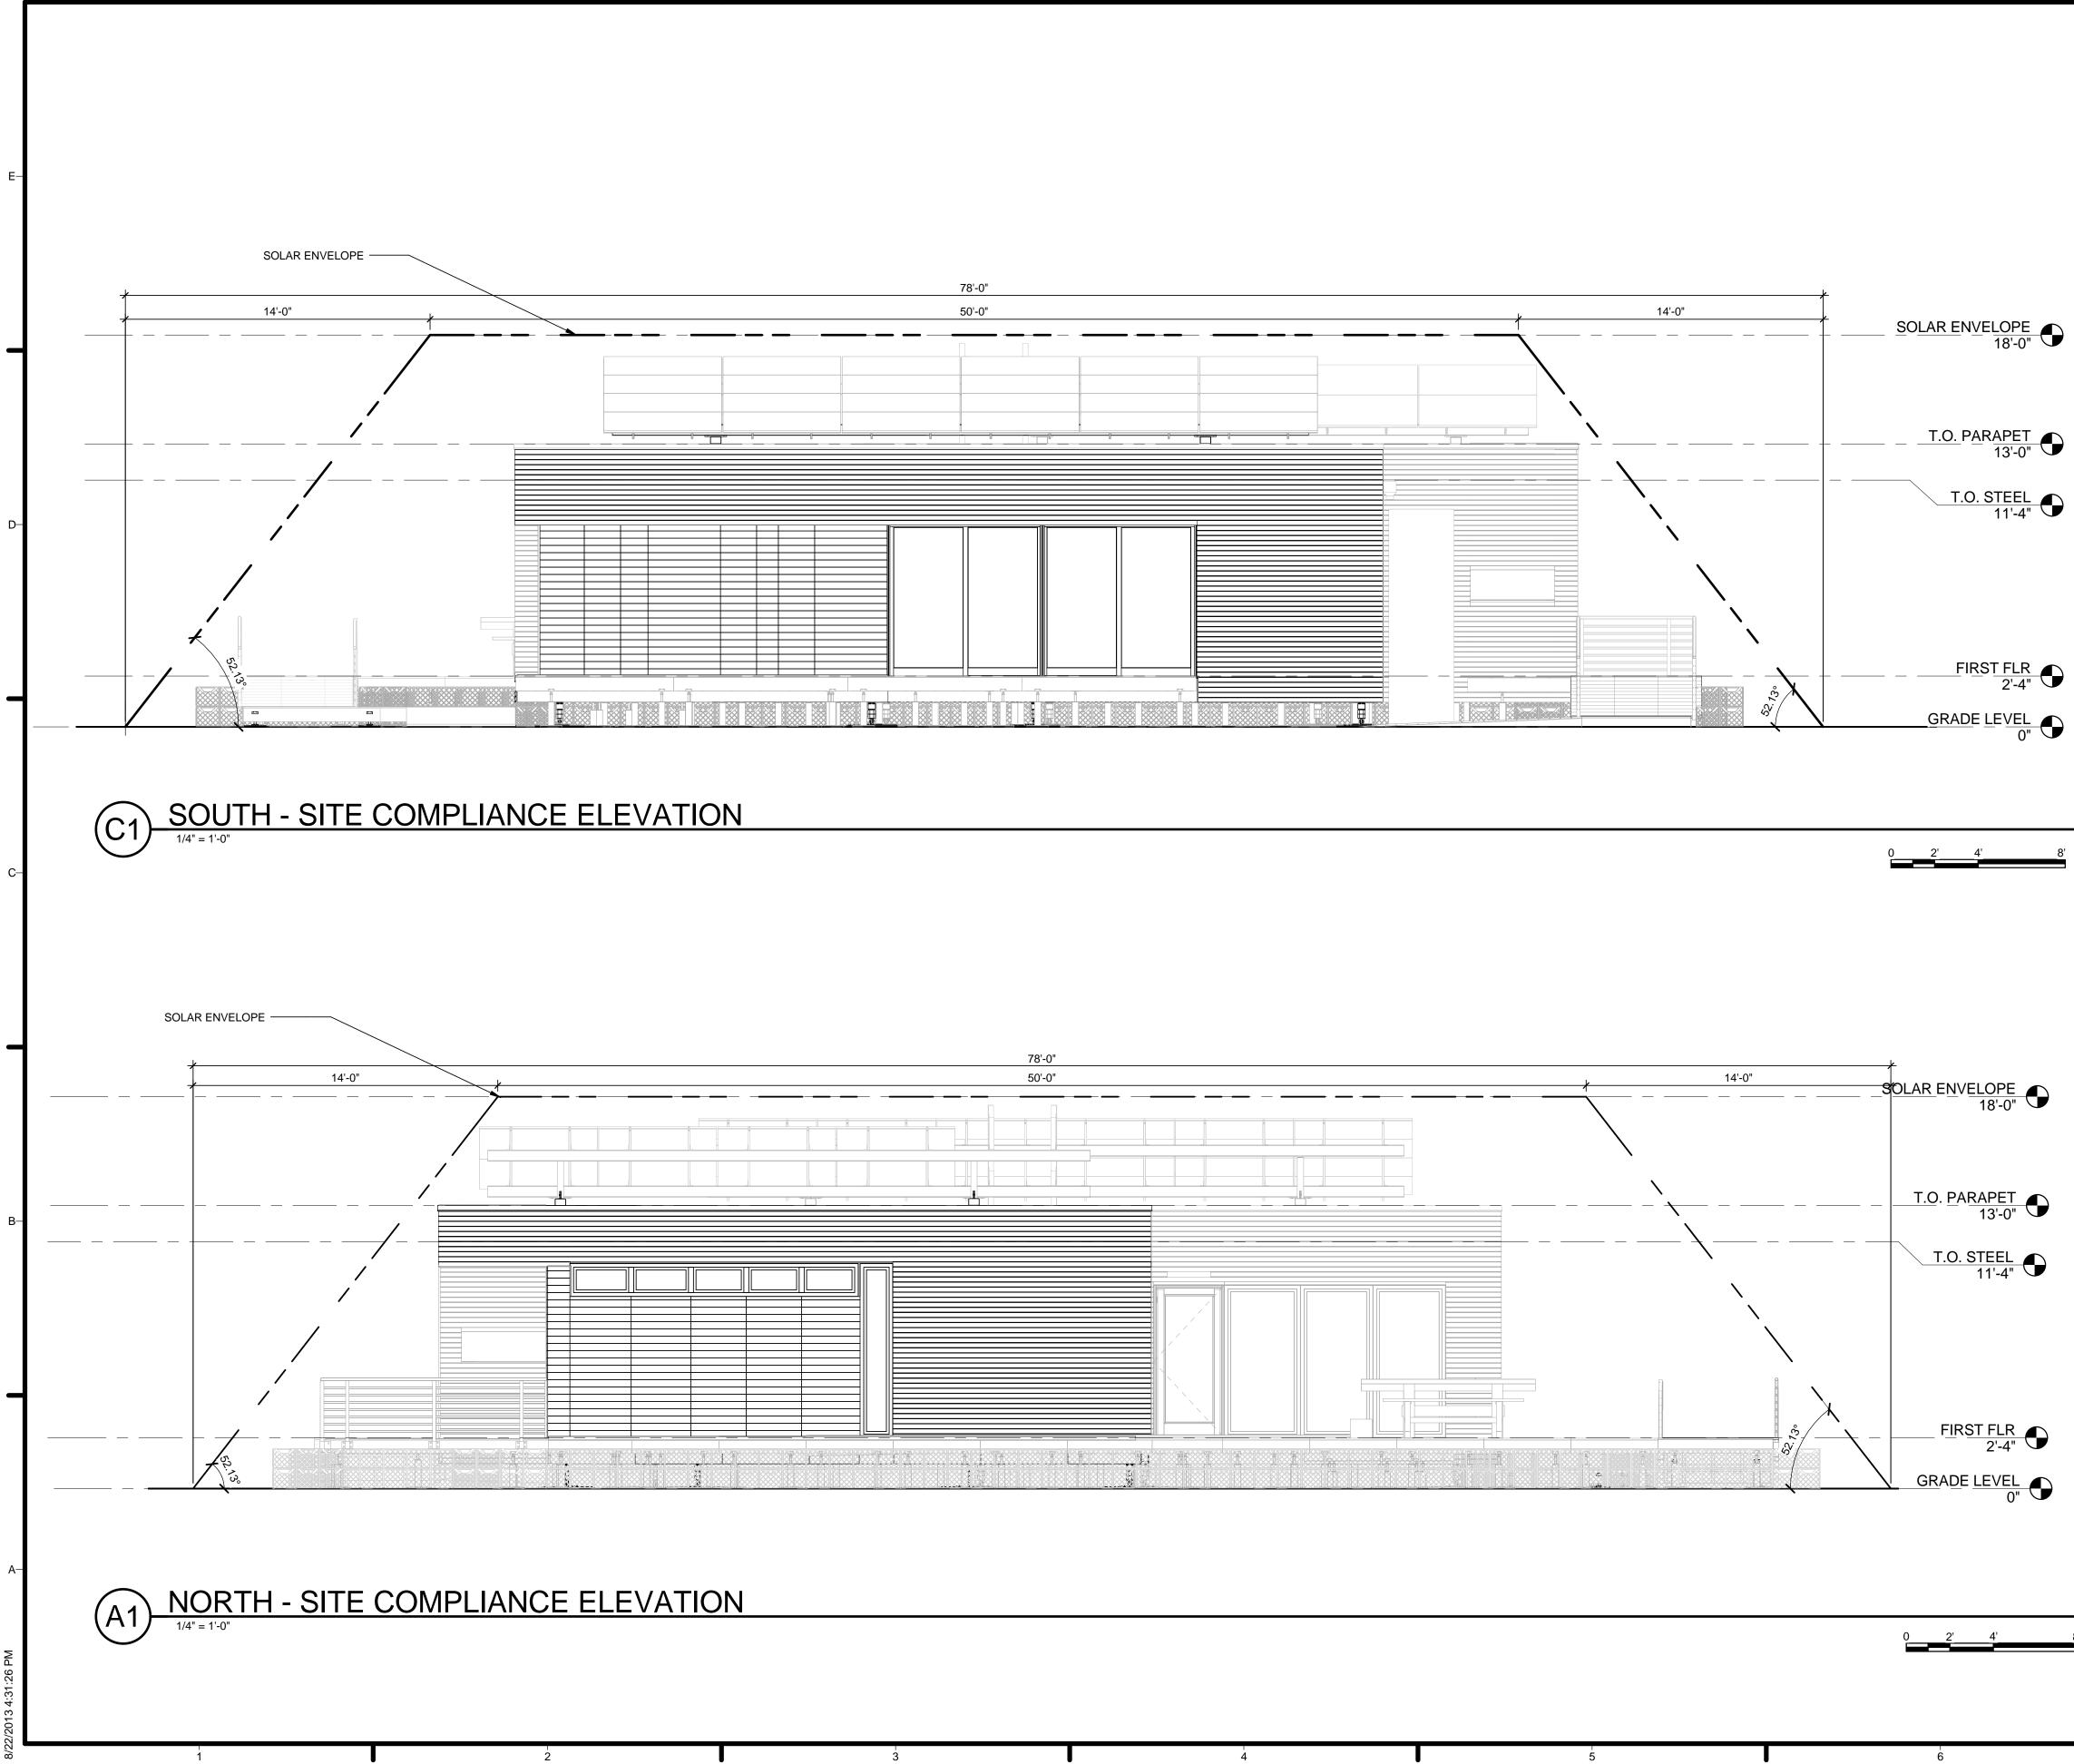




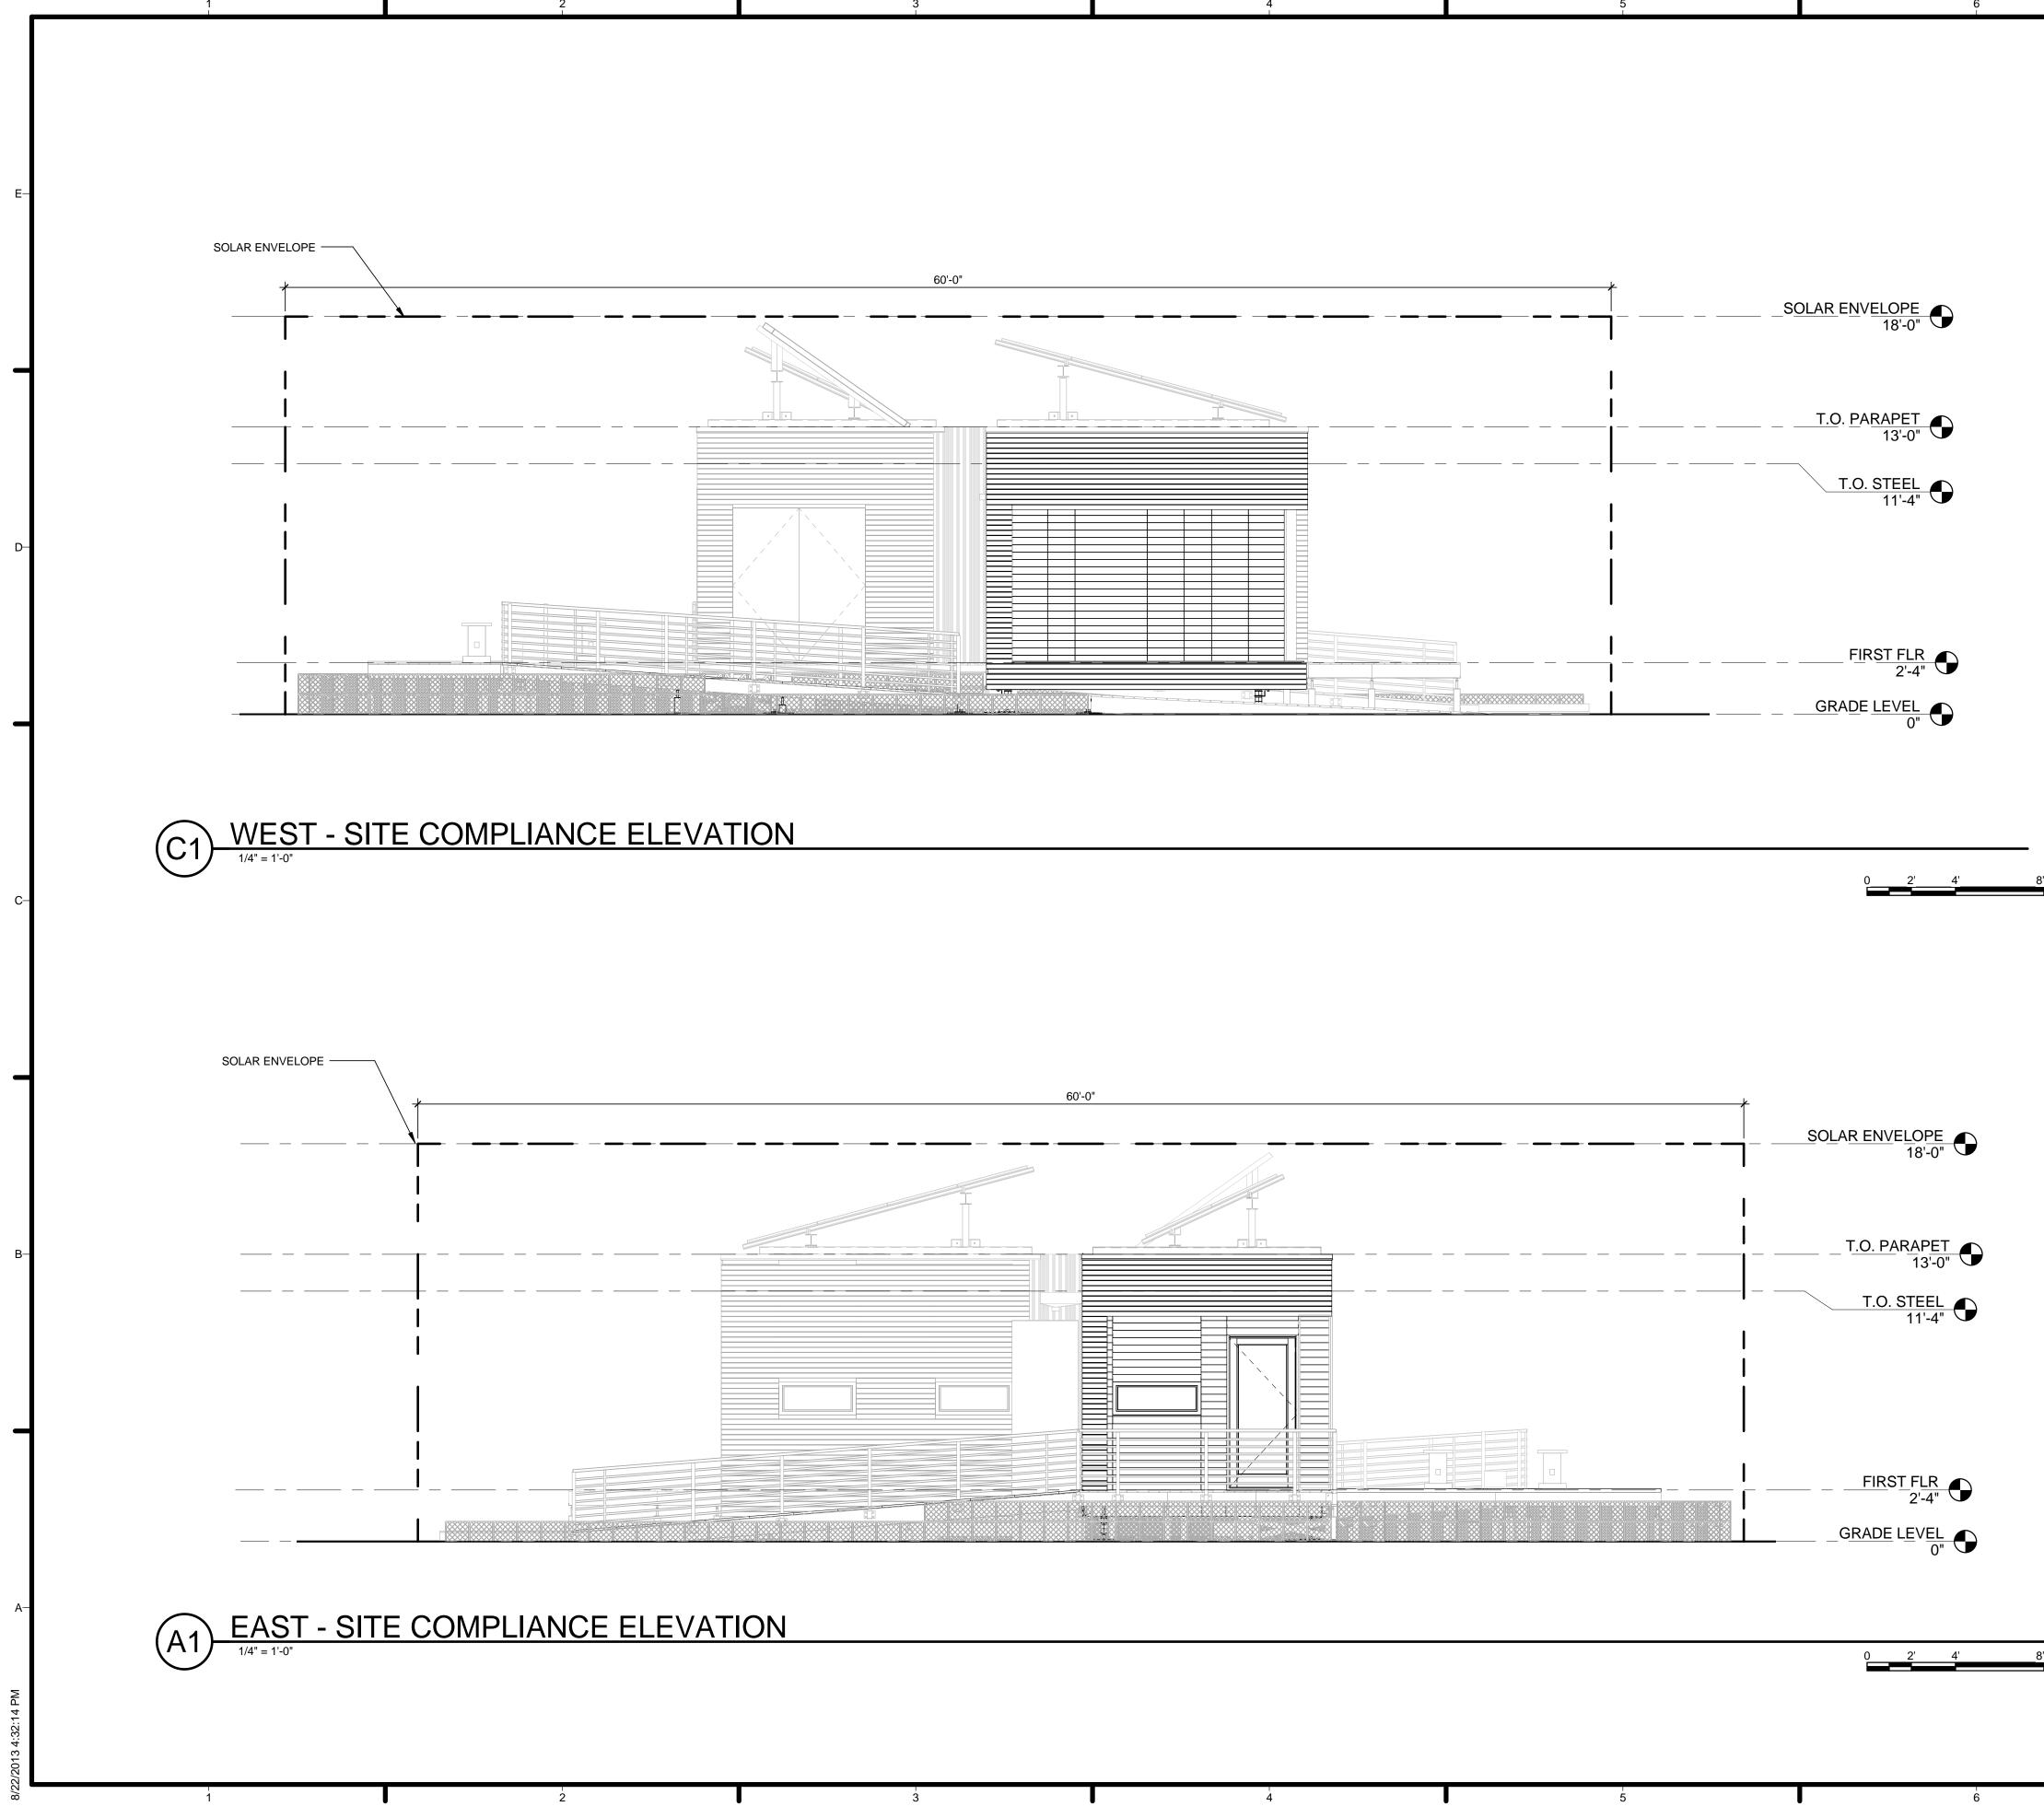
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GENERAL SHEET NOTES			
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		TEAM NAME: Team Capitol dc
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		SCHOOL OF ARCHITECTURE 620 MICHIGAN AVENUE, NE.
		WASHINGTON, DC 20064
REFERENCE KEYNOTES		STRUCTURAL ENGINEER
05 12 23.E1 ADJUSTABLE STEEL FOOTING		BOB ALLISON, PE ARUP ENGINEERING
		1120 CONNECTICUT AVENUE, NW., SUITE 200
	-D	WASHINGTON, DC 20036 TEL: 202.729.8220
		MEP ENGINEER ARUP ENGINEERING
		1120 CONNECTICUT AVENUE, NW., SUITE 200
		WASHINGTON, DC 20036 TEL: 202.729.8220
		WILLIAM JELEN, AIA 620 MICHIGAN AVE NE CROUGH CENTER
		WASHINGTON, DC 20064 TEL: 202.344.5513
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	7 GENERAL SHEET NOTES		
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	REFERENCE KEYNOTES		TEAM NAME: Team Capitol dc ADDRESS: THE CATHOLIC UNIVERSITY OF AMERICA SCHOOL OF ARCHITECTURE 620 MICHIGAN AVENUE, NE. WASHINGTON, DC 20064
		-D	MEP ENGINEER ARUP ENGINEERING 1120 CONNECTICUT AVENUE, NW., SUITE 200 WASHINGTON, DC 20036 TEL: 202.729.8220 ARCHITECT OF RECORD WILLIAM JELEN, AIA 620 MICHIGAN AVE NE CROUGH CENTER WASHINGTON, DC 20064
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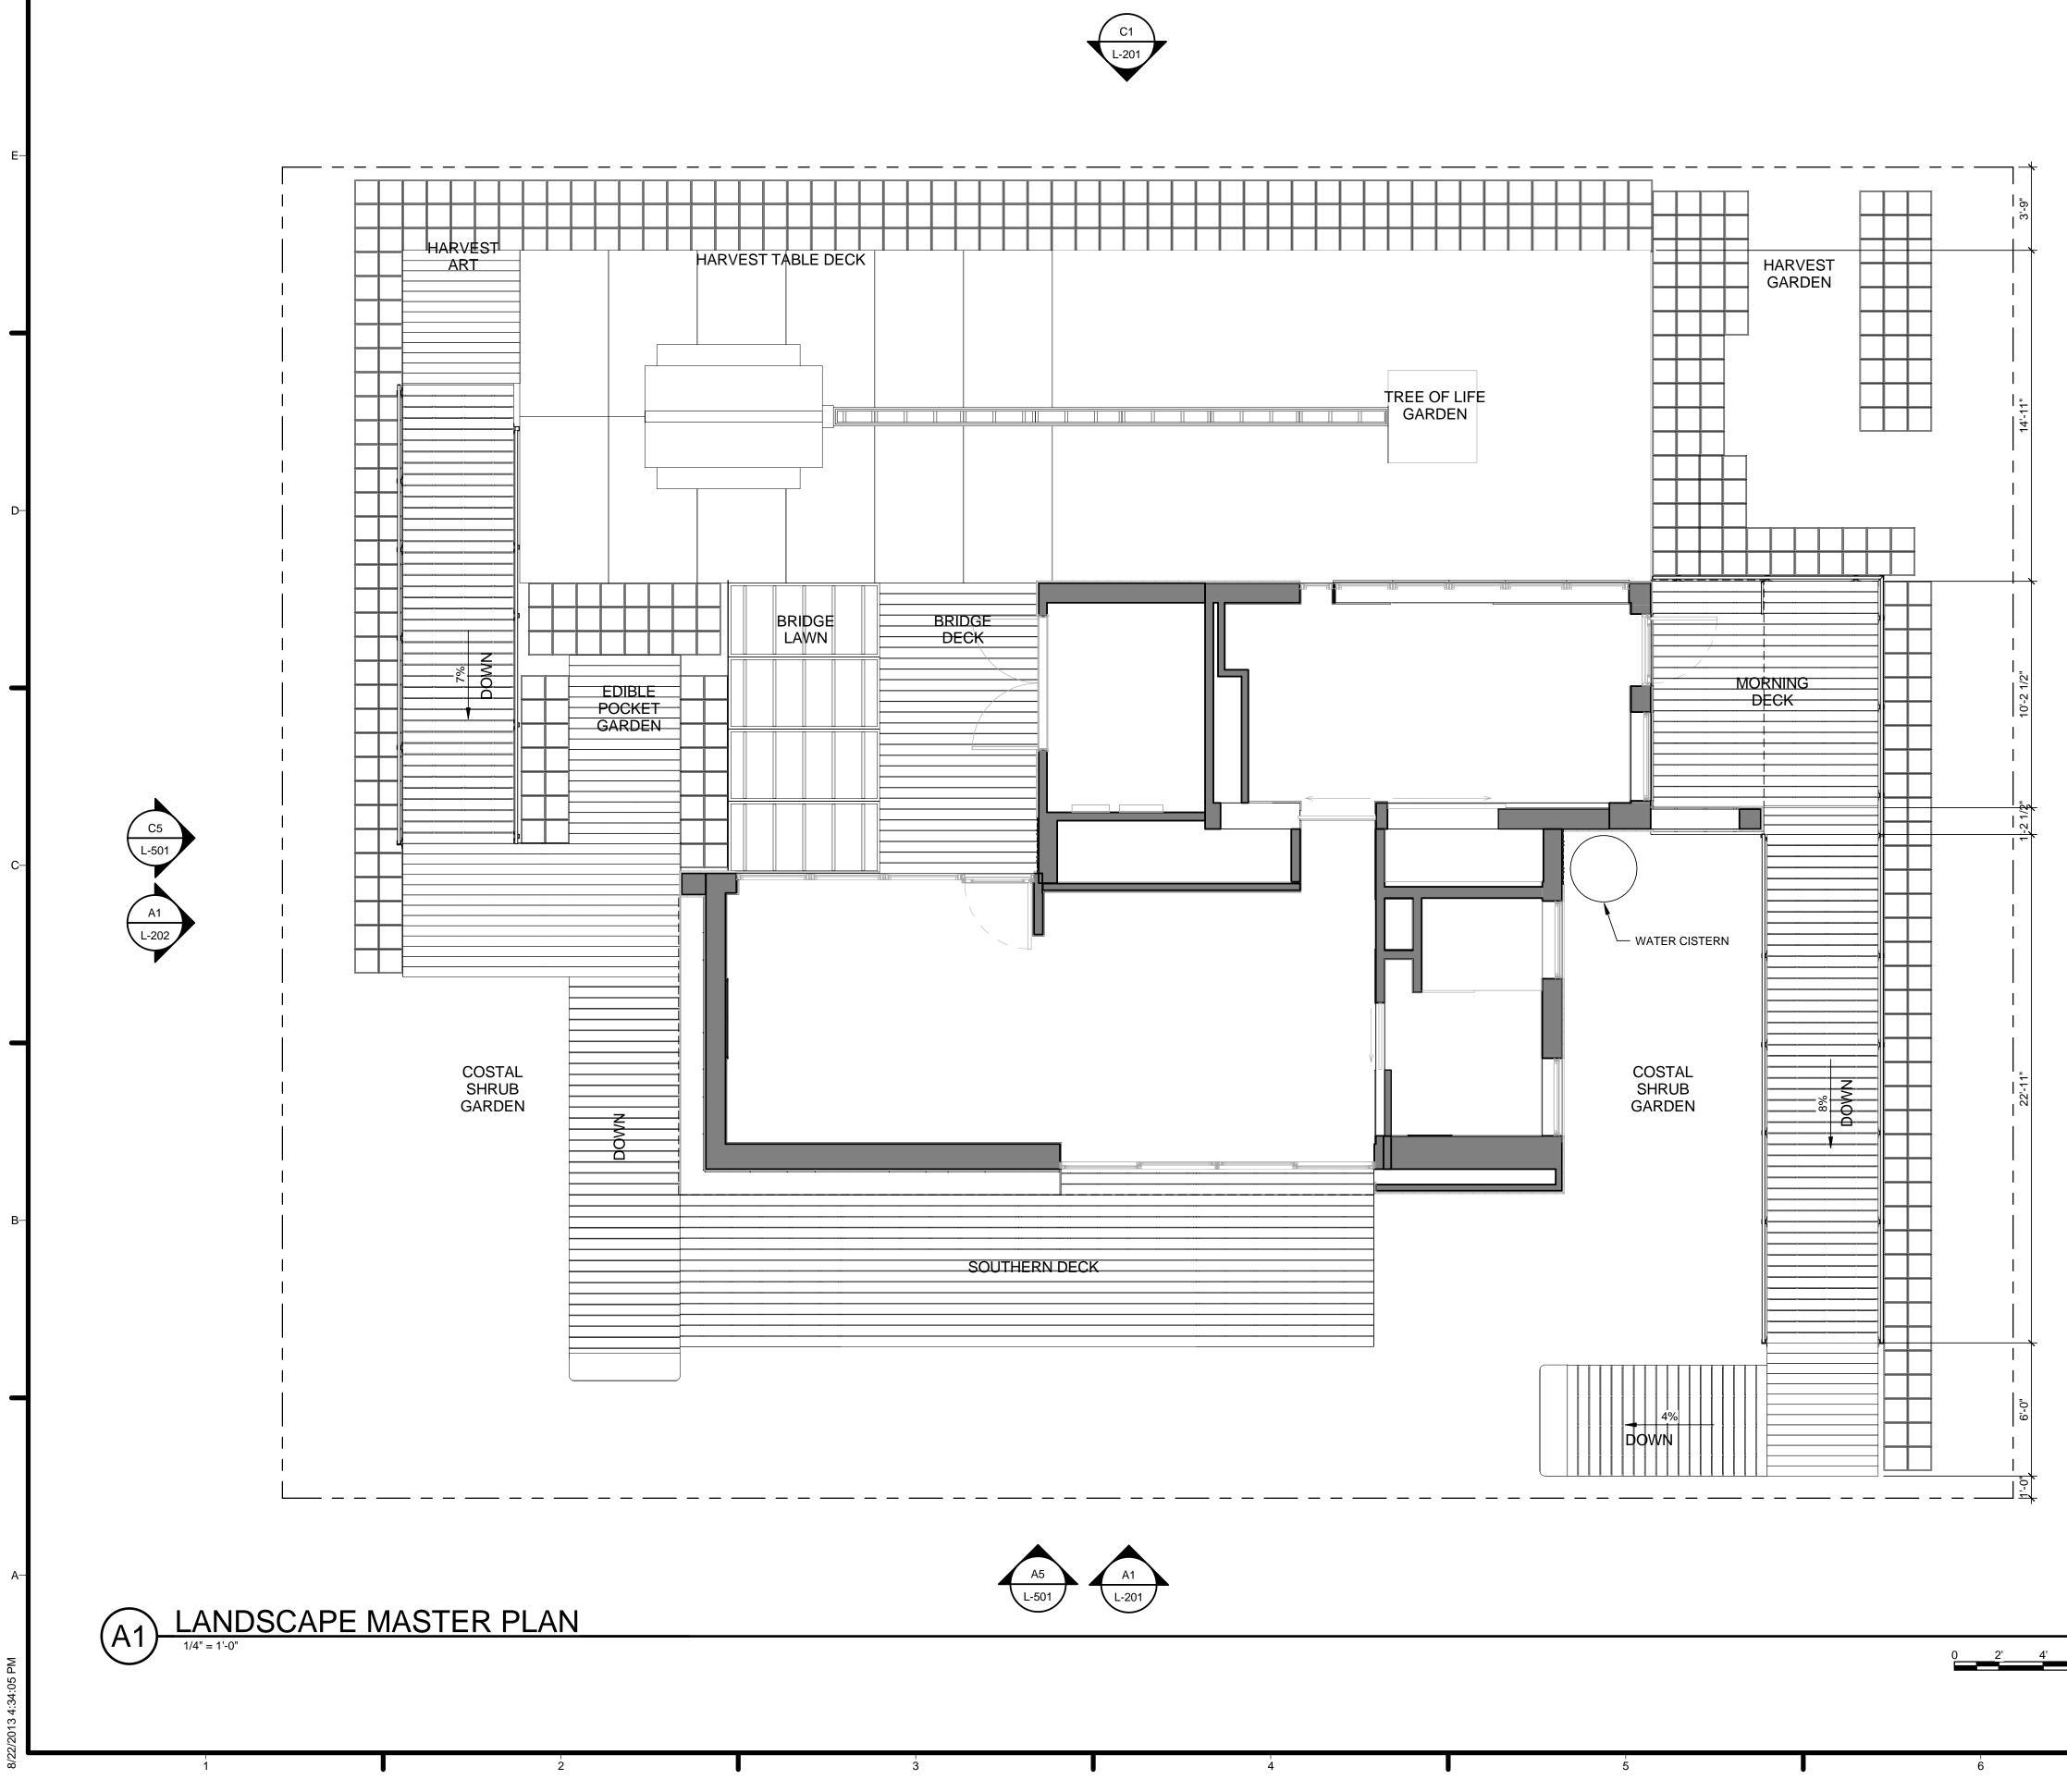
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REFERENCE KEYNOTES	-D	MEP ENGINEER ARUP ENGINEERING
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		U.S. DEPARTMENT OF ENERGY
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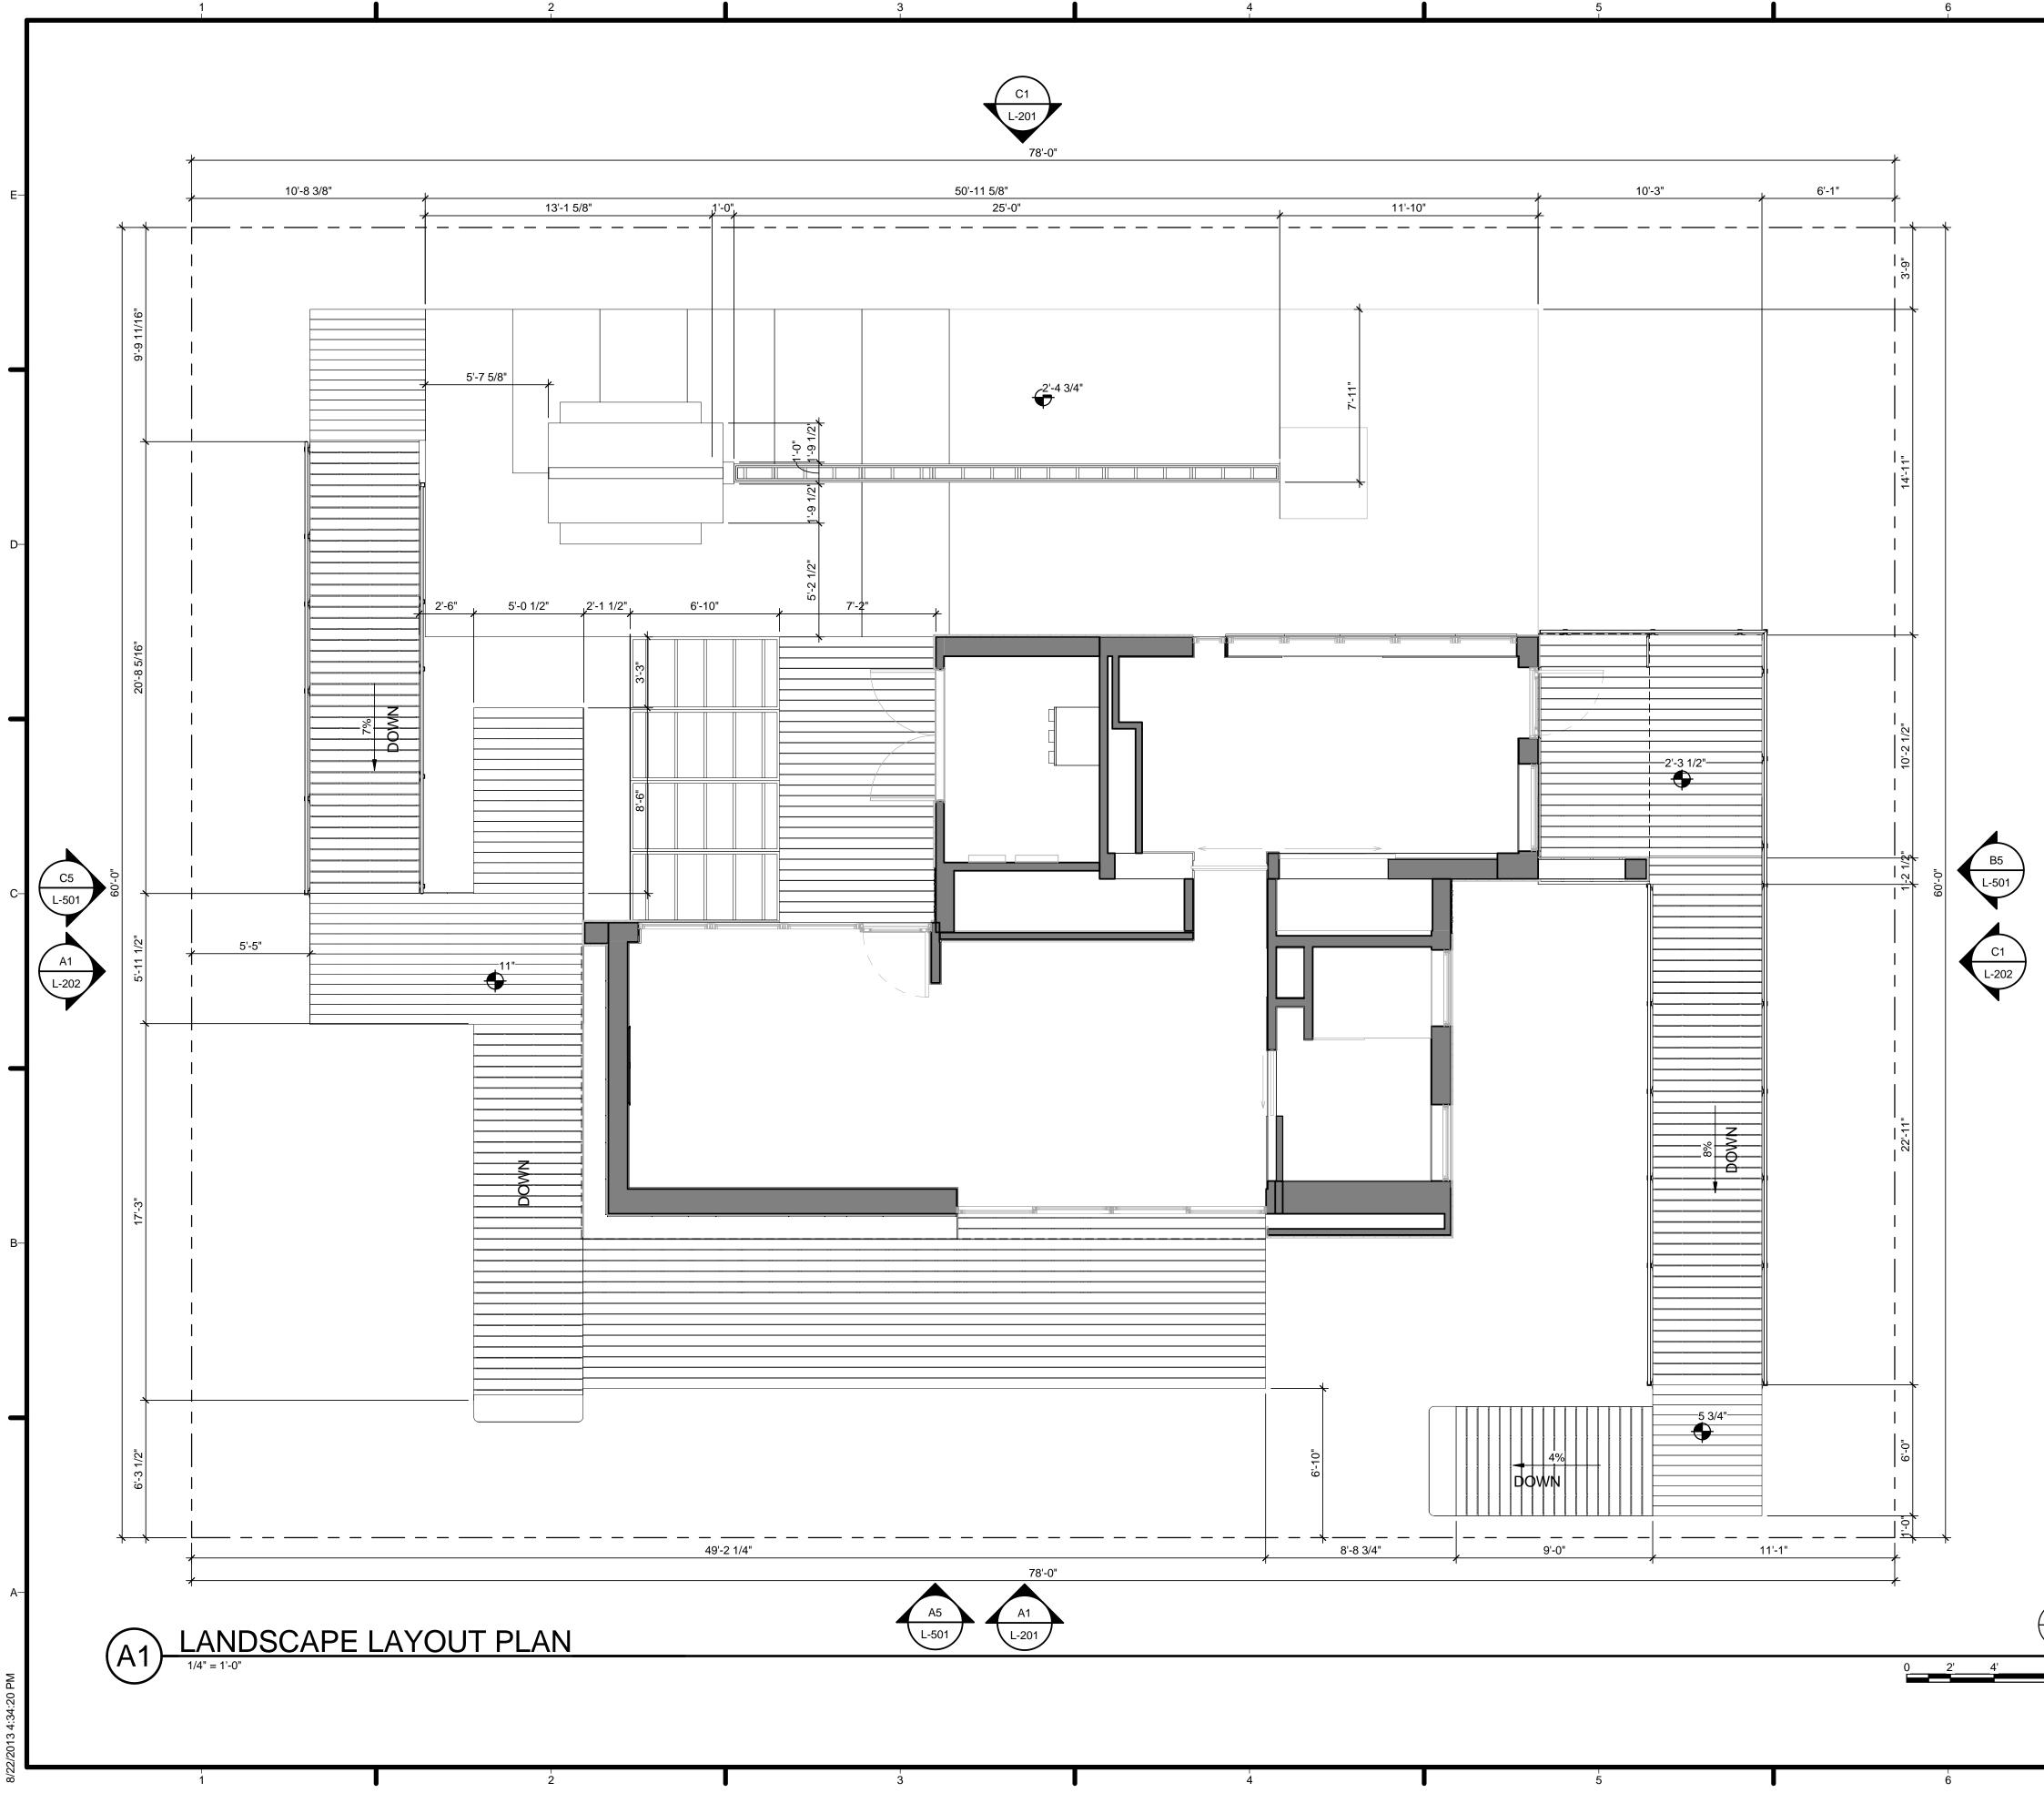
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LOCATION	QUANTITY	BOTANICAL NAME	COMMON NAME	SIZE	SPACING NOTES
NATIVE COASTAL SHRUB GARDEN	9 28 28 30	AGAVE AMERICANA MUHLENBERGIA RIGENS TRICHOSTEMA LANTUM SALVIA APIANA	CENTURY PLANT DEER GRASS WOOLY BLUE CURLS WHITE SAGE	15 GAL 5 GAL 5 GAL 5 GAL 5 GAL	ACCEN T 24" OC 24" OC 24" OC
TREE OF LIFE GARDEN	1 318	ARCTOSTAPHYLOS GAUCA FRAGARIA CHILOENSIS	BIG MANZANITA COASTAL STRAWBERRY	48" BOX 10"X 20 TRAYS	USED AS SOLID MASS
BRIDGE DECK LAWN	65	FRAGARIA CHILOENSIS	COASTAL STRAWBERRY	10"X20" TRAYS	USED AS SOLID MASS
EDIBLE BACK GARDEN	12	CYNARA SCOLYMUS DAUCUS CAROTA SUBSP. SATIVUS 'CIRCUS CIRCUS HELIANTHUS ANNUUS OCIMUM SANCTUM 'PURPLE'	AMARANTH ARTICHOKE TRI COLORED CARROTS SUNFLOWERS PURPLE BASIL TOMATOS EGGPLANT NASTURTIUM	MILK CRATE MILK CRATE MILK CRATE MILK CRATE MILK CRATE MILK CRATE MILK CRATE	
BACK AND SIDE MILK CRATES	182 24 22	MUHLENBERGIA RIGENS TRICHOSTEMA LANTUM SALVIA APIANA	DEER GRASS WOOLY BLUE CURLS WHITE SAGE	5 GAL 5 GAL 5 GAL	POTS PLACED IN MILK CRATES
HARVEST HOUSE PLANTER	97 25	JUNCUS PATENS SALVIA APIANA	WIRE GRASS WHITE SAGE	1 GAL 1 GAL	6" OC 6" OC
HARVEST TABLE		BRASSICA OLERACEA 'REDBOR' SALVIA OFFICINALIS 'ICETERINA' STENOCEREUS THURBERI TROPAEOLUM MAJUS 'ALASKA SALMON ORANGE'	KALE COMMON SAGE PIPE ORGAN CACTUS NASTURTIUM	4" POT 4" POT 15 GAL 4" POT	

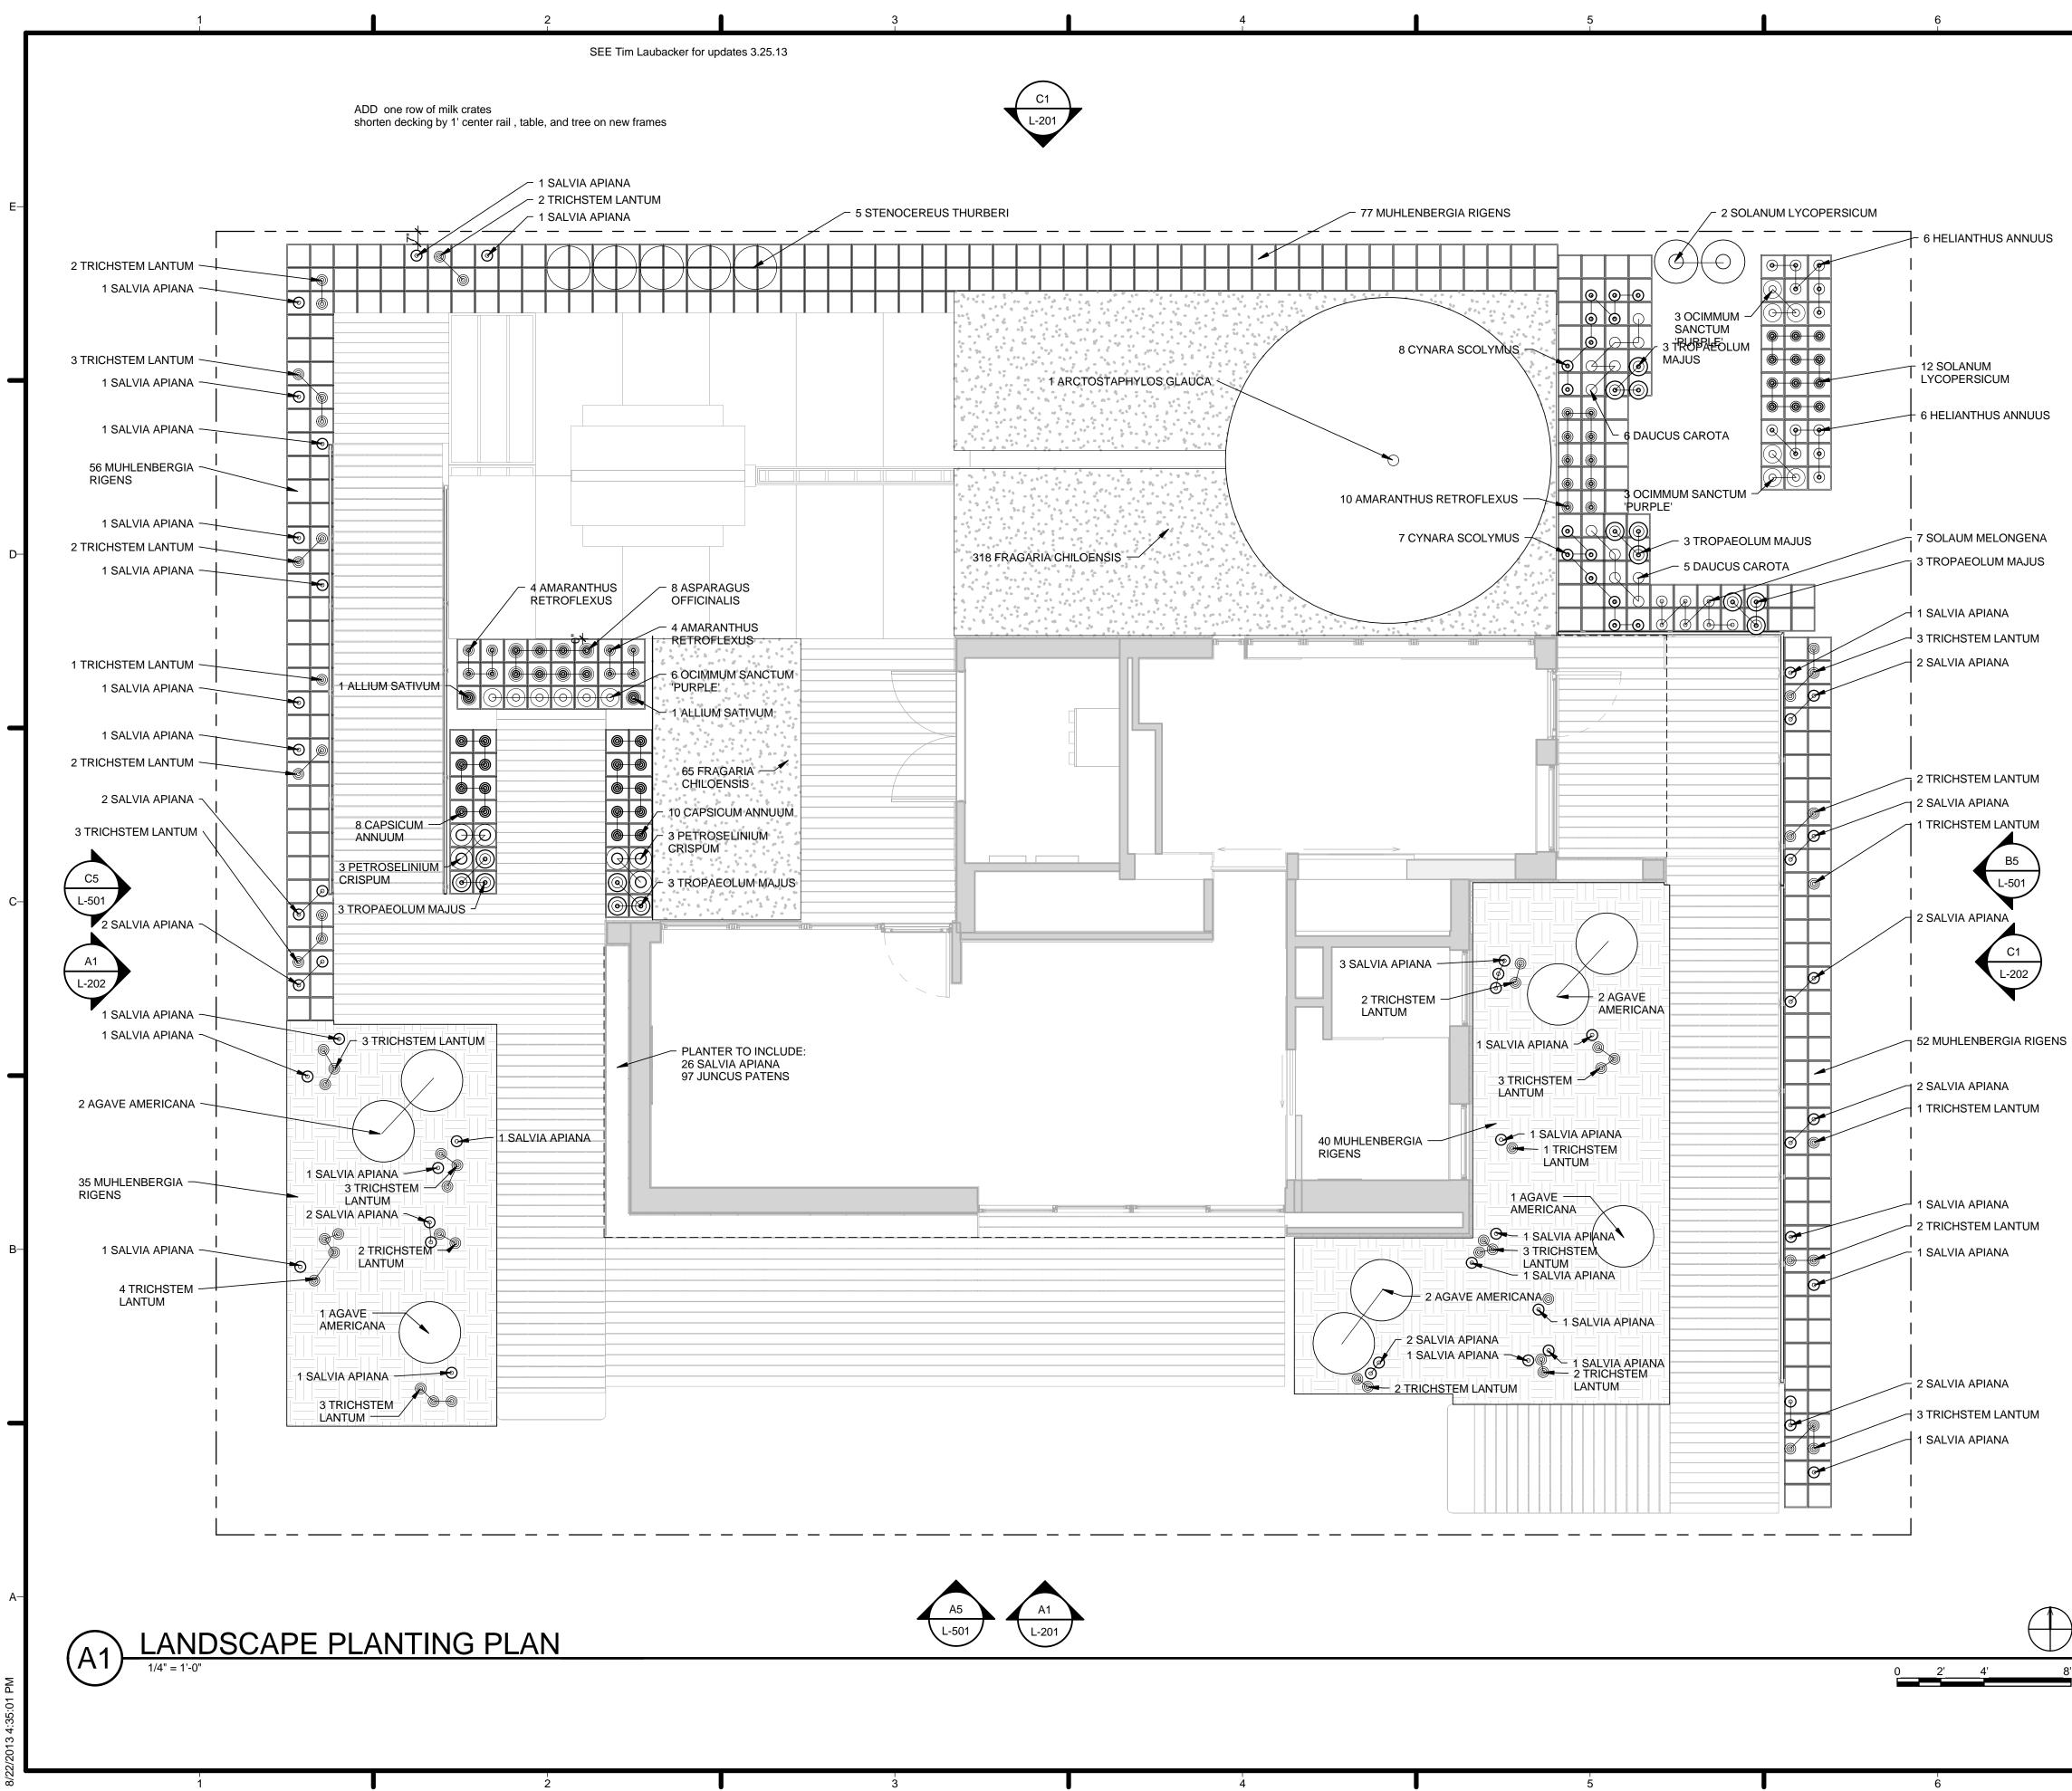
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							TEAM NAME: TEAM NAME: TEAM NAME: TEAM NAME: Team Capitol dc ADDRESS: THE CATHOLIC UNIVERSITY OF AMERICA SCHOOL OF ARCHITECTURE 620 MICHIGAN AVENUE, NE. WASHINGTON, DC 20064 STRUCTURAL ENGINEER BOB ALLISON, PE
		DI /	ANT LIST			-, I	ARUP ENGINEERING 1120 CONNECTICUT AVENUE, NW., SUITE 200
	LOCATION			SIZE	SPACING NOTES		WASHINGTON, DC 20036 TEL: 202.729.8220
	NATIVE COASTAL	9 AGAVE AMERICANA	CENTURY PLANT	15 GAL	ACCEN	_	MEP ENGINEER ARUP ENGINEERING
	SHRUB GARDEN	 28 MUHLENBERGIA RIGENS 28 TRICHOSTEMA LANTUM 30 SALVIA APIANA 	DEER GRASS WOOLY BLUE CURLS WHITE SAGE	5 GAL 5 GAL 5 GAL	T 24" OC 24" OC 24" OC		1120 CONNECTICUT AVENUE, NW., SUITE 200 WASHINGTON, DC 20036 TEL: 202.729.8220
	TREE OF LIFE GARDEN	1 ARCTOSTAPHYLOS GAUCA 318 FRAGARIA CHILOENSIS	BIG MANZANITA COASTAL STRAWBERRY	48" BOX 10"X 20 TRAYS	USED AS SOLID MASS		ARCHITECT OF RECORD WILLIAM JELEN, AIA 620 MICHIGAN AVE NE CROUGH CENTER
	BRIDGE DECK LAWN	65 FRAGARIA CHILOENSIS	COASTAL STRAWBERRY	10"X20" TRAYS	USED AS SOLID MASS	_ ┣	WASHINGTON, DC 20064 TEL: 202.344.5513
	EDIBLE BACK GARDEN	 AMARANTHUS RETROFLEXUS CYNARA SCOLYMUS DAUCUS CAROTA SUBSP. SATIVUS 'CIRCUS CIRCUS HELIANTHUS ANNUUS OCIMUM SANCTUM 'PURPLE' SOLANUM LYCOPERSICUM SOLANUM MELONGENA TROPAIEOLUM MAJUS 'ALASKA SALMON ORANGE' 	AMARANTH ARTICHOKE TRI COLORED CARROTS SUNFLOWERS PURPLE BASIL TOMATOS EGGPLANT NASTURTIUM	MILK CRATE MILK CRATE MILK CRATE MILK CRATE MILK CRATE MILK CRATE MILK CRATE			
	BACK AND SIDE MILK CRATES	182 MUHLENBERGIA RIGENS24 TRICHOSTEMA LANTUM22 SALVIA APIANA	DEER GRASS WOOLY BLUE CURLS WHITE SAGE	5 GAL 5 GAL 5 GAL	POTS PLACED IN MILK CRATES		C
	HARVEST HOUSE PLANTER	97 JUNCUS PATENS 25 SALVIA APIANA	WIRE GRASS WHITE SAGE	1 GAL 1 GAL	6" OC 6" OC		U.S. DEPARTMENT OF ENERGY SOLAR DECATHLON 2013
	HARVEST TABLE	24 BRASSICA OLERACEA 'REDBOR' 13 SALVIA OFFICINALIS 'ICETERINA' 5 STENOCEREUS THURBERI 15 TROPAEOLUM MAJUS 'ALASKA SALMON ORANGE'	KALE COMMON SAGE PIPE ORGAN CACTUS NASTURTIUM	4" POT 4" POT 15 GAL 4" POT			WWW.SOLARDECATHLON.GOV
							B A A CONTRACT A A A A A A A A A A A A A A A A A A
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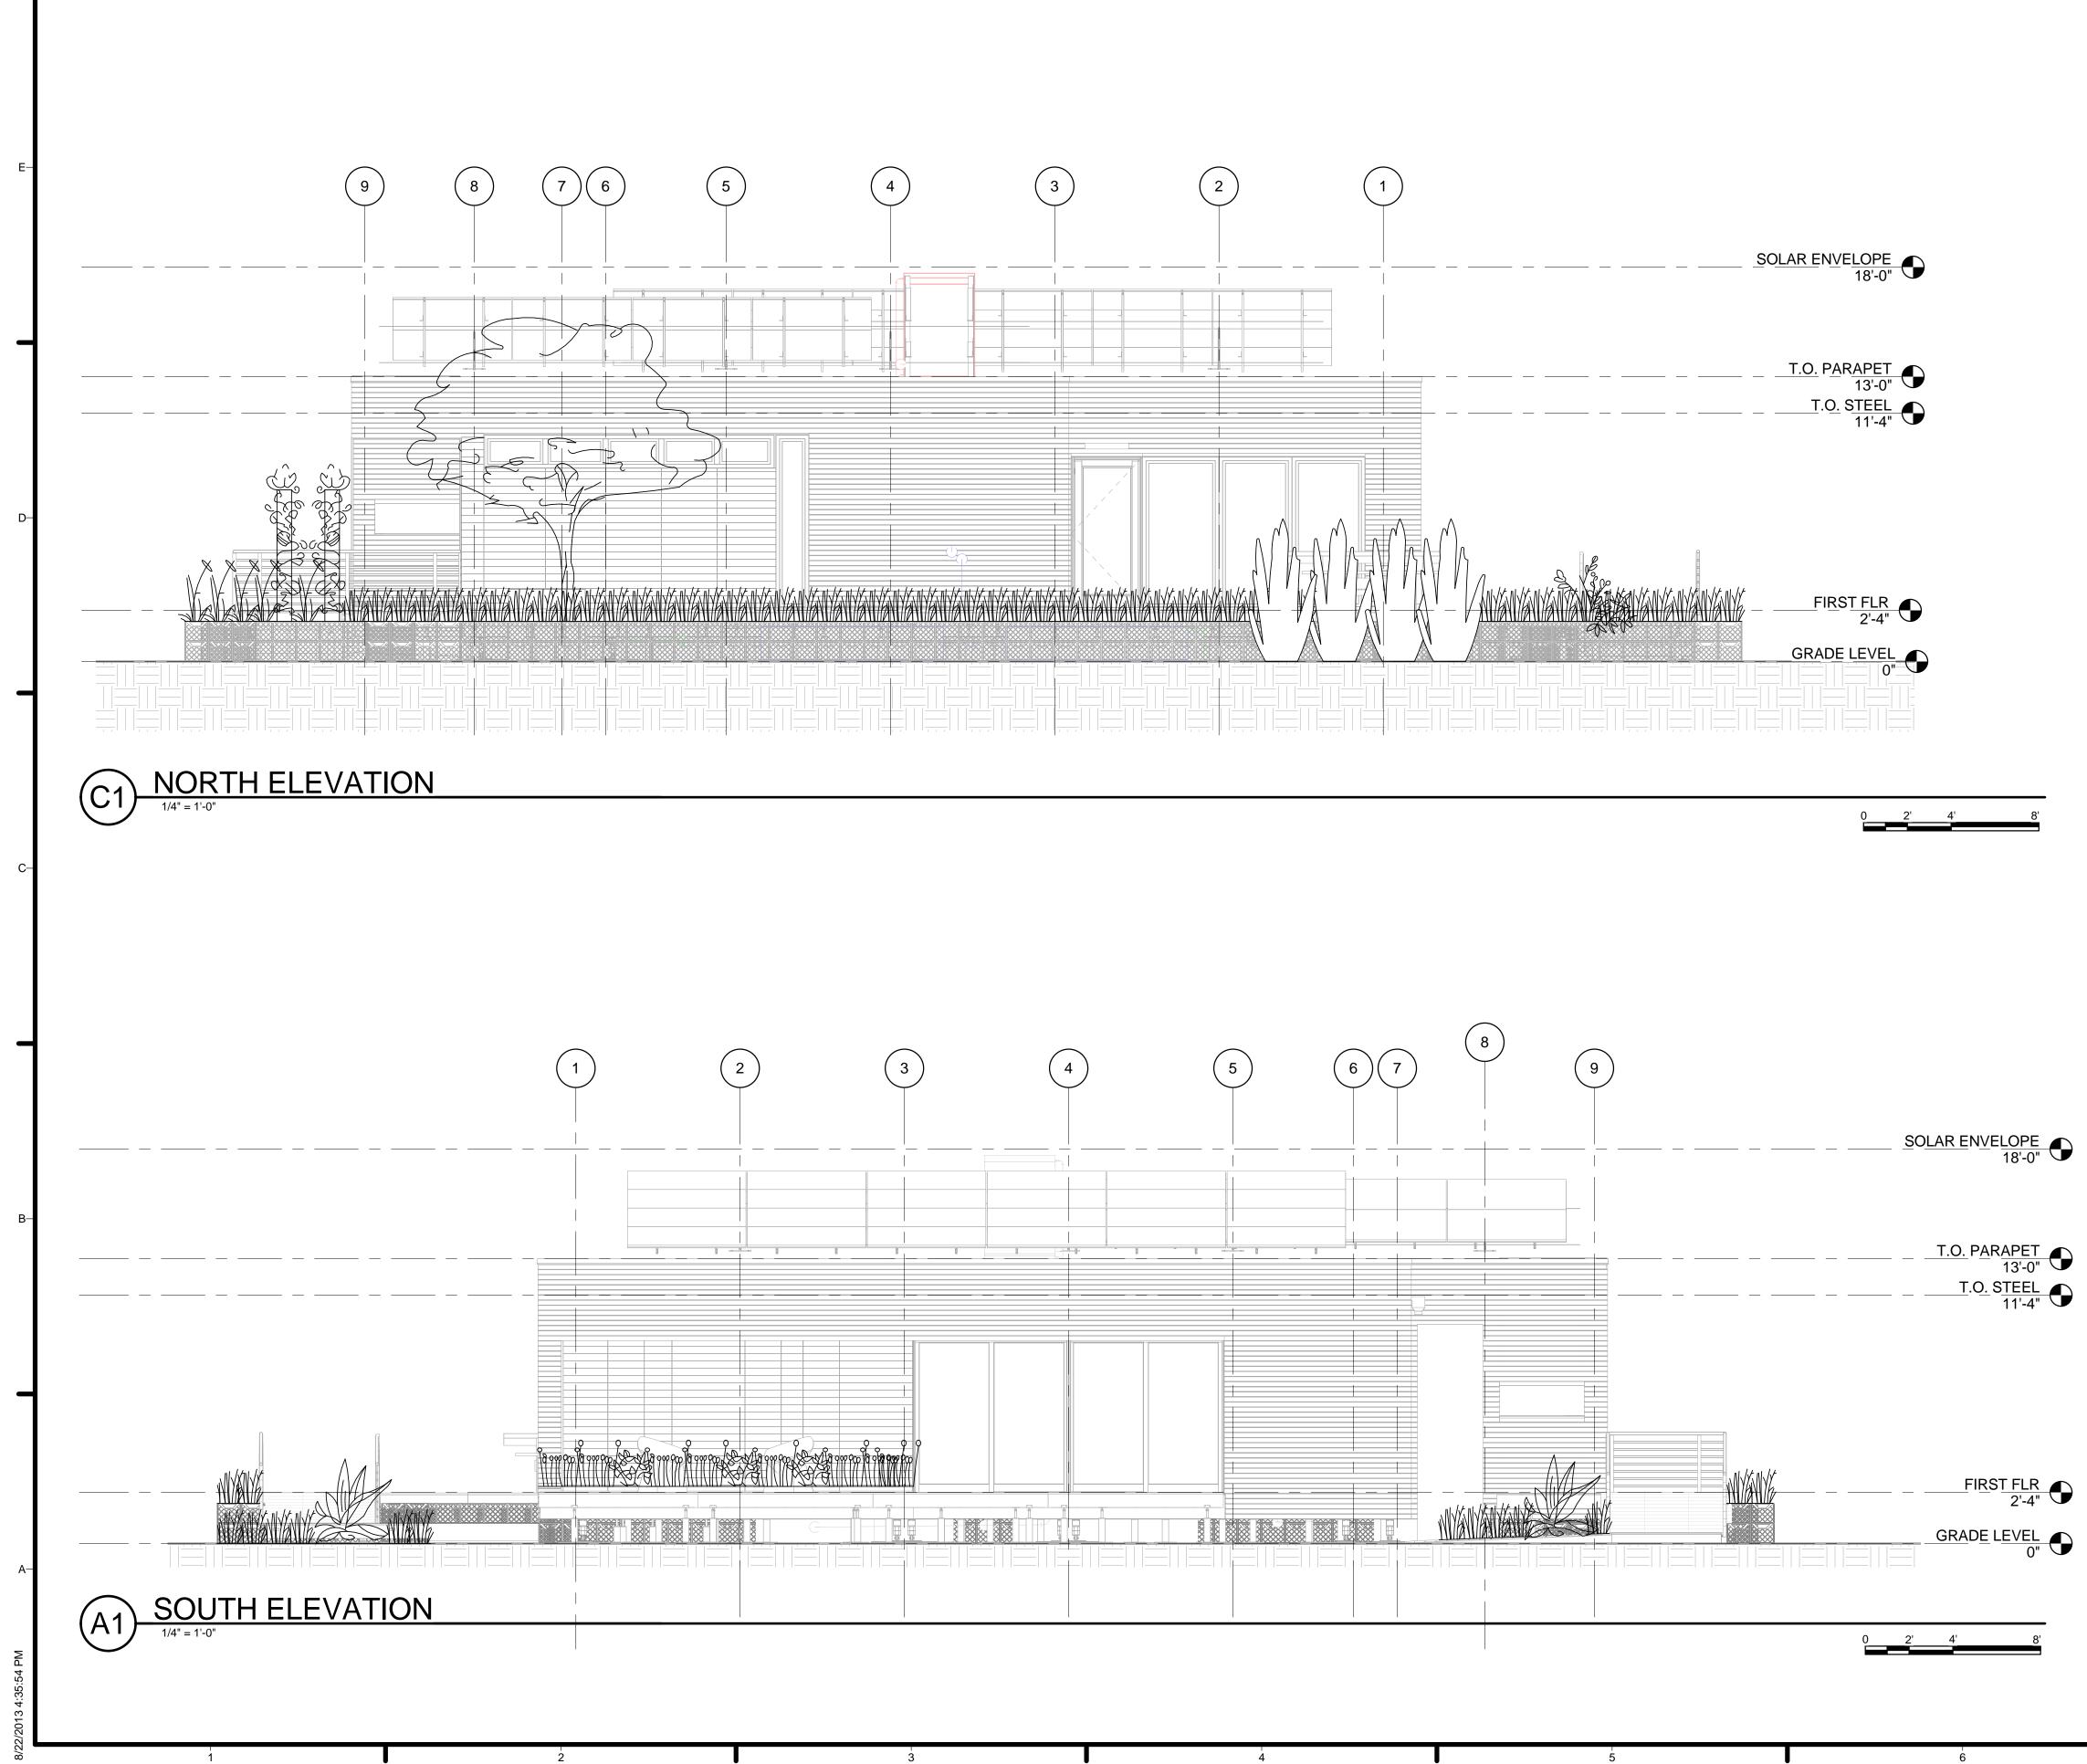
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	 NO SUBSTITUTIONS SHALL BE MADE WITHOUT APPROVAL BY THE LANDSCAPE ARCHITECT. PLANTS TO BE ARRANGED ON SITE BY LANDSCAPE ARCHITECT. MILK CRATE SOIL TO BE A MIX OF 40% SAND, 30% PEAT MOSS, 20% PUMMICE AND 10% PERLITE. 		
		-Ε	HARVEST
14'-11"		┝	TEAM NAME: Team Capitol dc ADDRESS: THE CATHOLIC UNIVERSITY OF AMERICA SCHOOL OF ARCHITECTURE 620 MICHIGAN AVENUE, NE. WASHINGTON, DC 20064 STRUCTURAL ENGINEER BOB ALLISON, PE
		-D	ARUP ENGINEERING 1120 CONNECTICUT AVENUE, NW., SUITE 200 WASHINGTON, DC 20036 TEL: 202.729.8220 MEP ENGINEER ARUP ENGINEERING 1120 CONNECTICUT AVENUE, NW., SUITE 200 WASHINGTON, DC 20036 TEL: 202.729.8220
10'-2 1/2"	REFERENCE KEYNOTES		ARCHITECT OF RECORD WILLIAM JELEN, AIA 620 MICHIGAN AVE NE CROUGH CENTER WASHINGTON, DC 20064 TEL: 202.344.5513
B5 L-501		C	CLIENT
C1 L-202			U.S. DEPARTMENT OF ENERGY SOLAR DECATHLON 2013 WWW.SOLARDECATHLON.GOV
	SHEET KEYNOTES	┝	
22'-11"			
		-В	4 2013.08.22 As-Built Submission 3 2013.02.04 100% CD Submission 2 2012.11.20 80% DD Revisions 1 2012.10.11 80% DD Submission MARK DATE DESCRIPTION
			LOT NUMBER: 115
6'-0"		┡	DRAWN BY: TEAM CAPITOL DC CHECKED BY: TEAM CAPITOL DC
e - - - - - - - - - - - - - - - - - - -			COPYRIGHT: NONE: PROJECT IS PUBLIC DOMAIN
		—А	SHEET TITLE LANDSCAPE MASTER PLAN
0 <u>2' 4' 8'</u>	7		L-101



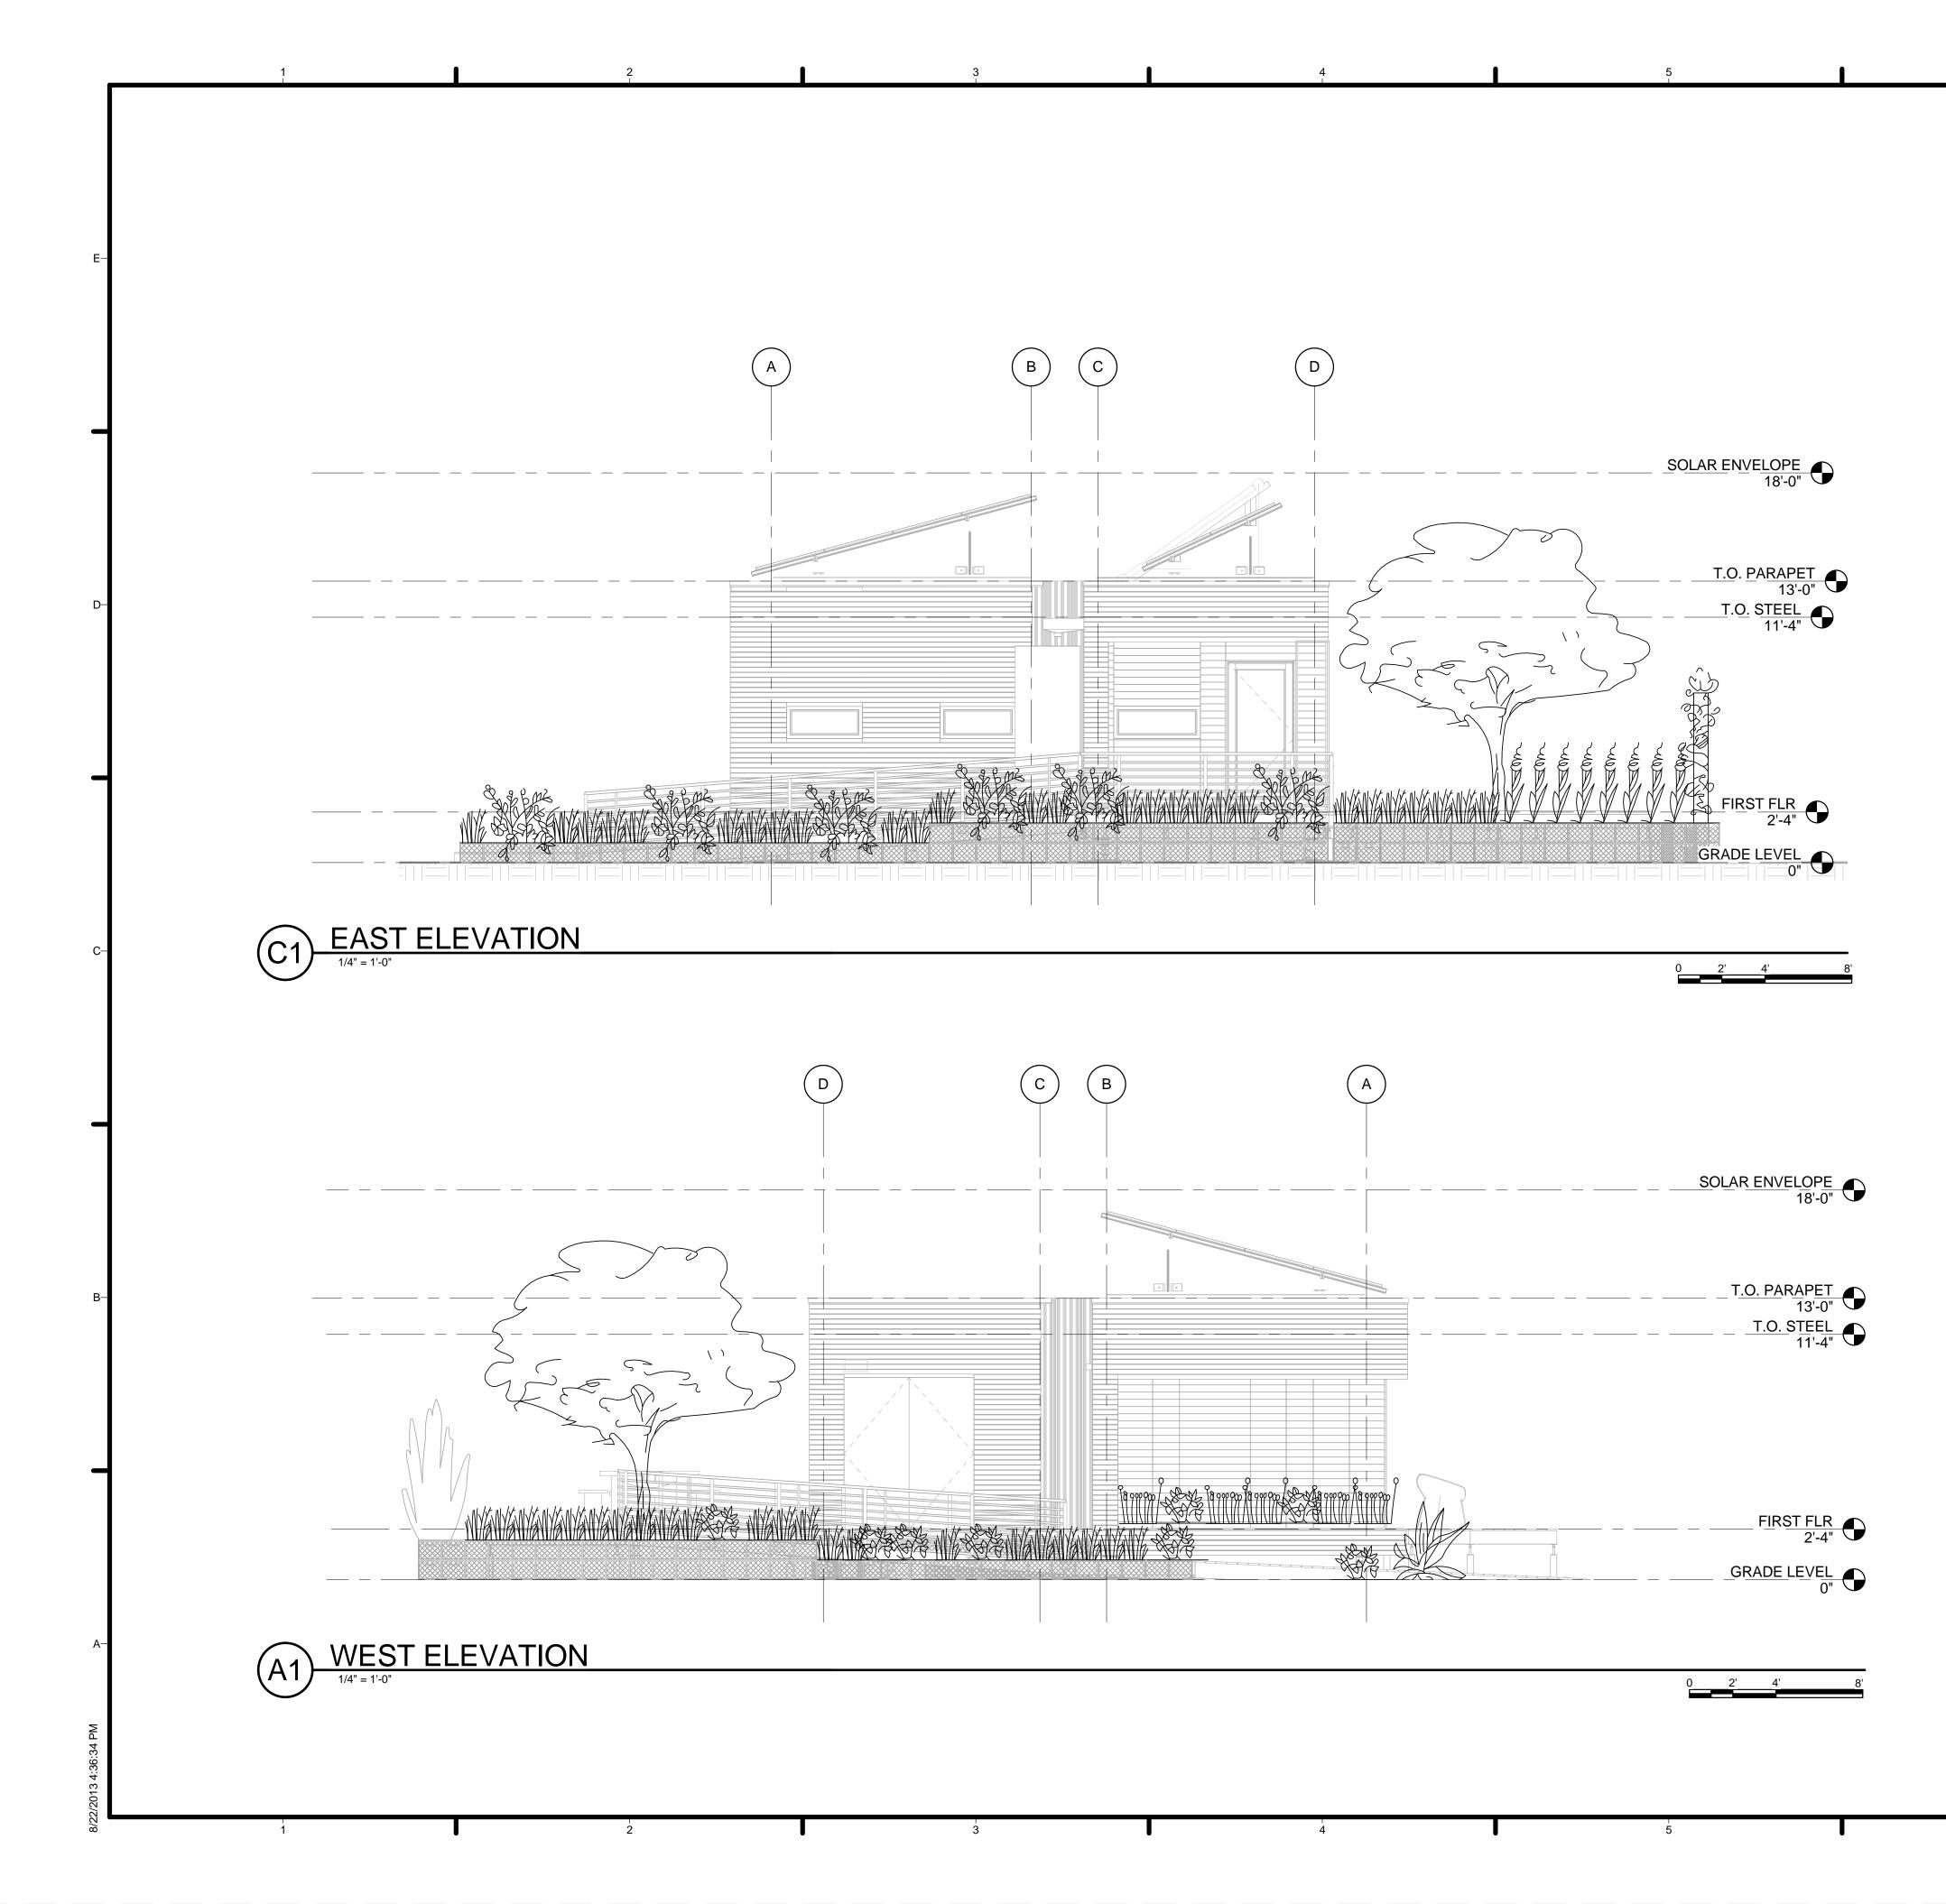
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	REFERENCE KEYNOTES	TEAM NAME: Team Capitol dc ADDRESS: THE CATHOLIC UNIVERSITY OF AMERICA SCHOOL OF ARCHITECTURE 620 MICHIGAN AVENUE, NE. WASHINGTON, DC 20064 STRUCTURAL ENGINEER BOB ALLISON, PE ARUP ENGINEERING 1120 CONNECTICUT AVENUE, NW., SUITE 200 WASHINGTON, DC 20036 TEL: 202.729.8220
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)		-C CLIENT U.S. DEPARTMENT OF ENERGY SOLAR DECATHLON 2013
)	SHEET KEYNOTES	WWW.SOLARDECATHLON.GOV
		B
		LOT NUMBER: 115 DRAWN BY: TEAM CAPITOL DC CHECKED BY: TEAM CAPITOL DC COPYRIGHT: NONE: PROJECT IS PUBLIC DOMAIN SHEET TITLE
8'		LANDSCAPE DECKING LAYOUT PLAN LATO2
	7	



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 NO SUBSTITUTIONS SHALL BE MADE WITHOUT APPROVAL BY THE LANDSCAPE ARCHITECT. PLANTS TO BE ARRANGED ON SITE BY LANDSCAPE ARCHITECT. MILK CRATE SOIL TO BE A MIX OF 40% SAND, 30% PEAT MOSS, 20% PUMMICE AND 10% PERLITE. 	-E
REFERENCE KEYNOTES	HARVEST TEAM NAME: TEAM NAME: Team Capitol dc ADDRESS: THE CATHOLIC UNIVERSITY OF AMERICA SCHOOL OF ARCHITECTURE 620 MICHIGAN AVENUE, NE. WASHINGTON, DC 20064 STRUCTURAL ENGINEER BOB ALLISON, PE ARUP ENGINEERING 1120 CONNECTICUT
	AVENUE, NW., SUITE 200 WASHINGTON, DC 20036 TEL: 202.729.8220 MEP ENGINEER ARUP ENGINEERING 1120 CONNECTICUT AVENUE, NW., SUITE 200 WASHINGTON, DC 20036 TEL: 202.729.8220 ARCHITECT OF RECORD WILLIAM JELEN, AIA 620 MICHIGAN AVE NE CROUGH CENTER WASHINGTON, DC 20064 TEL: 202.344.5513
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	42013.08.22As-Built Submission32013.02.04100% CD Submission22012.11.2080% DD Revisions12012.10.1180% DD SubmissionMARKDATEDESCRIPTIONLOT NUMBER:115DRAWN BY:TEAM CAPITOL DCCHECKED BY:TEAM CAPITOL DCCOPYRIGHT:NONE: PROJECT IS PUBLIC DOMAIN
	SHEET TITLE LANDSCAPE PLANTING PLAN L-103

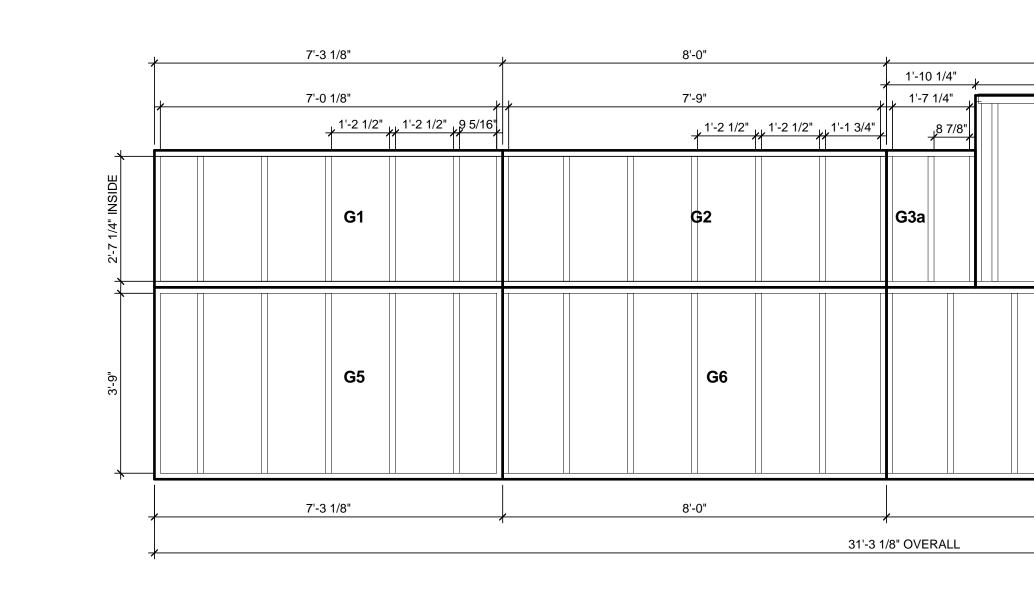


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 VERIFY ALL DIMENSIONS IN FIELD PRIOR TO FABRICATION AND INSTALLATION DRAWINGS FOR LANDSCAPE CORDINATION ONLY. 	-Е	HARVEST CAPITOL
REFERENCE KEYNOTES	-D	TEAM NAME:Team Capitol dcADDRESS:THE CATHOLIC UNIVERSITY OF AMERICA SCHOOL OF ARCHITECTURE 620 MICHIGAN AVENUE, NE. WASHINGTON, DC 20064STRUCTURAL ENGINEERBOB ALLISON, PE ARUP ENGINEERING 1120 CONNECTICUT AVENUE, NW., SUITE 200
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	D	BOR ALLISON, PE ARUP ENGINEERING 1120 CONNECTICUT AVENUE, NW., SUITE 200 WASHINGTON, DC 20036 TEL: 202.729.8220 MEP ENGINEER ARUP ENGINEERING 1120 CONNECTICUT AVENUE, NW., SUITE 200 WASHINGTON, DC 20036 TEL: 202.729.8220 ARCHITECT OF RECORD WILLIAM JELEN, AIA 620 MICHIGAN AVE NE CROUGH CENTER WASHINGTON, DC 20064 TEL: 202.344.5513
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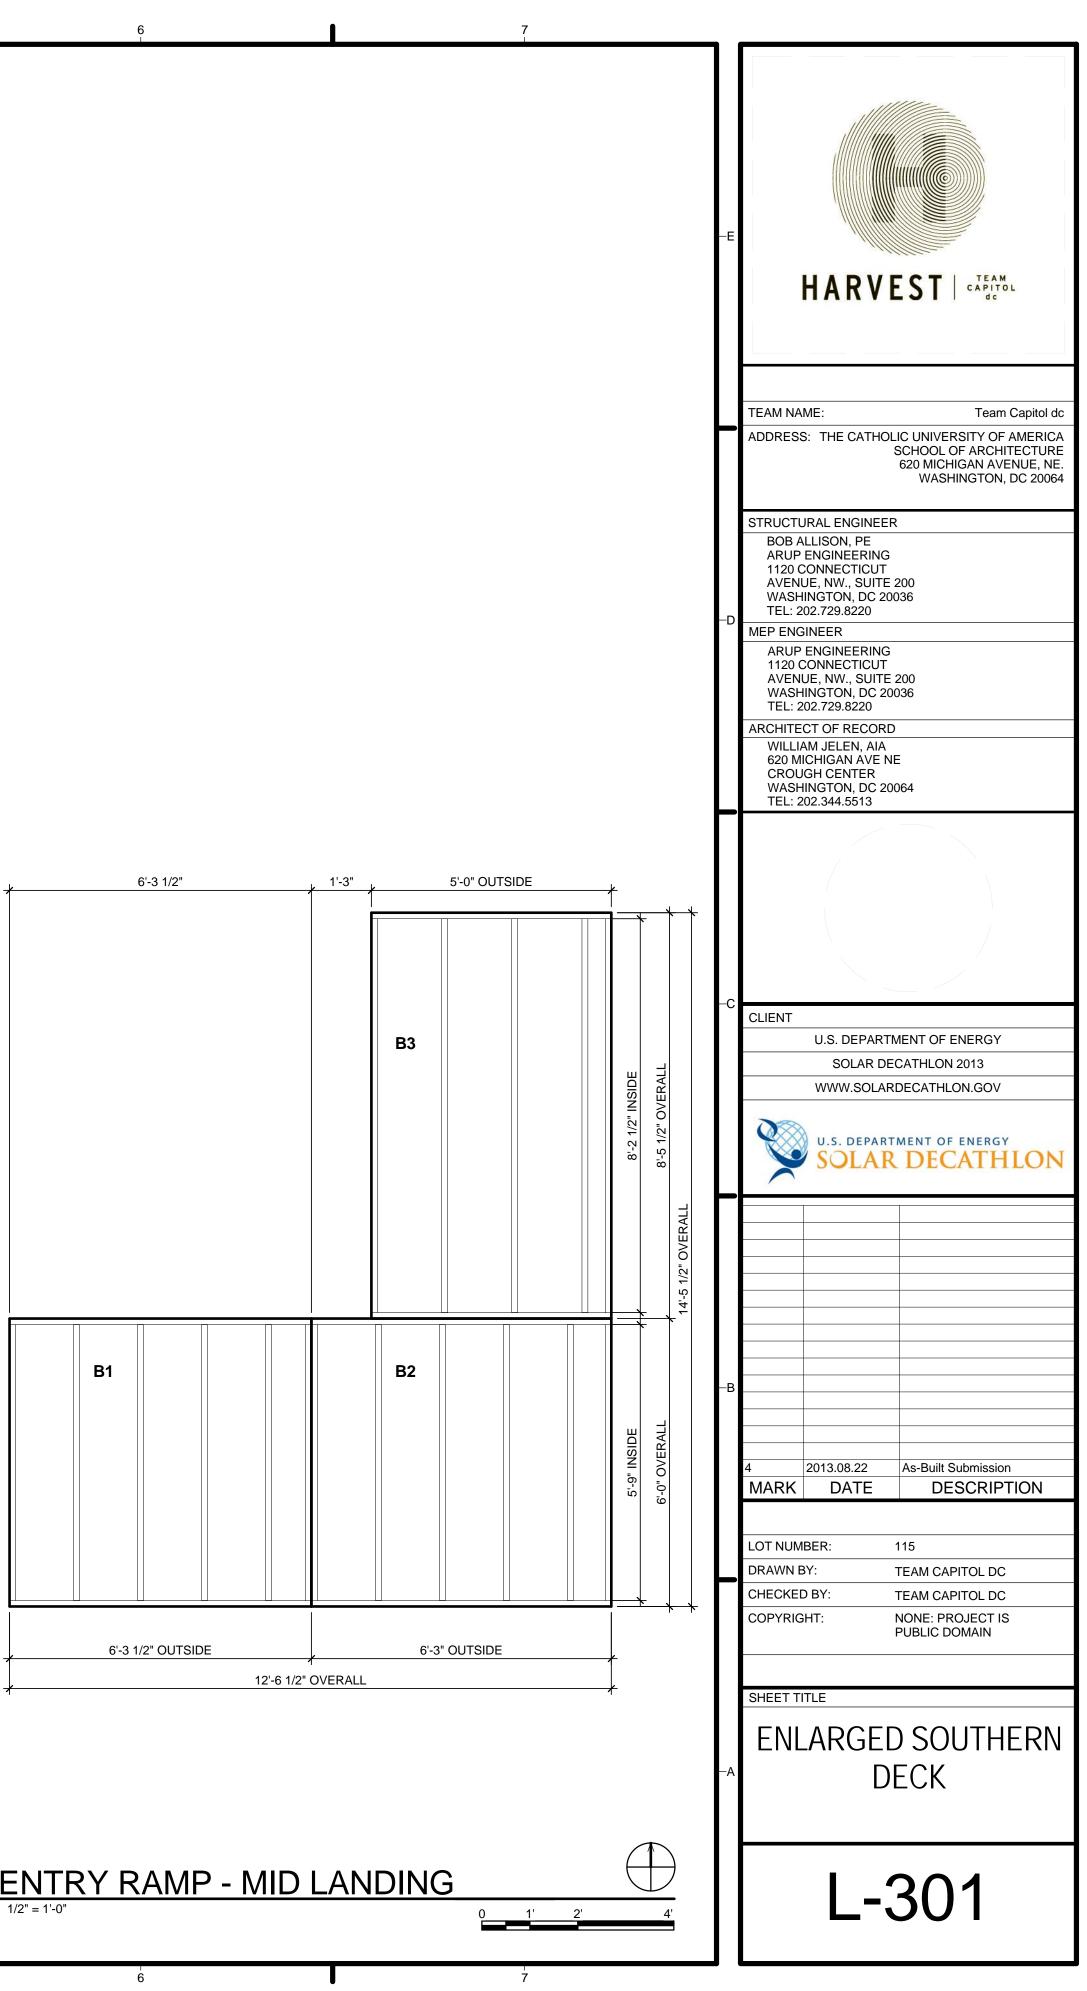


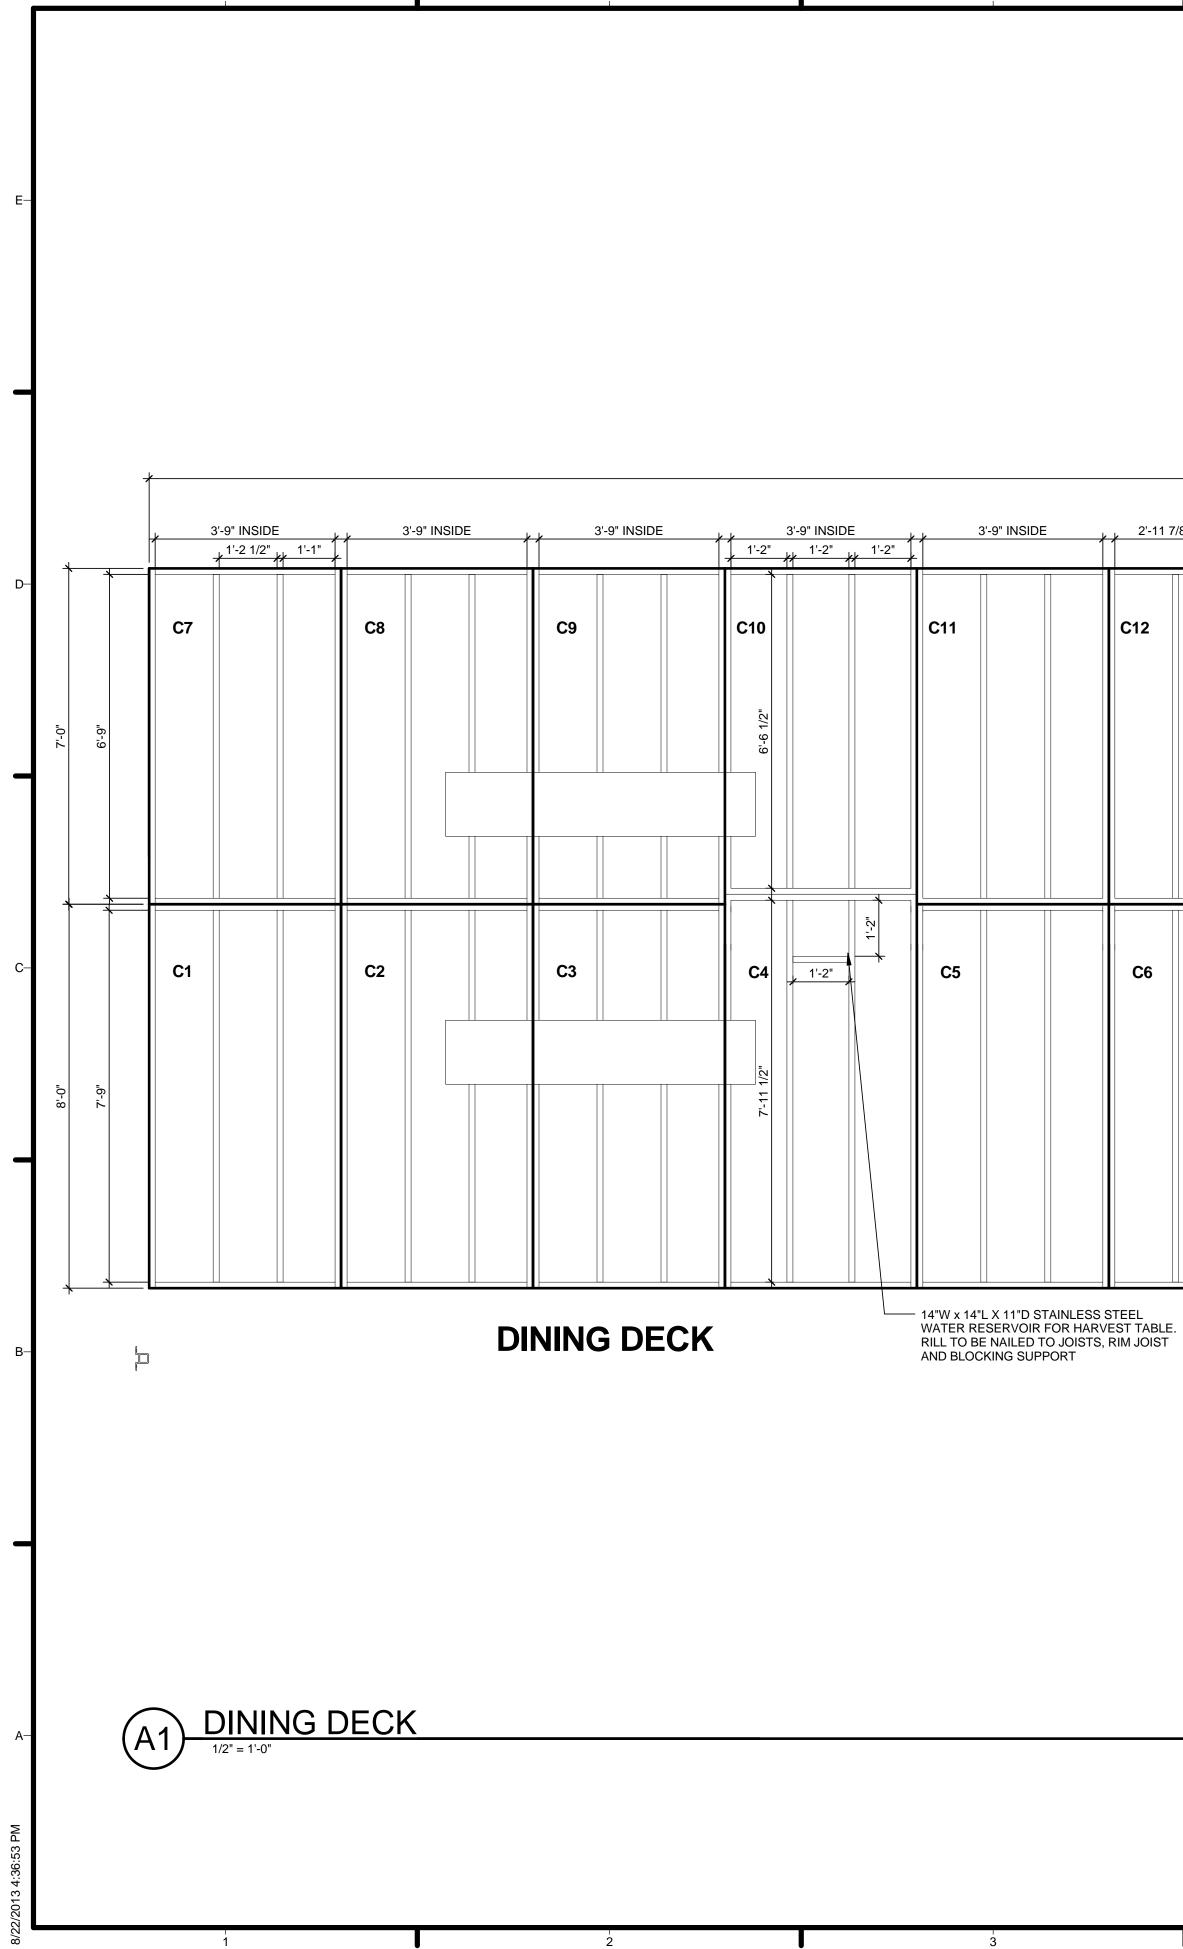
			0 1' 2' 4'	A6 EN 1/2" =	ITRY RAMP - MI
l	4	l	5		6

6'-1 3/4" <u>1'-2 1/2" 2 5/8</u>	<u>- 1'-2 1/2" 1'-1 3/4"</u> 	<u>~</u>
G3b	G4	8'-9" INSIDE
G7	G8	3'-9" INSIDE
8'-0"	8'-0"	۲ <u>۰</u>

8'-0"

8'-0"





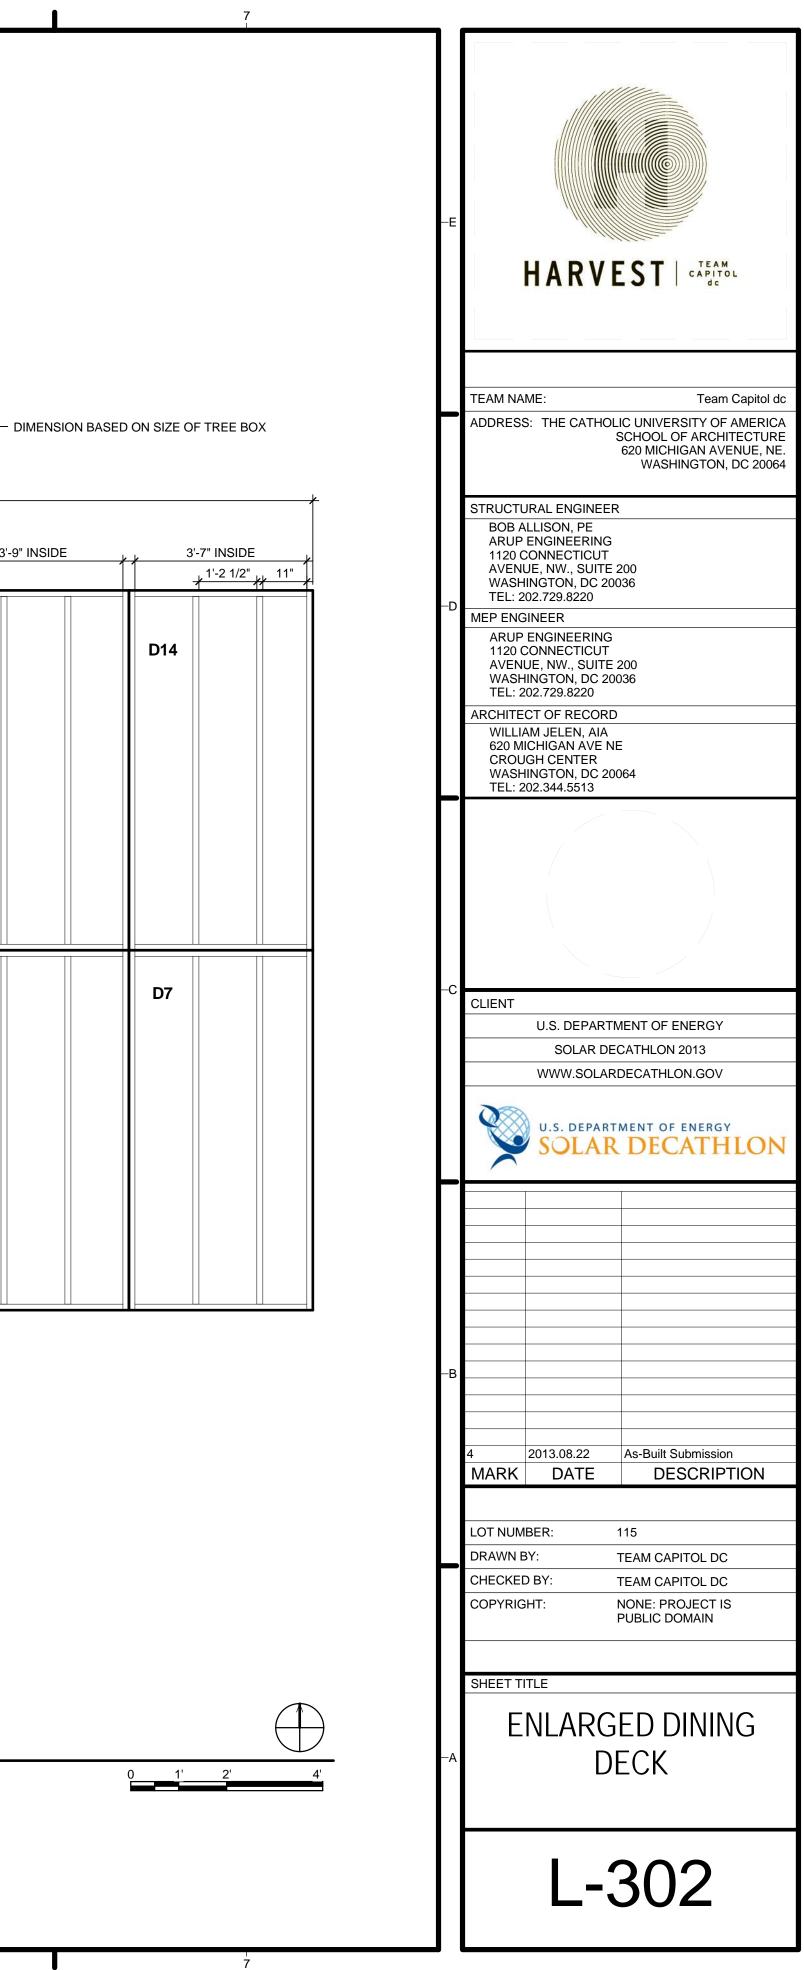
TREE OF LIFE DECK

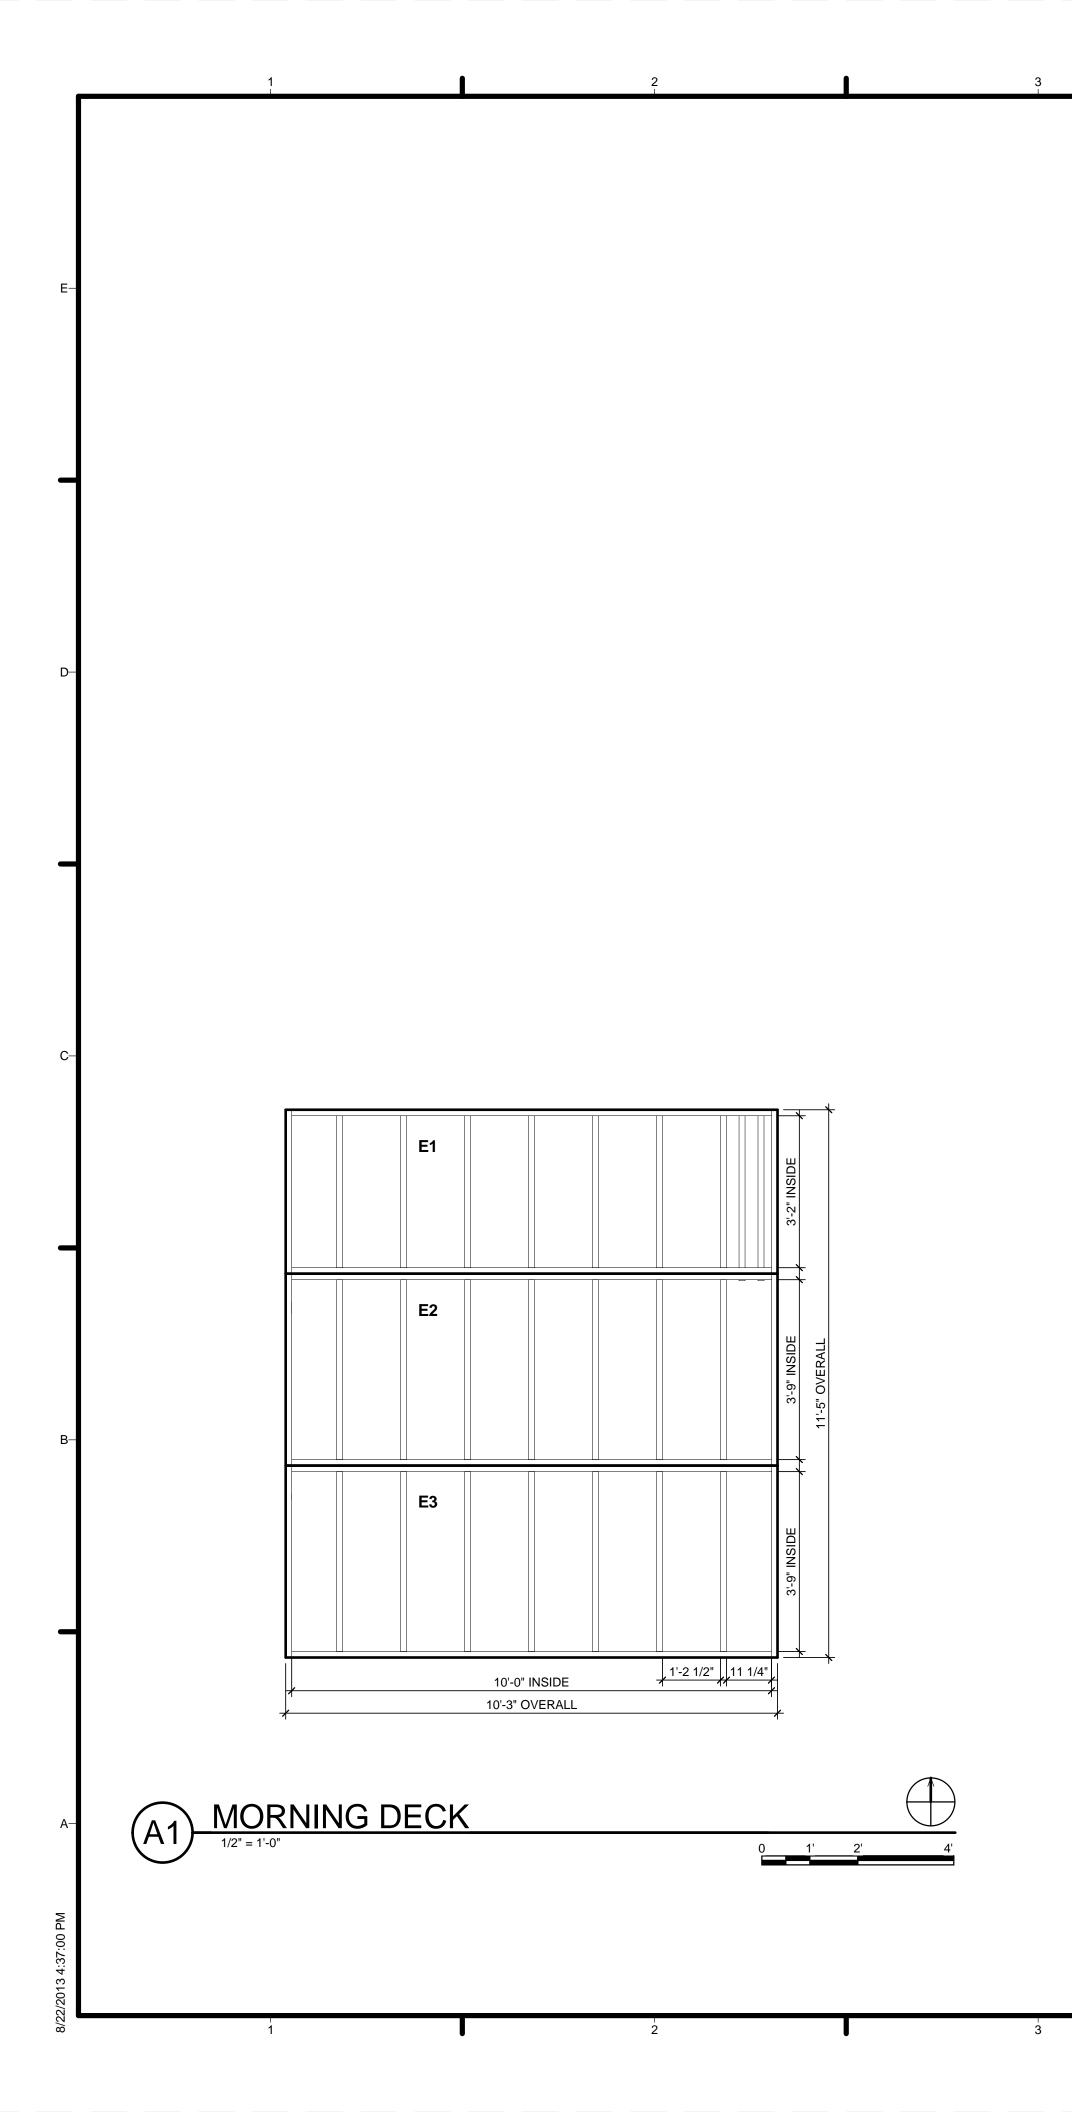
6

	50'-11 5/8" OVERALL								
-/	2'-11 7/8" INSIDE	3'-7 3/4" INSIDE	3'-9" INSI	DE , 3'-9" INS	SIDE <u>- 3</u> '-9	9" INSIDE	3'-9" INSIDE	, <u>3'-9</u>	
	C12	D8	D9	D10	D11	D12	5'-5" OUTSIDE 5'-2" INSIDE	D13	
	C6	D1	D2	D3	D4	D5	5'-5" OUTSIDE 4'-2" 5'-2" INSIDE OPEN TO BELOW	D6	

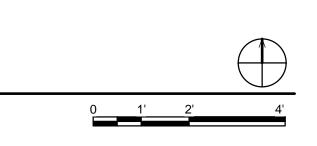
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C12 TO D8 CONNECTION TO ALIGN WITH RAINSCREEN

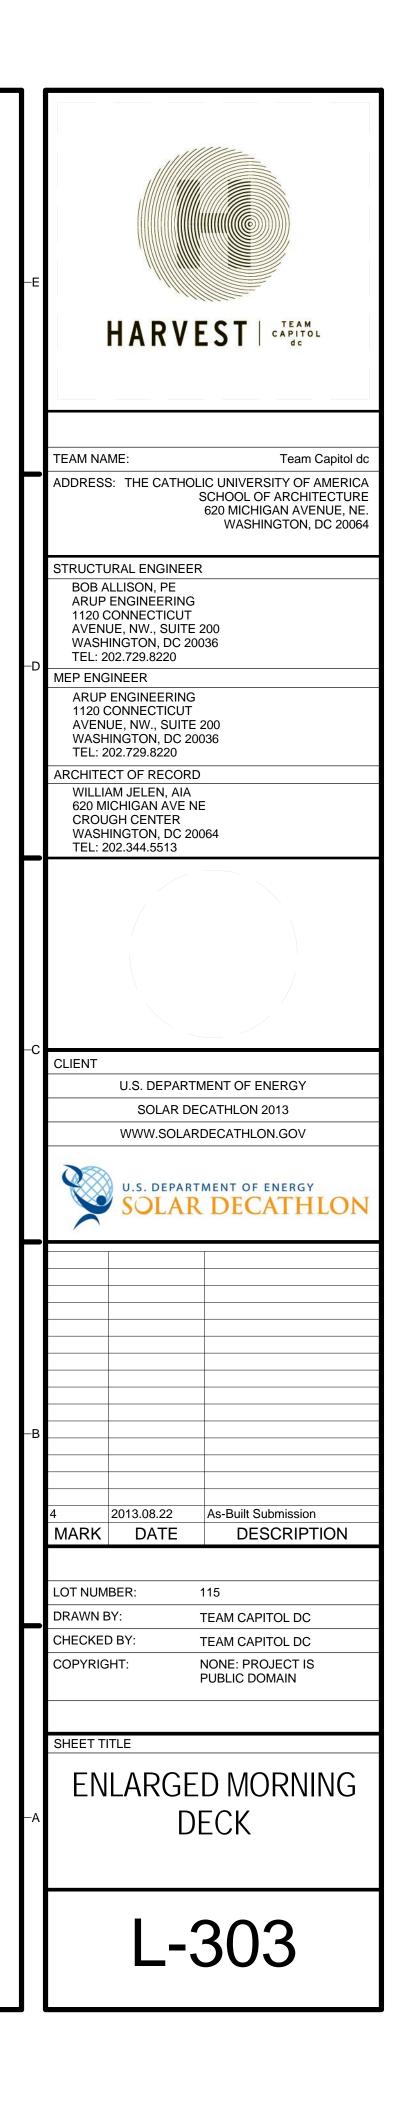


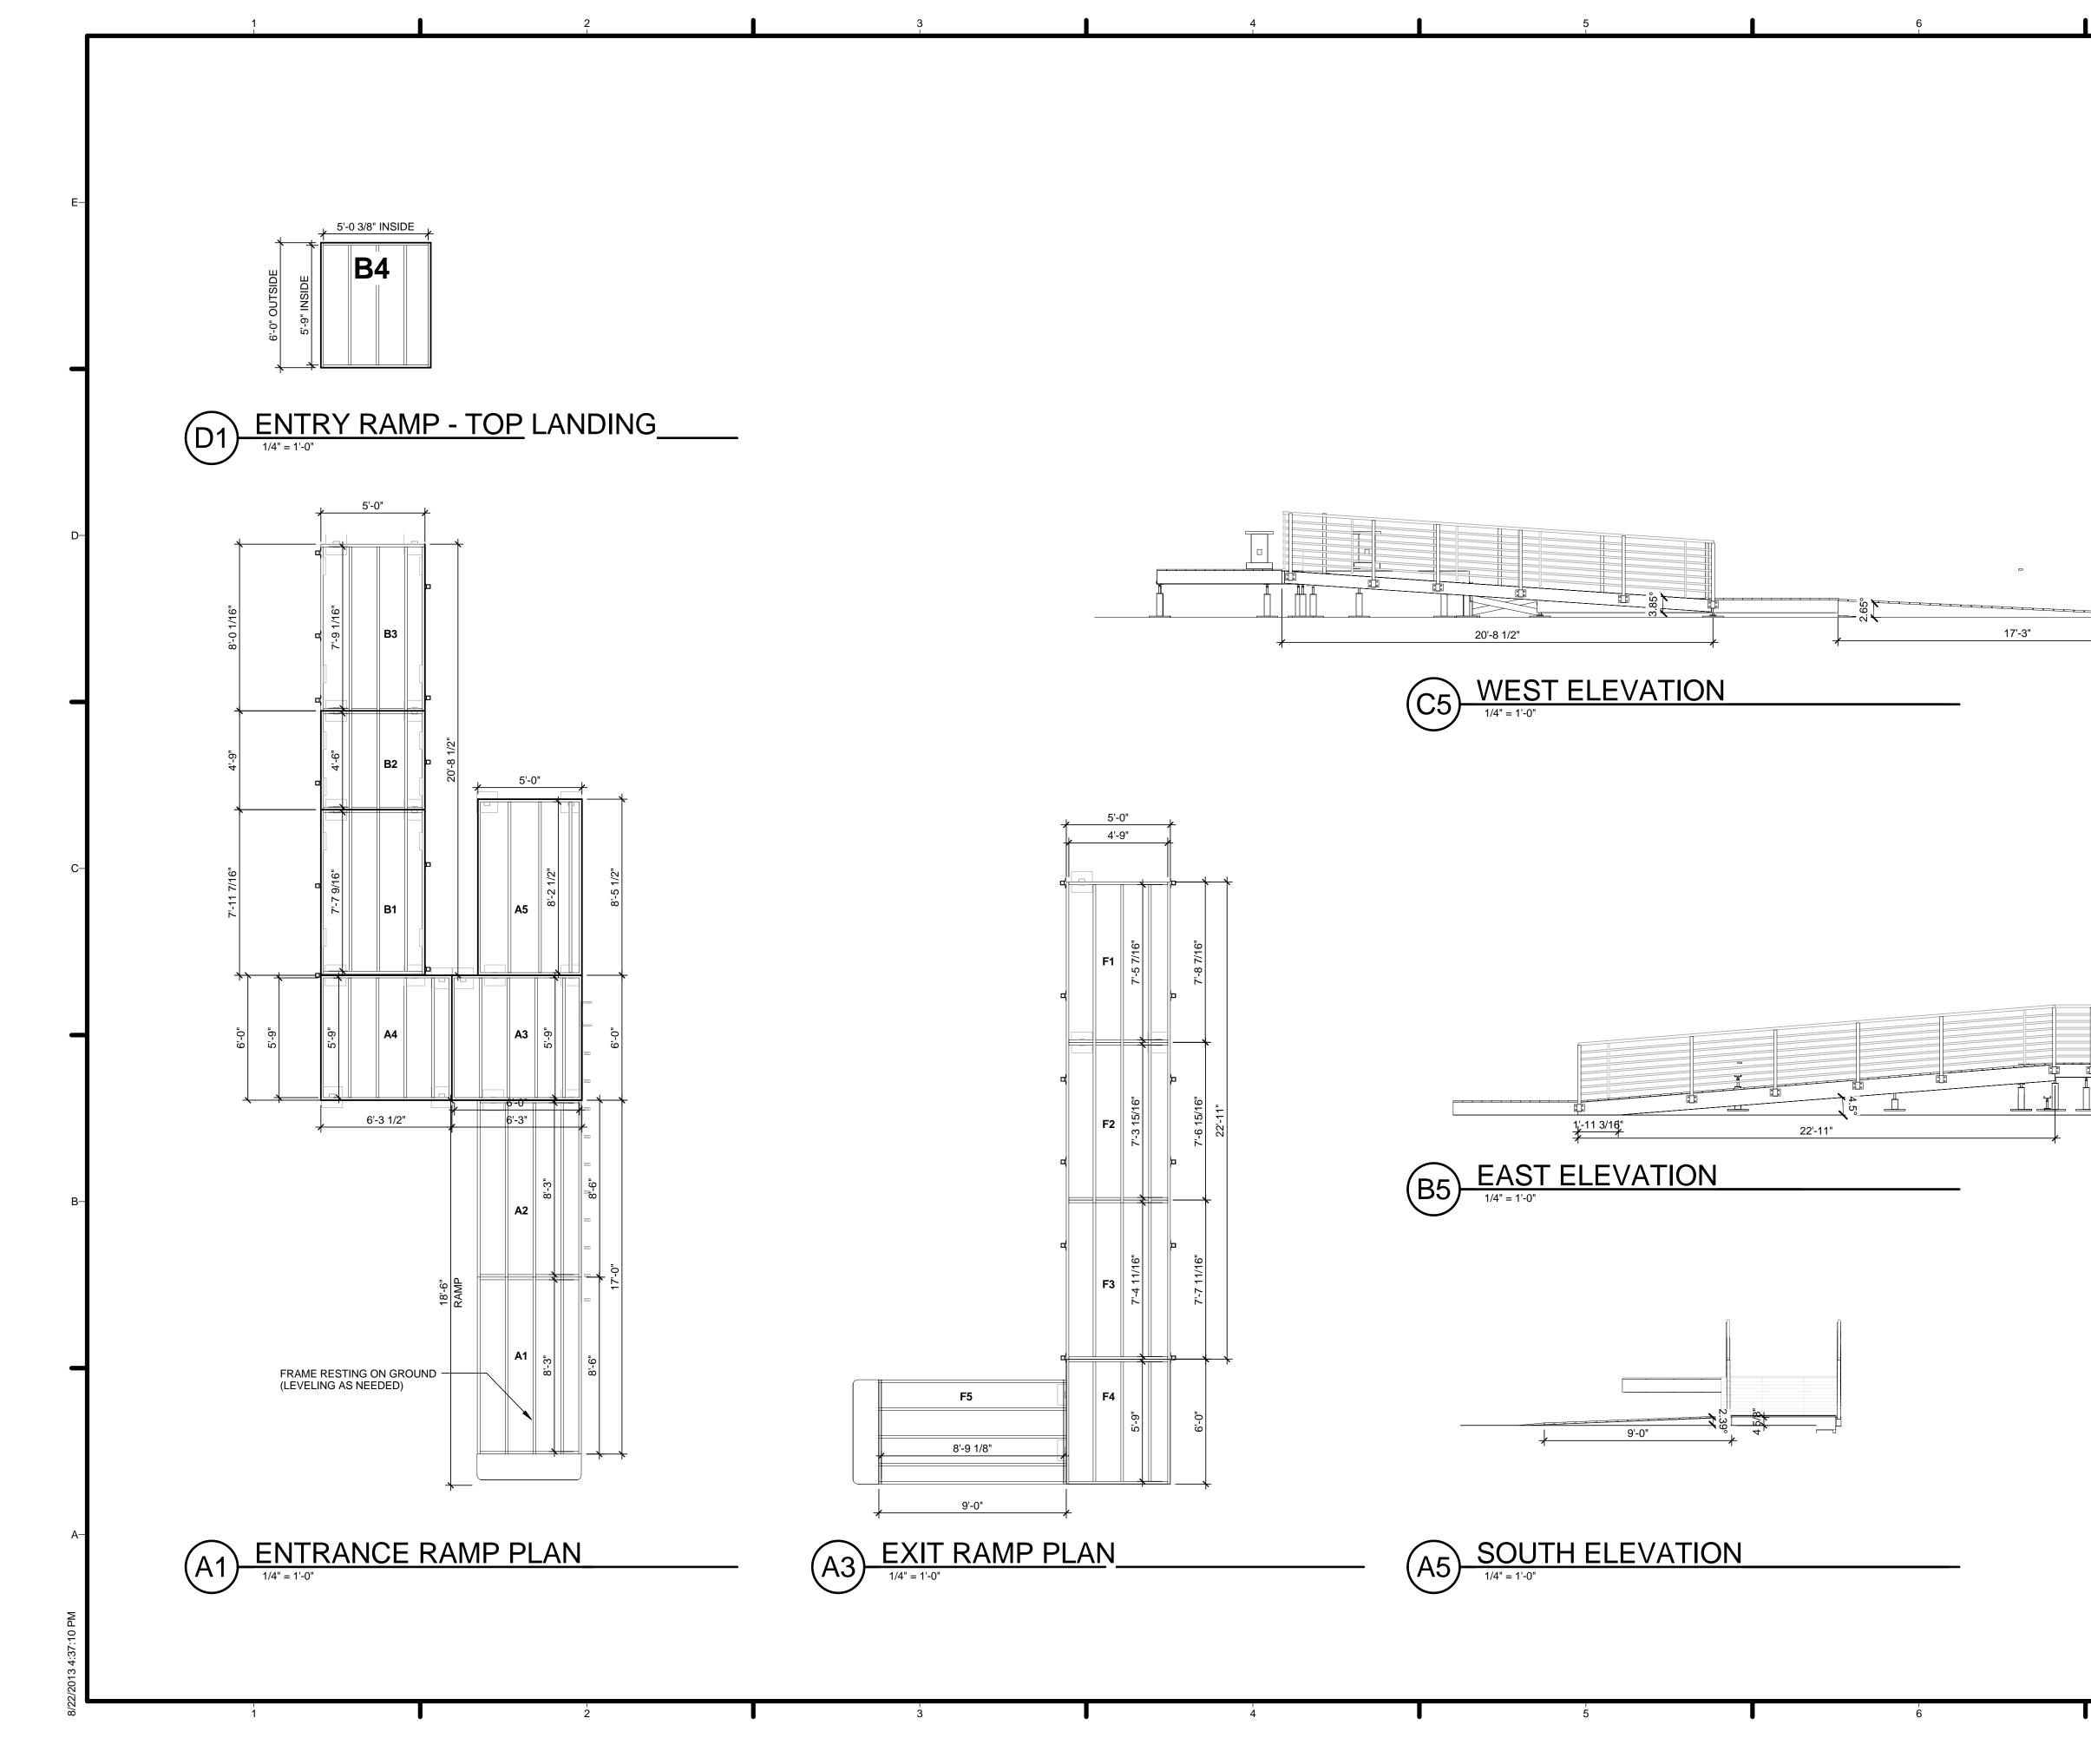


(A3) BRIDGE DECK 1/2" = 1'-0"



*		14'-0 5/16	" OVERALL	,	Ł	
	6'-10 5/16"	ł	,	7'-2"	e i	
		+ 1'-2 1/2" _6 7/8" + 11-2 1/2" _6 7/8"		+ 1'-2 1/2" + 8 3/4", 1		t
	H4		4		3'-1" INSIDE	
	H3		13		3'-0" INSIDE	VERALL
	H2		I2		3'-0" INSIDE	13'-1" OVERALL
	H1				3'-0" INSIDE	





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	Ψ	HARVEST CAPITOL
	_	TEAM NAME: Team Capitol dc ADDRESS: THE CATHOLIC UNIVERSITY OF AMERICA SCHOOL OF ARCHITECTURE 620 MICHIGAN AVENUE, NE.
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		L-501

SYMBOL	DESCRIPTION
[]	CAMBER
<>	NUMBER OF STUDS
()	BOTTOM OF FOOTING ELEVATION
С	CAMBER IN INCHES
<u> </u>	STEEL BEAM
<u> </u>	STEEL JOIST
<u> </u>	BRACE
►	MOMENT CONNECTION
I	WATERSTOP
<i>\</i>	WALL
\mathbf{A}	BEAM PENETRATION
\oplus	SETTING-OUT POINT
	GROUND

D-	

C–	





STNBOL	DESCRIPTION
ALT	ALTERNATE
BET	BETWEEN
	BOTH FACES
	BUILDING
BM	BEAM
BOT	BOTTOM
BPL	BASE PLATE
BS	BOTH SIDES
	BOTTOM OF STEEL
0/51	DOTTOM OF STEEL
	CHANNEL
	CANTILEVER
CJ	CONSTRUCTION JOINT
CJP	COMPLETE JOINT PENETRATION (WELD
CL	CENTERLINE
CLR	CLEAR
COL	COLUMN
	CONCRETE
	CONNECTION
	CONSTRUCTION
	CONTINUOUS
	COVERPLATE
CTRL JT	CONTROL JOINT
D	DEPTH, DEEP
DEMO	DEMOLITION
DET	DETAIL
DIA	DIAMETER
	DIAGONAL
-	DIMENSION
	DEAD LOAD
	DITTO
DWG	DRAWING
E	MODULUS OF ELASTICITY
EA	EACH
EF	EACH FACE
EJ	EXPANSION JOINT
-	ELEVATION
	EMBEDMENT
	EQUAL
	EACH WAY
	EXISTING
	EXPANSION
EXT	EXTERIOR
FF	FAR FACE
FFL	FINISH FLOOR LEVEL
FDN	FOUNDATION
FIN	FINISHED
FL	FLOOR
FS	FAR SIDE
	FEET
	FOOTING
	YIELD STRESS
	TIELD STRESS
	GAUGE
	GALVANISED
GR	GRADE
Н	HORIZONTAL (FORCE)
HEX	HEXAGON, HEXAGONAL
HORIZ	HORIZONTAL
	HIGH POINT
	HIGH-STRENGTH BOLT
	HOLLOW STRUCTURAL SECTION
	HEIGHT
ID	INSIDE DIAMETER
IF	INSIDE FACE
IN	INCH
INT	INTERIOR
іт	
	ALT BET BET BF BLDG BM BOT BPL BS B/ST C C C CANT CJ C CANT CJ CJP CL CL CL CONC CONC CONS CONST CONST CONST CONST CONST CONST CONST CONST CONST CONS CONST CONS CONS CONS CONS CONS CONS CONS CONS

JOINT

K

KSF

KIP = 1000 LBS

KIPS PER SQUARE FOOT

ABBREVIATIONS

DESCRIPTION

SYMBOL

	ABBREVIATIONS
SYMBOL	DESCRIPTION
L	LENGTH
LB	POUND
LG	LONG LINEAR OR LINEAL
LIN	LINEAR OR LINEAL
LLH	LONG LEG HORIZONTAL
LLV	LONG LEG VERTICAL
LP	LOW POINT
LSL LT	LONG SLOTTED (BOLT HOLE) LIGHT
LW	LIGHT WEIGHT
М	MOMENT
NF	NEAR FACE
NIC	NOT IN CONTRACT
NO	NUMBER
NOM	NOMINAL
NS	NEAR SIDE
NTS NW	NOT TO SCALE NORMAL WEIGHT
OC	ON CENTER
OD	
OF OH	OUTSIDE FACE OPPOSITE HAND
OPNG	OPPOSITE HAND OPENING
OPP	OPPOSITE
OVS	OVERSIZE (BOLT HOLE)
P PCF	STRUCTURAL STEEL PIPE (STANDARD) POUNDS PER CUBIC FOOT
PERP	PERPENDICULAR
PL	PLATE
PP	PARTIAL PENETRATION (WELD)
PSF	POUNDS PER SQUARE FOOT
PSI PT	POUNDS PER SQUARE INCH POINT
R	RADIUS
REBAR	REINFORCING BAR
REINF REV	REINFORCE(ING) REVISION
REV	REVISION
SIM	SIMILAR
SL	SLAB
SOG	SLAB ON GRADE
SQ FT SQ IN	SQUARE FOOT SQUARE INCH
SS	STAINLESS STEEL
SSL	SHORT SLOTTED (BOLT HOLE)
STD	STANDARD
STIFF	STIFFENER
ST STRUCT	STEEL STRUCTURAL
011001	
T&B	TOP & BOTTOM
THK	THICK
T/CONC TOPG	TOP OF CONCRETE TOPPING
T/SL	TOP OF SLAB
T/ST	TOP OF STEEL
TS	STRUCTURAL STEEL TUBE
T/WALL	
TYP	TYPICAL
UON	UNLESS OTHERWISE NOTED
VERT, V	
VIF	VERIFY IN FIELD
W/	WITH
W/O	WITHOUT
WP	WORK POINT
WWF	WELDED WIRE FABRIC
XS	EXTRA STRONG (PIPE)
XXS	DOUBLE EXTRA STRONG (PIPE)

3

20 PSF

50 PSF

1.1

150 PSF

CODES AND STANDARDS

1.WHERE DOCUMENTS ARE REFERENCED IN THE GENERAL AND DESIGN NOTES THEY SHALL BE THE LATEST EDITIONS, UNLESS OTHERWISE NOTED.

2.ALL WORK SHALL CONFORM TO THE REQUIREMENTS OF THE SOLAR DECATHLON AND DISTRICT OF COLUMBIA BUILDING CODES, INCLUDING REFERENCE STANDARDS, ADDENDA AND APPENDICES.

3.IN ADDITION, THE FOLLOWING CODES, STANDARDS AND SPECIFICATIONS SHALL APPLY WHERE MORE STRINGENT AND AS MODIFIED BY THE BUILDING CODE.

A.AISC "MANUAL OF STEEL CONSTRUCTION", 14TH EDITION

B.AISC "CODE OF STANDARD PRACTICE FOR STEEL BUILDINGS AND BRIDGES"

C. "SPECIFICATIONS FOR STRUCTURAL JOINTS USING ASTM A 325 OR A 490 BOLTS"

D.AWS D1.1 "STRUCTURAL WELDING CODE"

E.AISI "SPECIFICATION FOR THE DESIGN OF COLD FORMED STEEL STRUCTURAL MEMBERS"

DESIGN LOADS

1. BUILDING OCCUPANCY CATEGORY

CATEGORY II

2.LIVE LOADS -ROOF -FLOOR -MECHANICAL LIVE LOAD REDUCTION NOT USED.

ROOF LIVE LOAD REDUCTION NOT USED.

3.WIND LOADS

-BASIC WIND SPEED 90 MPH -WIND LOAD IMPORTANCE FACTOR 1.0 -WIND EXPOSURE CATEGORY WIND LOAD DETERMINATION BY ASCE 7-05, METHOD 1

4.SEISMIC LOADS (REQUIRED FOR CALIFORNIA

COMPETITION SITE ONLY)	
-SEISMIC DESIGN CATEGORY	D
-SEISMIC LOAD IMPORTANCE FACTO	DR 1.0
-SEISMIC OCCUPANCY CATEGORY	I
-LATERAL SYSTEM TYPE	
ORDINARY BRACED FRAME	
-RESPONSE MODIFICATION FACTOR	3.5
-DEFLECTION AMPLIFICATION FACT	OR 3
-RESPONSE ACCELERATION	
SHORT PERIOD	1.46
1 SECOND PERIOD	0.56
5.SNOW LOADS	
-GROUND SNOW LOAD	25 PSF

-G	ROUND SNOW LOAD	
-SI	NOW EXPOSURE FACTOR	
-SI	NOW IMPORTANCE FACTOR	

FOUNDATIONS

OUT.

1.THE FOLLOWING ALLOWBALE SOIL PRESSURES WERE USED IN THE PRPEARATION OF THESE

DRAWINGS -6,000 PSF (PER SOLAR DECATHLON BUILDING CODE, FOR CALIFORNIA COMPETITION SITE ONLY) -3,000 PSF (ALL OTHER TEMPORARY LOCATIONS)

2.CONTRACTOR SHALL VISIT THE SITE AND THOROUGHLY FAMILIARIZE HIMSELF WITH ALL SURFACE AND SUBSURFACE CONDITIONS IN ADDITION TO THE INFORMATION CONTAINED IN THE SOLAR DECATHLON BUILDING CODE.

3.FOOTINGS SHALL BE BUILT AS SHOWN IN DRAWINGS. PROJECT DOCUMENTS

1.THIS SET OF DRAWINGS, TOGETHER WITH THE SPECIFICATIONS, CONSTITUTES THE COMPLETE DOCUMENT BY WHICH ALL WORK IS TO BE CARRIED

2.THE CONTRACTOR SHALL VERIFY ALL EXISTING CONDITIONS AND DIMENSIONS AT JOB SITE. THE CONTRACTOR SHALL USE STRUCTURAL DRAWINGS IN CONJUNCTION WITH ARCHITECTURAL, MECHANICAL, ELECTRICAL, PLUMBING, FIRE PROTECTION AND ALL OTHER RELEVANT CONSULTANTS' DRAWINGS BEFORE COMMENCING WITH THE WORK AND SHALL NOTIFY THE ARCHITECT AND ENGINEER OF ANY DISCREPANCIES REQUIRING CLARIFICATION OR REVISION.

3.SCALES NOTED ON THE DRAWINGS ARE FOR GENERAL INFORMATION ONLY. NO DIMENSIONAL INFORMATION SHALL BE OBTAINED BY SCALING FROM THE DRAWINGS.

4.IN THE EVEN THAT CERTAIN DETAILS OF THE CONSTRUCTION ARE NOT FULLY SHOWN OR NOTED ON DRAWINGS, THEIR CONSTRUCTION SHALL BE OF THE SAME TYPE AS FOR SIMILAR CONDITIONS THAT ARE SHOWN OR NOTED, SUBJECT TO THE STRUCTURAL ENGINEER'S APPROVAL.

5.REFER TO ARCHITECTURAL DRAWINGS FOR THE FOLLOWING:

A.SIZE AND LOCATION OF ALL DOOR AND WINDOW OPENINGS, EXCEPT AS NOTED.

B.SIZE AND LOCATION OF ALL INTERIOR AND EXTERIOR NON-BEARING PARTITIONS.

C.SIZE AND LOCATION OF ALL CONCRETE CURBS, FLOOR DRAINS, SLOPES, INSERTS, ETC. EXCEPT AS SHOWN.

D.FLOOR AND ROOF FINISHES.

E.DIMENSIONS NOT SHOWN ON STRUCTURAL DRAWINGS.

6.REFER TO MEP DRAWINGS FOR THE FOLLOWING:

A.PIPE AND DUCT RUNS, SLEEVES, HANGERS, TRENCHES, WALL AND SLAB OPENINGS, EXCEPT AS SHOWN OR NOTESD.

B.ELECTRICAL CONDUIT RUNS, BOXES, OUTLETS IN WALLS SPLICES SHALL BE MADE ONLY AT LOCATIONS AND SLABS.

C.CONCRETE INSERTS FOR ELECTRICAL, MECHANICAL OR PLUMBING FIXTURES.

D.SIZE AND LOCATION OF MACHINE OR EQUIPMENT BASES, AS TO CLEAR ALL ARCHITECTURAL FINISHES AND ANCHOR BOLTS FOR MOTOR MOUNTS, EXCEPT AS SHOWN OR NOTED.

7.SEE SPECIFICATIONS FOR WATERPROOFING AND DAMP PROOFING.

8.IT IS THE RESPONSIBILITY OF THE CONTRACTOR TO PROVIDE PROPER SHORING AND BRACING DURING CONSTRUCTION WHEREVER NECESSARY, WHICH SHALL NOT BE REMOVED AS LONG AS REQUIRED FOR SAFETY. STEEL DECK

1.STEEL DECK AND ACCESSORIES SHALL BE FROM STEEL CONFORMING TO ASTM A1008 OR ASTM A653 WITH A MINIMUM YIELD STRESS OF 50 KSI.

2.GALVANIZING SHALL CONFORM TO THE REQUIREMENTS OF ASTM A653 WITH A MINIMUM COATING OF G60.

3.ROOF DECK SHALL BE 18 GAGE TYPE 1.5B. DECK SHALL BE BY VULCRAFT OR APPROVED EQUAL. REFER TO DRAWINGS FOR OTHER REQUIREMENTS.

4.ROOF DECK SHALL BE ATTACHED TO SUPPORTING STRUCTURAL MEMBERS BY (7)-5/8" PUDDLE WELDS OR EQUIVALENT STEEL DECKING FASTENERS FOR EVERY 36" COVERAGE.

5. ROOF DECK SIDELAPS BETWEEN ADJACENT UNITS SHALL BE FASTENED BY (4)-#10 TEK SCREWS FOR EACH SPAN.

6.FLOOR DECK SHALL BE 18 GAGE TYPE 3N. DECK SHALL BE BY VULCRAFT OR APPROVED EQUAL. REFER TO DRAWINGS FOR OTHER REQUIREMENTS.

7.FLOOR DECK SHALL BE ATTACHED TO SUPPORTING STRUCTURAL MEMBERS BY (4)-5/8" PUDDLE WELDS OR EQUIVALENT STEEL DECKING FASTENERS FOR EVERY 24" COVERAGE.

8.FLOOR DECK SIDELAPS BETWEEN ADJACENT UNITS SHALL BE FASTENED BY (4)-#10 TEK SCREWS FOR EACH SPAN.

9. DECK WELDING SHALL COMPLY WITH THE BUILDING CODE AND AWS-D1.1. ELECTRODES SHALL BE E70XX.

10.PROVIDE 2 INCHES MINIMUM BEARING AT DECK SUPPORTS.

11.PROVIDE MISCELLANEOUS TRIMMING STEEL AS REQUIRED TO SUPPORT THE DECK WHERE NOT SPECIFICALLY SHOWN ON DRAWINGS.

STEEL FRAMING NOTES

1.STEEL MEMBERS ARE ASSUMED TO BE VERTICAL AND DIMENSIONED TO THEIR CENTERLINE UNLESS OTHERWISE NOTED.

2.STEEL MEMBERS NOT LOCATED IN PLAN BY A DIMENSION LINE SHALL BE EQUALLY SPACED BETWEEN DIMENSIONED MEMBERS.

3.FOR SLOPING MEMBERS, THE TOP OF STEEL ELEVATIONS AT THE LOW AND HIGH POINTS SHALL COINCIDE WITH THE TOP OF STEEL ELEVATIONS OF THE MEMBERS THEY ARE FRAMING TO AT THESE LOCATIONS, UNLESS OTHERWISE NOTED.

STRUCTURAL STEEL

1.STRUCTURAL STEEL SHALL BE PROVIDED AS FOLLOWS:

ASTM STANDARD	Fy (KSI)
A992	50
A572 GRADE 50	50
A500 GRADE B	46
A53 TYPE E	35
A36	36
A36	36
	A992 A572 GRADE 50 A500 GRADE B A53 TYPE E A36

-Fv IS THE MINIMUM TENSILE YIELDING STRESS TO BE PROVIDED UNLESS OTHERWISE NOTED.

2.ALL BOLTED CONNECTIONS SHALL BE MADE WITH 3/4" DIAMETER HIGH STRENGTH BOLTS CONFORMING TO ASTM A325 UNLESS OTHERWISE NOTED. ALL CONNECTIONS SHALL BE TYPE N UNLESS OTHERWISE NOTED ON DRAWINGS.

3.NUTS SHALL CONFORM TO ASTM A563, DH OR ASTM A194, 2H. PROVIDE WASHERS CONFORMING TO ASTM F436 AT EACH THREADED ROD OR BOLT.

4.BOLT HOLES IN STEEL MEMBERS, WITH THE EXCEPTION OF BASE PLATES, SHALL BE 1/16 INCH LARGER IN DIAMETER THAN THE NOMINAL SIZE OF BOLT USED, UNLESS NOTED OTHERWISE ON DRAWINGS.

5.BOLT HOLES IN STEEL BASE PLATES SHALL BE OF THE SIZE MARKED ON DRAWINGS. PROVIDE WELDED PLATE WASHERS 3"x3"x3/8" THICK MINIMUM.

6.ALL WELDS SHALL BE CONTINUOUS UNLESS OTHERWISE NOTED. MINIMUM WELD SIZE TO BE 3/16" FILLET UNLESS OTHERWISE NOTED.

7. THREADED RODS SHALL HAVE THREADS CONFORMING TO UNC CLASS 2A (EXTERIOR THREADS) AND 2B (INTERNAL THREADS).

8.WELDING MATERIALS SHALL CONFORM TO AWS D1.1. ELECTRODES SHALL HAVE A MINIMUM TENSILE STRENGTH OF 70 KSI AND BE LOW-HYDROGEN TYPE.

9.WELD LENGTHS CALLED FOR ON PLANS ARE THE NET EFFECTIVE LENGTHS REQUIRED.

10.SPLICES SHALL BE DESIGNED TO DEVELOP THE FULL CAPACITY OF THE MEMBER AT THE POINT OF SPLICE. INDICATED ON DRAWINGS. FULL DETAIL AND BACK-UP CALCULATIONS OF SPLICES REQUIRE REVIEW AND APPROVAL BY THE ENGINEER.

11.SHAPE AND SIZE GUSSET PLATES IN SUCH A MANNER MECHANICAL FIXTURES (DUCTS, PIPES, ETC.). SUBMIT THE CONFIGURATION OF ALL GUSSET PLATES EXPOSED TO VIEW TO ARCHITECT AND ENGINEER FOR REVIEW AND APPROVAL

12.CONTRACTOR SHALL PROVIDE ALL NECESSARY TEMPORARY BRACING, GUYING AND CONNECTING MEMBERS REQUIRED TO ERECT THE STRUCTURE, MAINTAIN CORRECT ALIGNMENT AND SAFELY RESIST ALL POSSIBLE COMBINATIONS OF DEAD, CONSTRUCTION, ERECTION, WIND AND OTHER LATERAL LOADS.

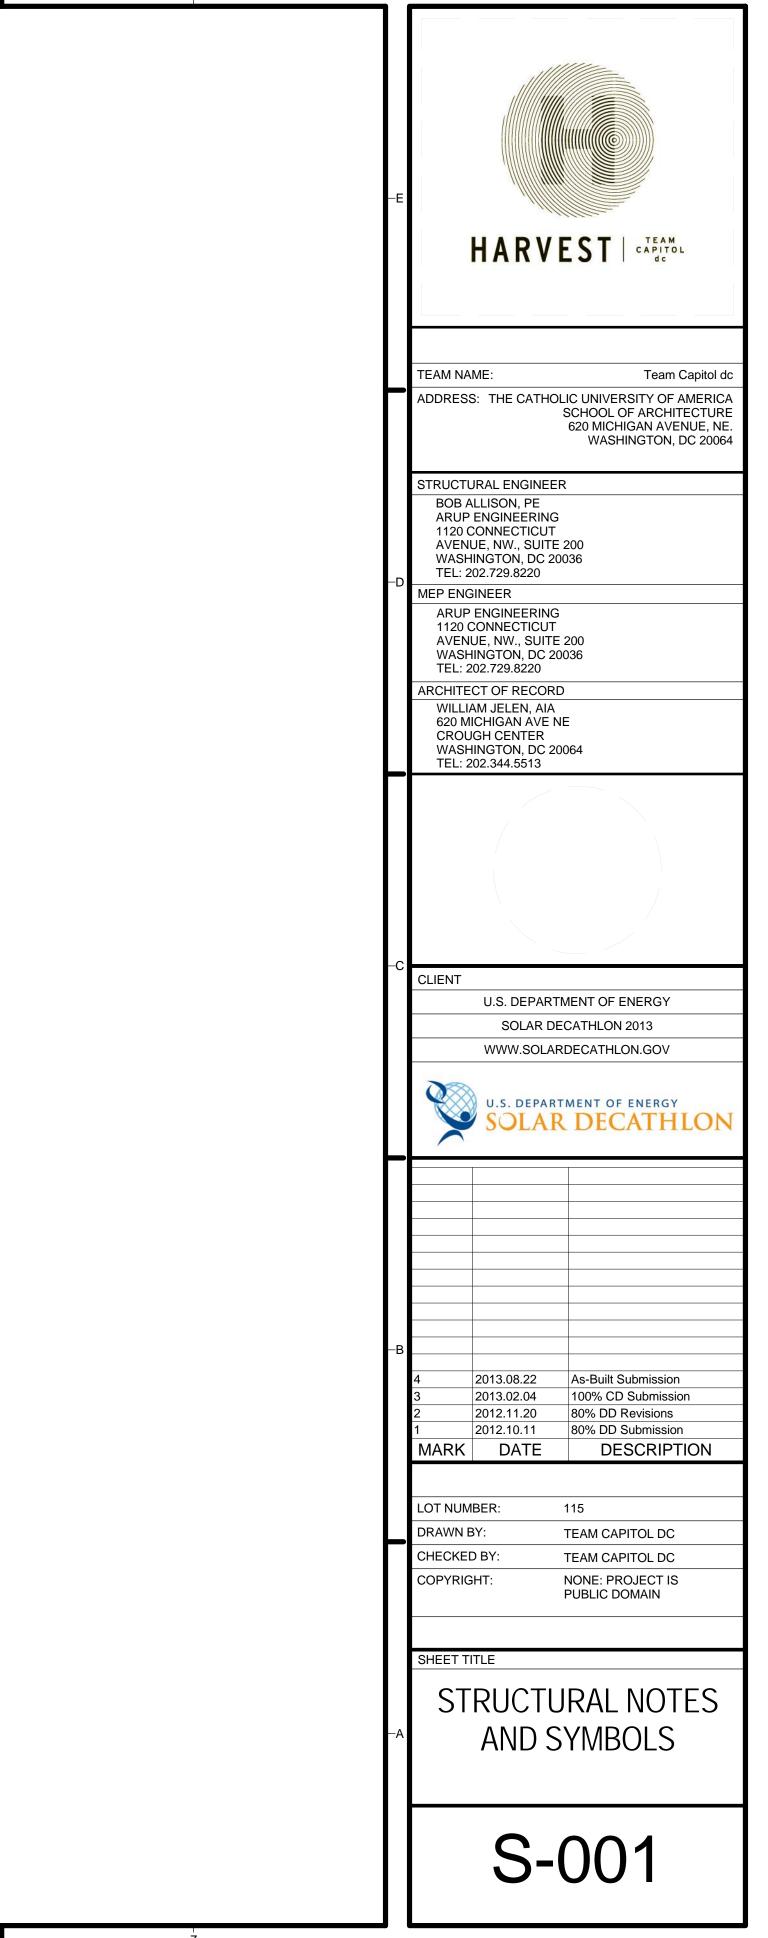
13.REFER TO SPECIFICATIONS FOR STEELWORK PROTECTION AND COATINGS.

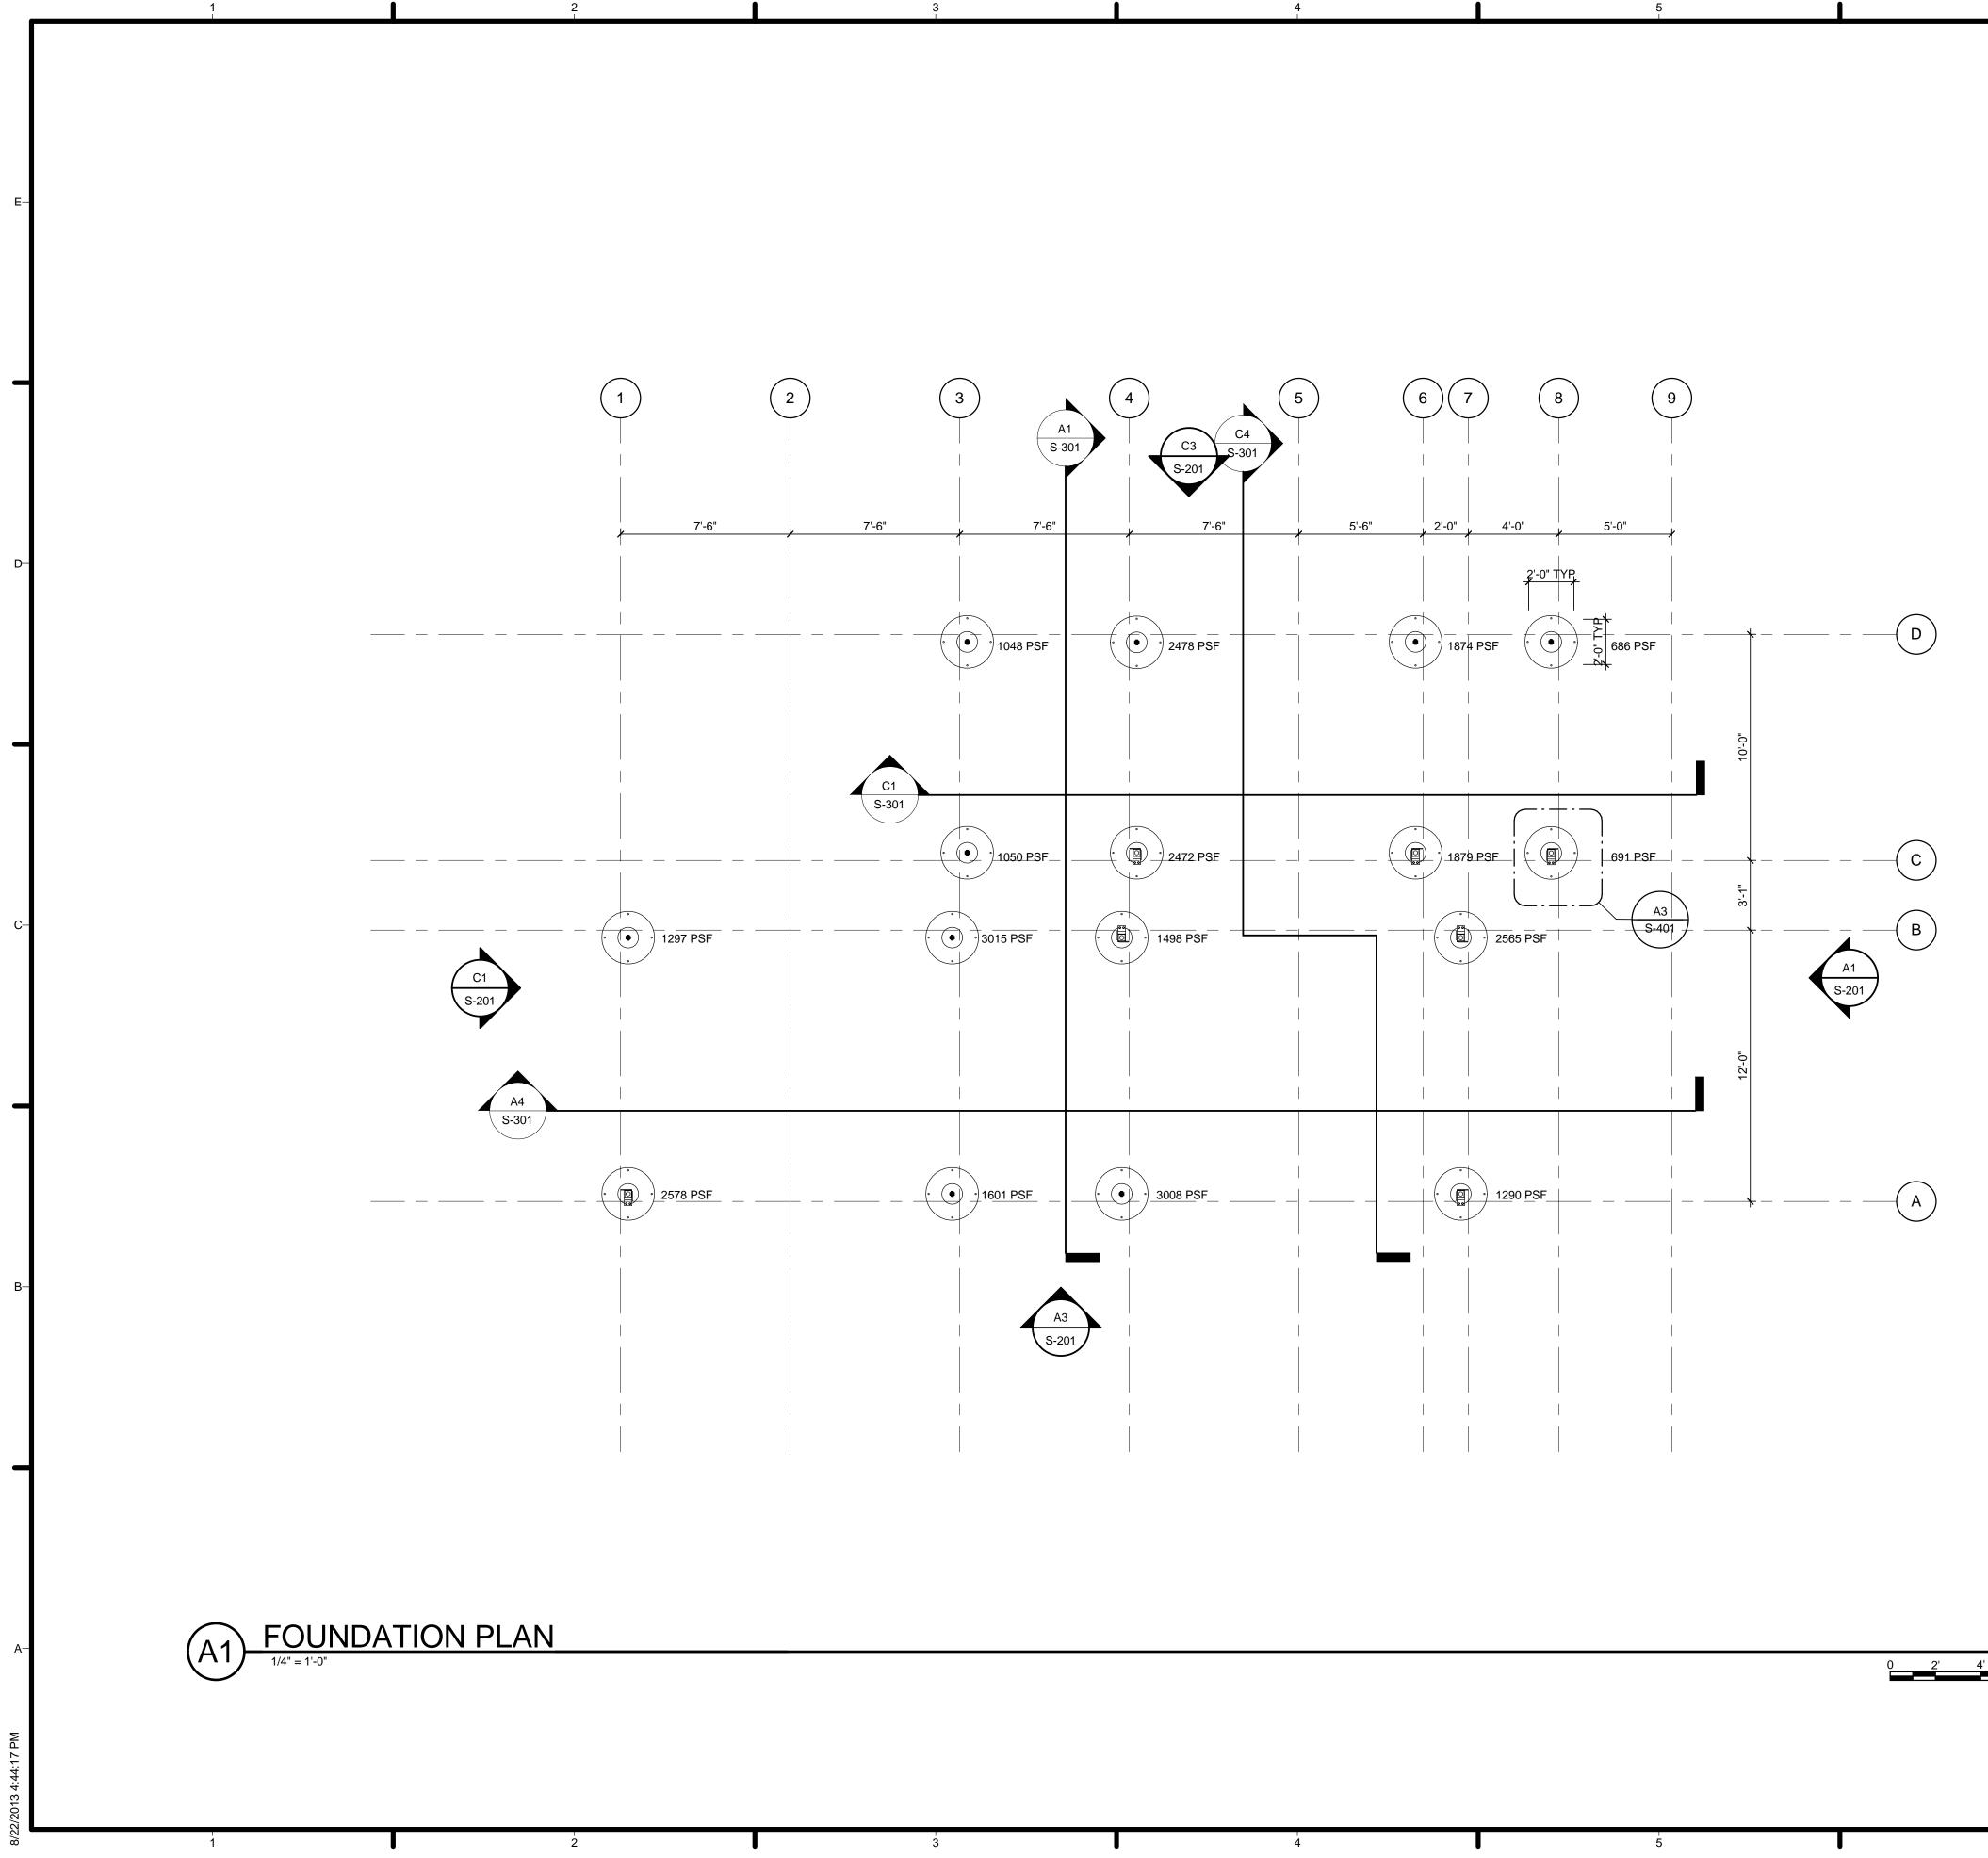
SUBMITTALS

1.CONTRACTOR SHALL SUBMIT SHOP DRAWINGS FOR ENGINEER'S APPROVAL.

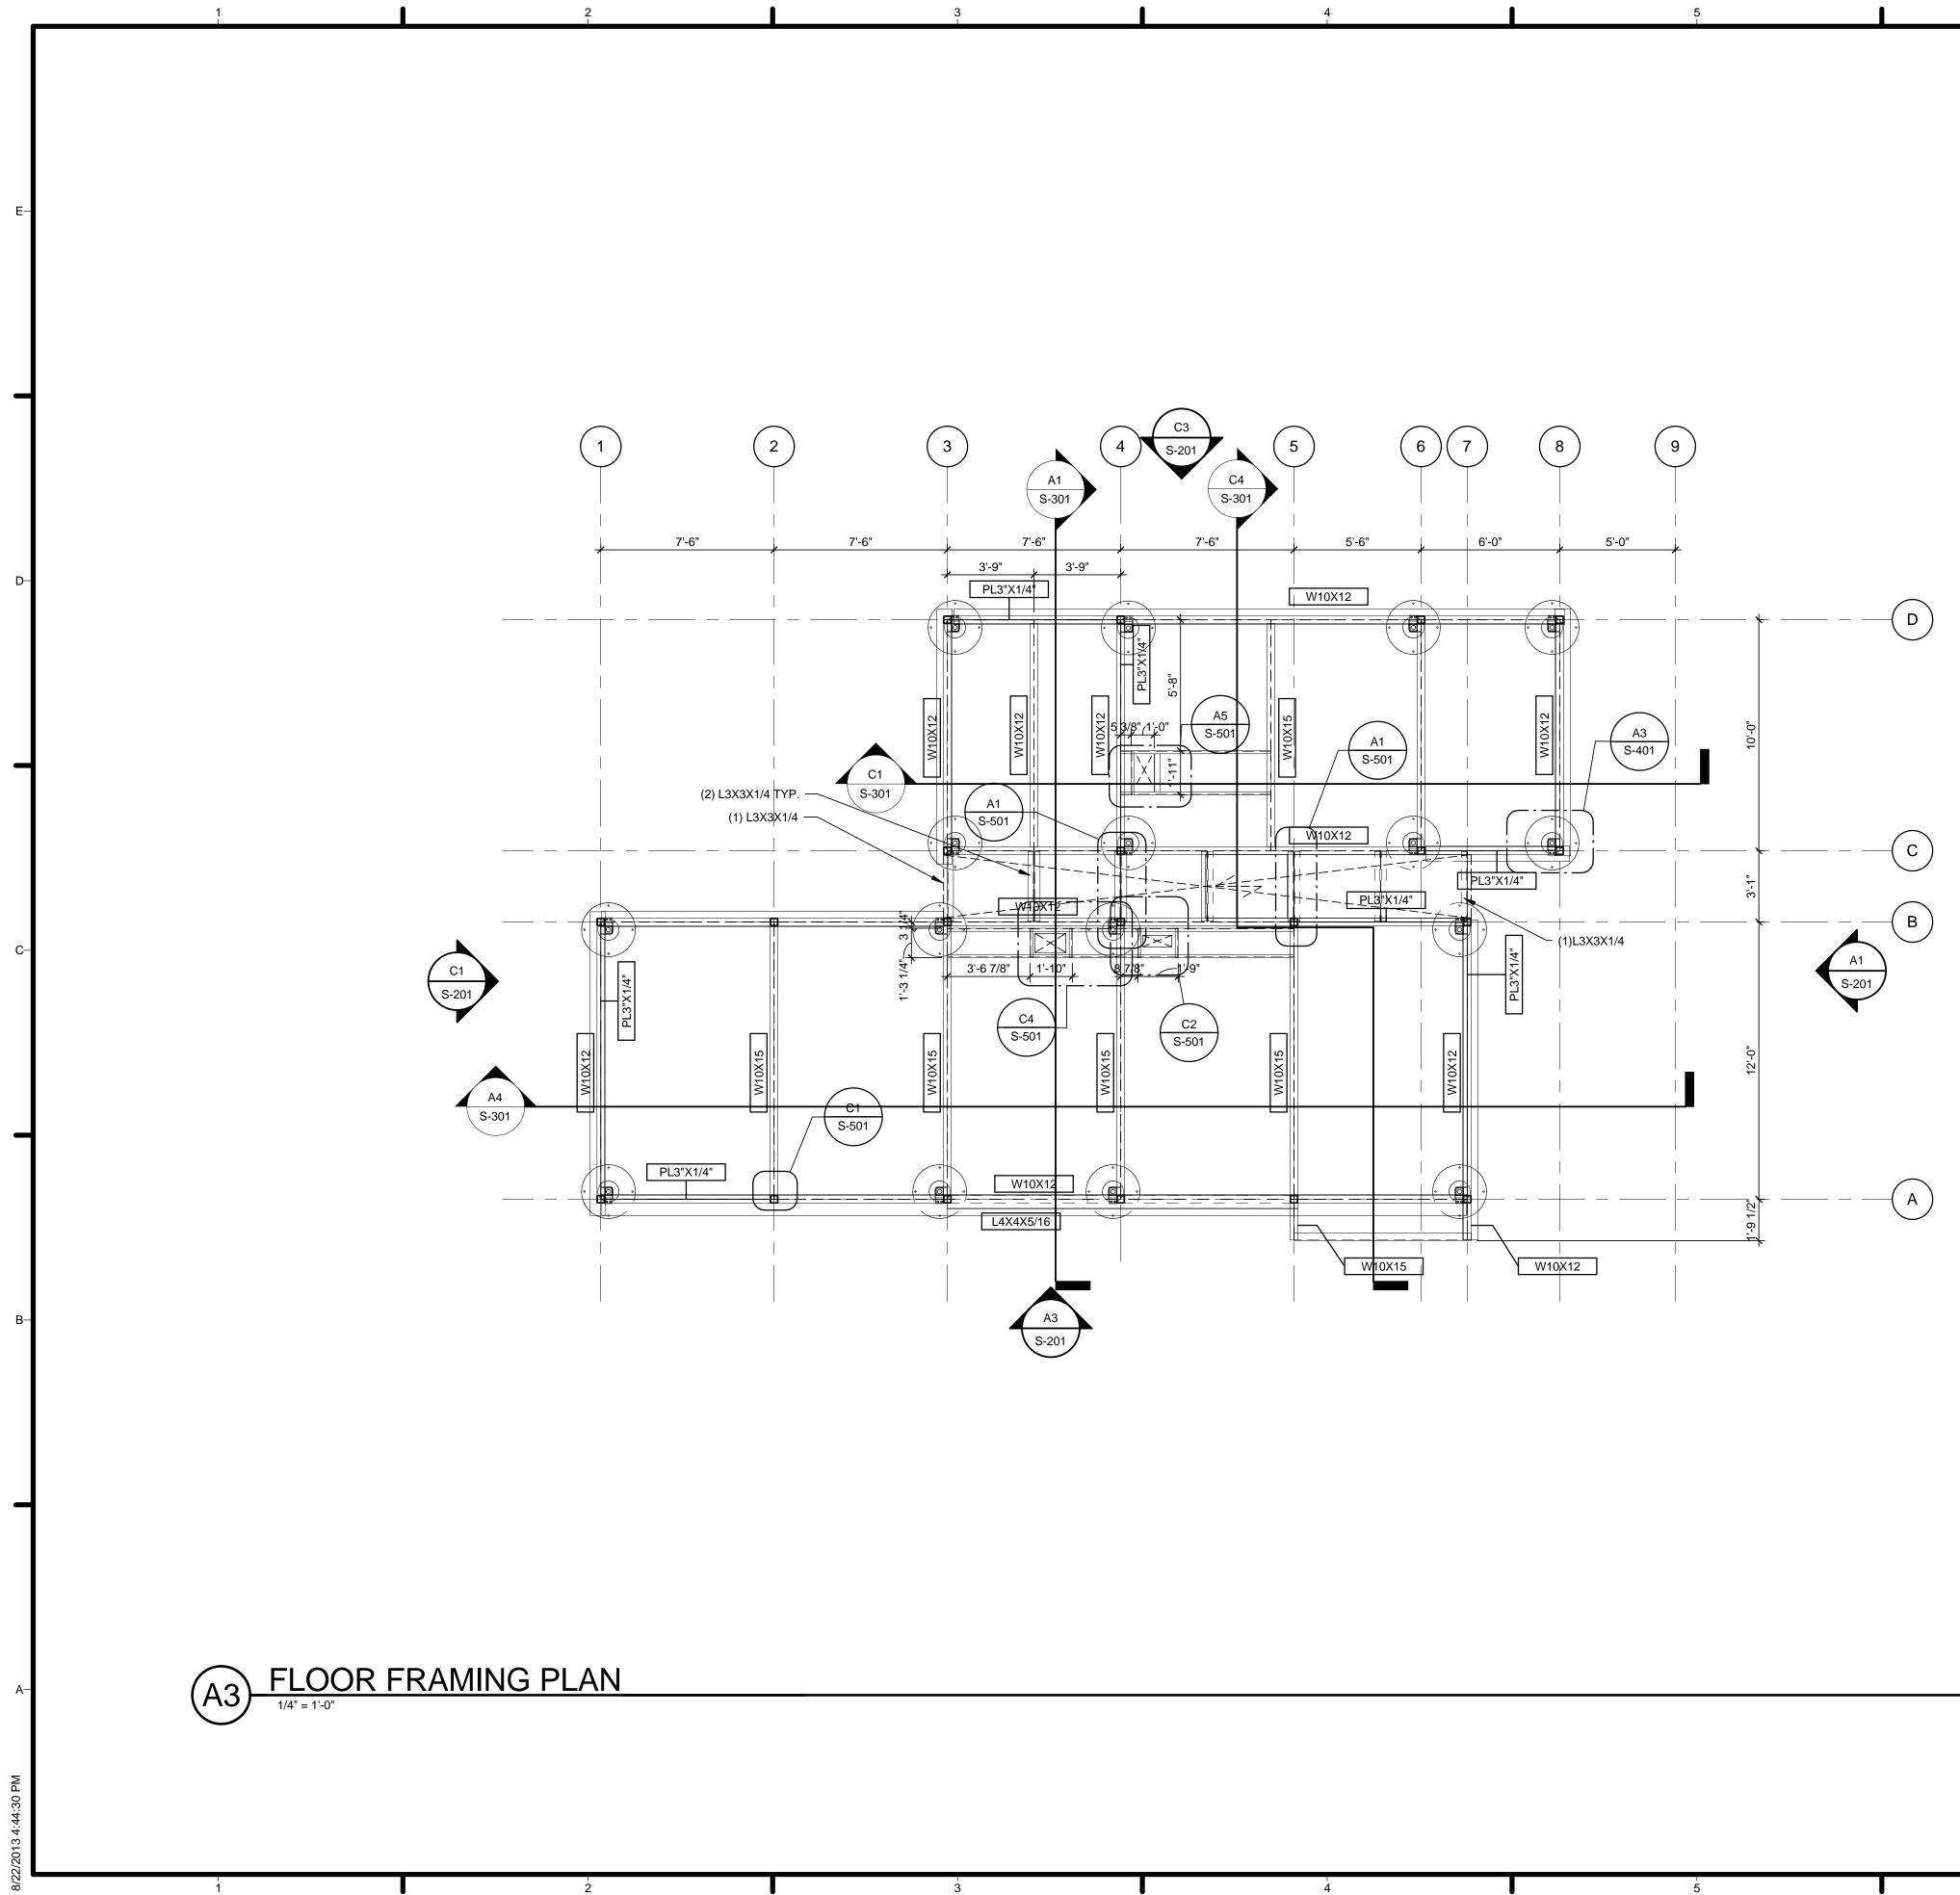
2. ONLY SHOP DRAWINGS MARKED "NO EXCEPTIONS TAKEN", "REVISE AS NOTED" OR "SEE COMMENTS NOTED" MAY BE USED BY CONTRACTOR IN THE WORK. SHOP DRAWINGS MARKED "REJECTED" OR "RESUBMIT FOR REVIEW" SHALL BE CORRECTED AND COMPLETED AS REQUIRED AND RESUBMITTED TO THE ARCHITECT BEFORE THEY ARE USED IN THE WORK. TESTING AND INSPECTIONS **1.THE OWNER WILL RETAIN AN INDEPENDENT TESTING** AGENCY TO INSPECT, CONDUCT TESTS, AND PROVIDE RECORDS OF THE FOLLOWING TYPES OF WORK AS REQUIRED BY THE BUILDING CODE:

A.ALL STRUCTURAL STEEL WELDING **B.ALL HIGH STRENGTH BOLTING**

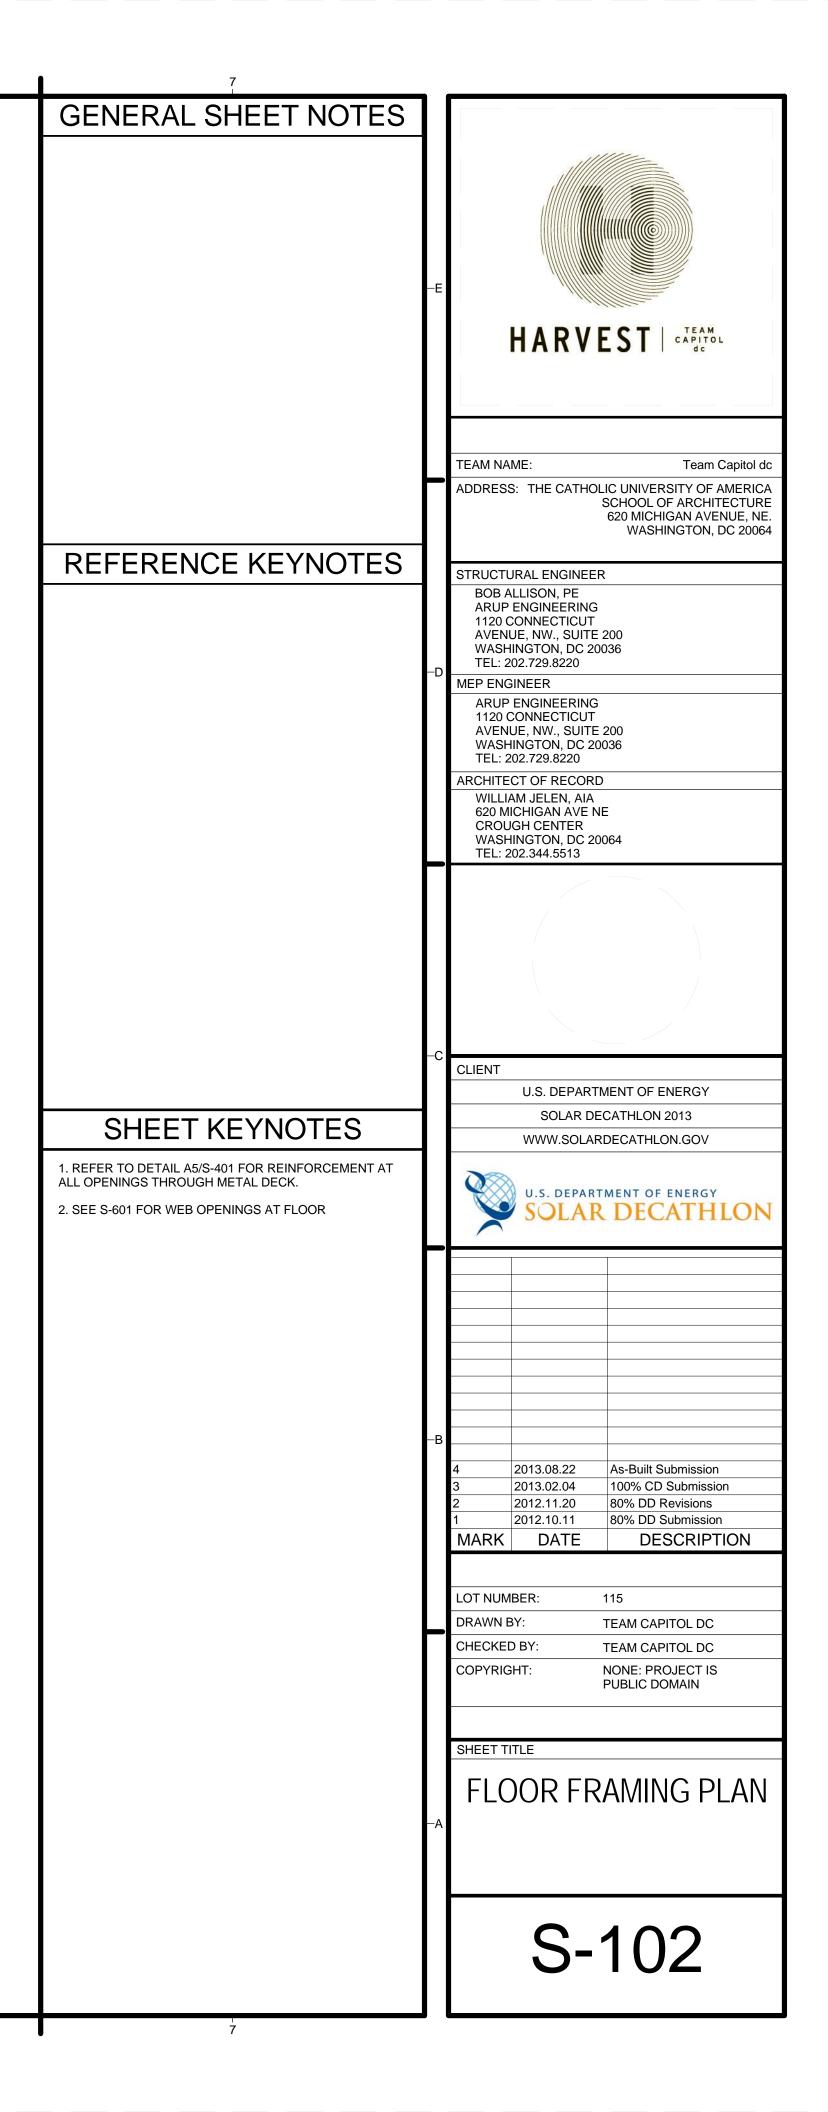


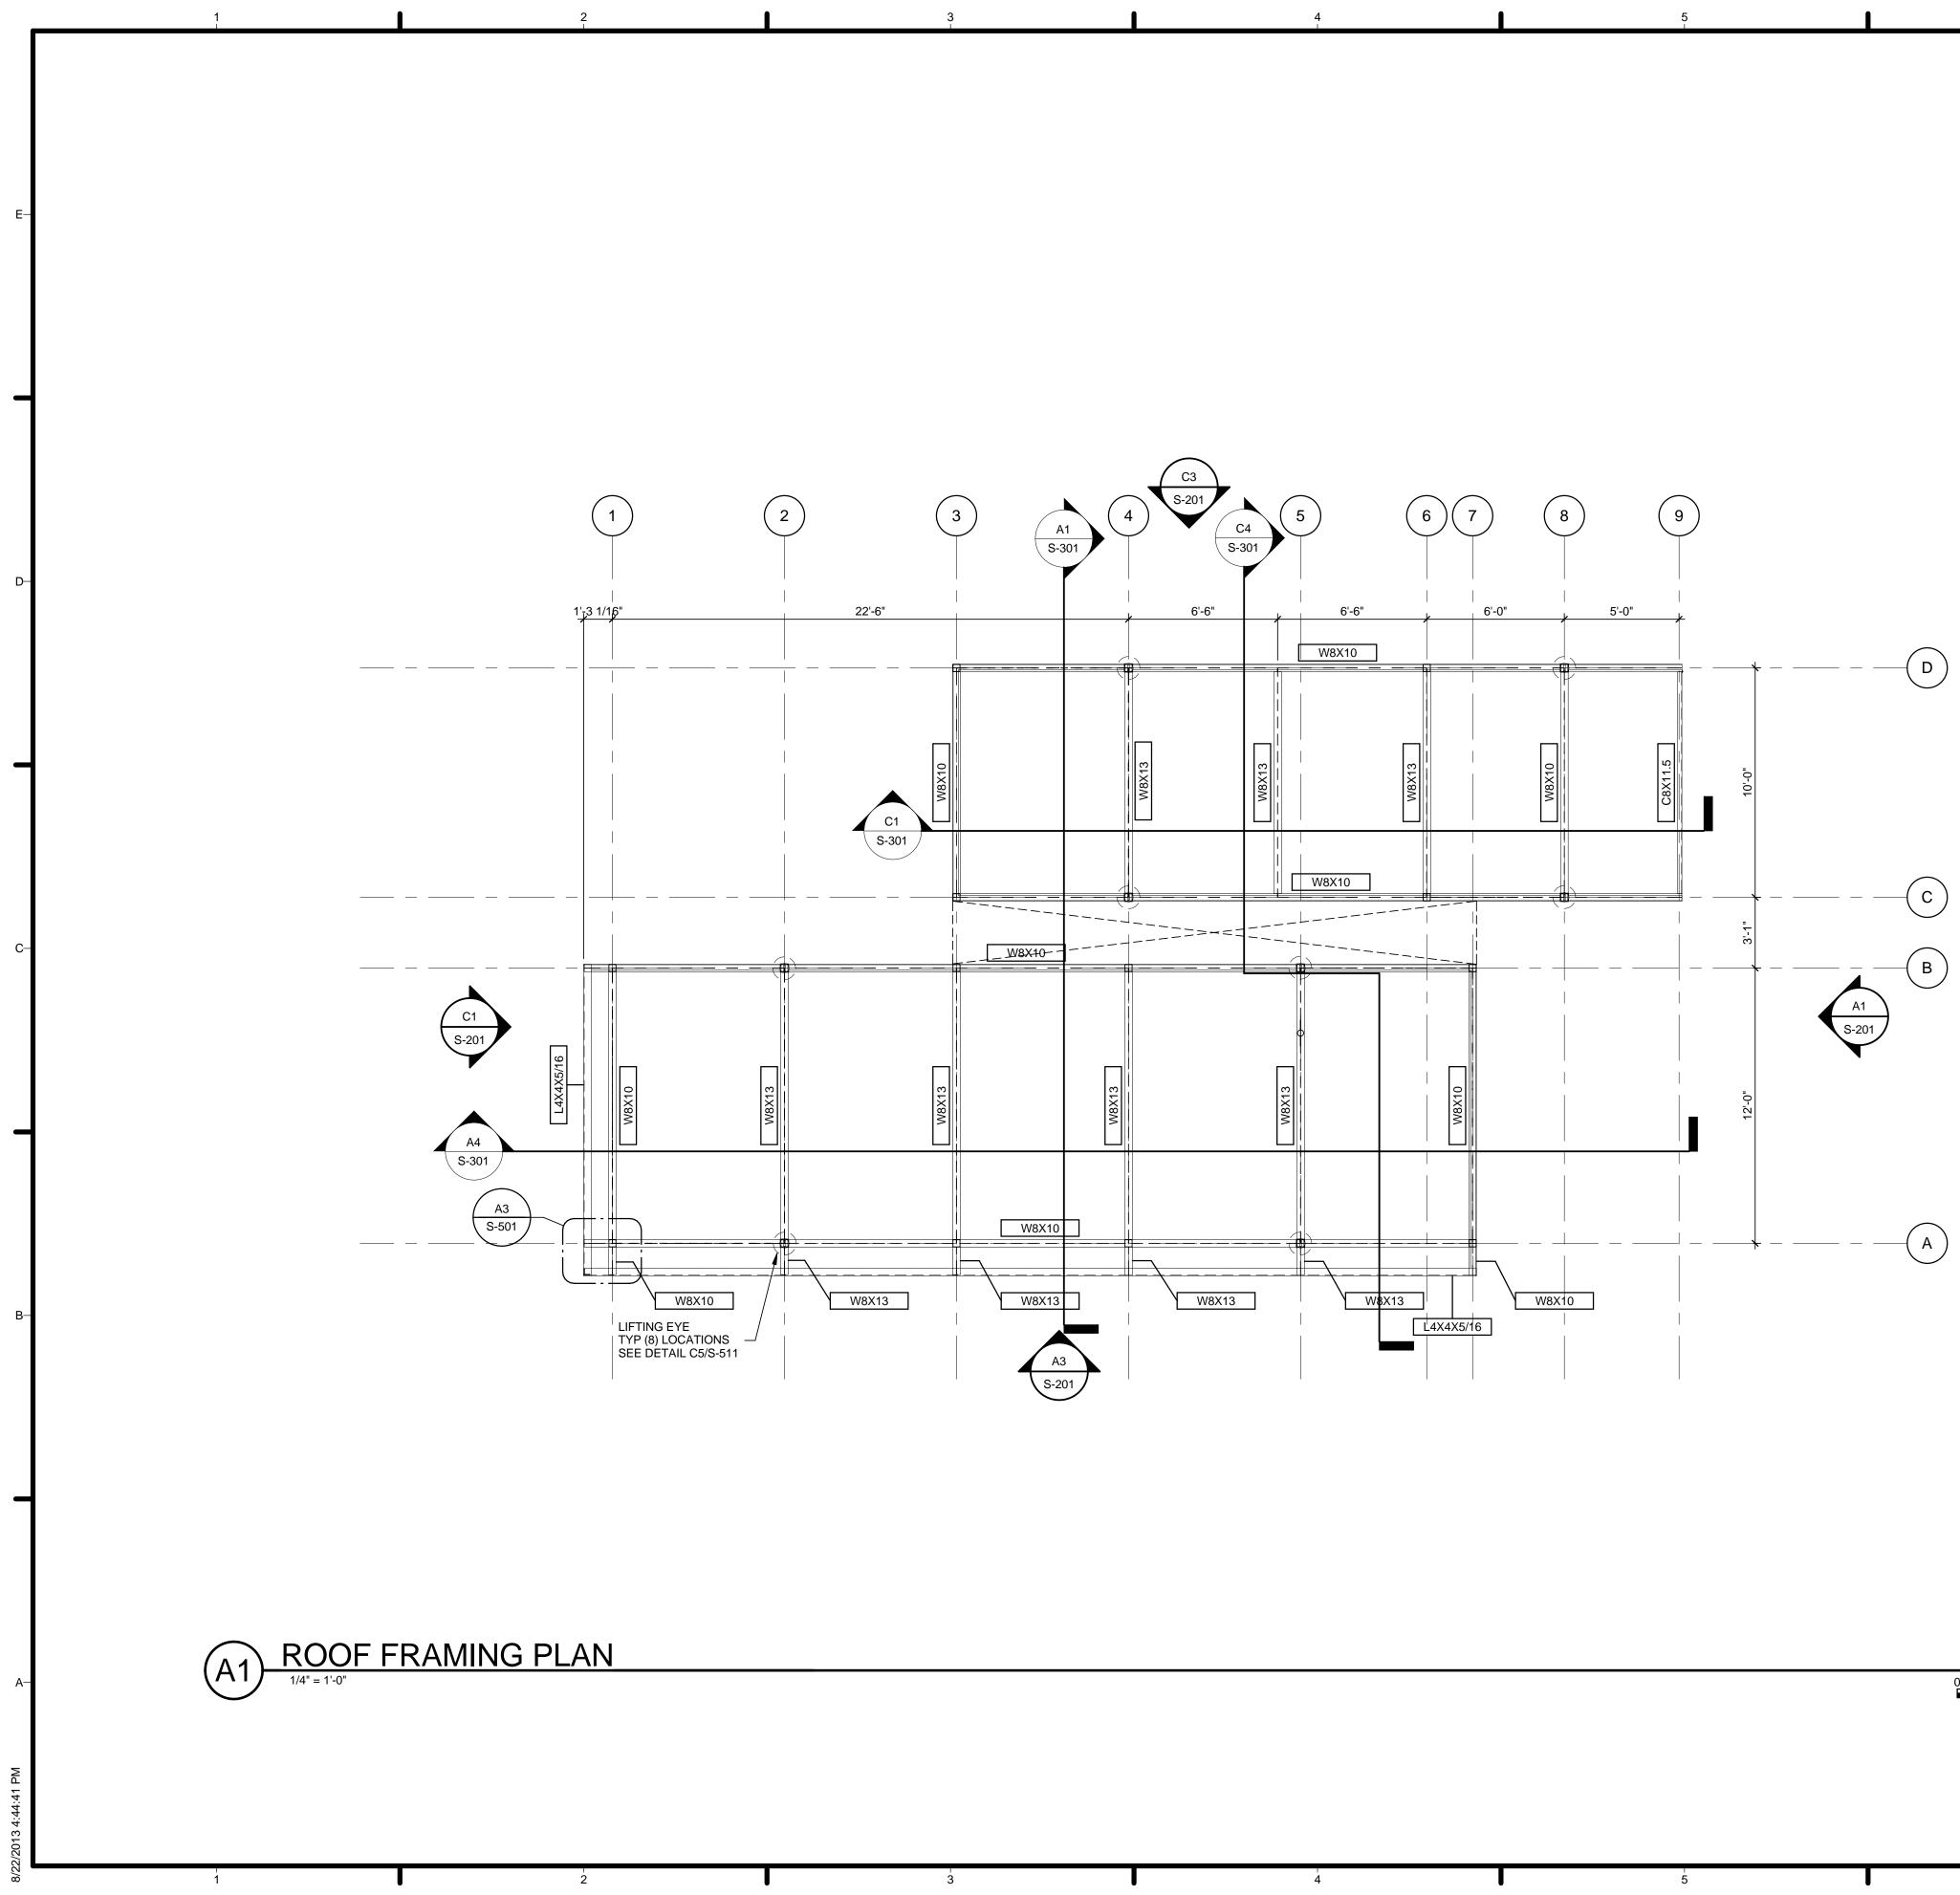


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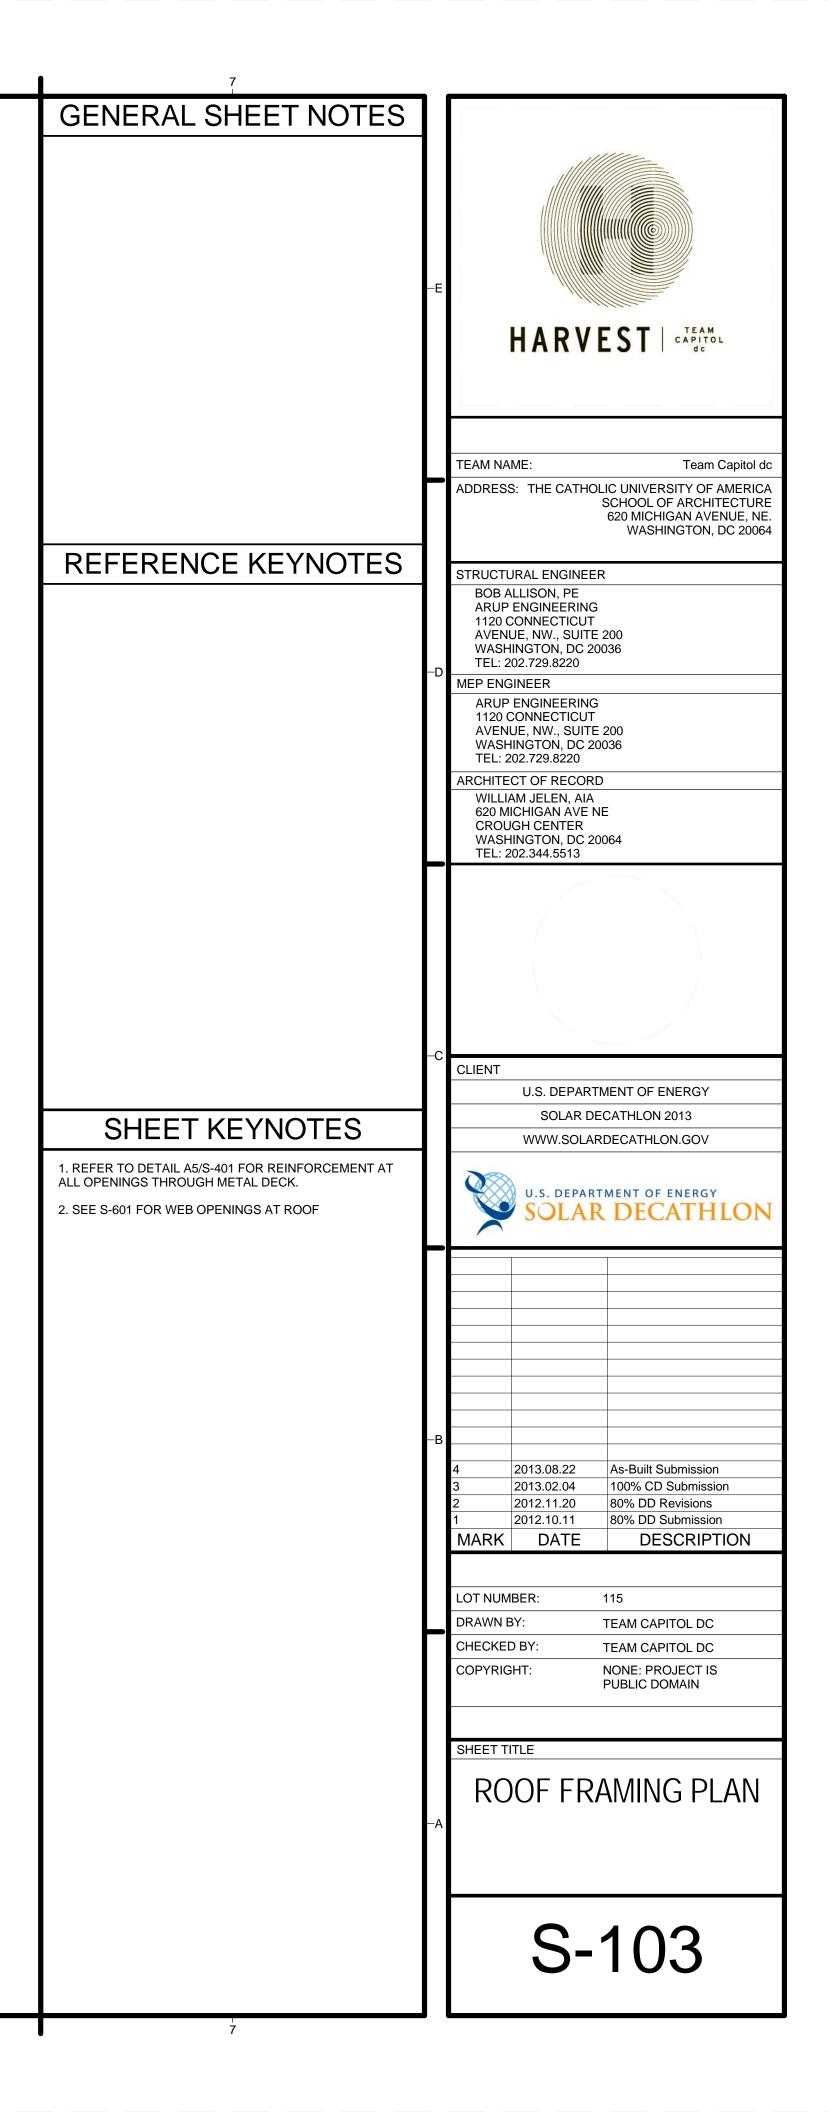


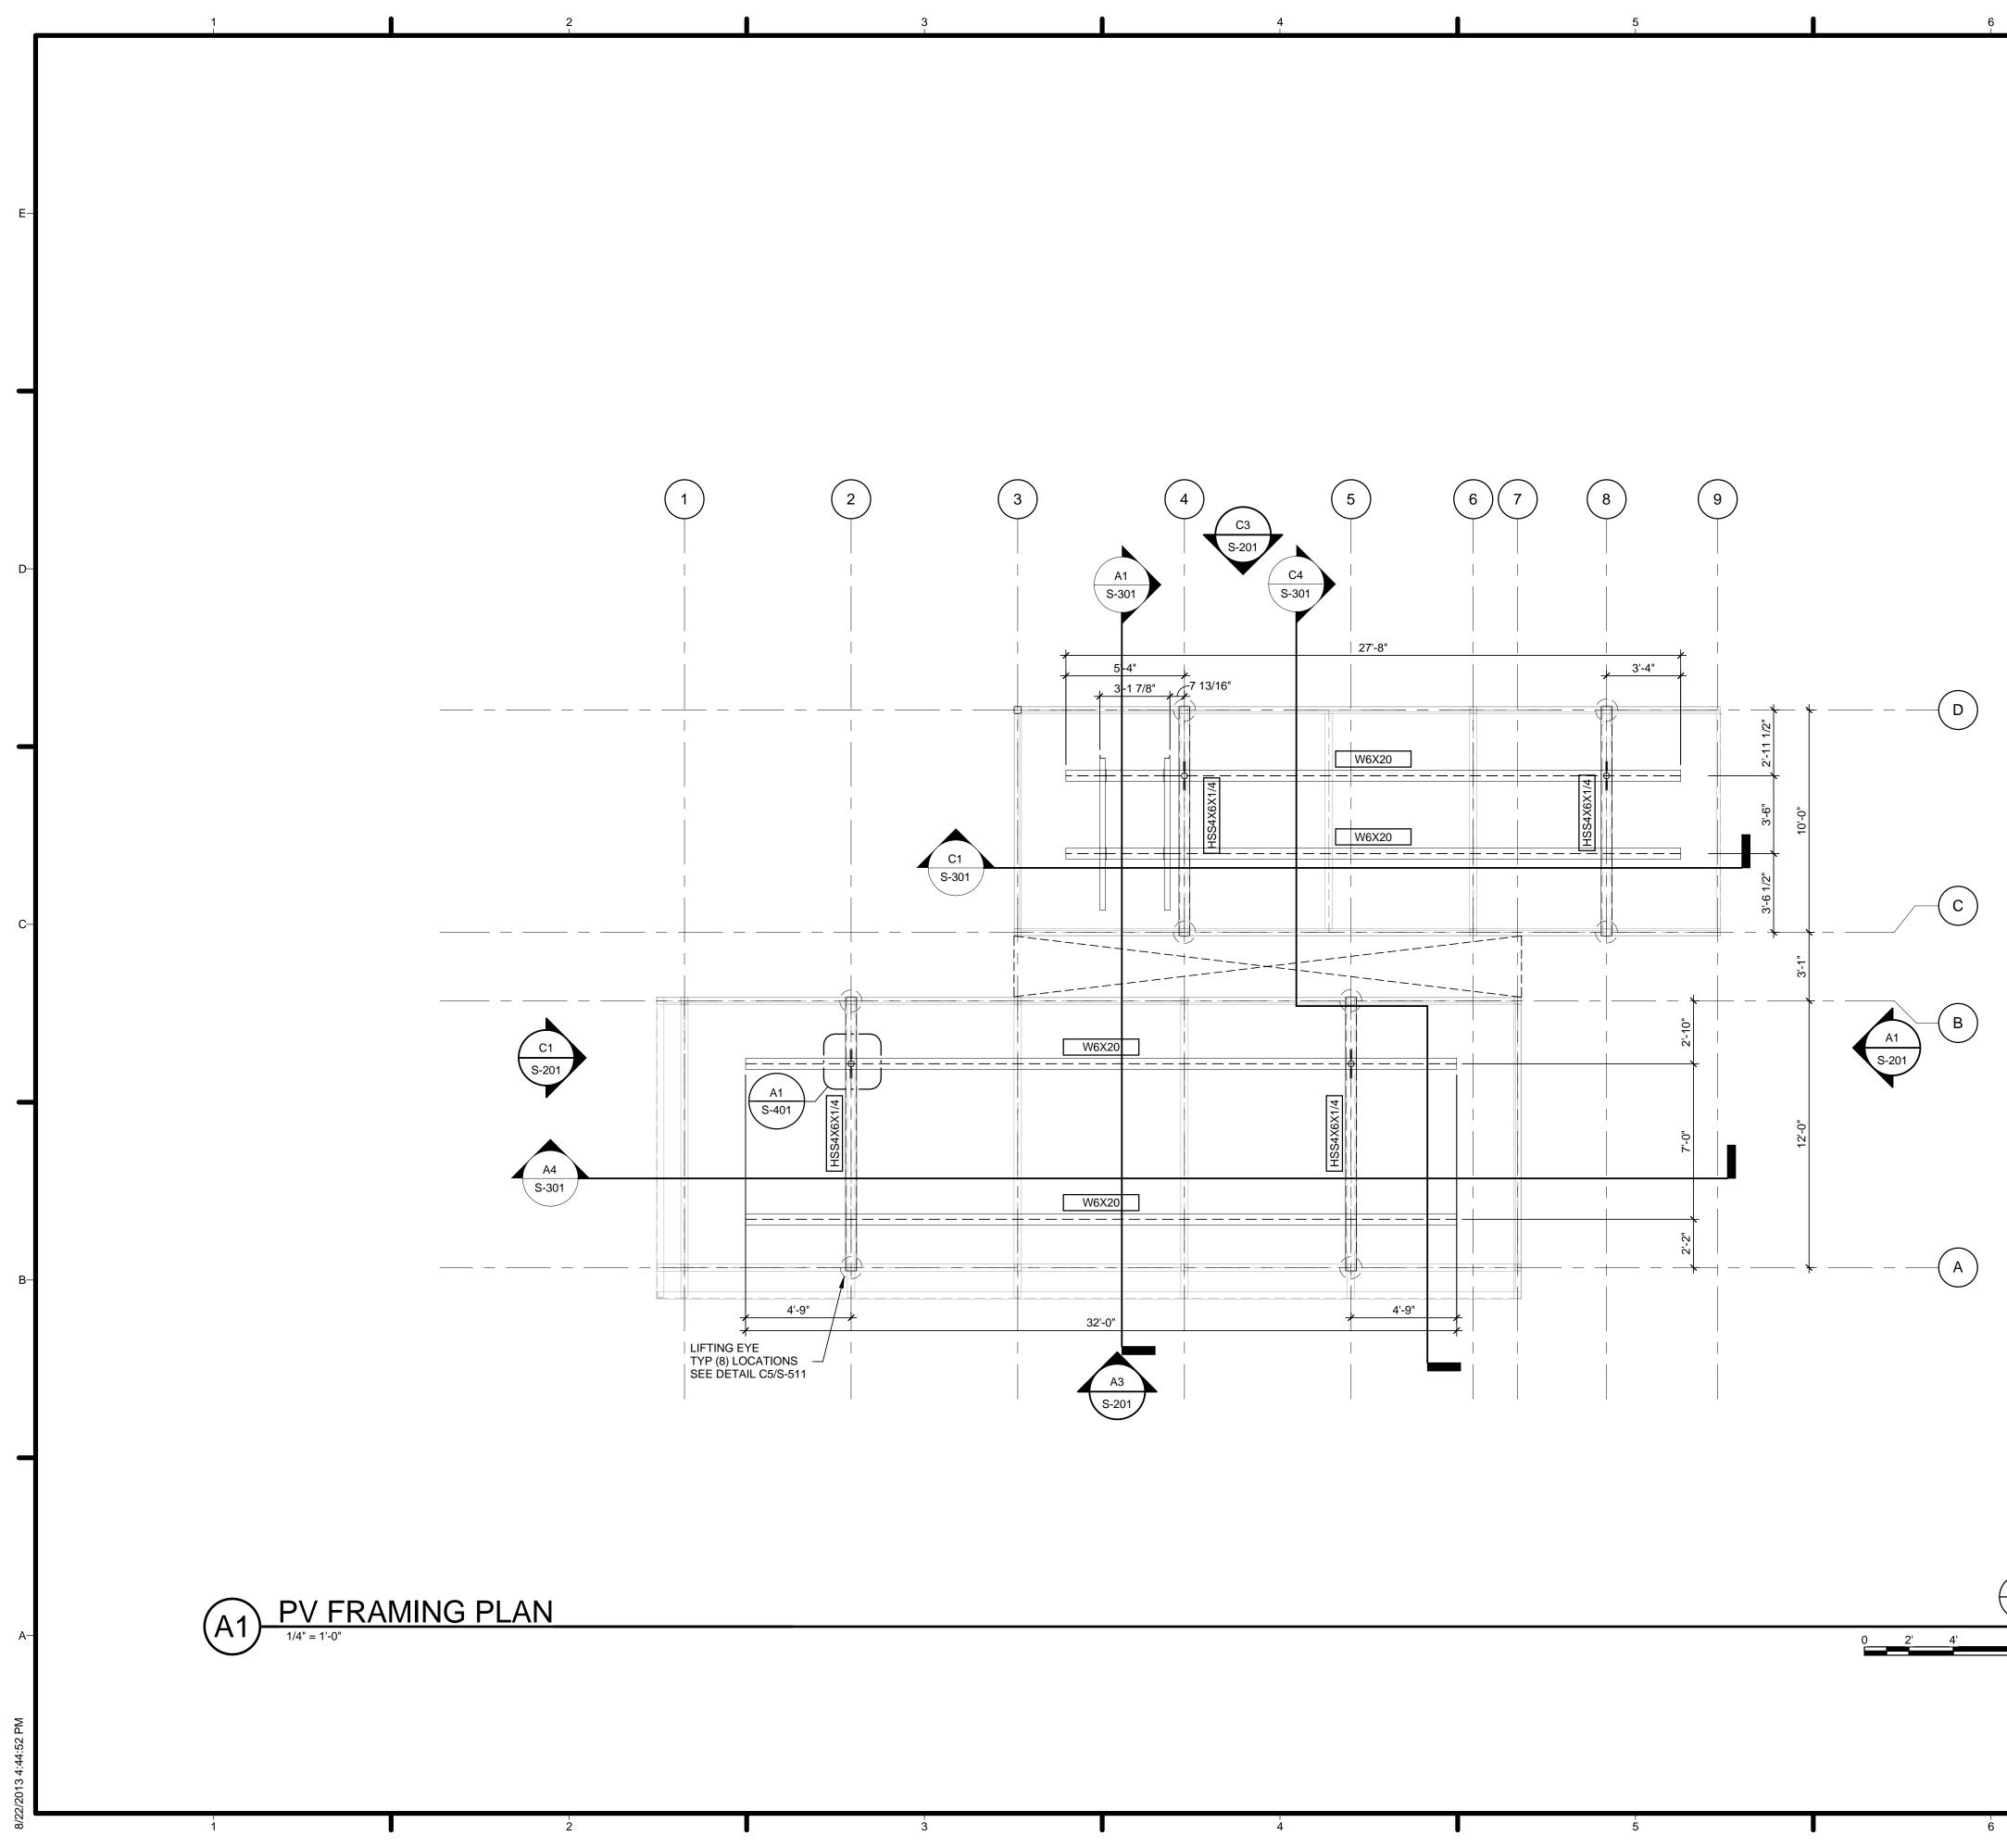
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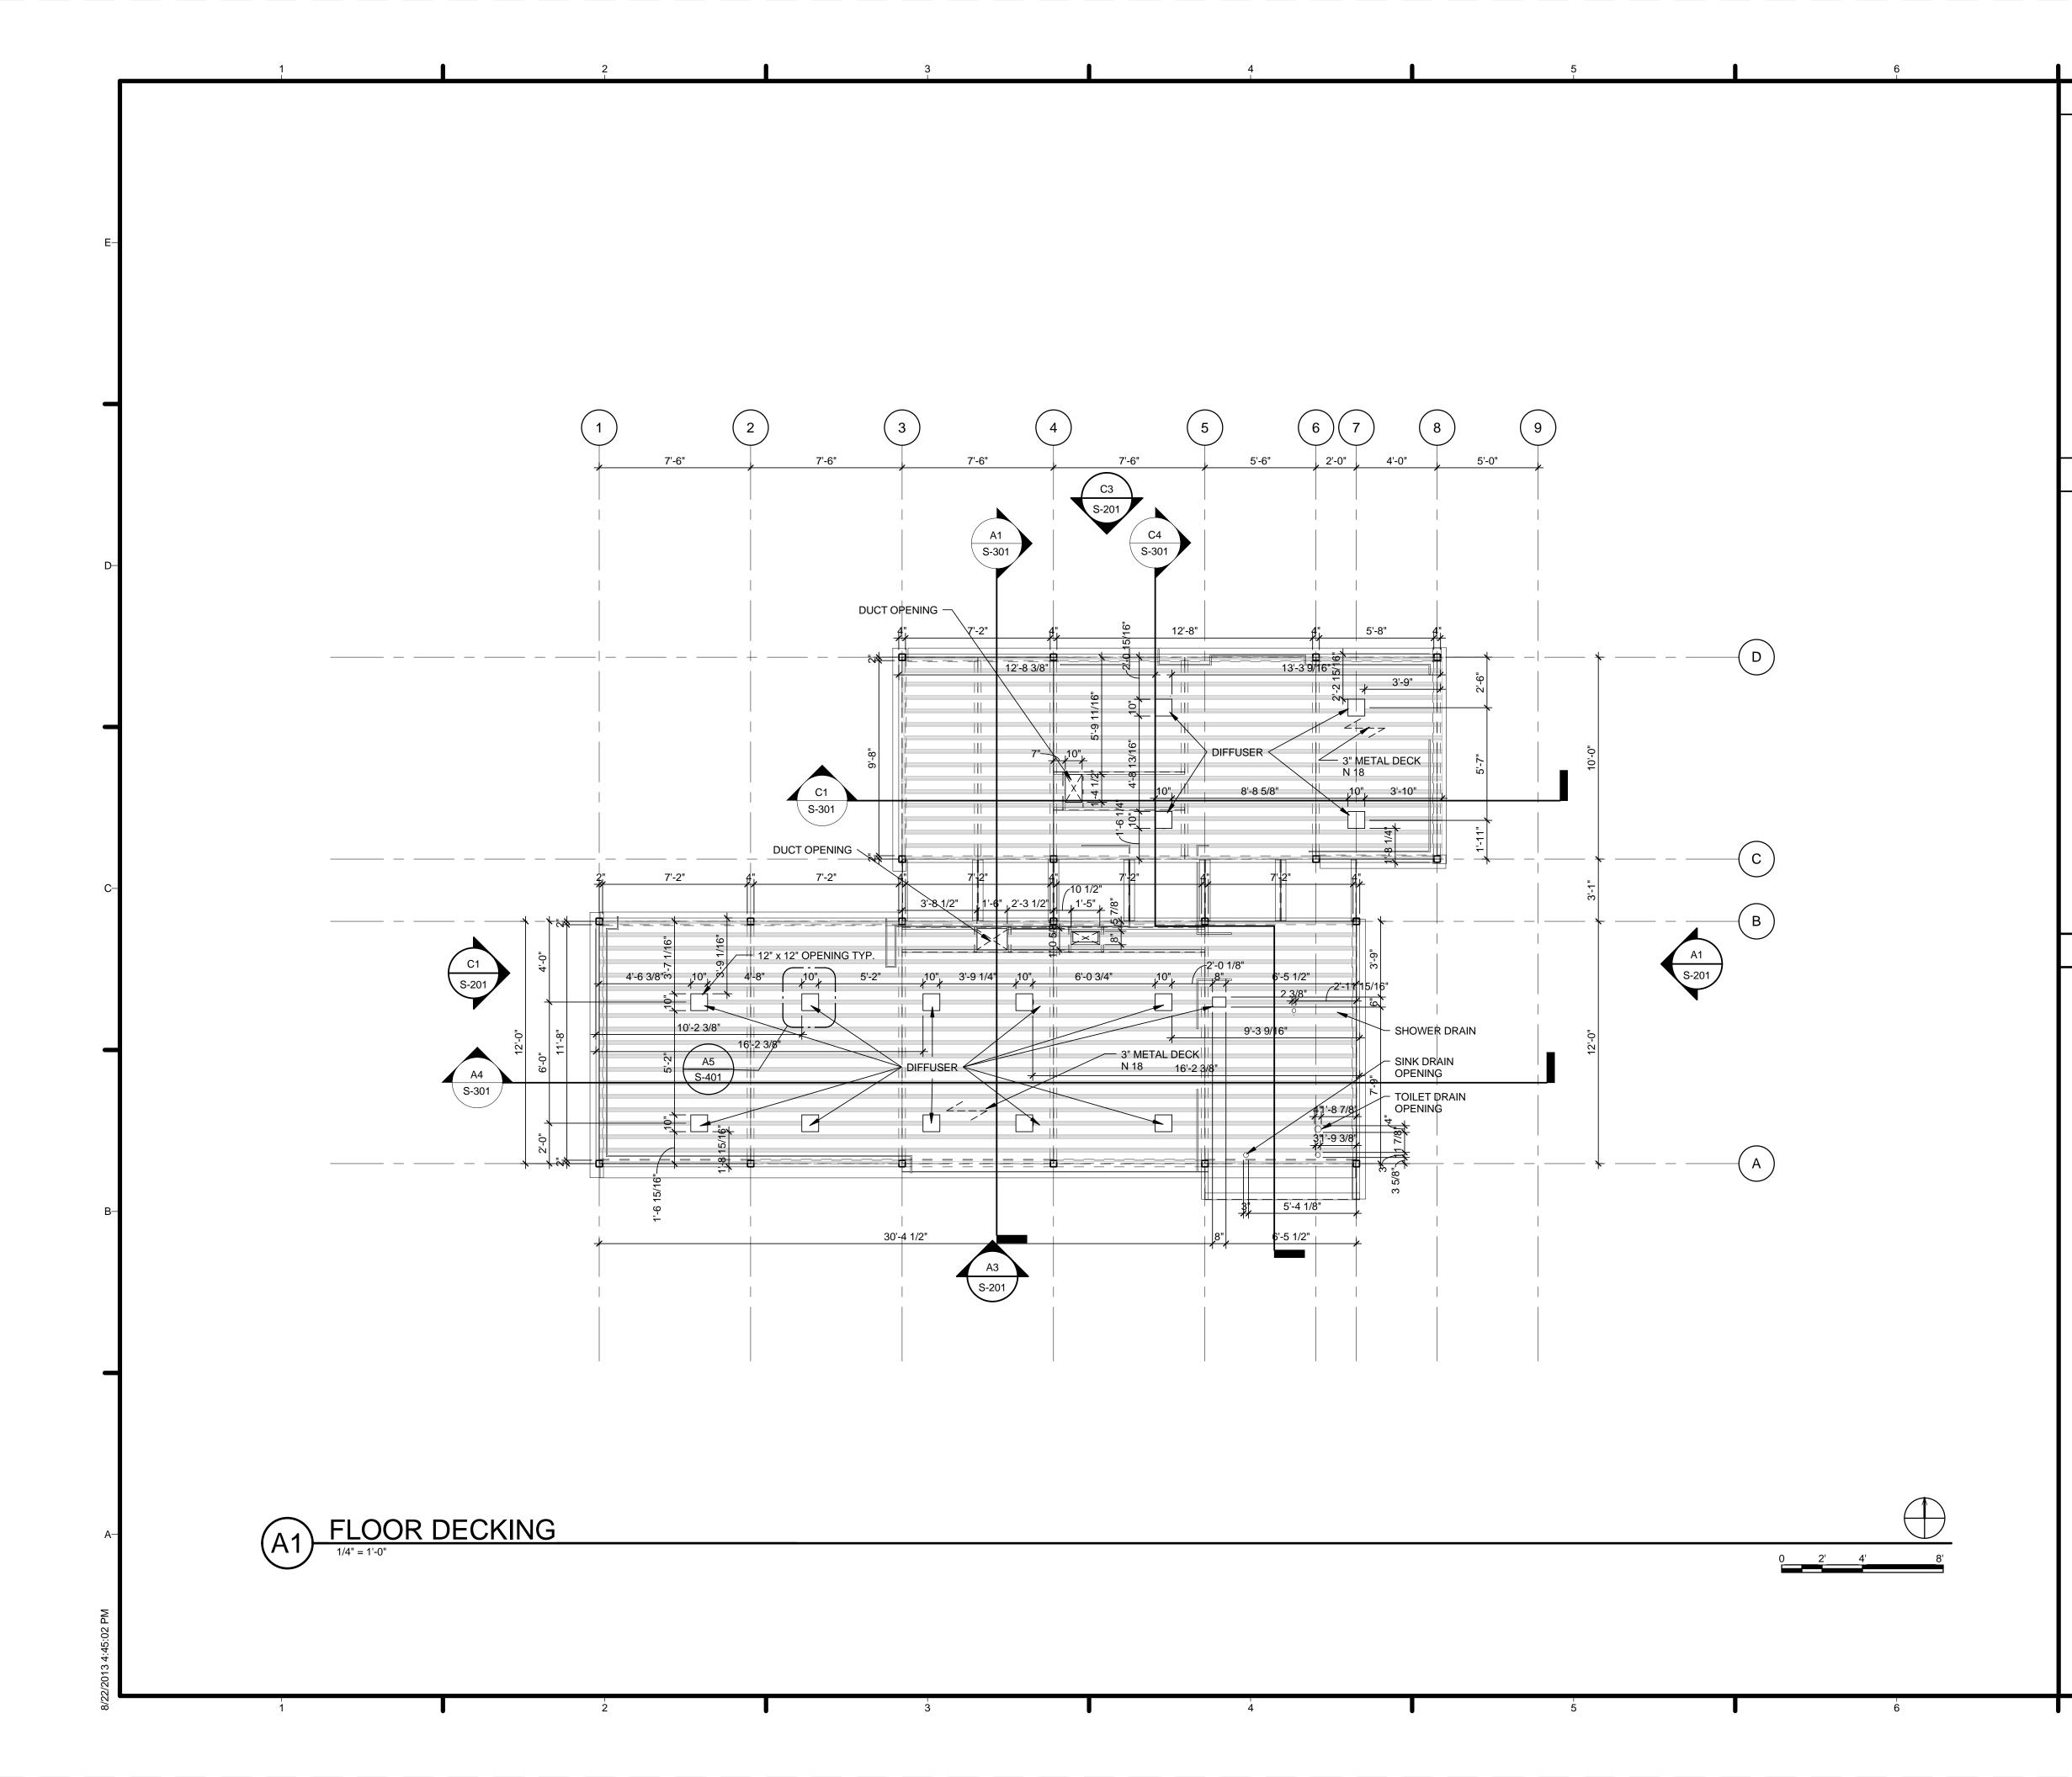


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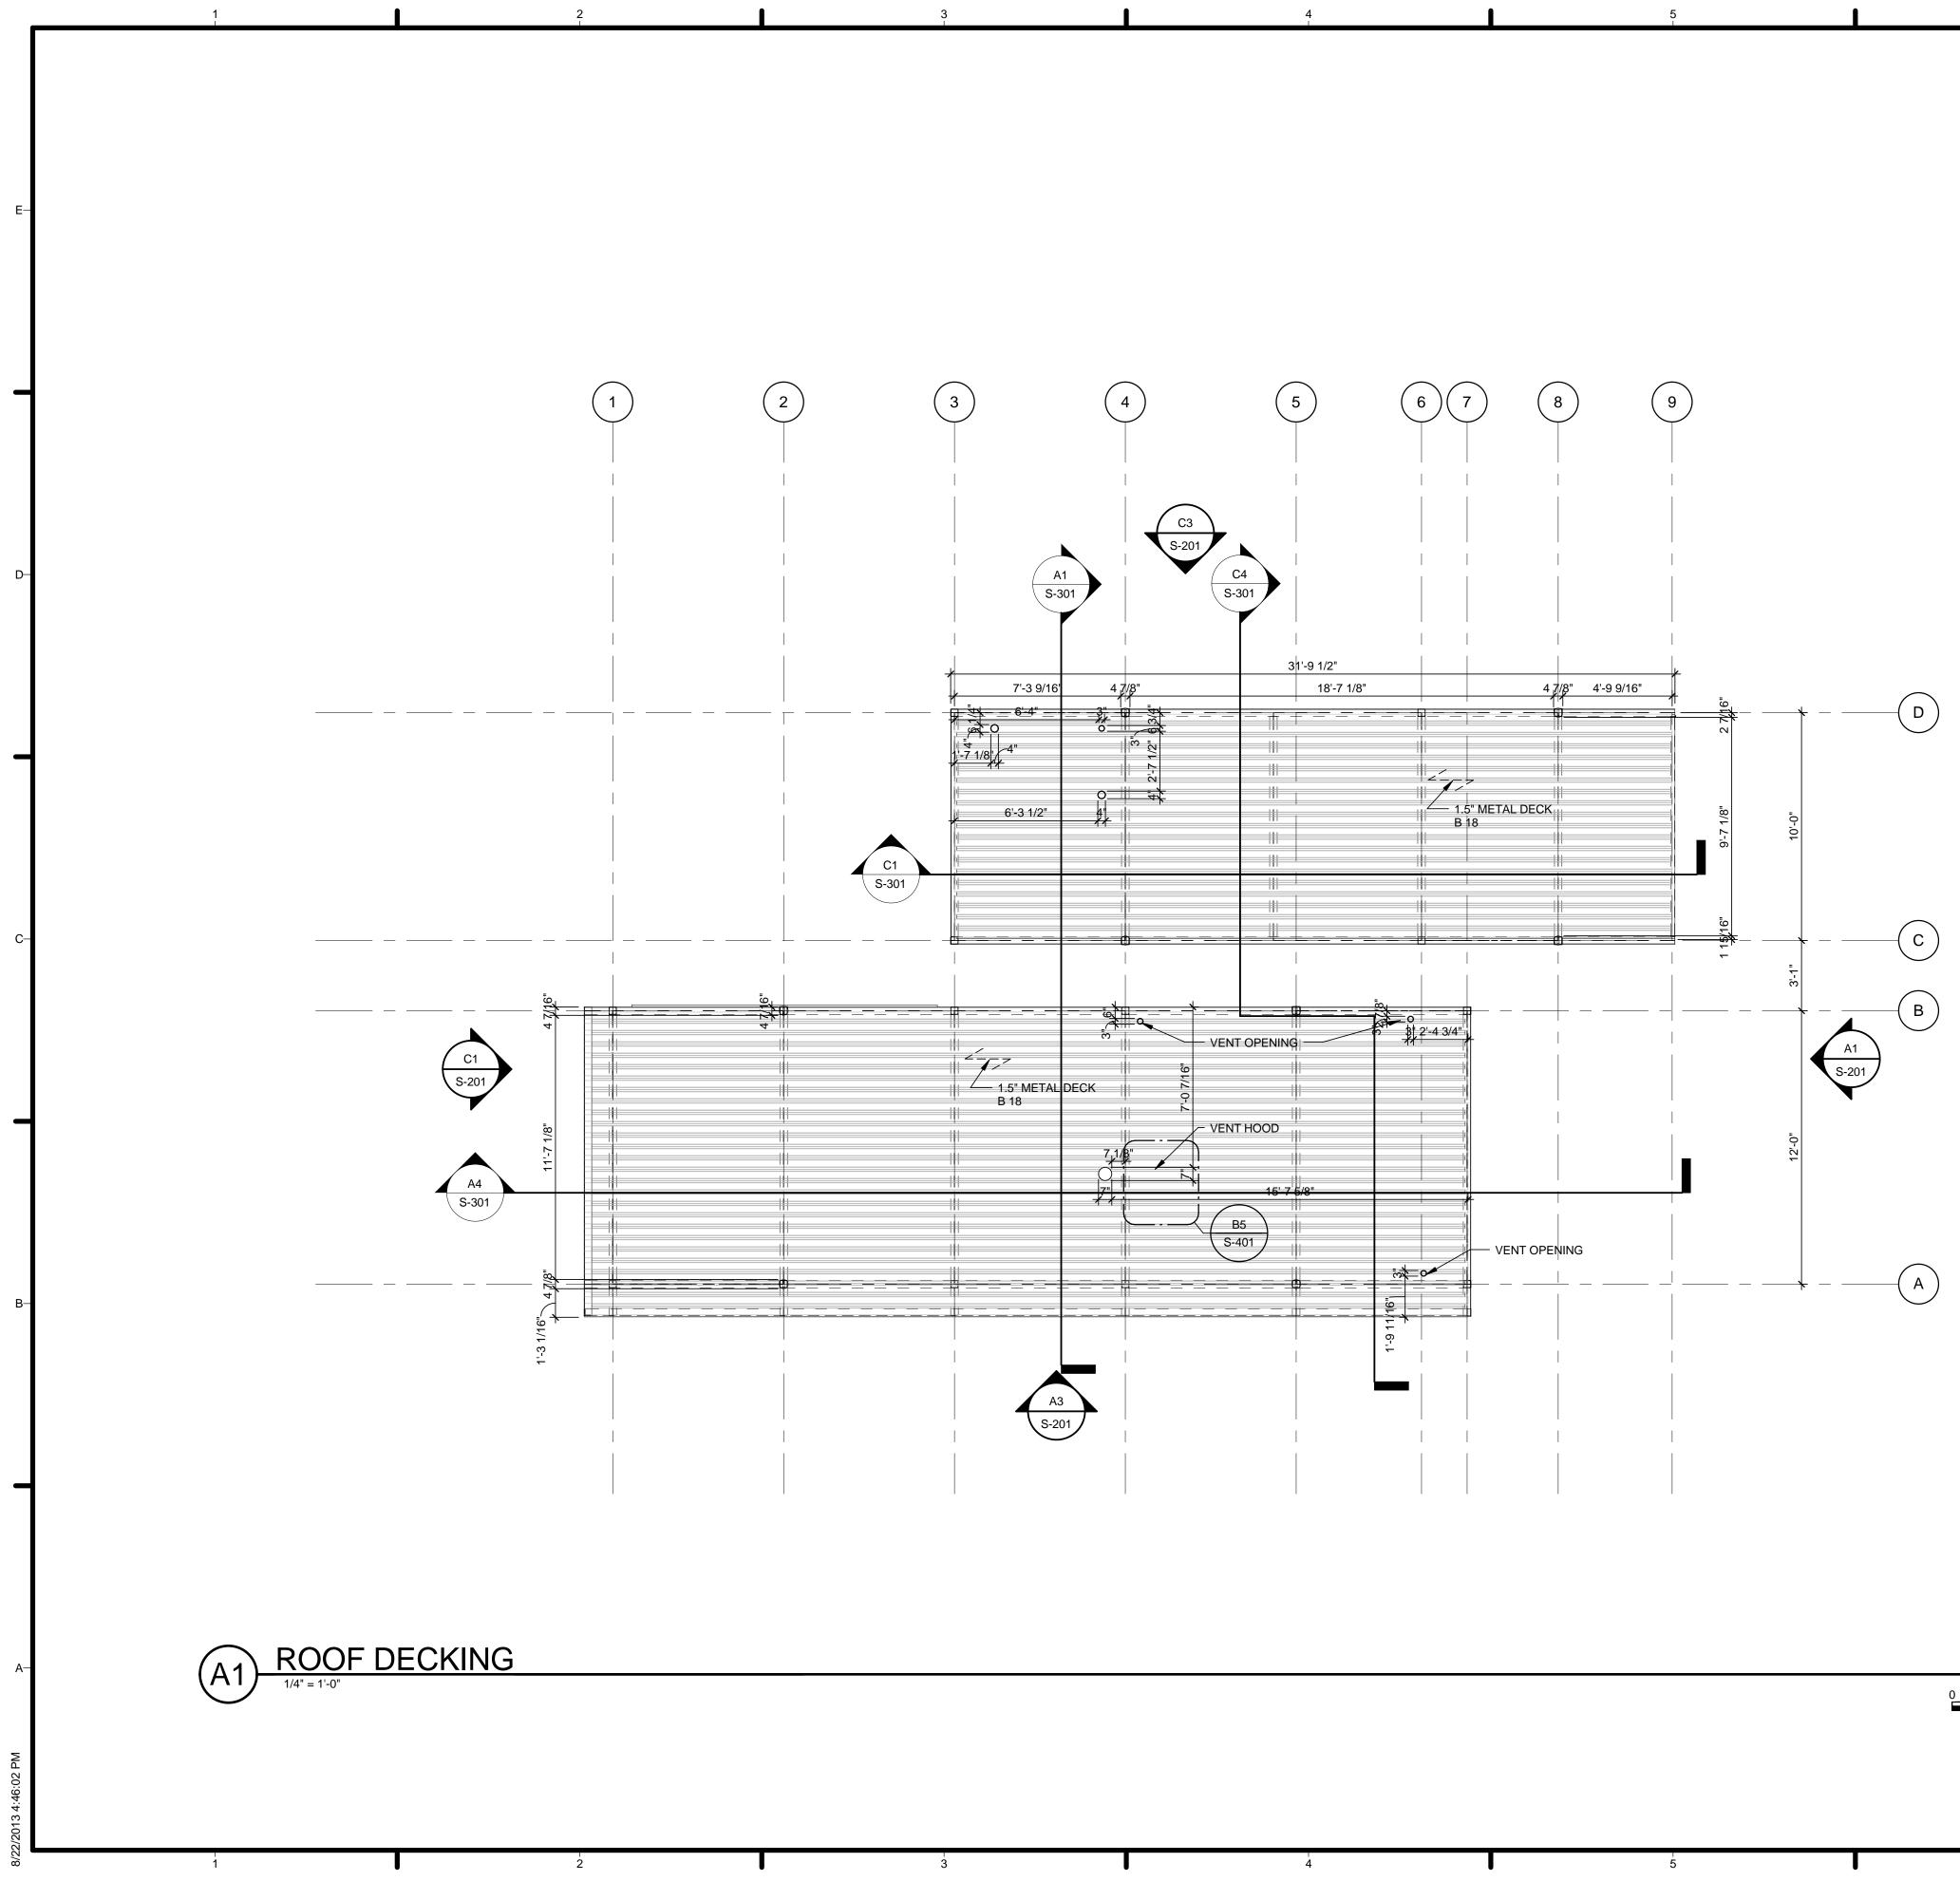




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REFERENCE KEYNOTES	TEAM NAME: Team Capitol dc ADDRESS: THE CATHOLIC UNIVERSITY OF AMERICA SCHOOL OF ARCHITECTURE 620 MICHIGAN AVENUE, NE. WASHINGTON, DC 20064 STRUCTURAL ENGINEER BOB ALLISON, PE ARUP ENGINEERING 1120 CONNECTICUT
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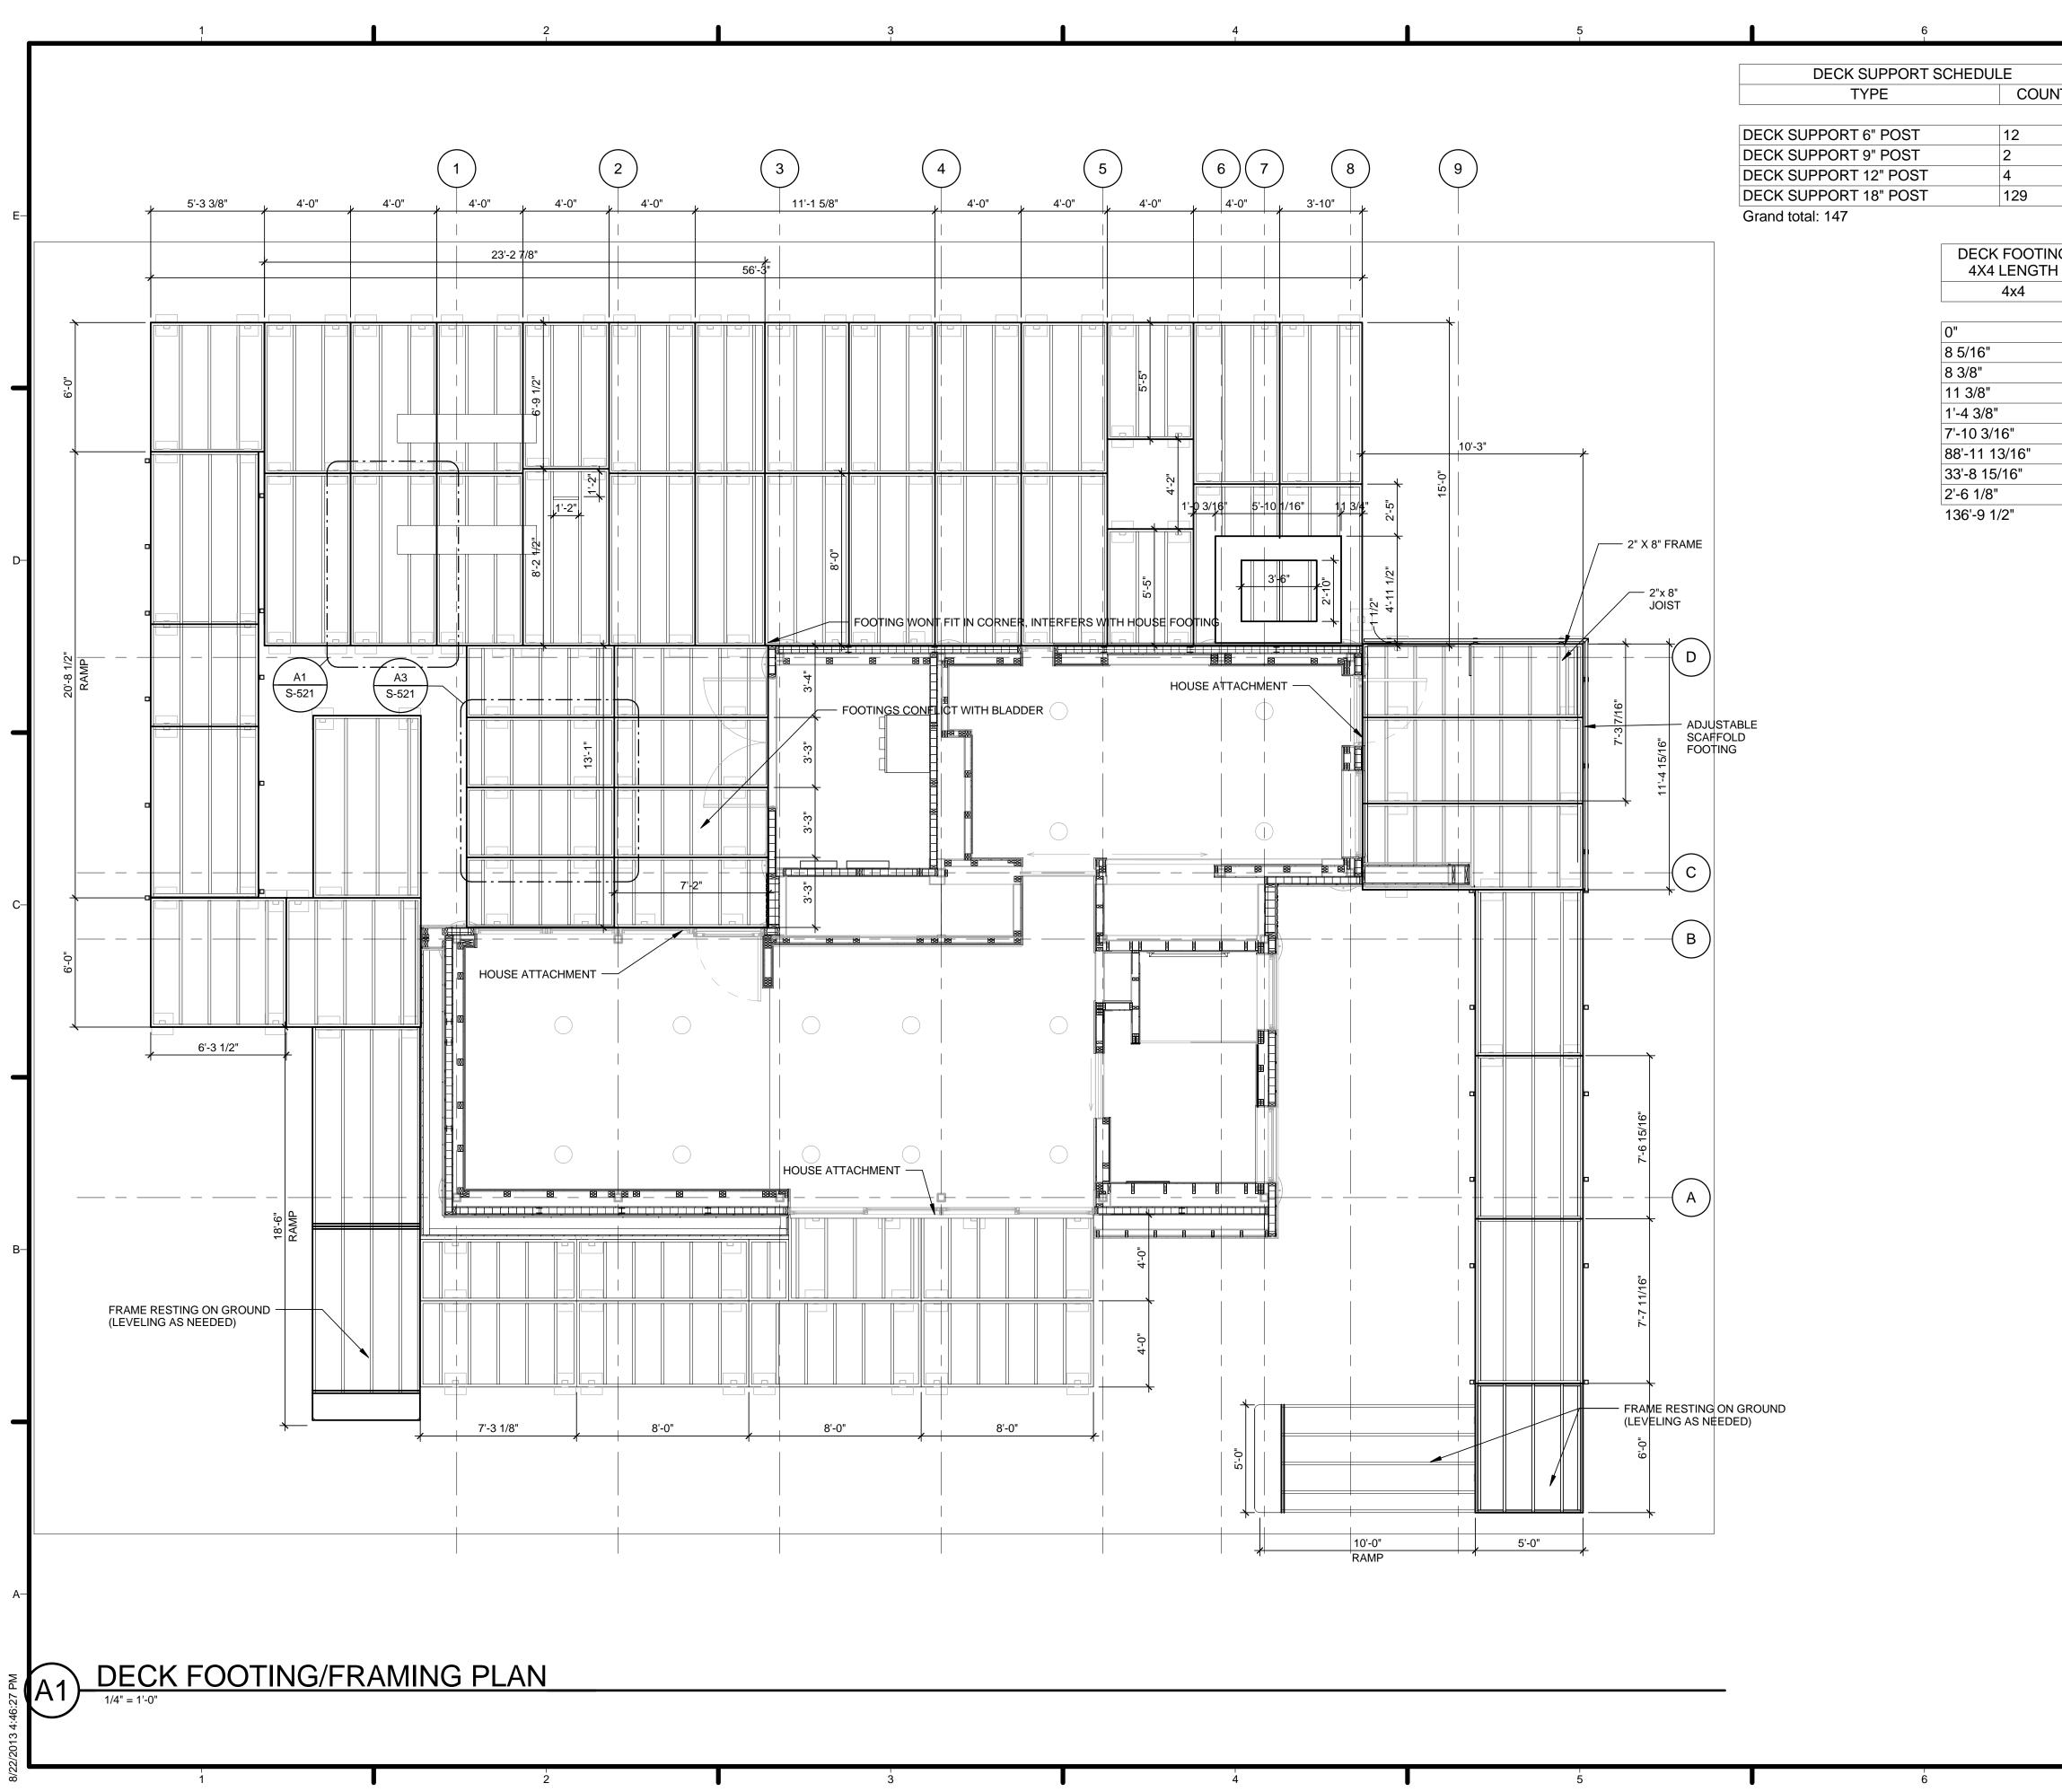
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REFERENCE KEYNOTES	STRUCTURAL ENGINEER
	BOB ALLISON, PE ARUP ENGINEERING 1120 CONNECTICUT AVENUE, NW., SUITE 200 WASHINGTON, DC 20036 TEL: 202.729.8220
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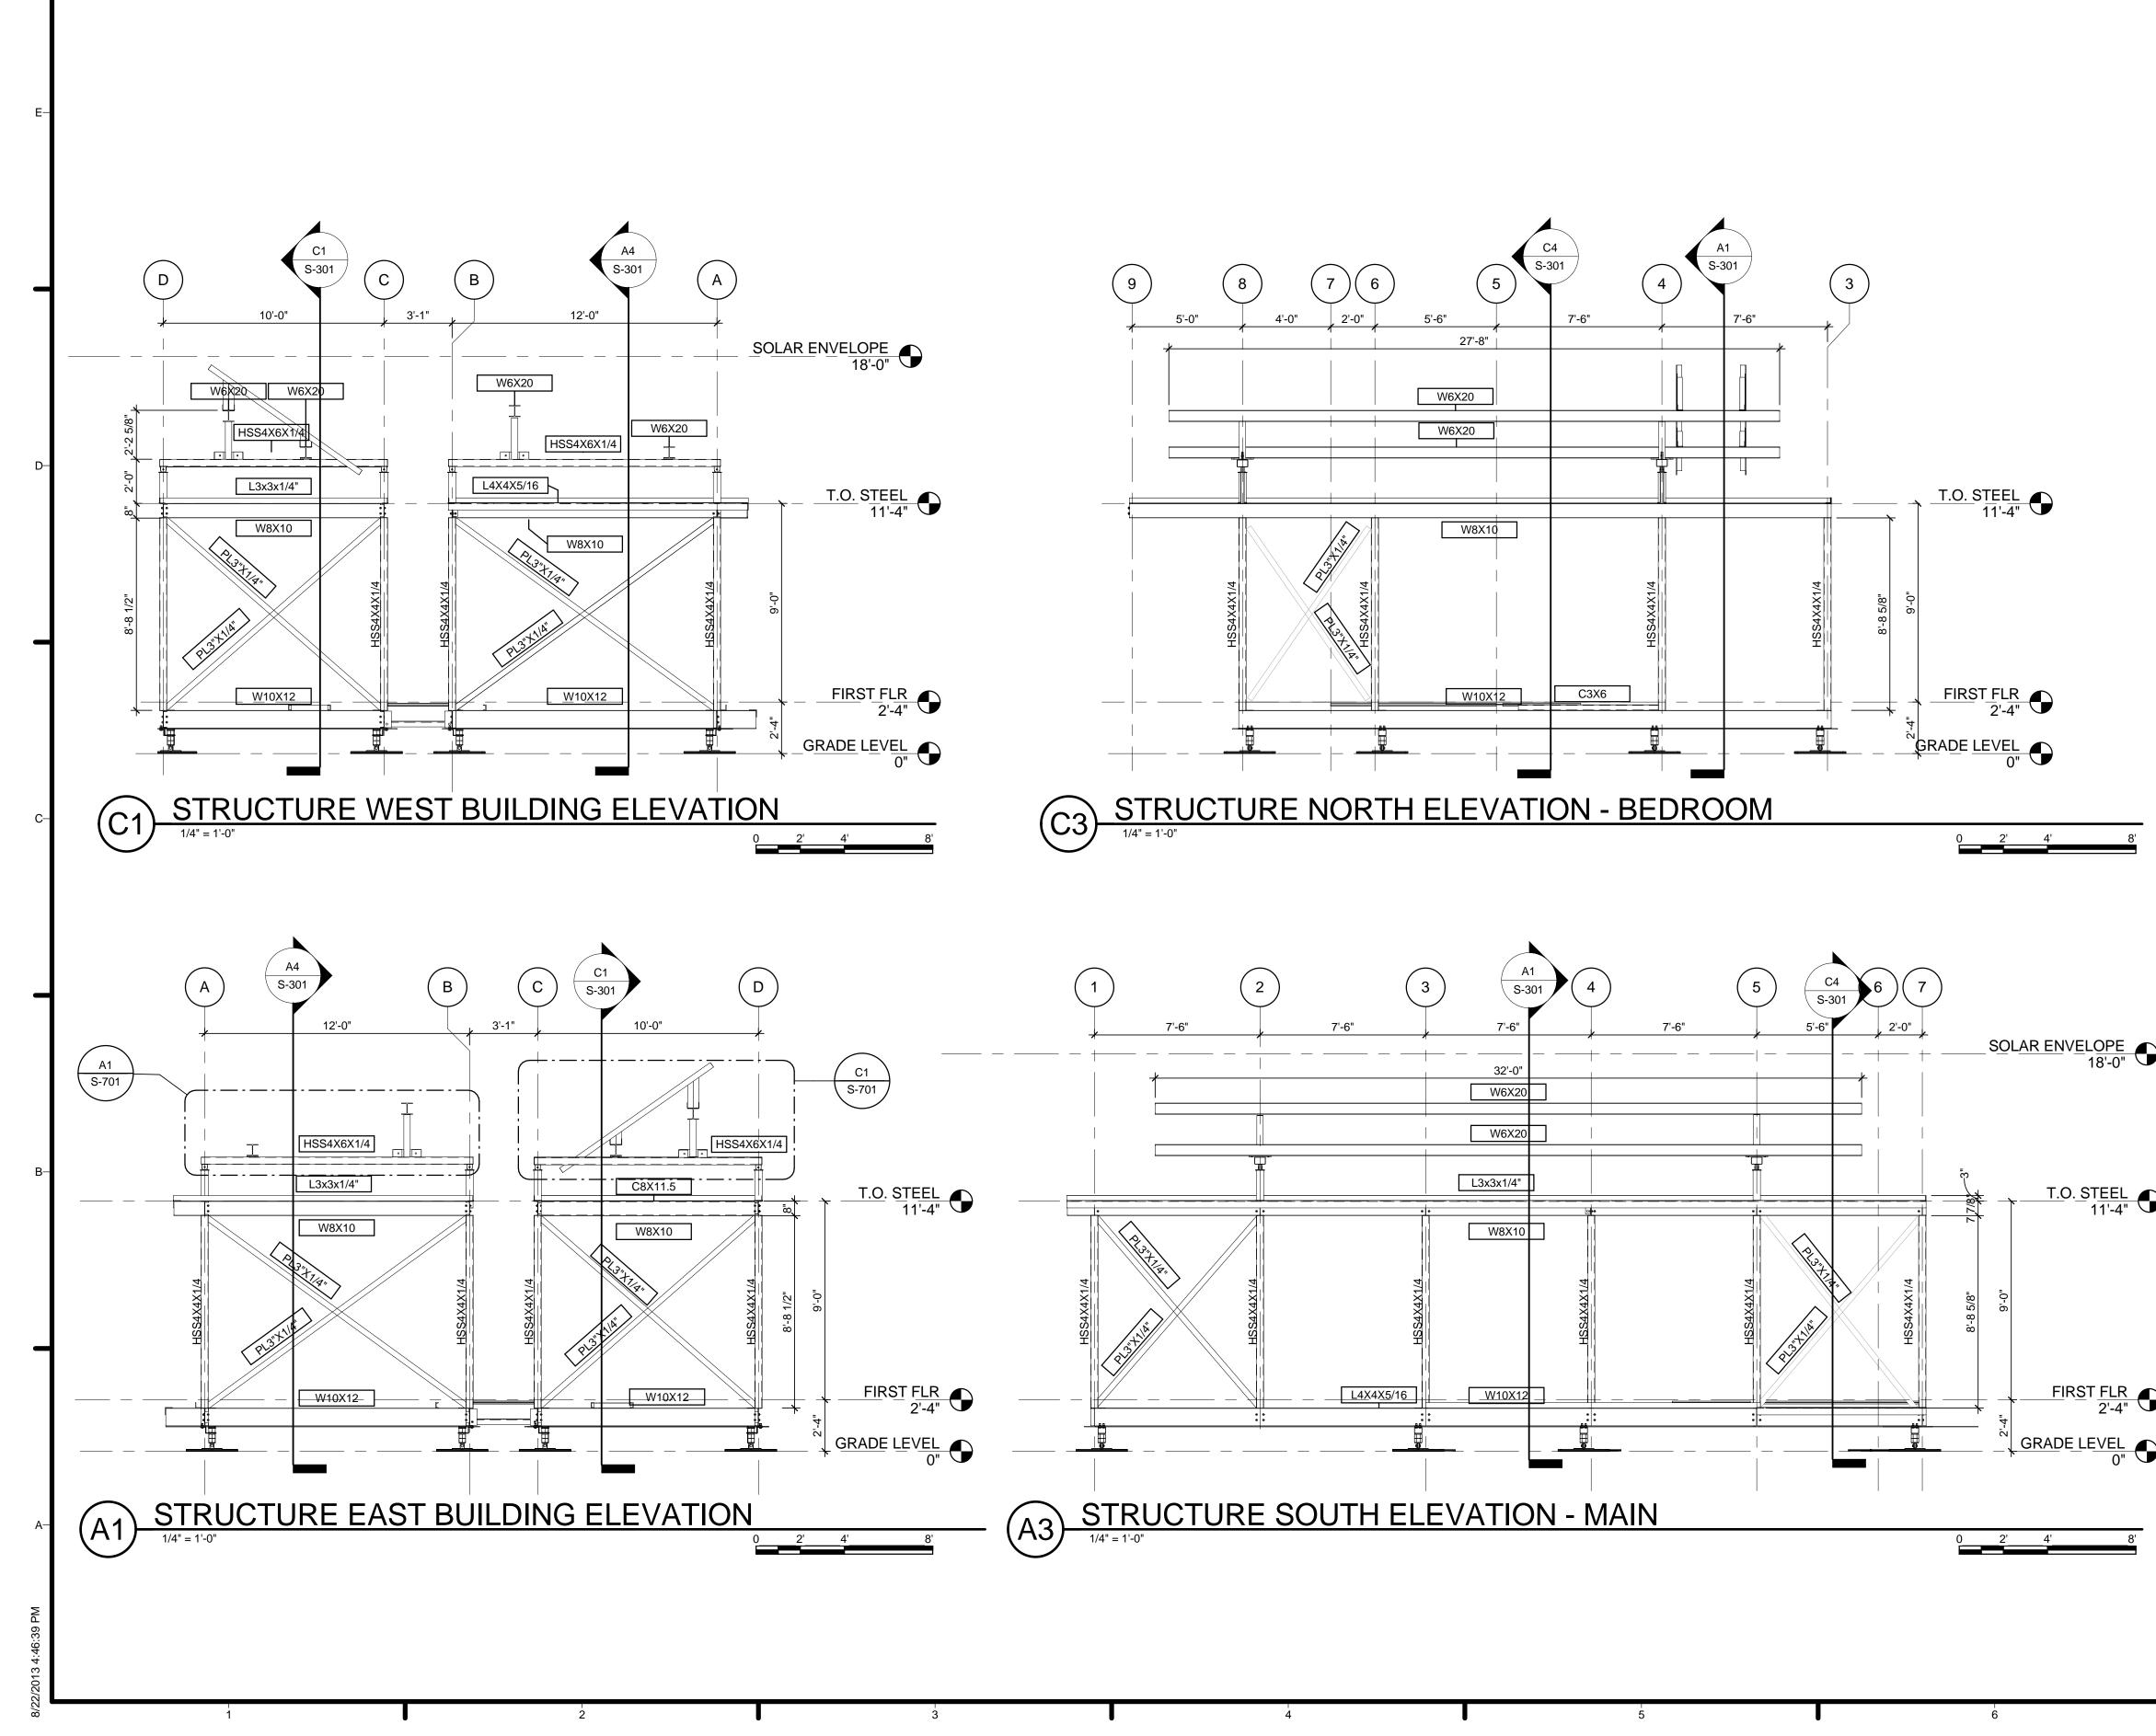
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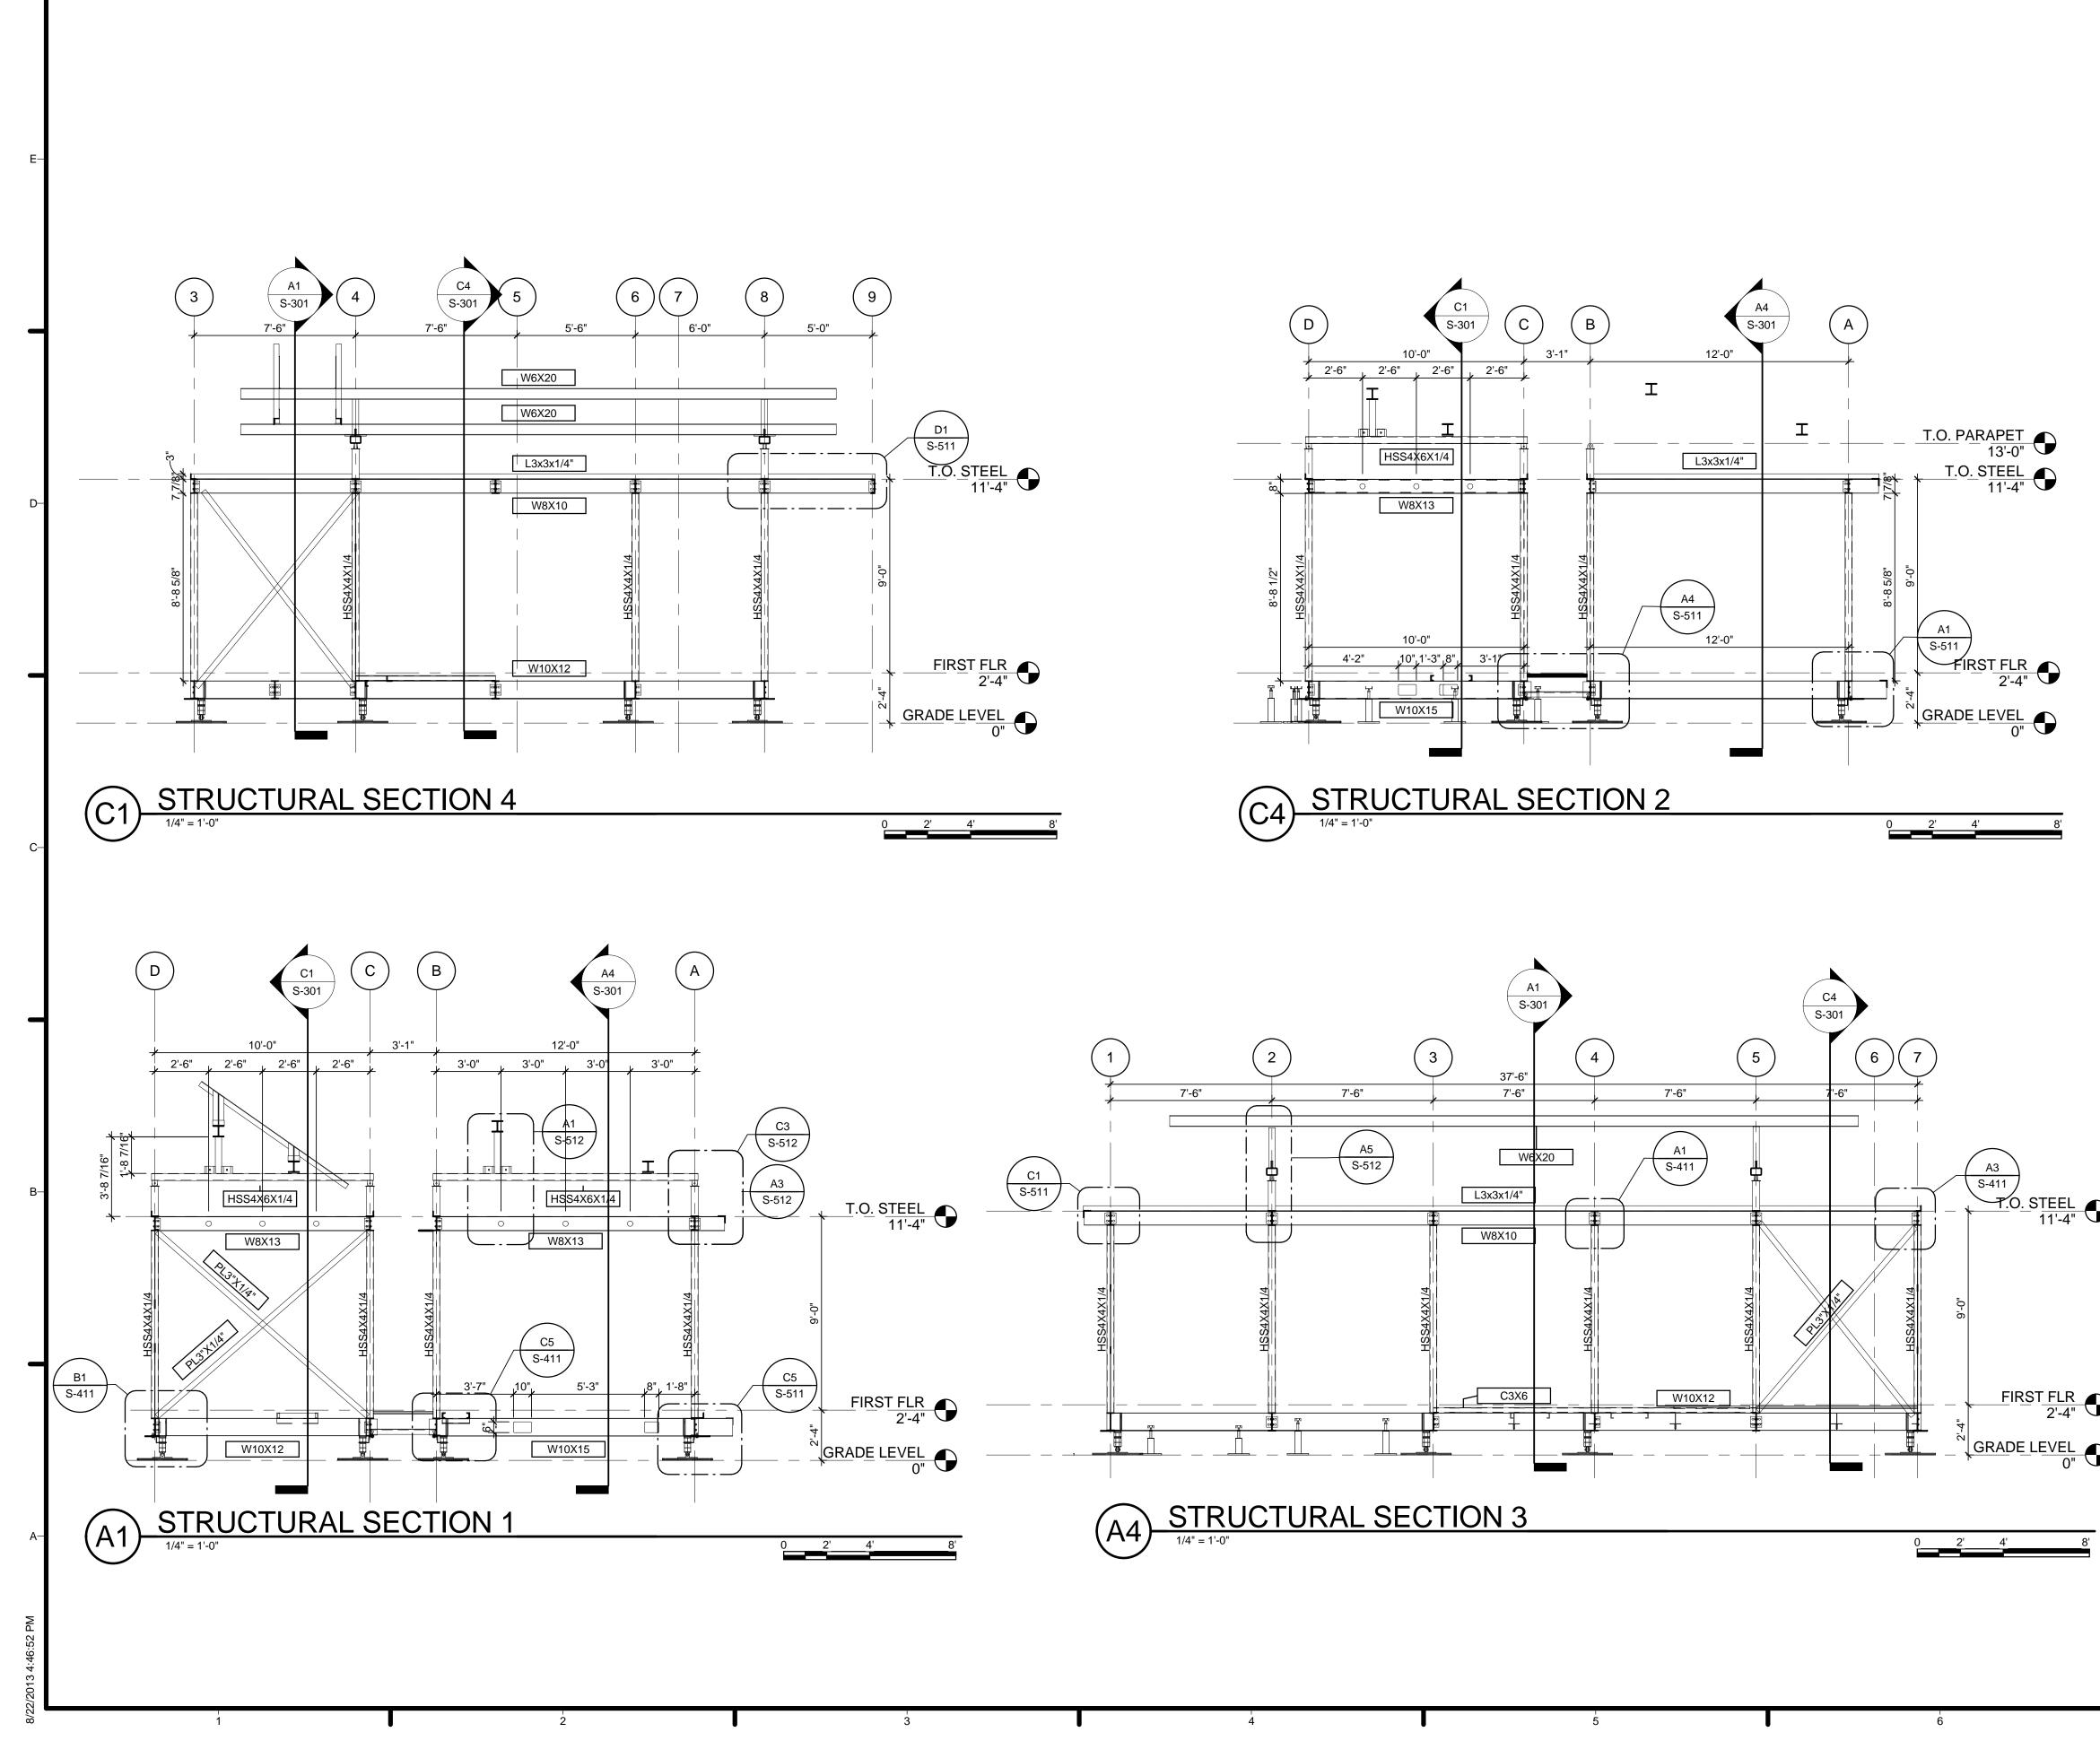
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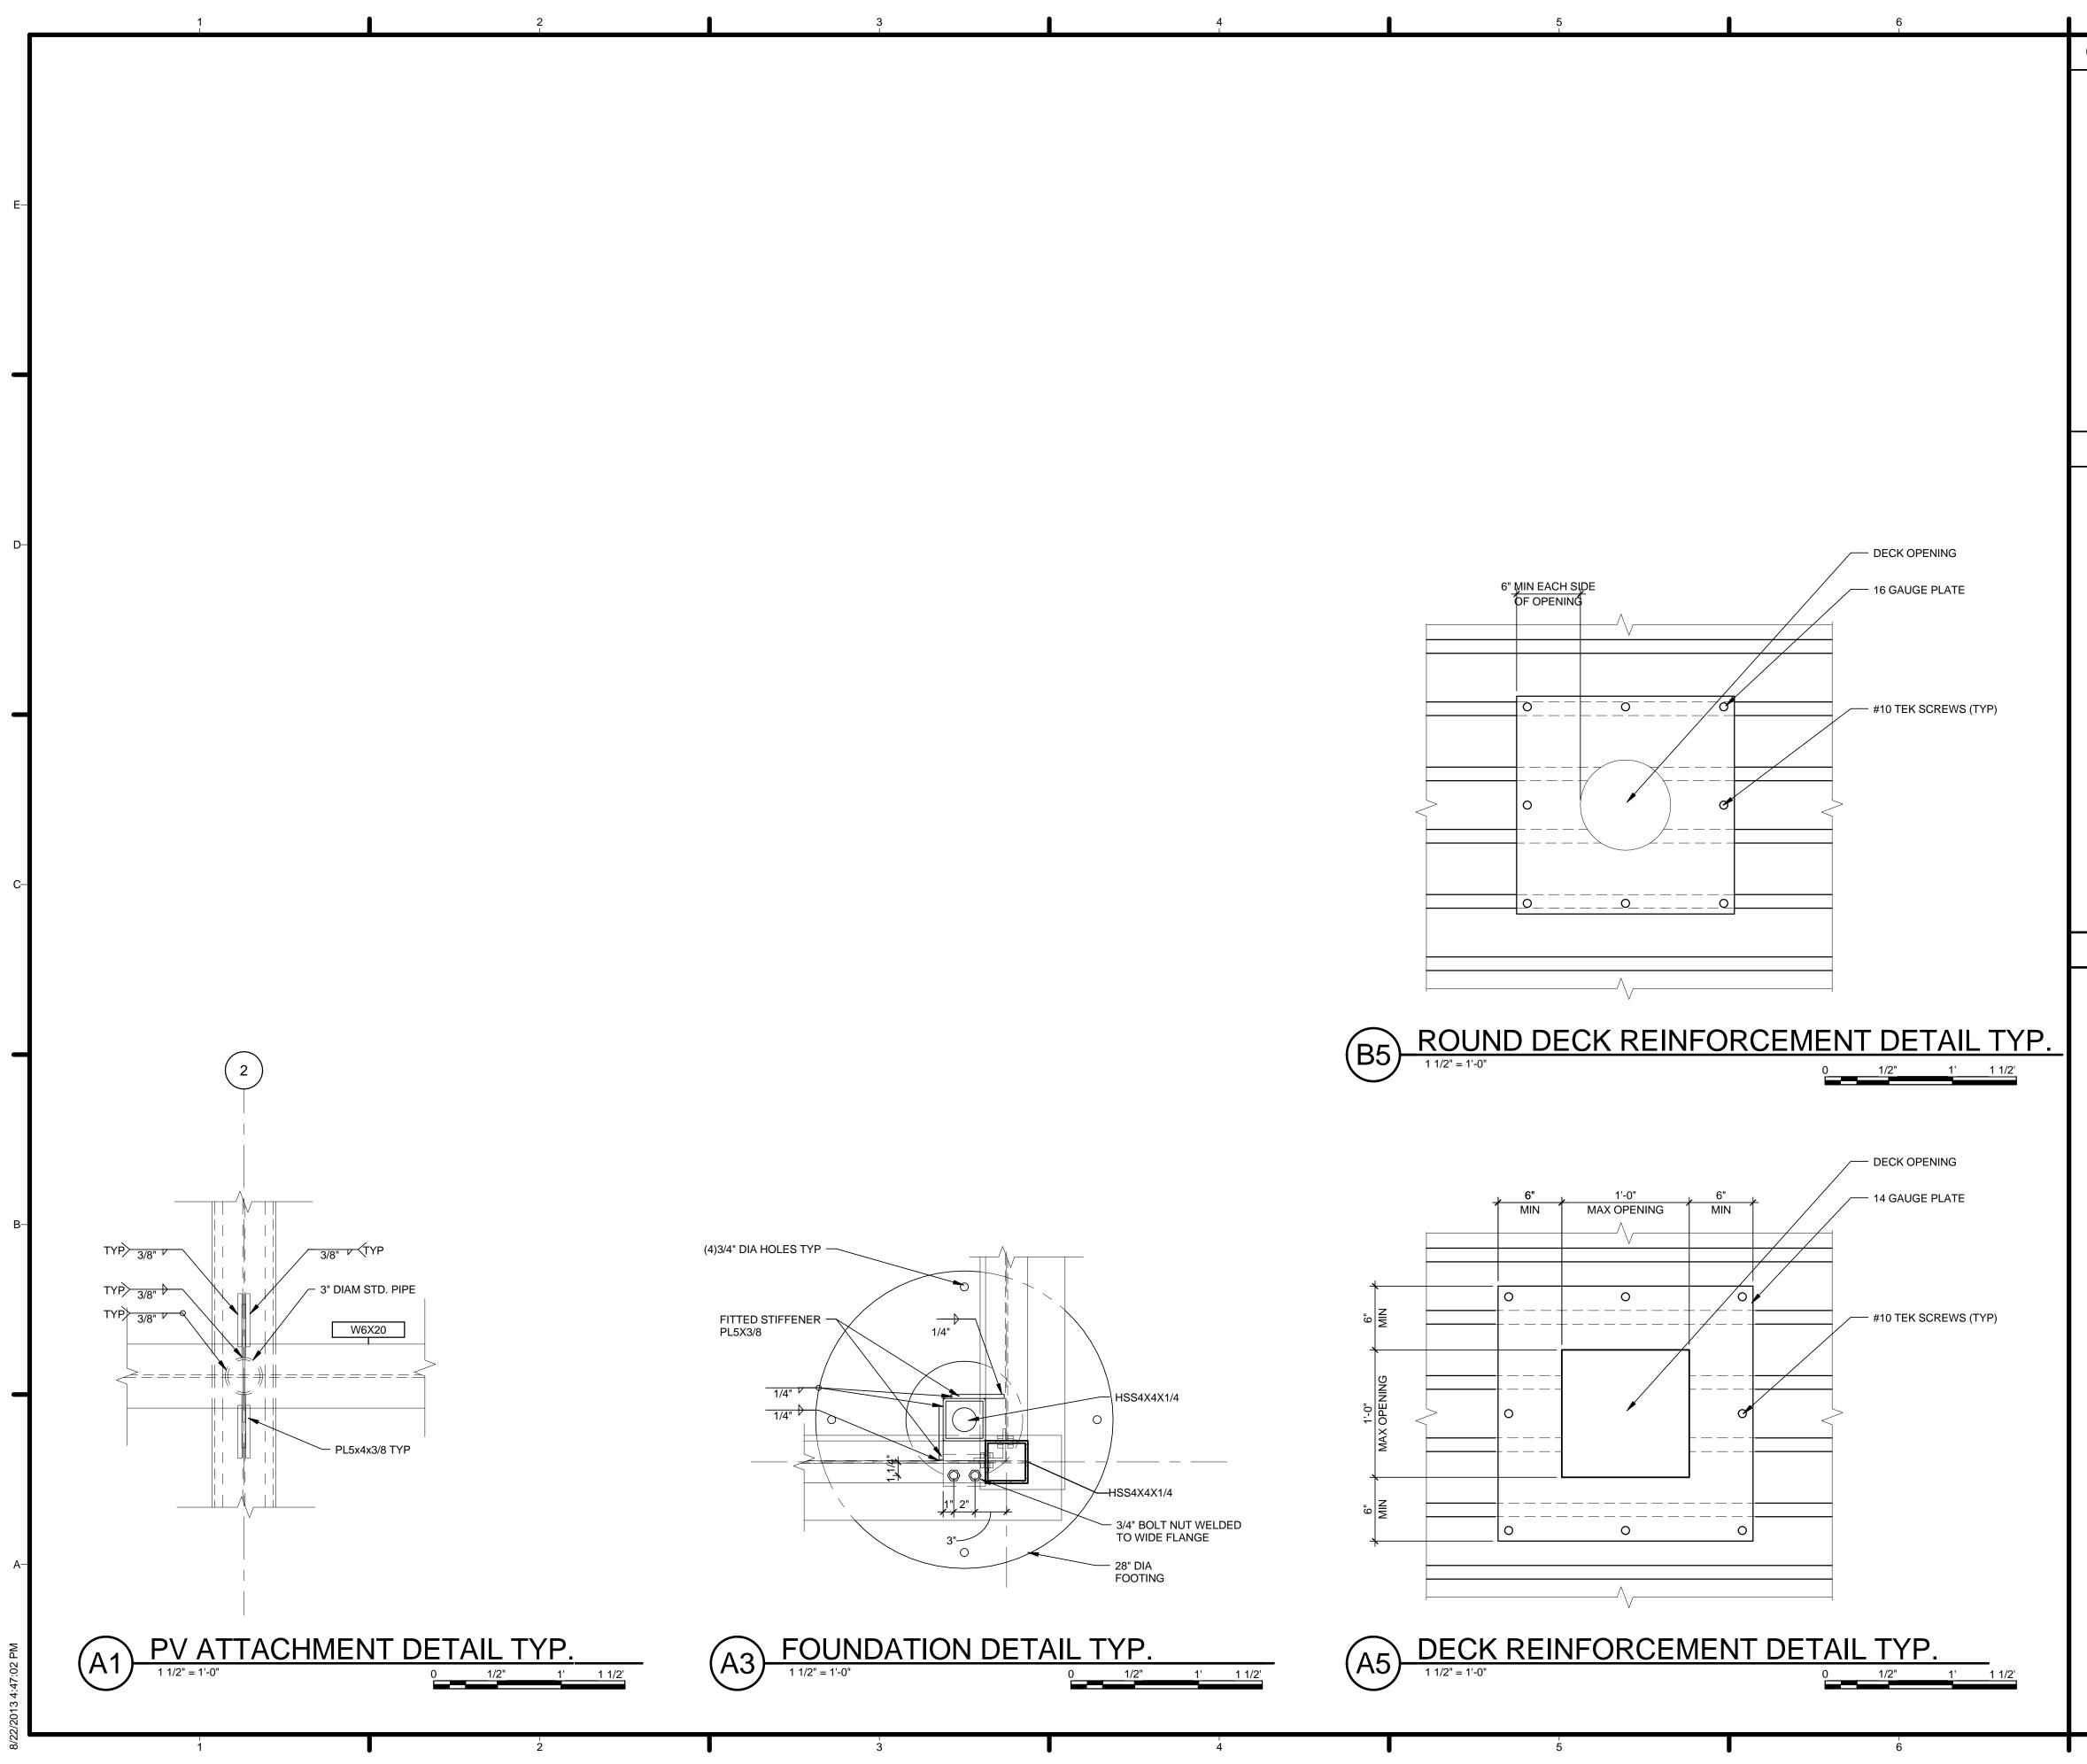


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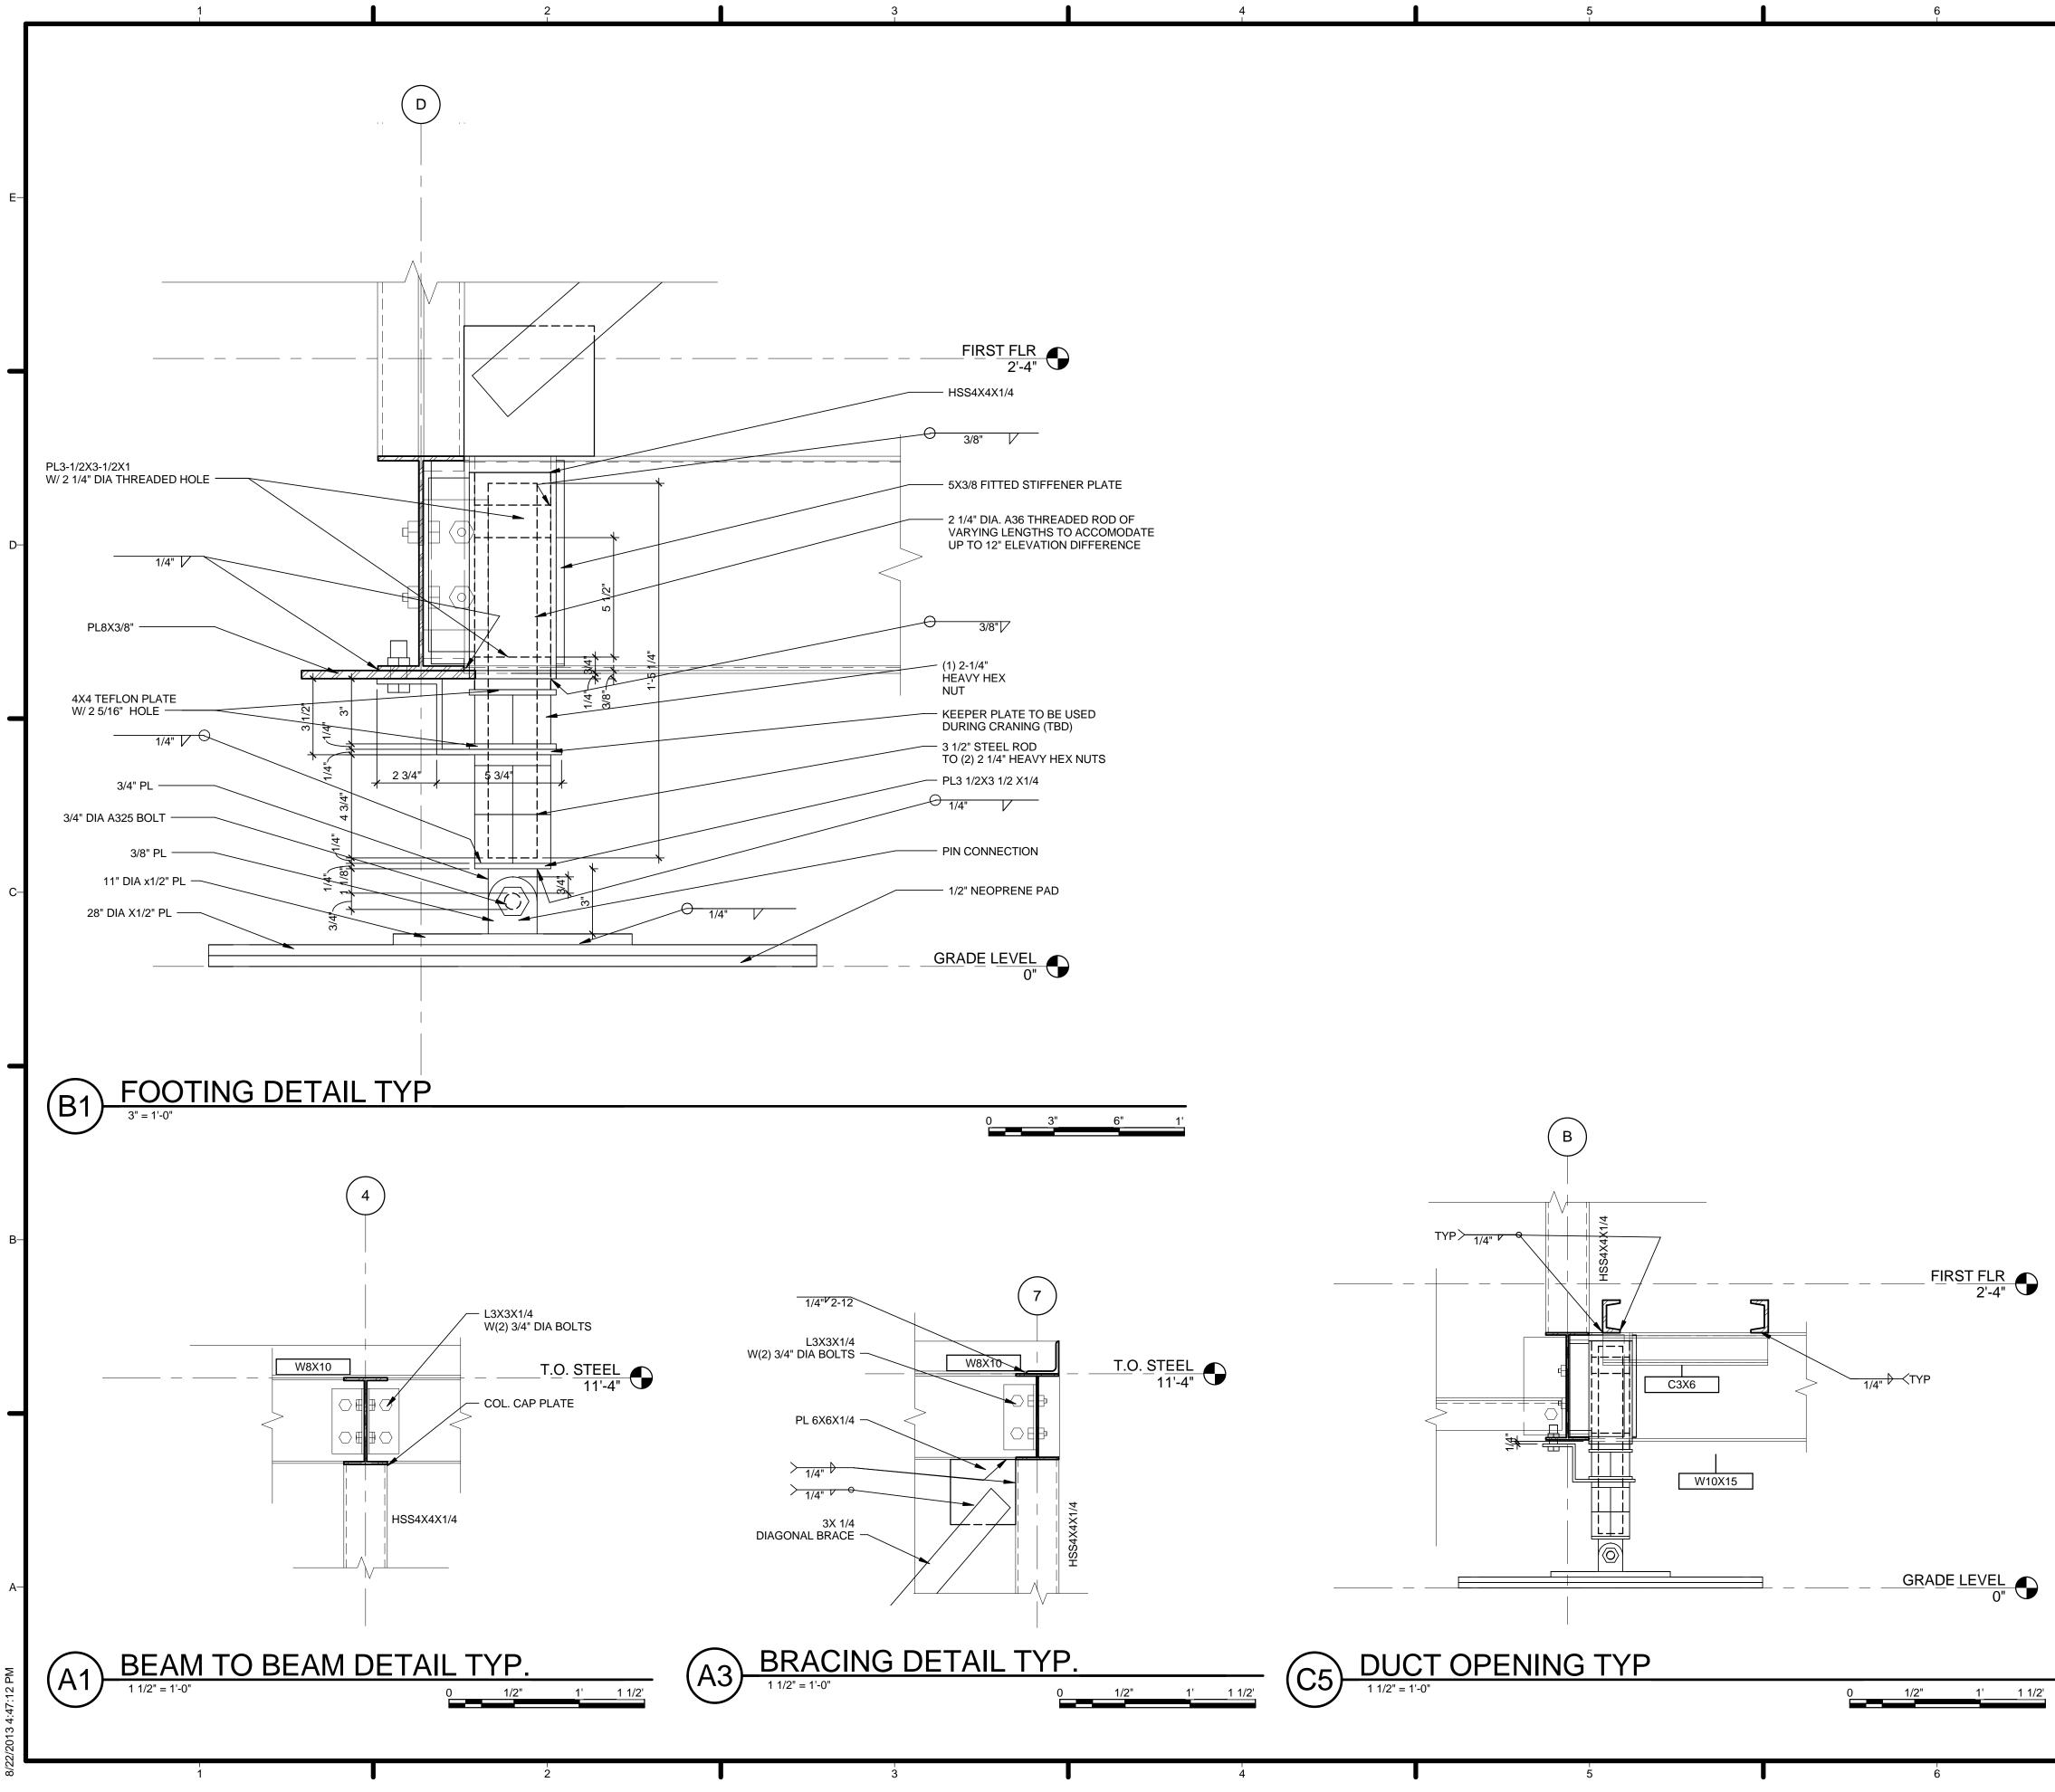


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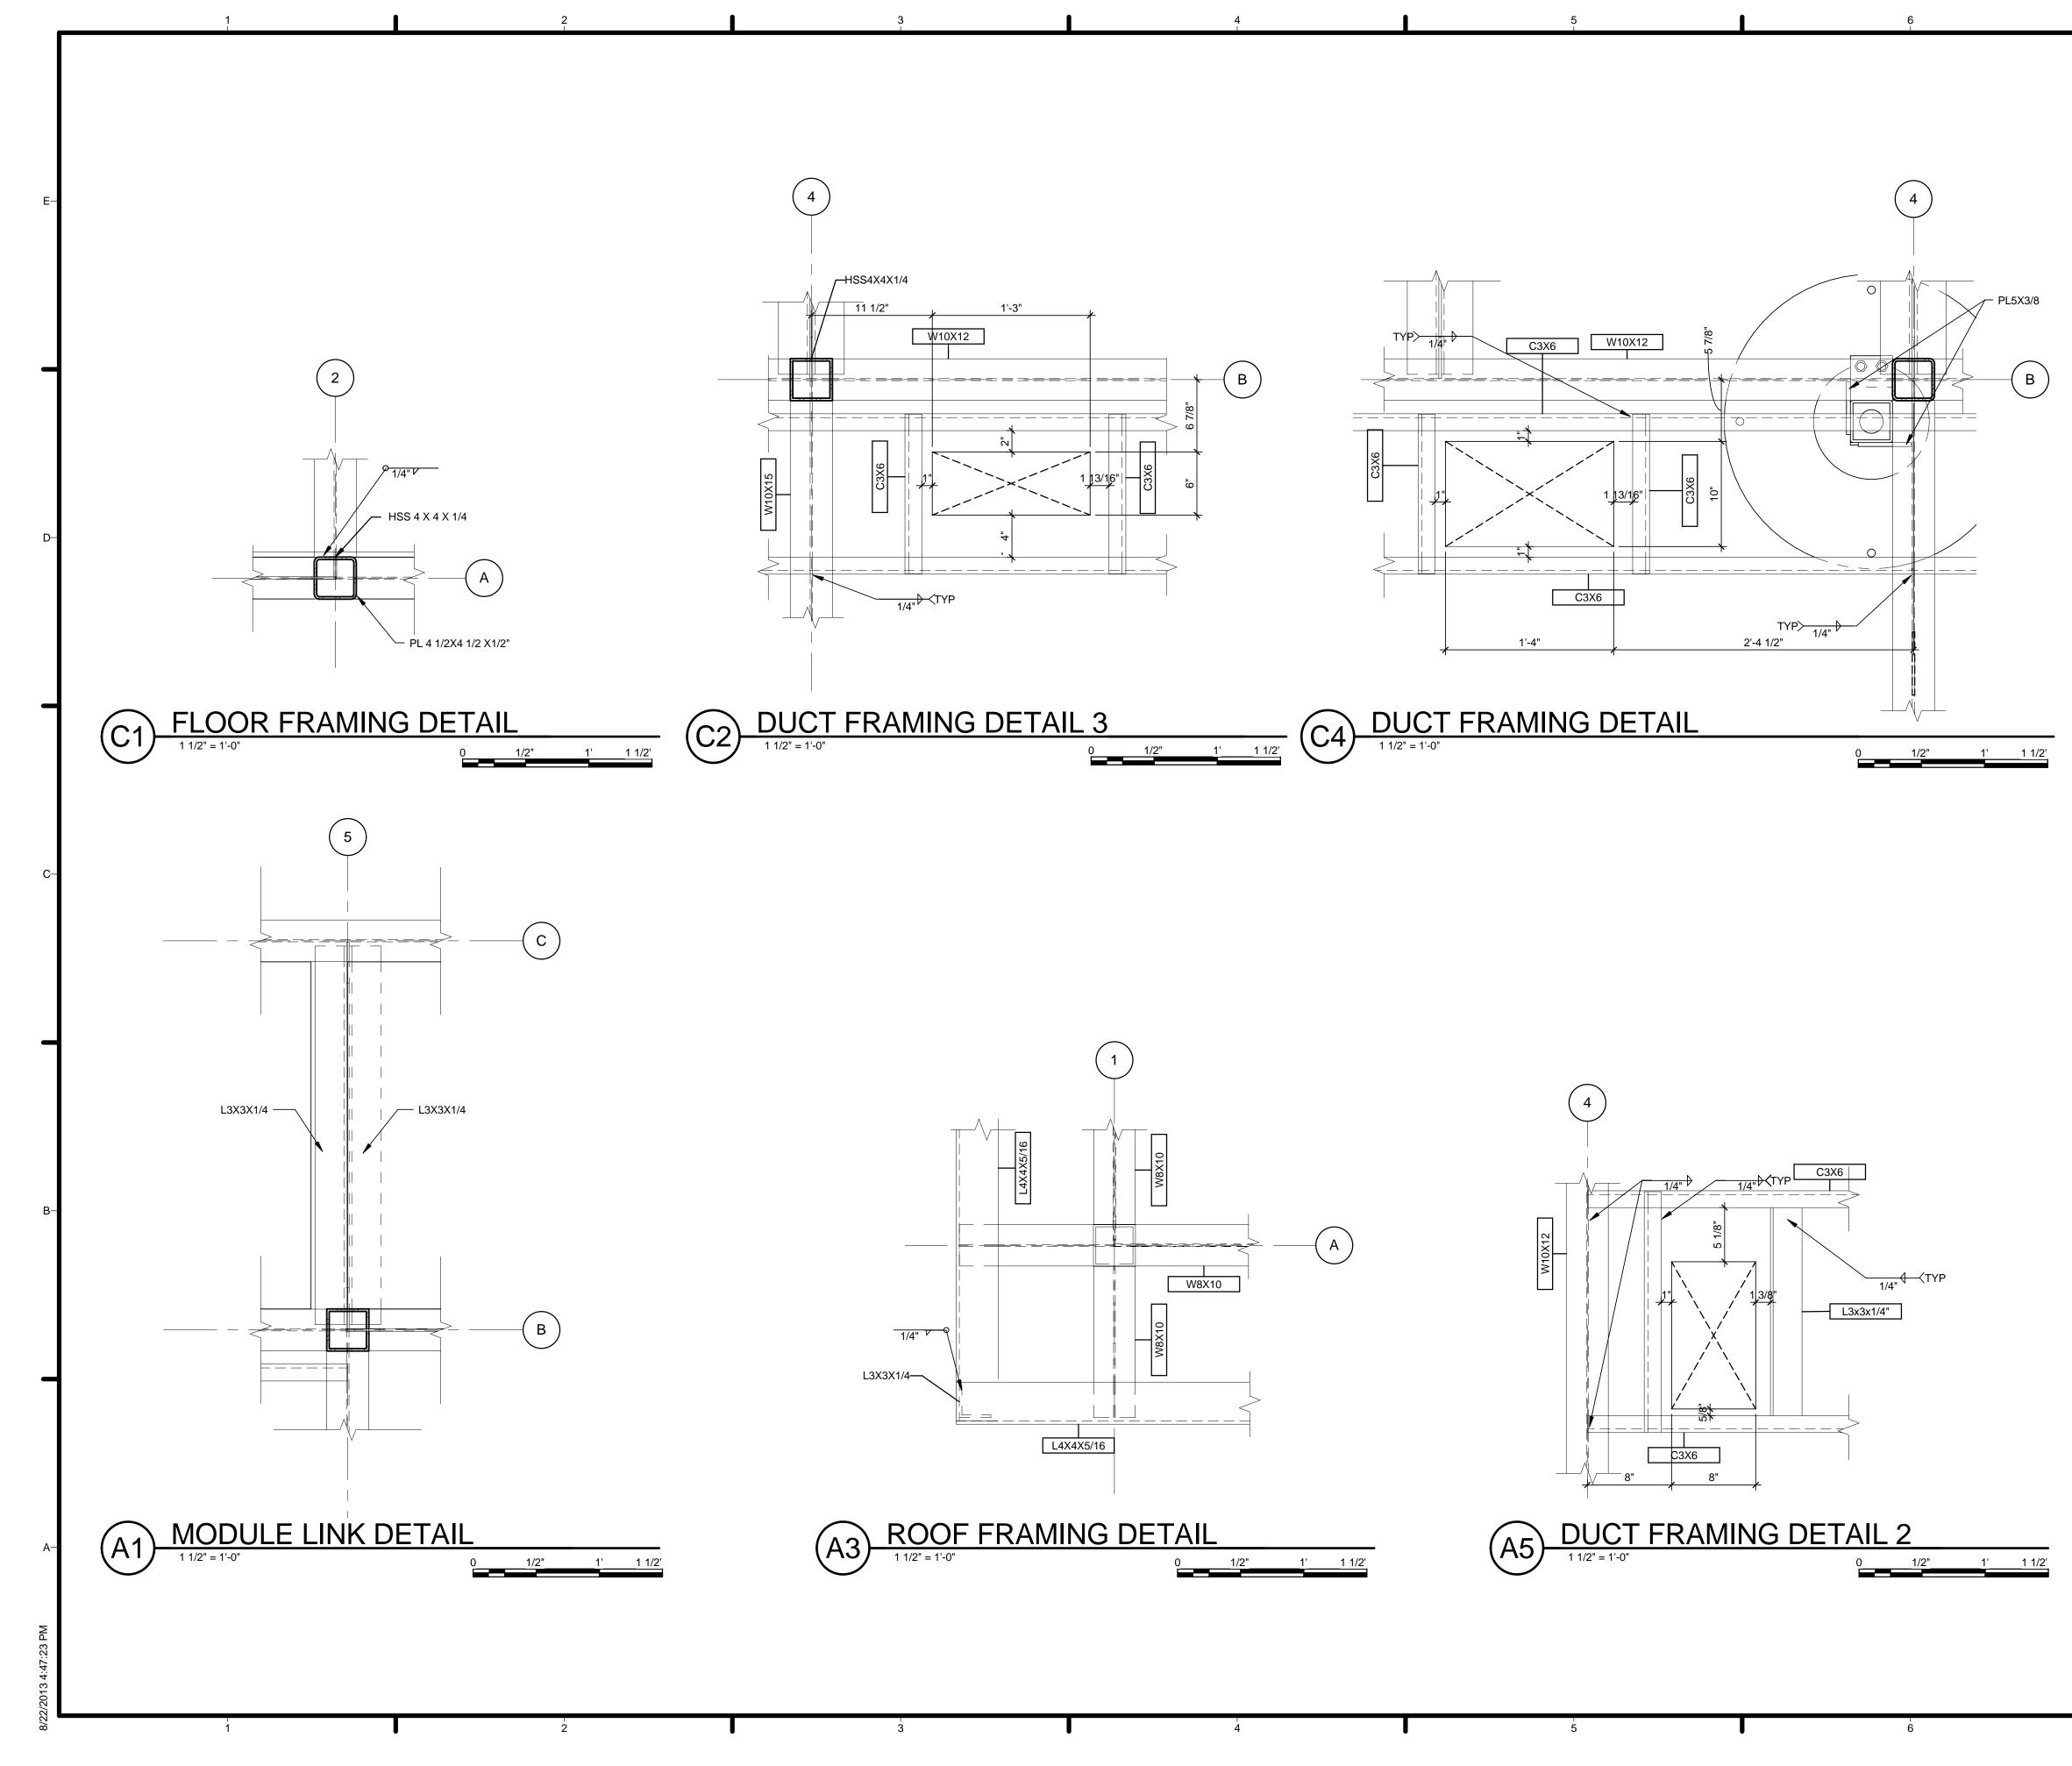
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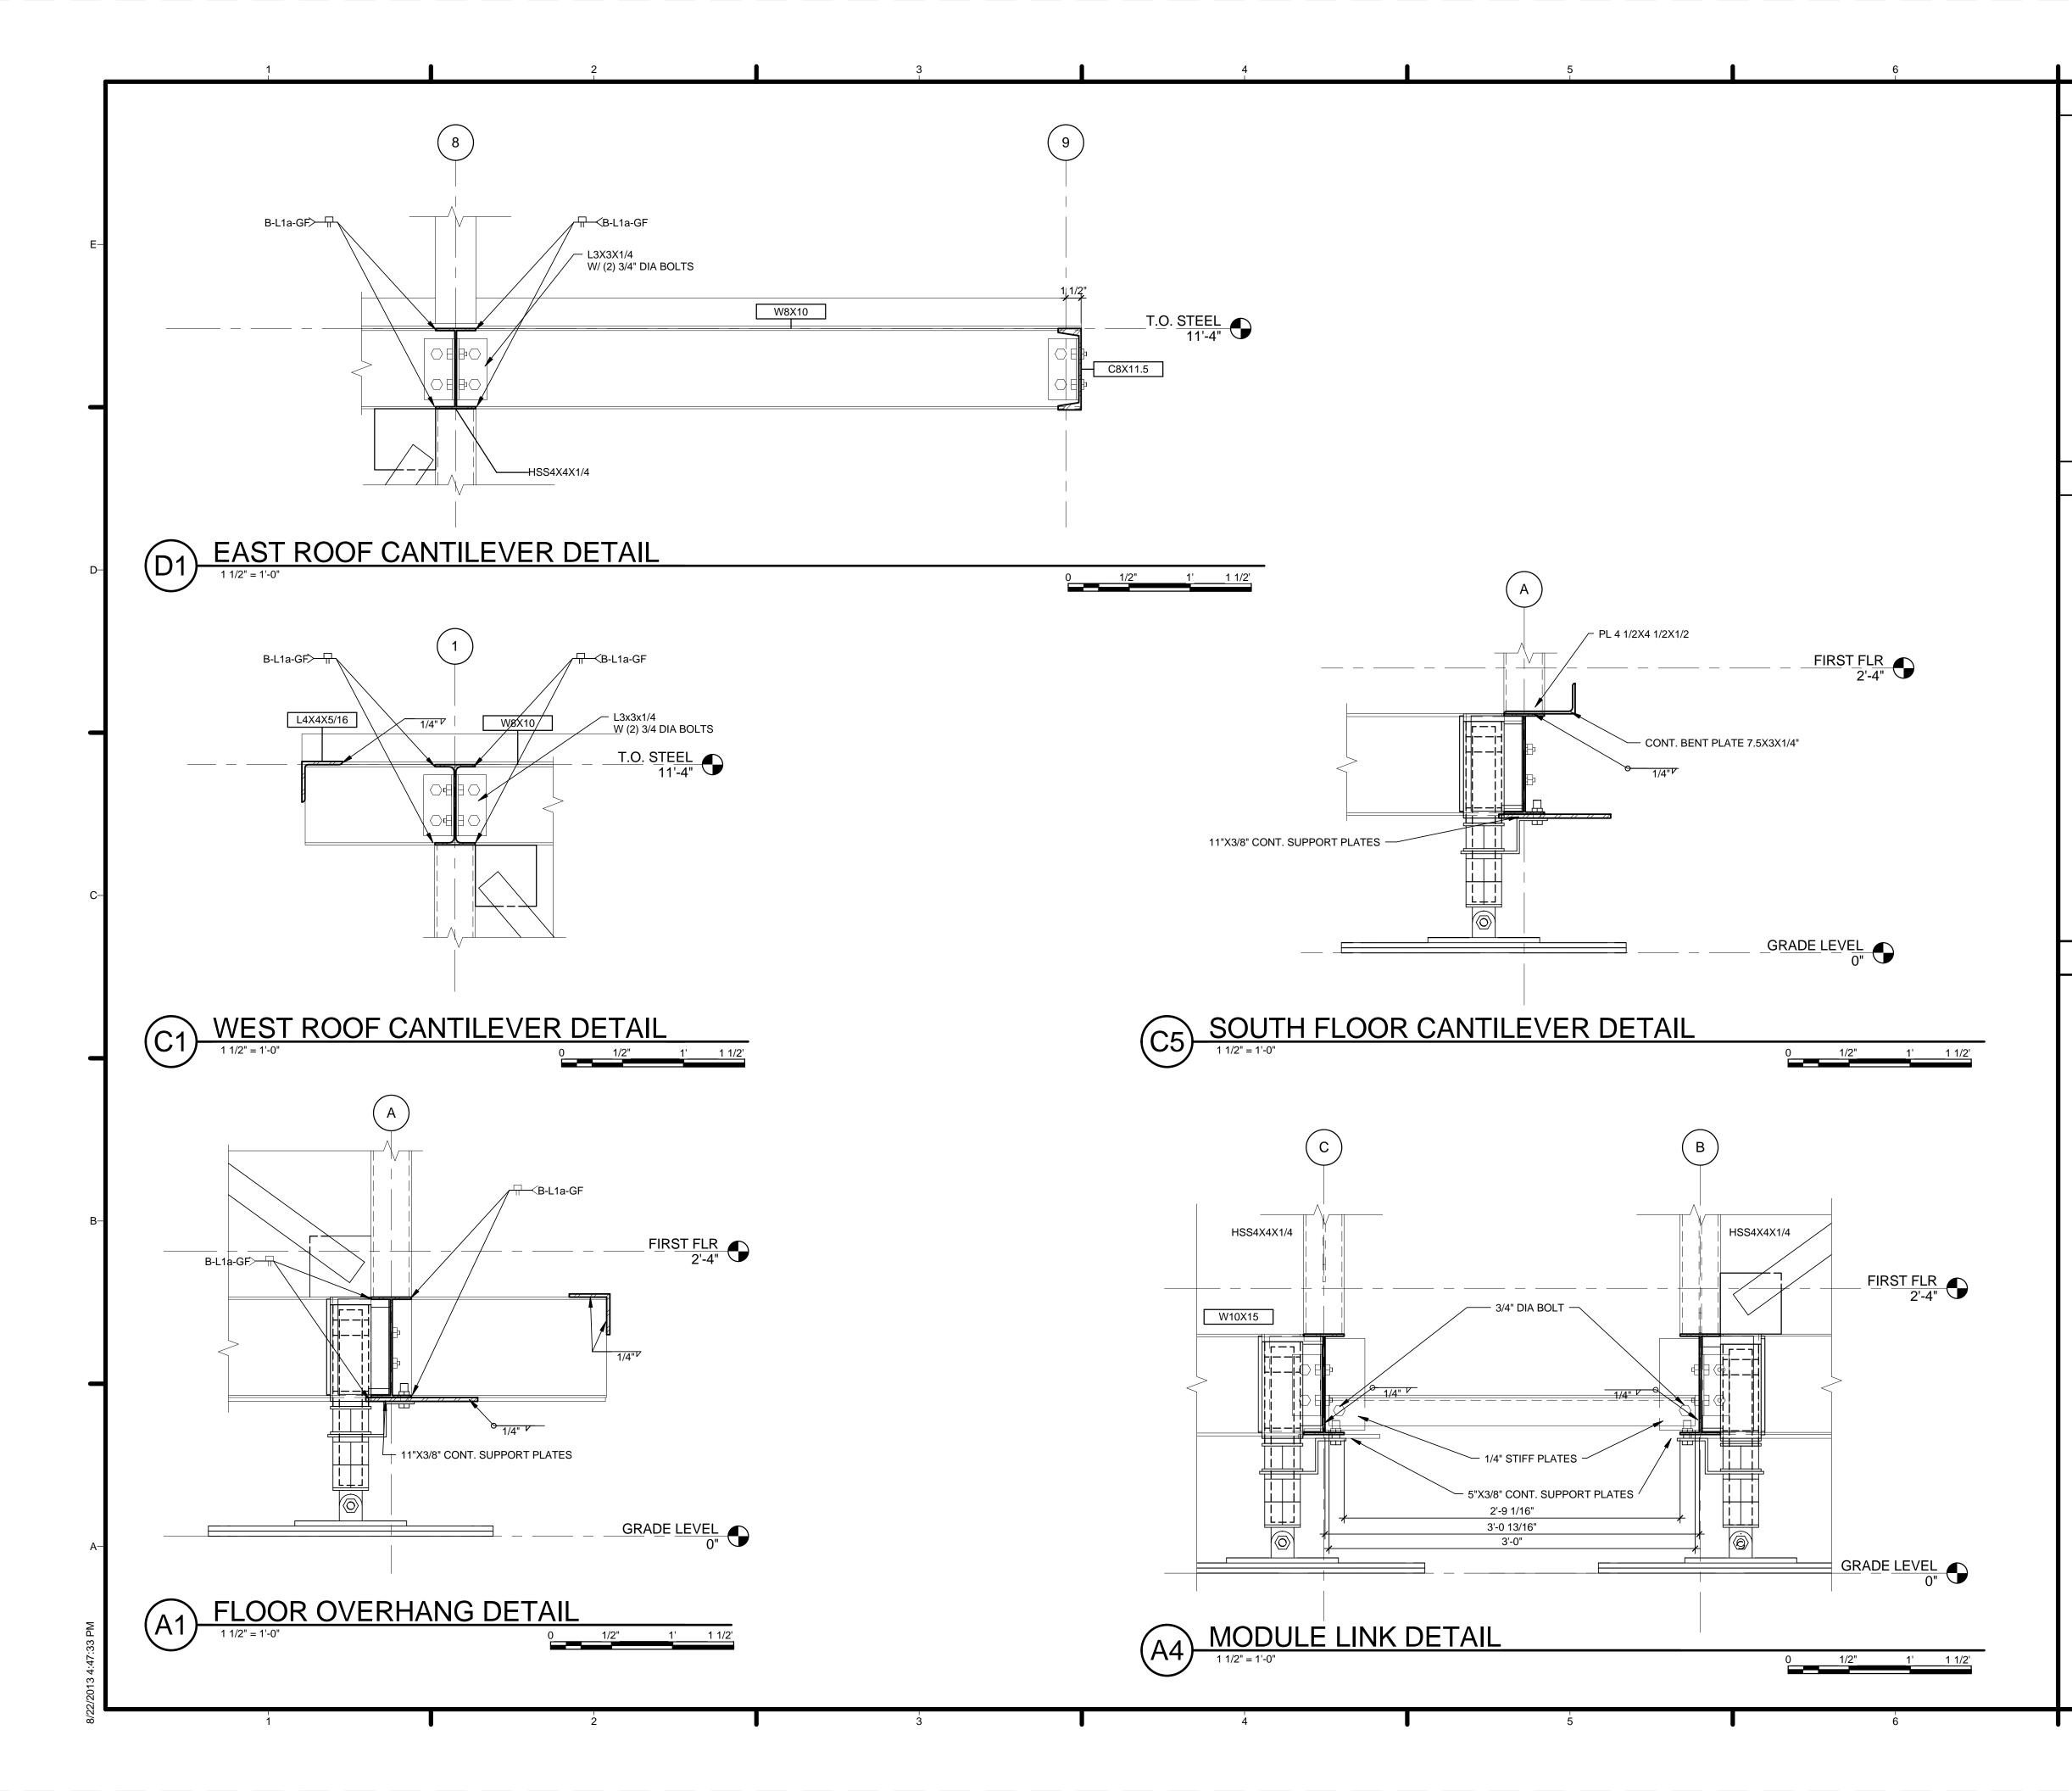
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REFERENCE KEYNOTES		STRUCTURAL ENGINEER
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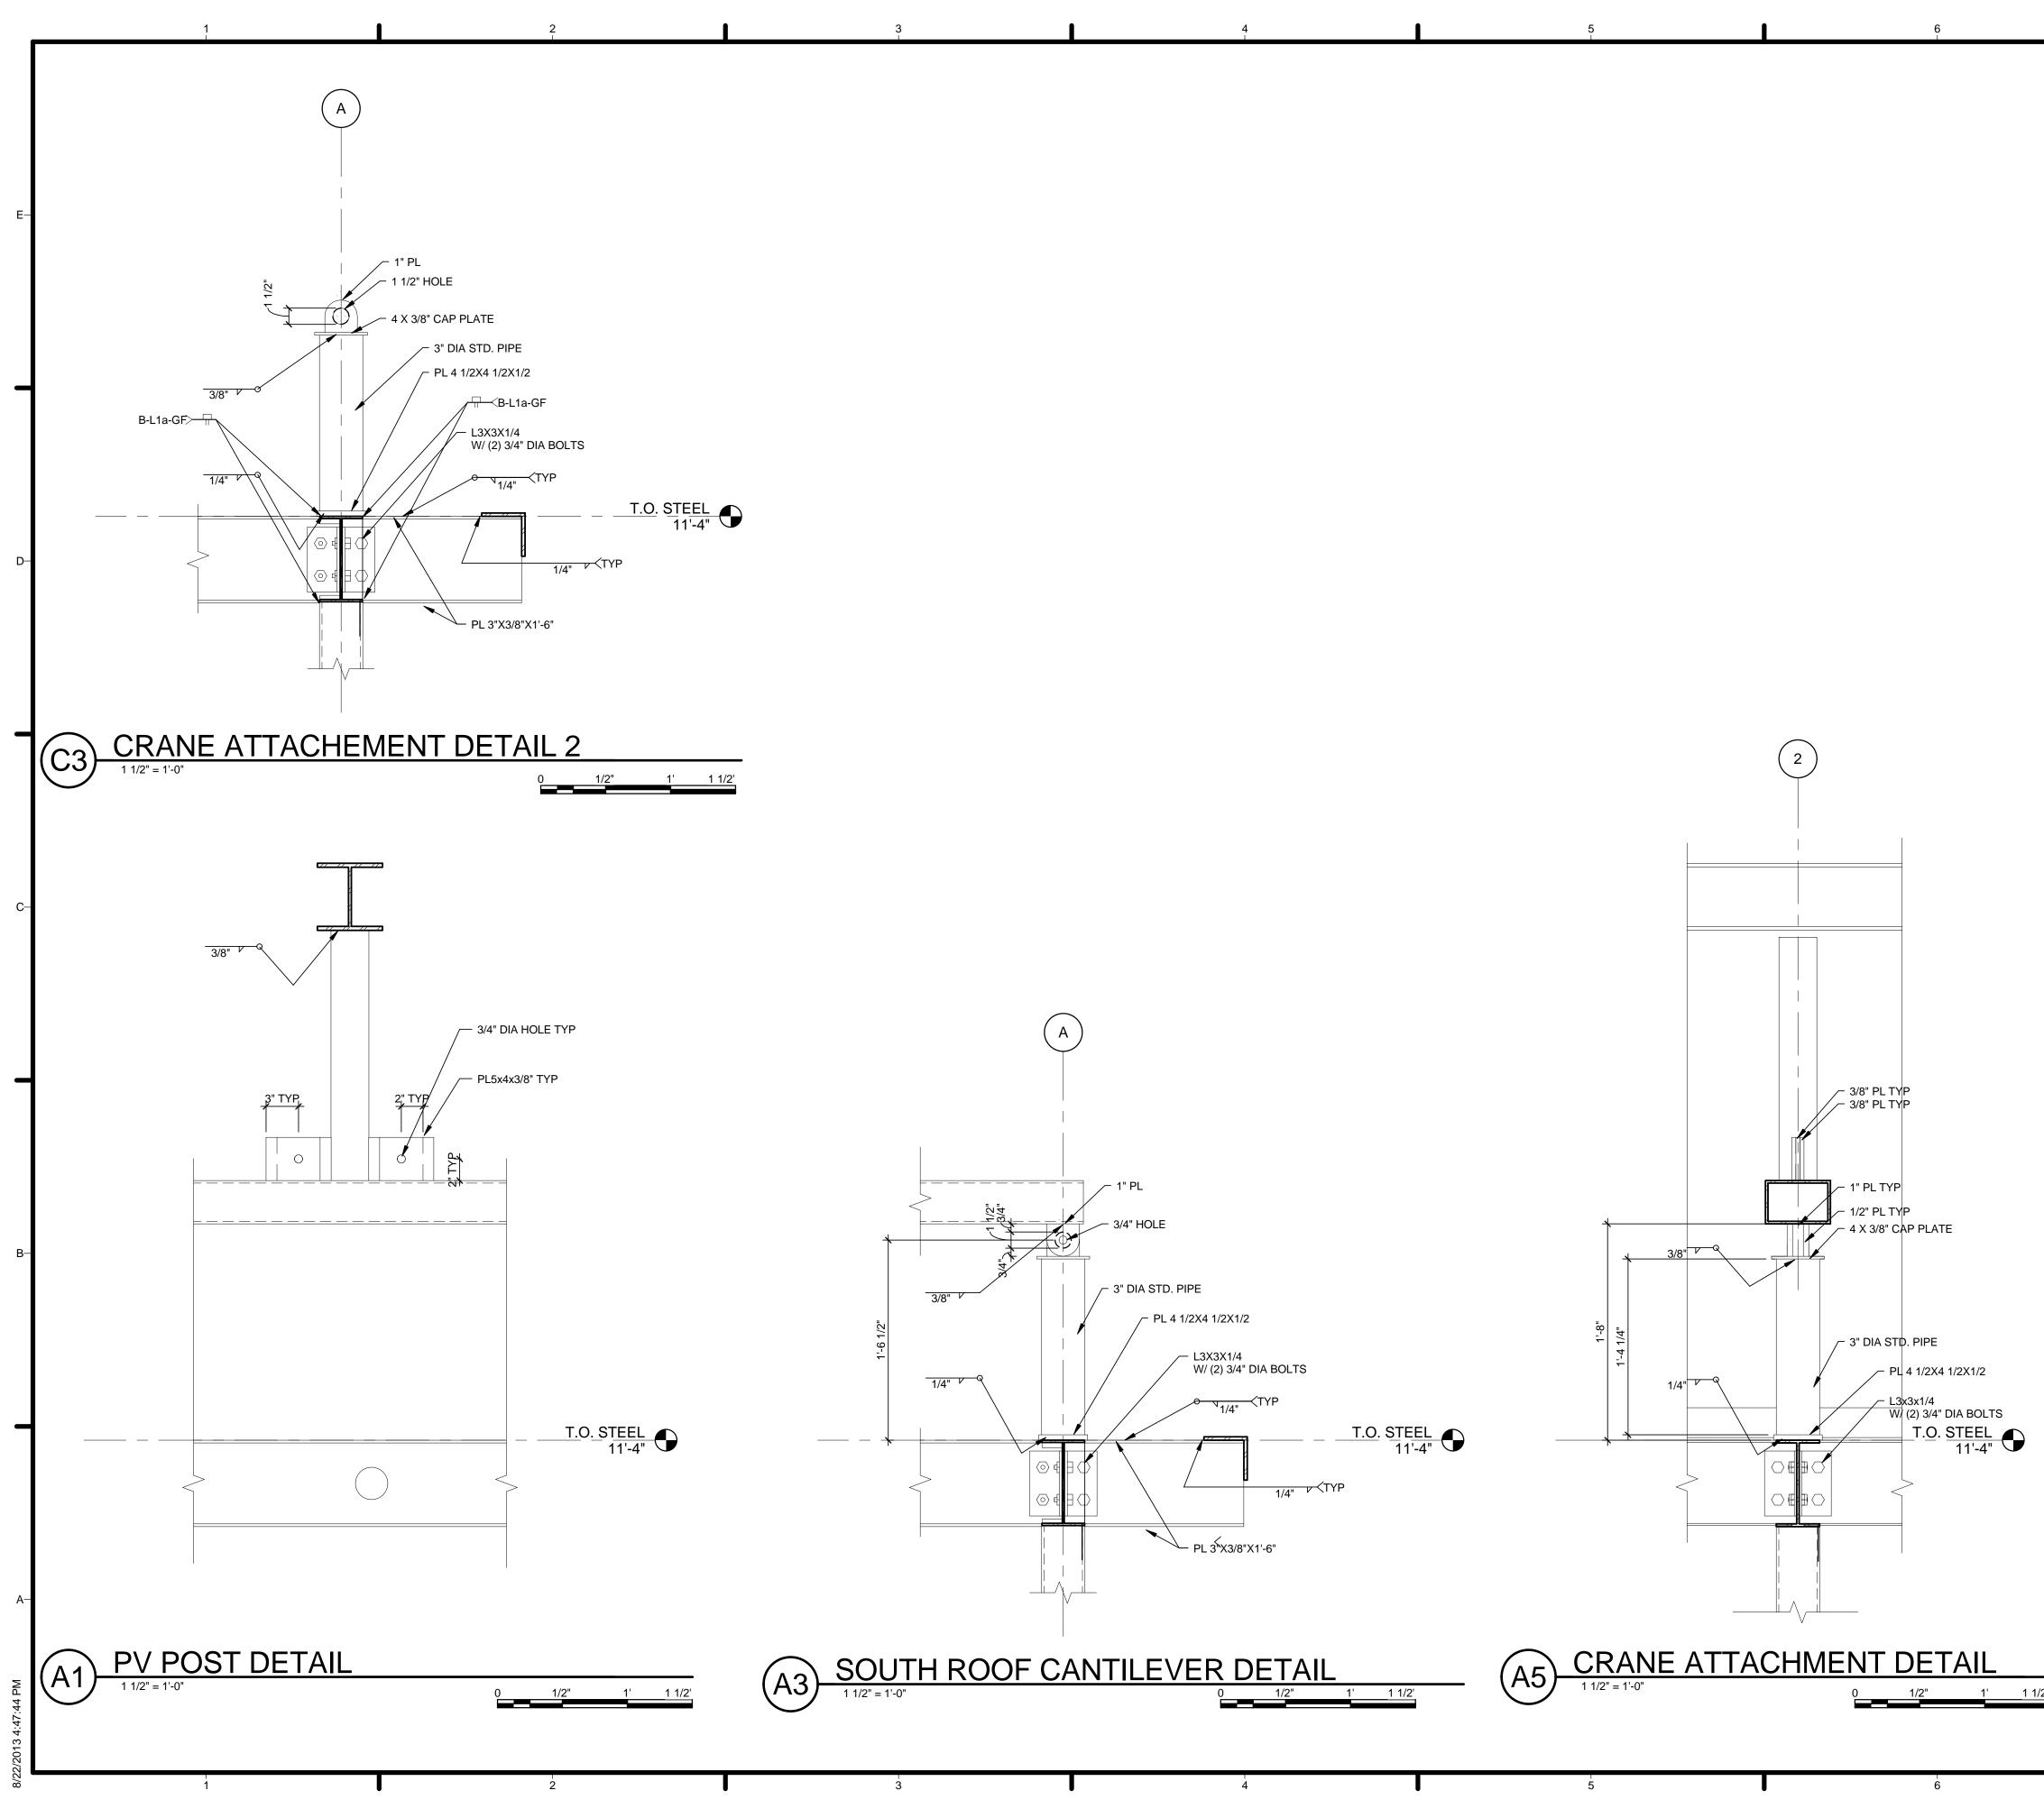
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	-Е	HARVEST CAPITOL
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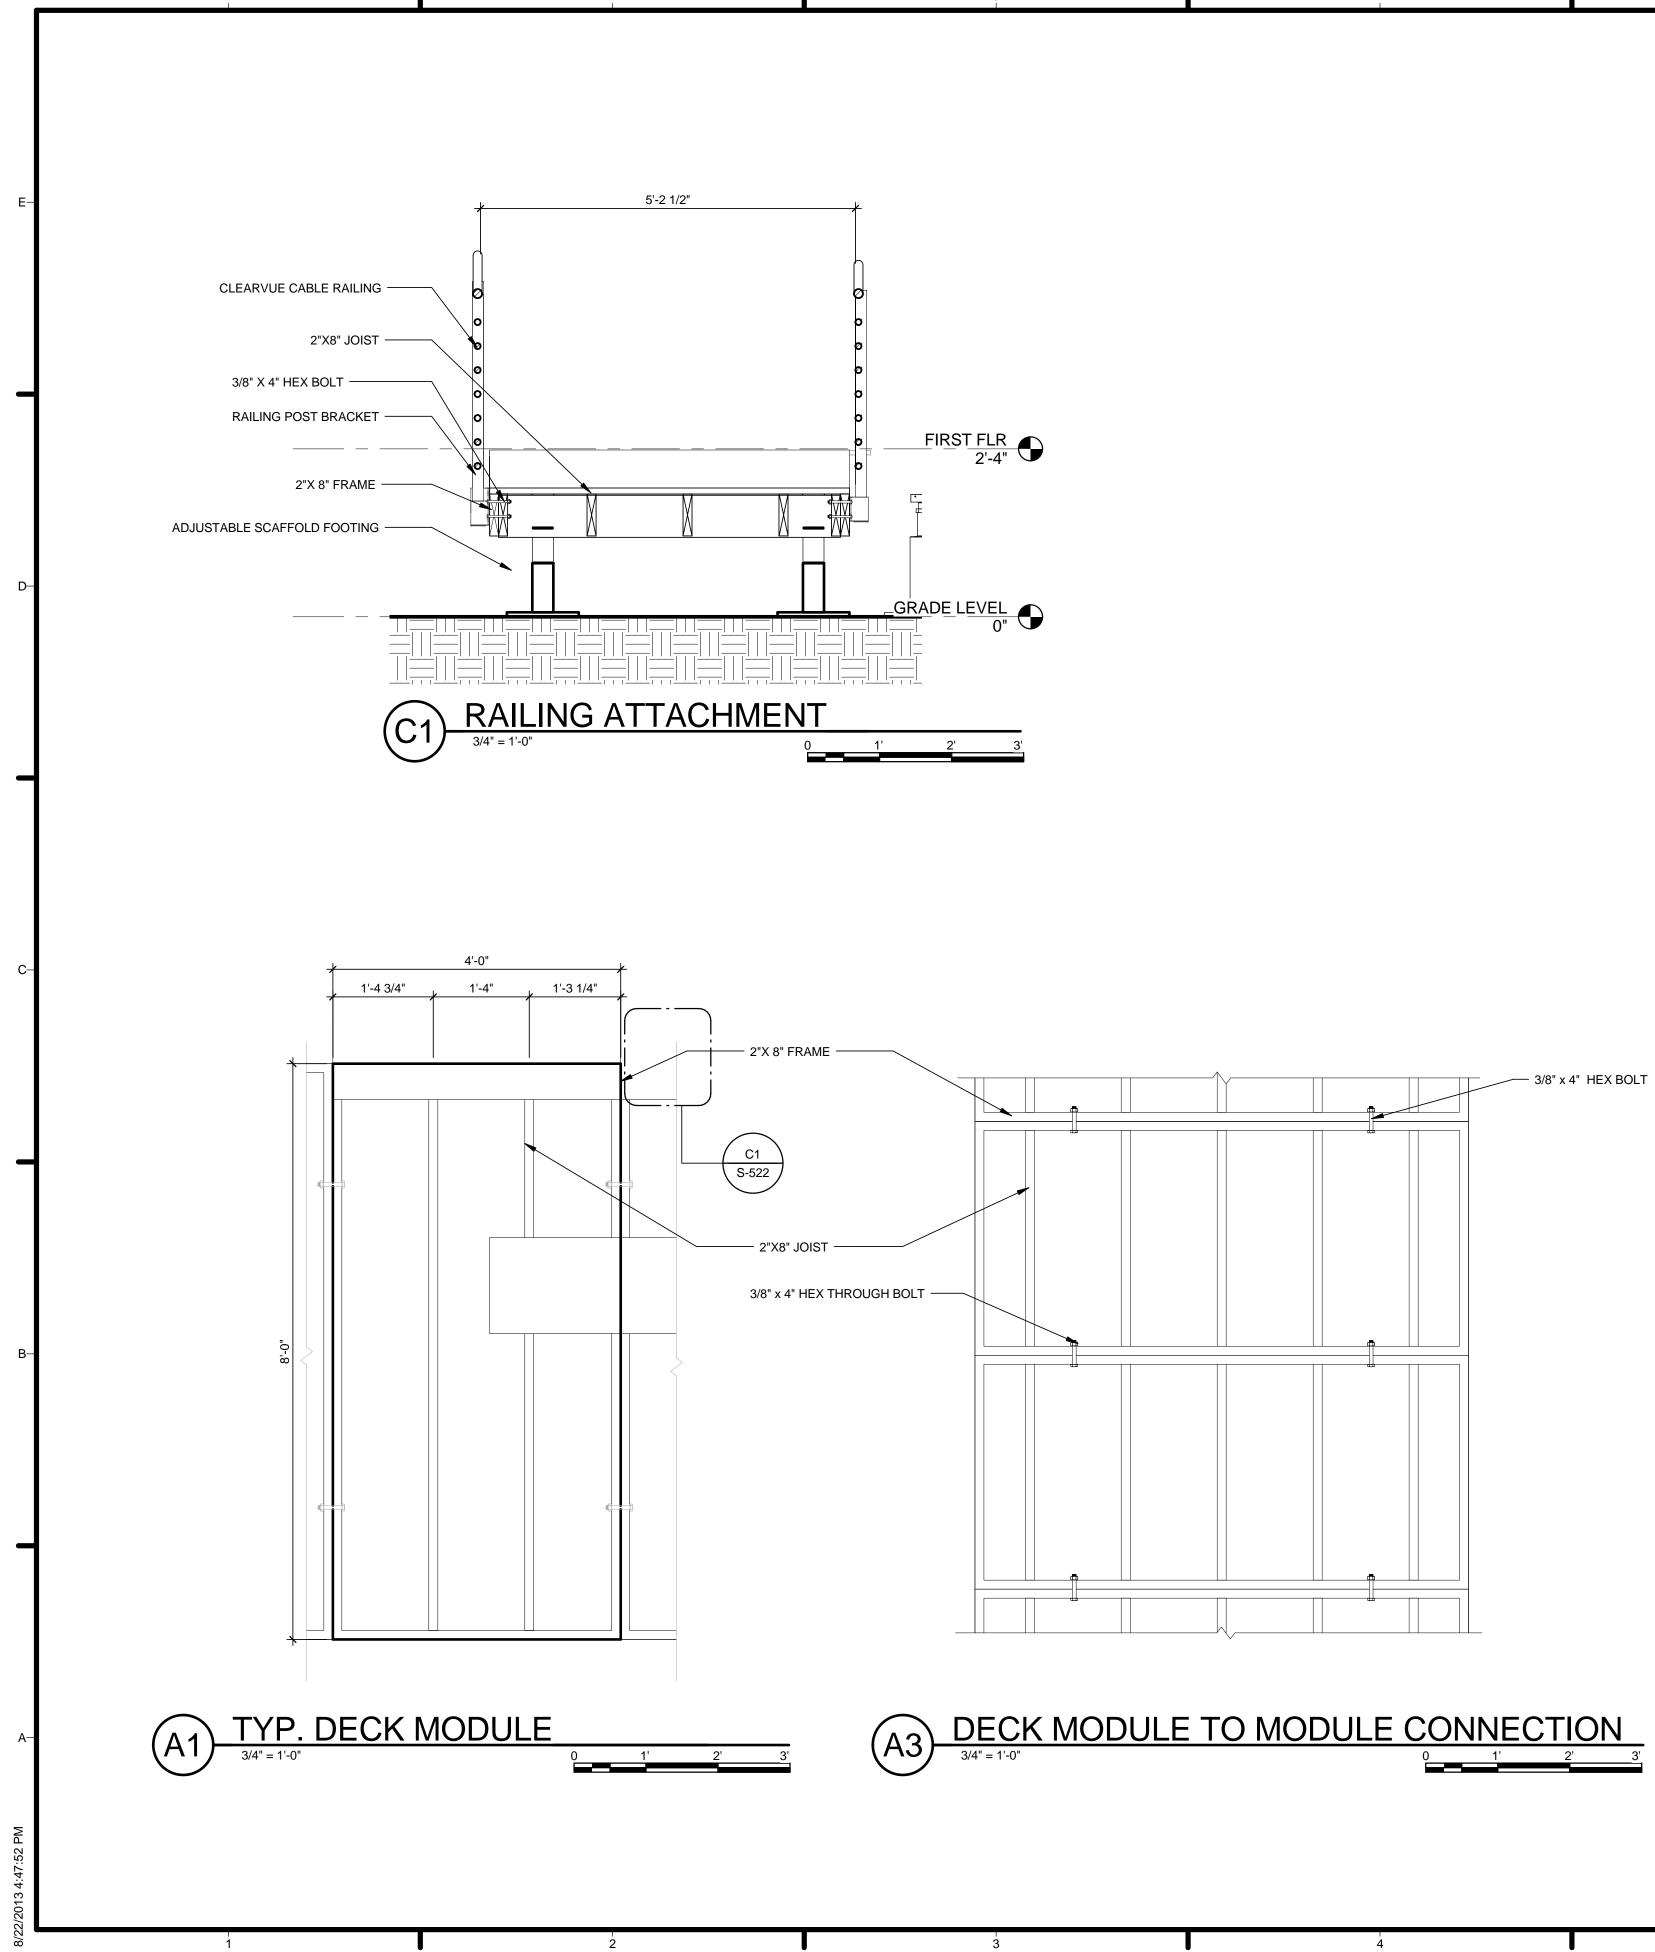
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		ADDRESS: THE CATHOLIC UNIVERSITY OF AMERICA SCHOOL OF ARCHITECTURE 620 MICHIGAN AVENUE, NE. WASHINGTON, DC 20064
REFERENCE KEYNOTES		STRUCTURAL ENGINEER
05 12 23.A7 HSS 4 X 4 X 1/4	-D	BOB ALLISON, PE ARUP ENGINEERING 1120 CONNECTICUT AVENUE, NW., SUITE 200 WASHINGTON, DC 20036 TEL: 202.729.8220 MEP ENGINEER
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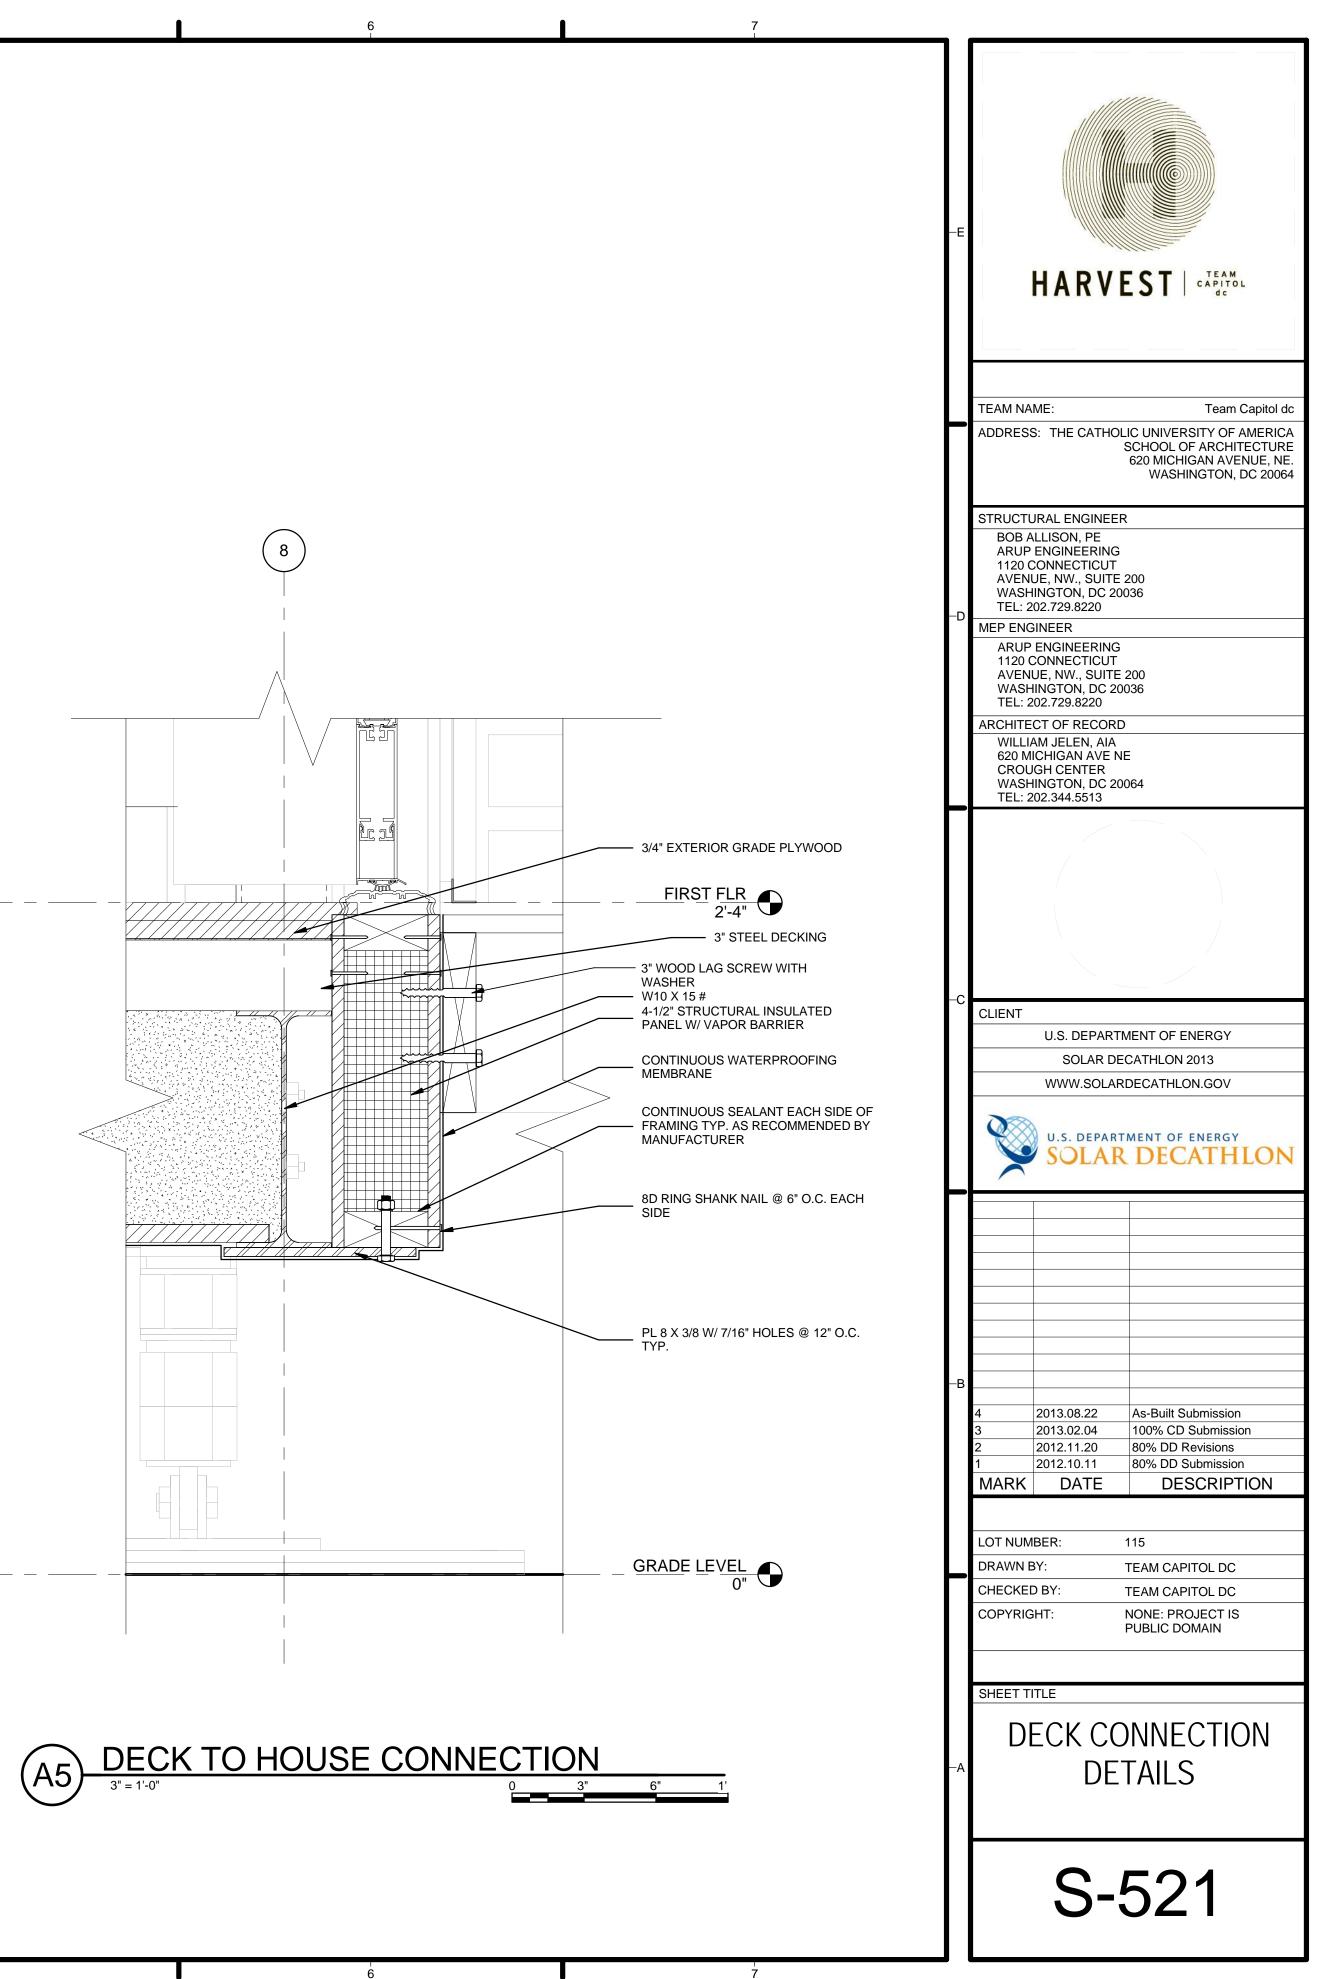
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GENERAL SHEET NOTES	HARVEST CAPITOL	
REFERENCE KEYNOTES	TEAM NAME: Team Capito ADDRESS: THE CATHOLIC UNIVERSITY OF AMER SCHOOL OF ARCHITECTU 620 MICHIGAN AVENUE, WASHINGTON, DC 20 STRUCTURAL ENGINEER BOB ALLISON, PE ARUP ENGINEERING 1120 CONNECTICUT AVENUE, NW., SUITE 200 WASHINGTON, DC 20036 TEL: 202.729.8220 MEP ENGINEER ARUP ENGINEERING 1120 CONNECTICUT AVENUE, NW., SUITE 200	ICA JRE NE.
	WASHINGTON, DC 20036 TEL: 202.729.8220 ARCHITECT OF RECORD WILLIAM JELEN, AIA 620 MICHIGAN AVE NE CROUGH CENTER WASHINGTON, DC 20064 TEL: 202.344.5513	
SHEET KEYNOTES	C CLIENT U.S. DEPARTMENT OF ENERGY SOLAR DECATHLON 2013 WWW.SOLARDECATHLON.GOV	N
	-B 4 2013.08.22 As-Built Submission 3 2013.02.04 100% CD Submission 2 2012.11.20 80% DD Revisions 1 2012.10.11 80% DD Submission MARK DATE DESCRIPTION	
	LOT NUMBER: 115 DRAWN BY: TEAM CAPITOL DC CHECKED BY: TEAM CAPITOL DC COPYRIGHT: NONE: PROJECT IS PUBLIC DOMAIN SHEET TITLE SECTION DETAILS	
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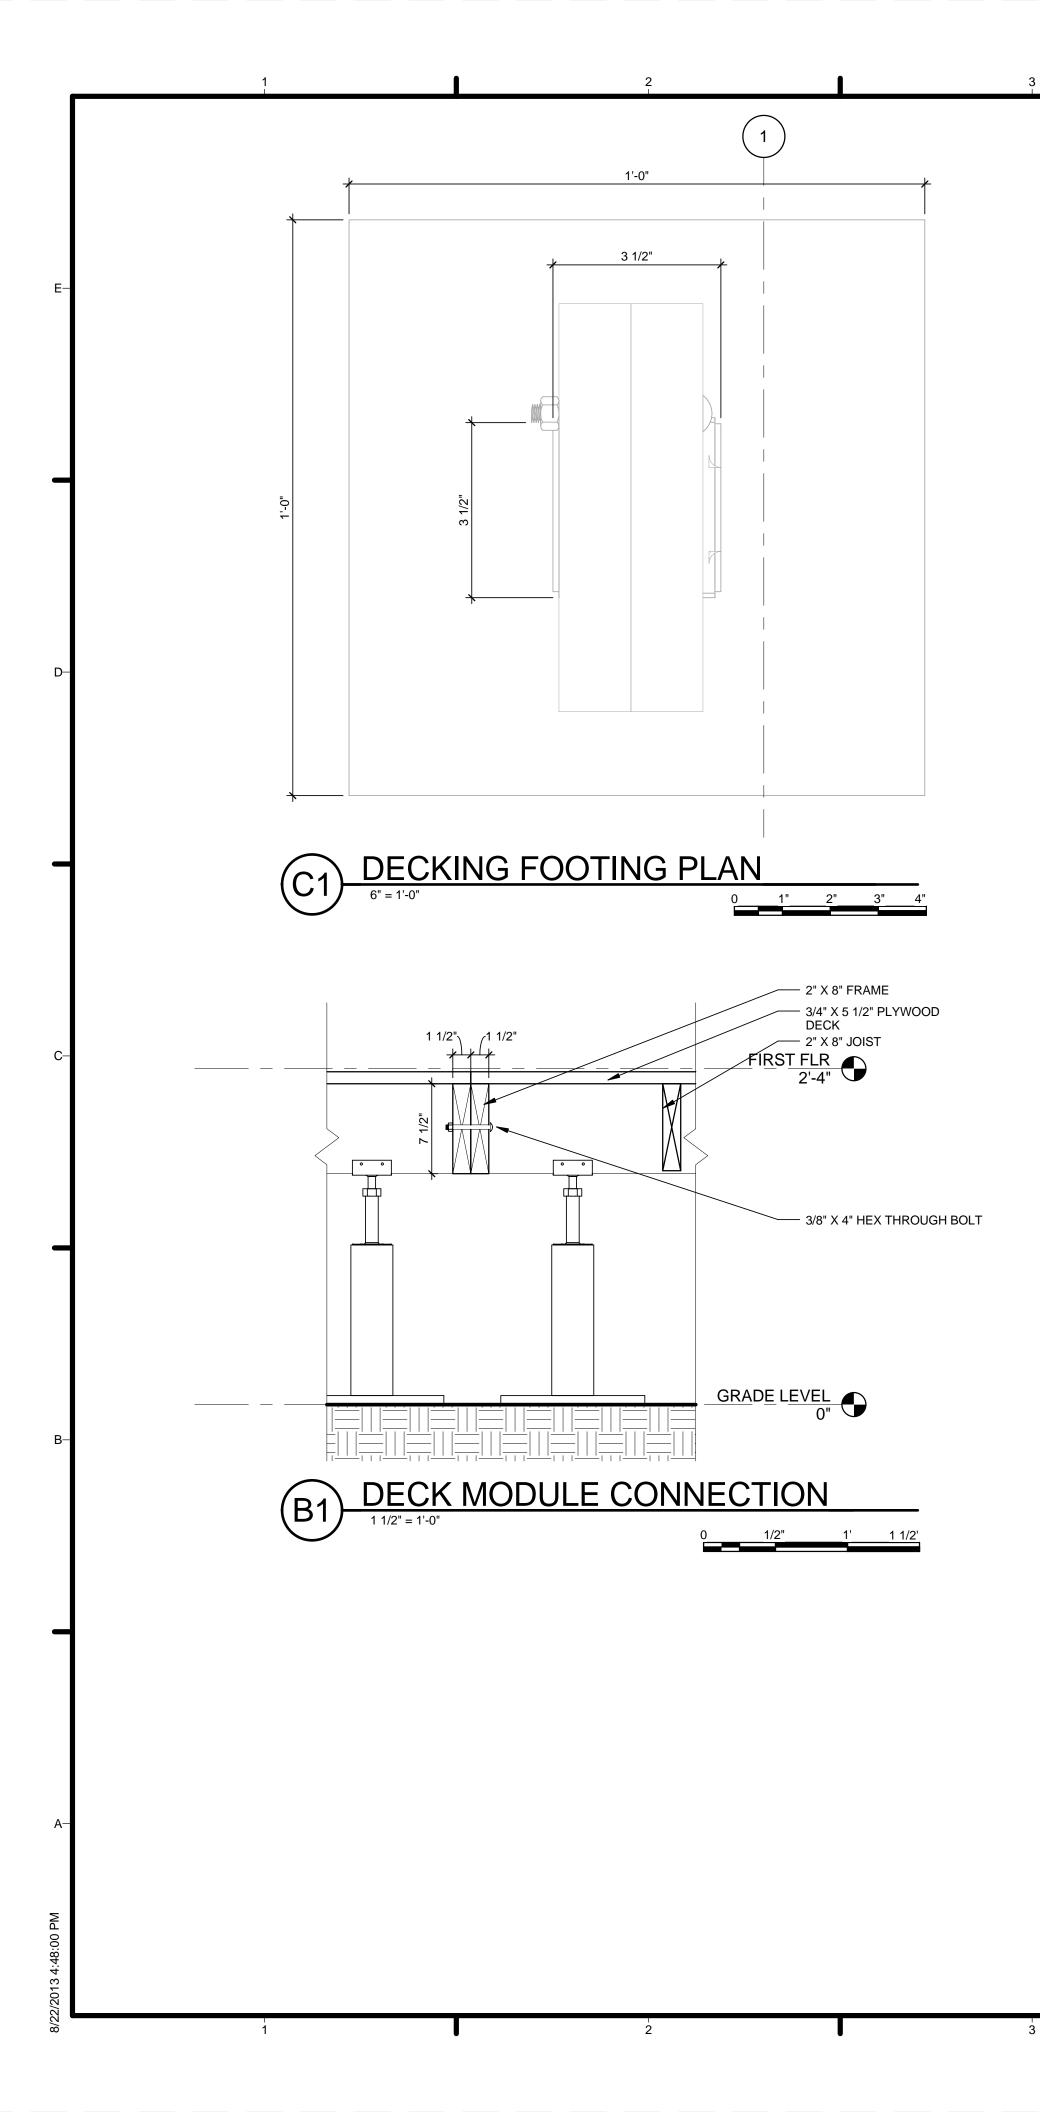


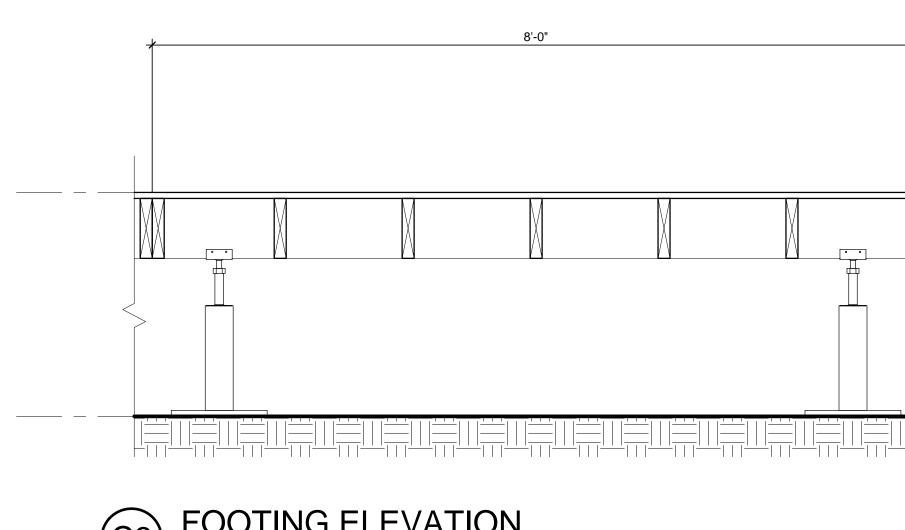
G	SENERAL SHEET NOTES	-E	HARVEST CAPITOL
R	REFERENCE KEYNOTES		TEAM NAME: Team Capitol dc ADDRESS: THE CATHOLIC UNIVERSITY OF AMERICA SCHOOL OF ARCHITECTURE 620 MICHIGAN AVENUE, NE. WASHINGTON, DC 20064 STRUCTURAL ENGINEER BOB ALLISON, PE
		-D	ARUP ENGINEERING 1120 CONNECTICUT AVENUE, NW., SUITE 200 WASHINGTON, DC 20036 TEL: 202.729.8220 MEP ENGINEER ARUP ENGINEERING 1120 CONNECTICUT AVENUE, NW., SUITE 200 WASHINGTON, DC 20036 TEL: 202.729.8220 ARCHITECT OF RECORD WILLIAM JELEN, AIA 620 MICHIGAN AVE NE CROUGH CENTER WASHINGTON, DC 20064 TEL: 202.344.5513
		C	CLIENT U.S. DEPARTMENT OF ENERGY SOLAR DECATHLON 2013
	SHEET KEYNOTES		WWW.SOLARDECATHLON.GOV
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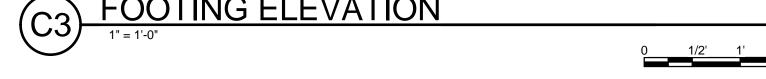


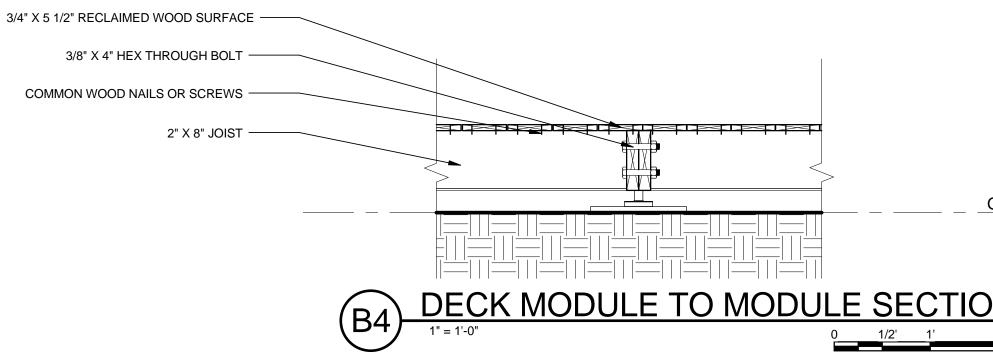


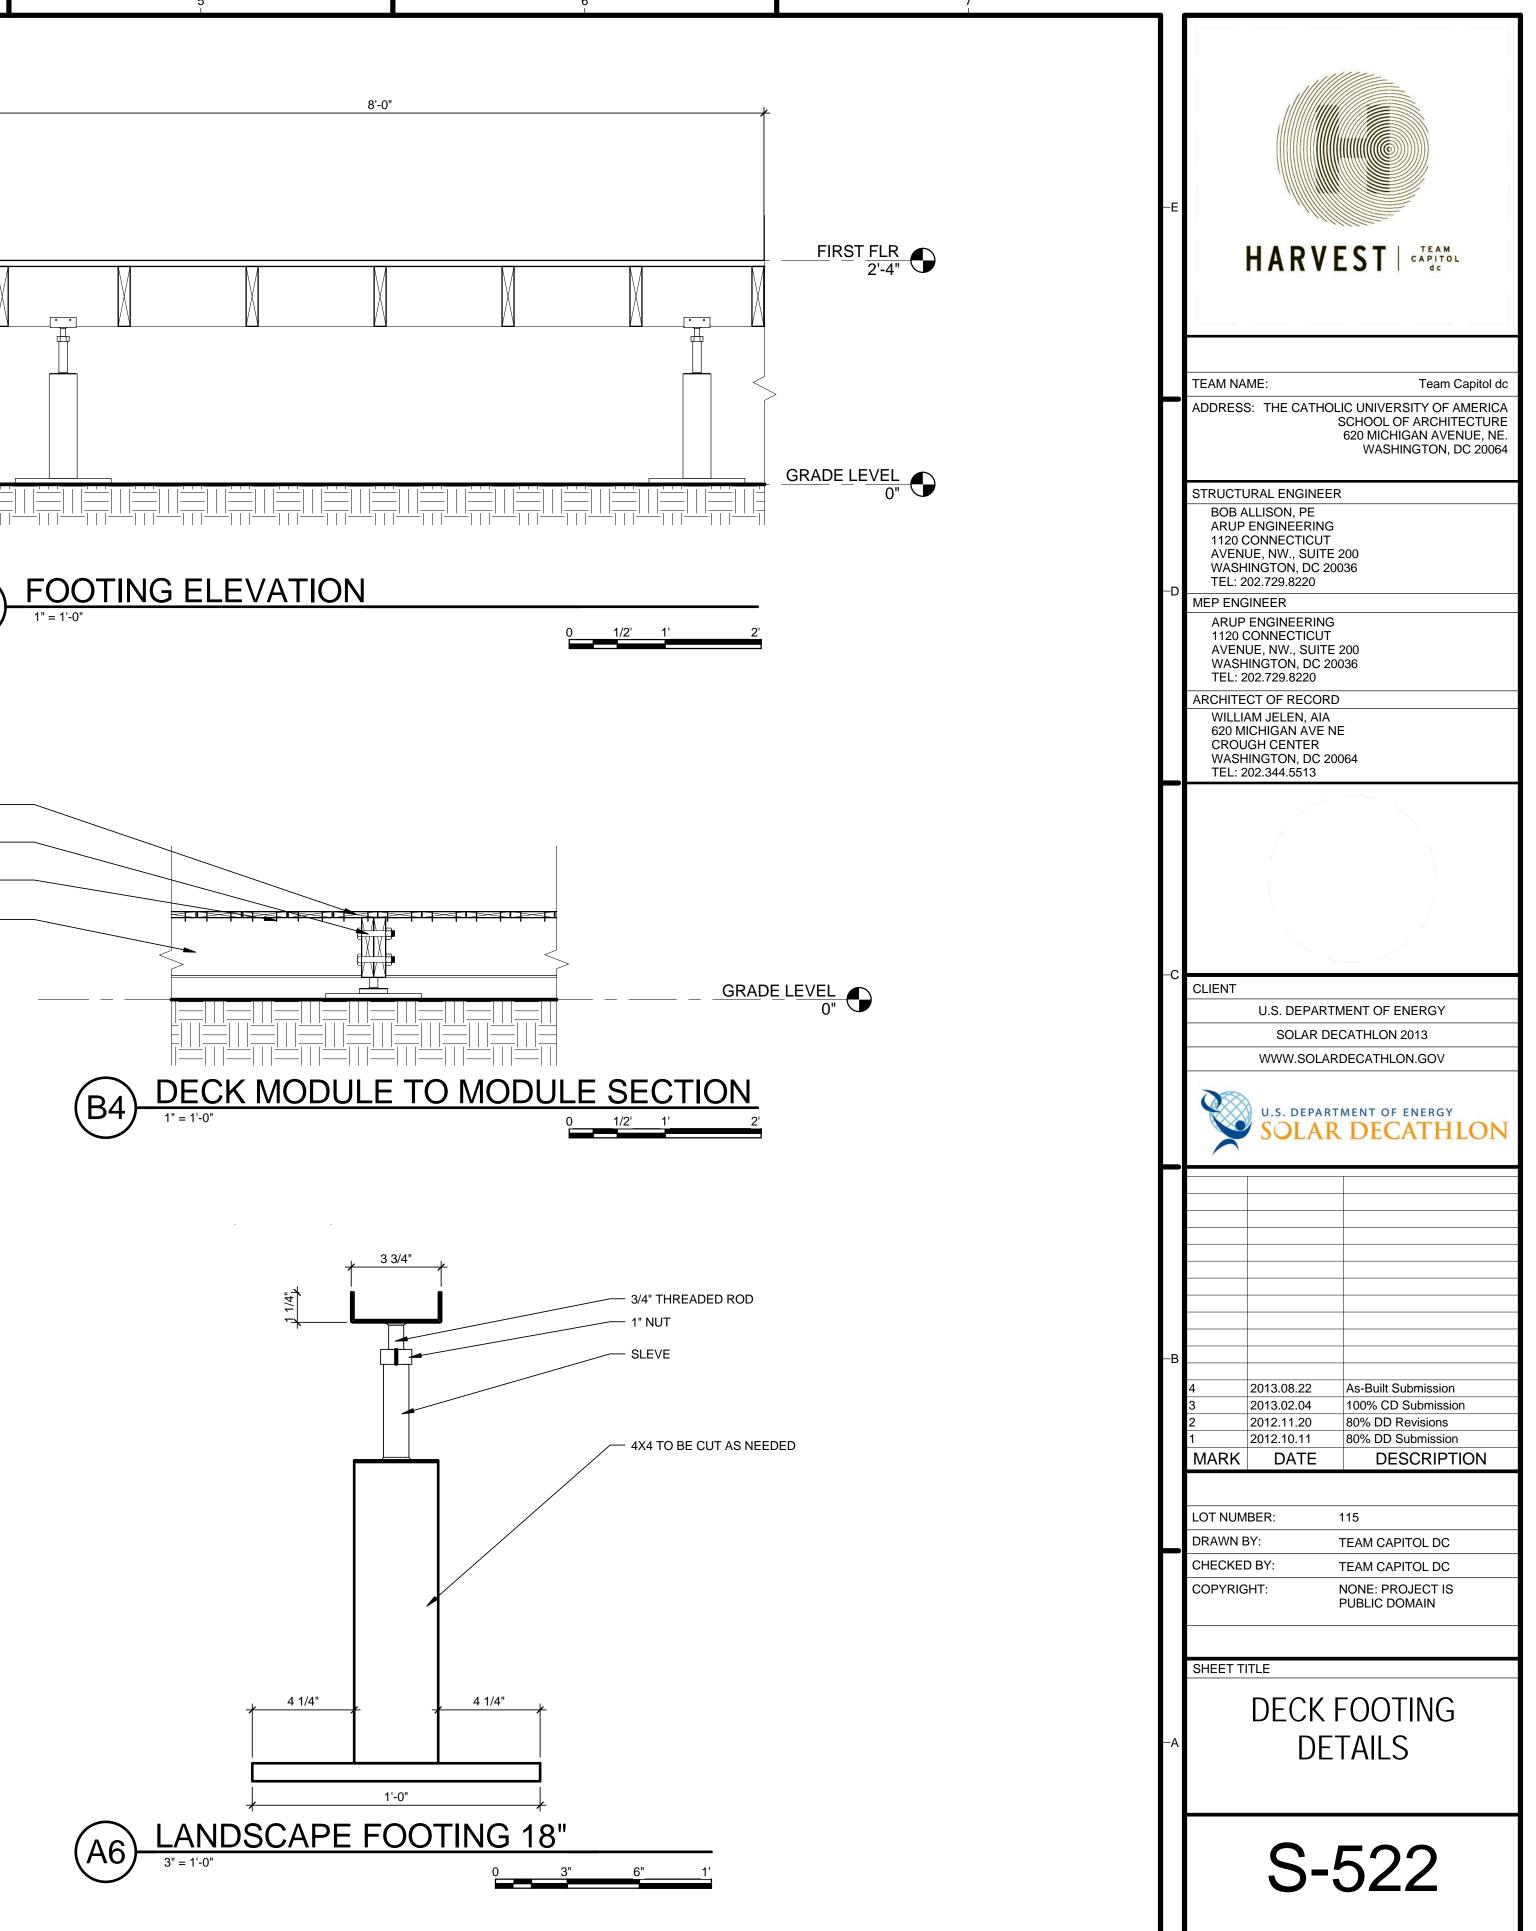


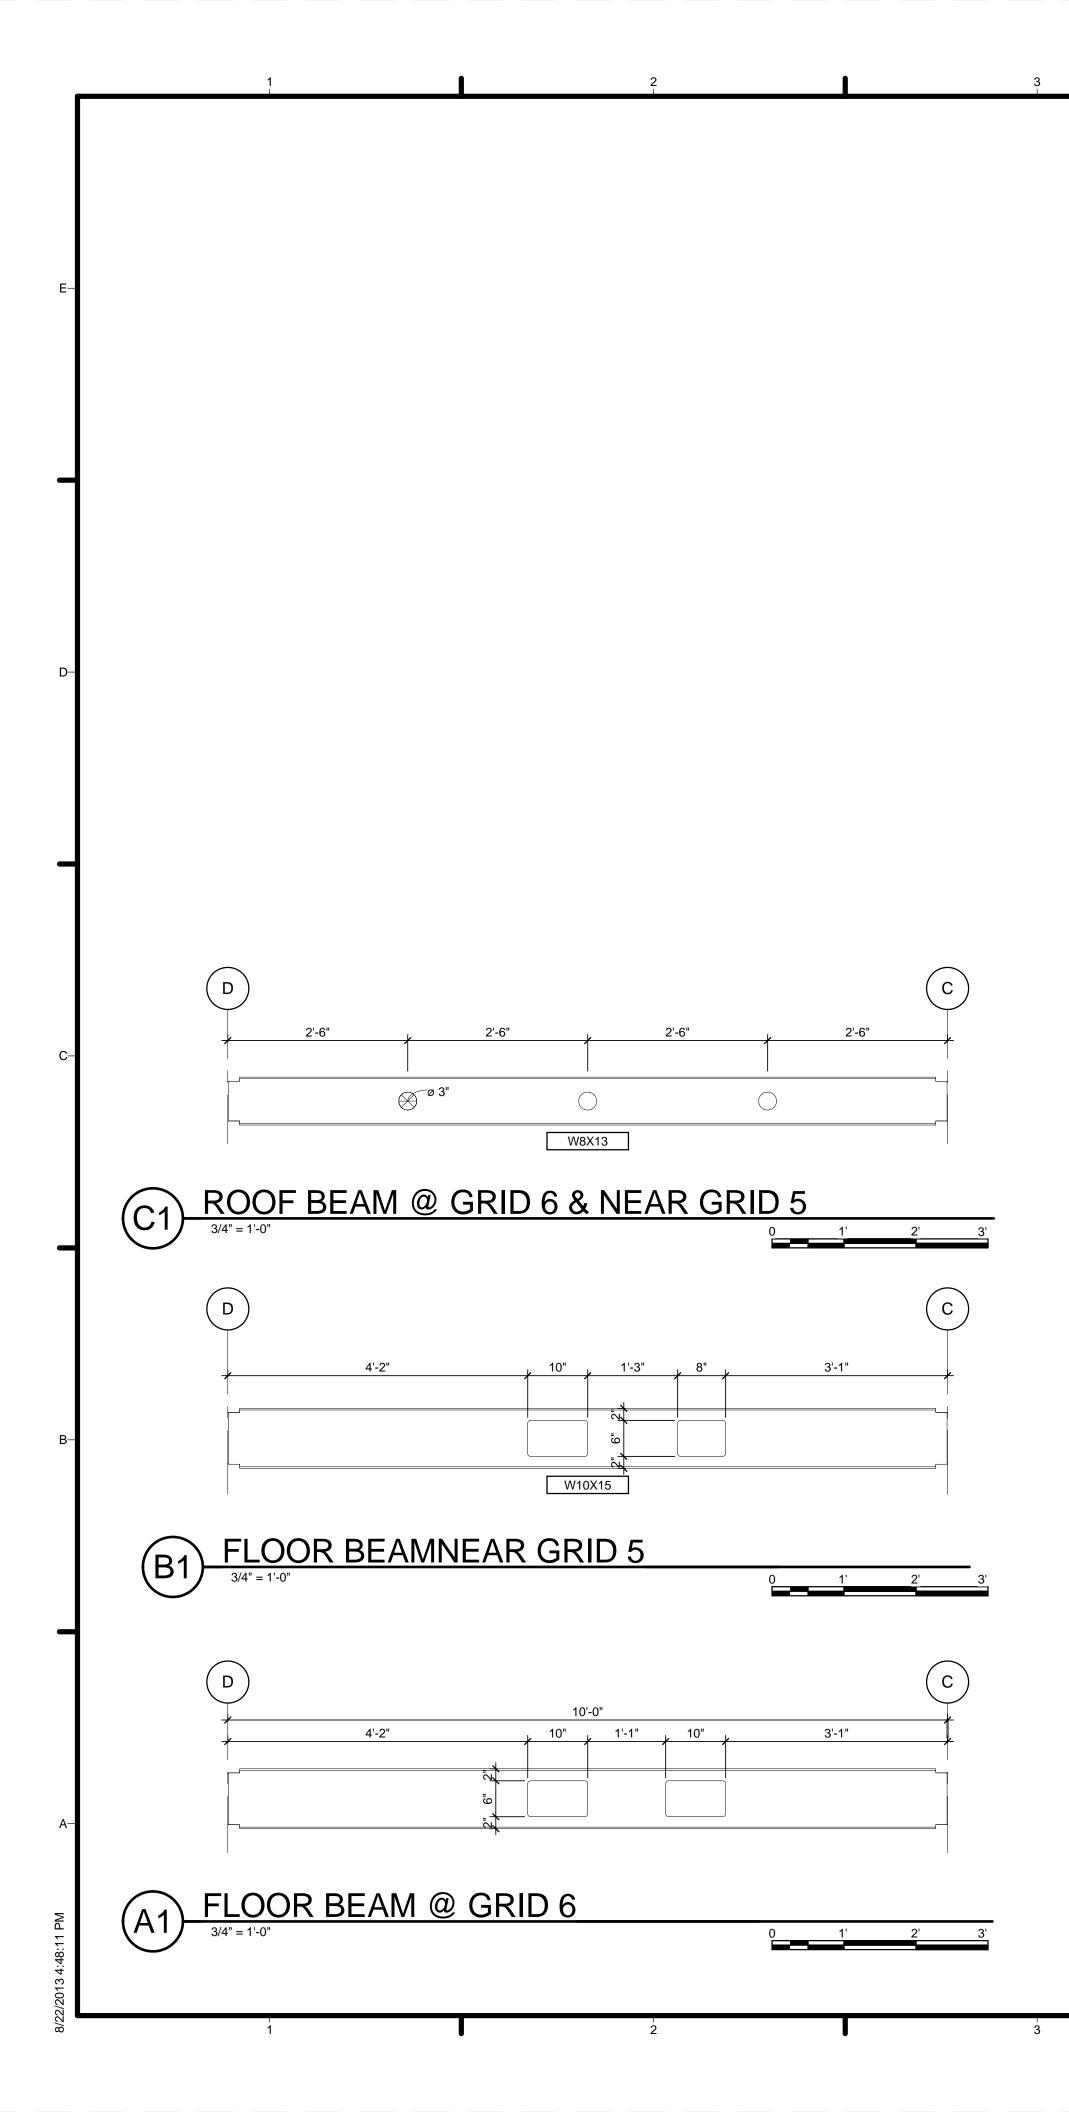


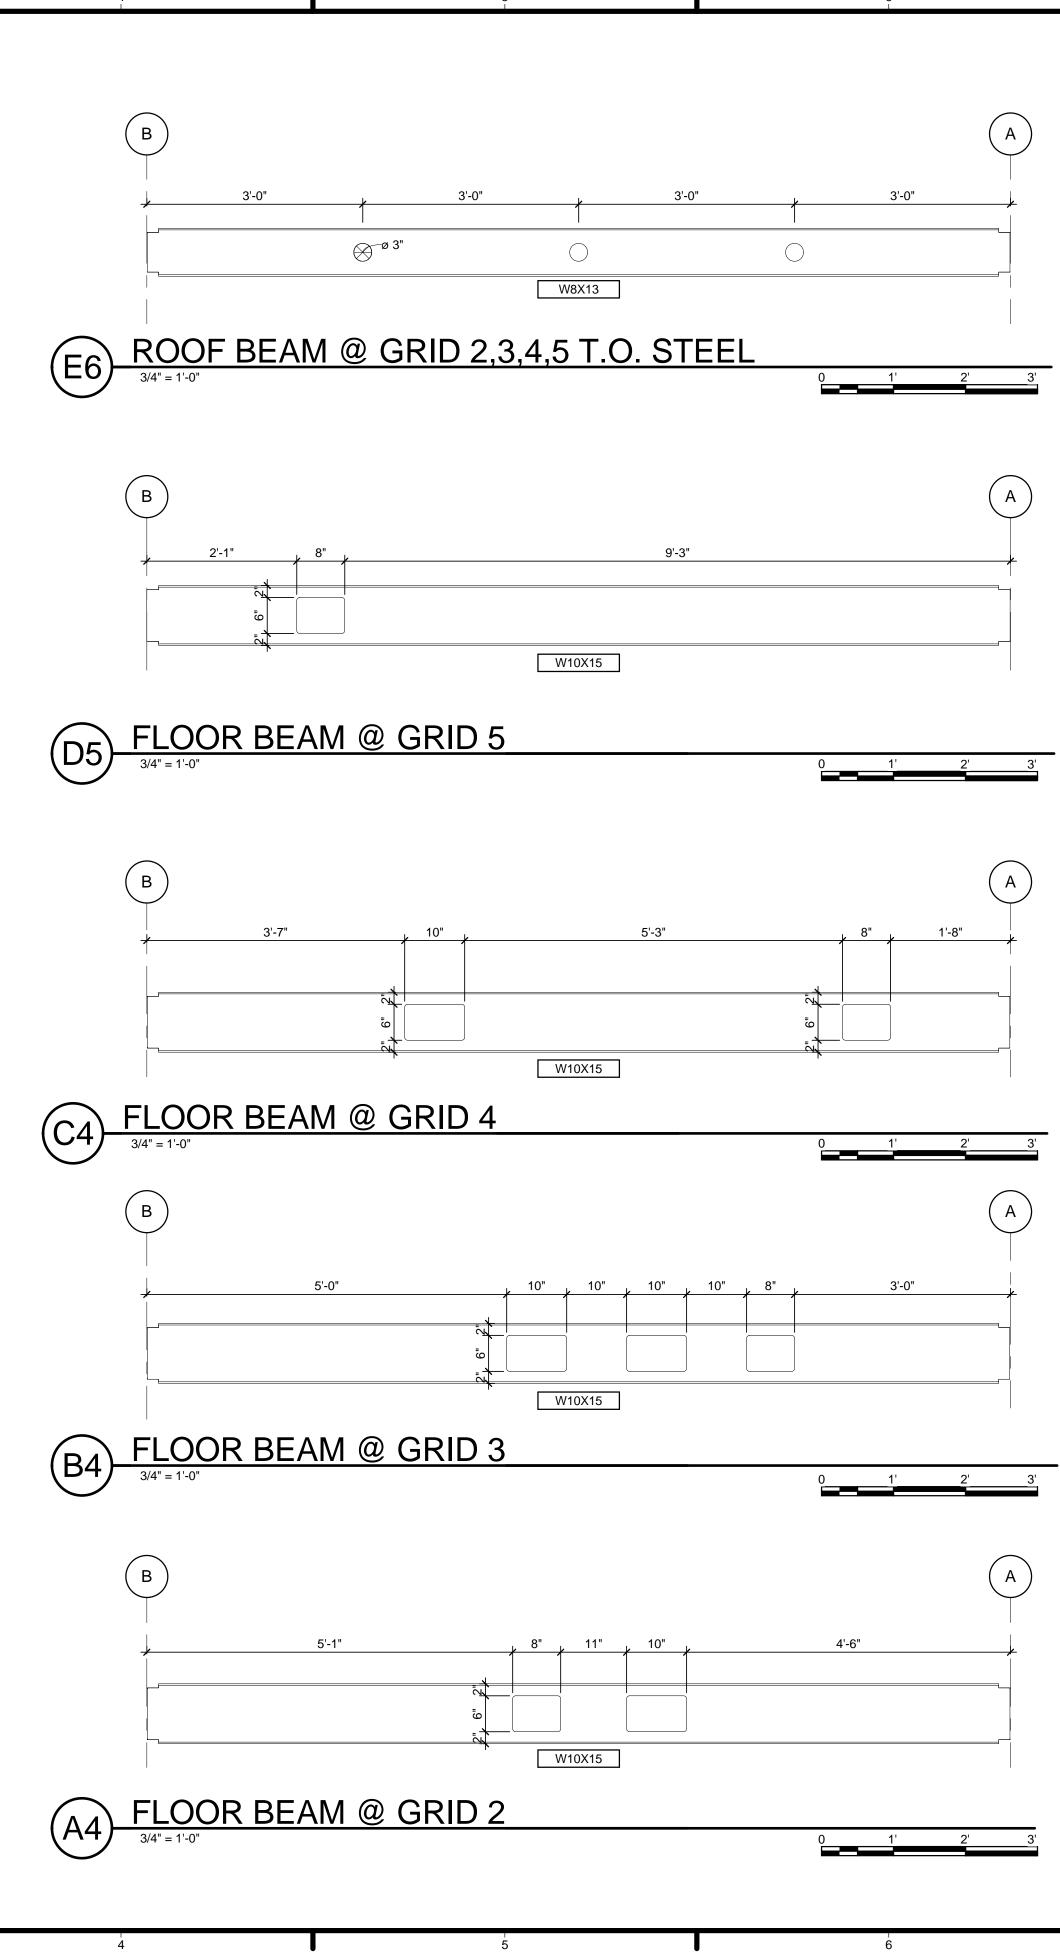




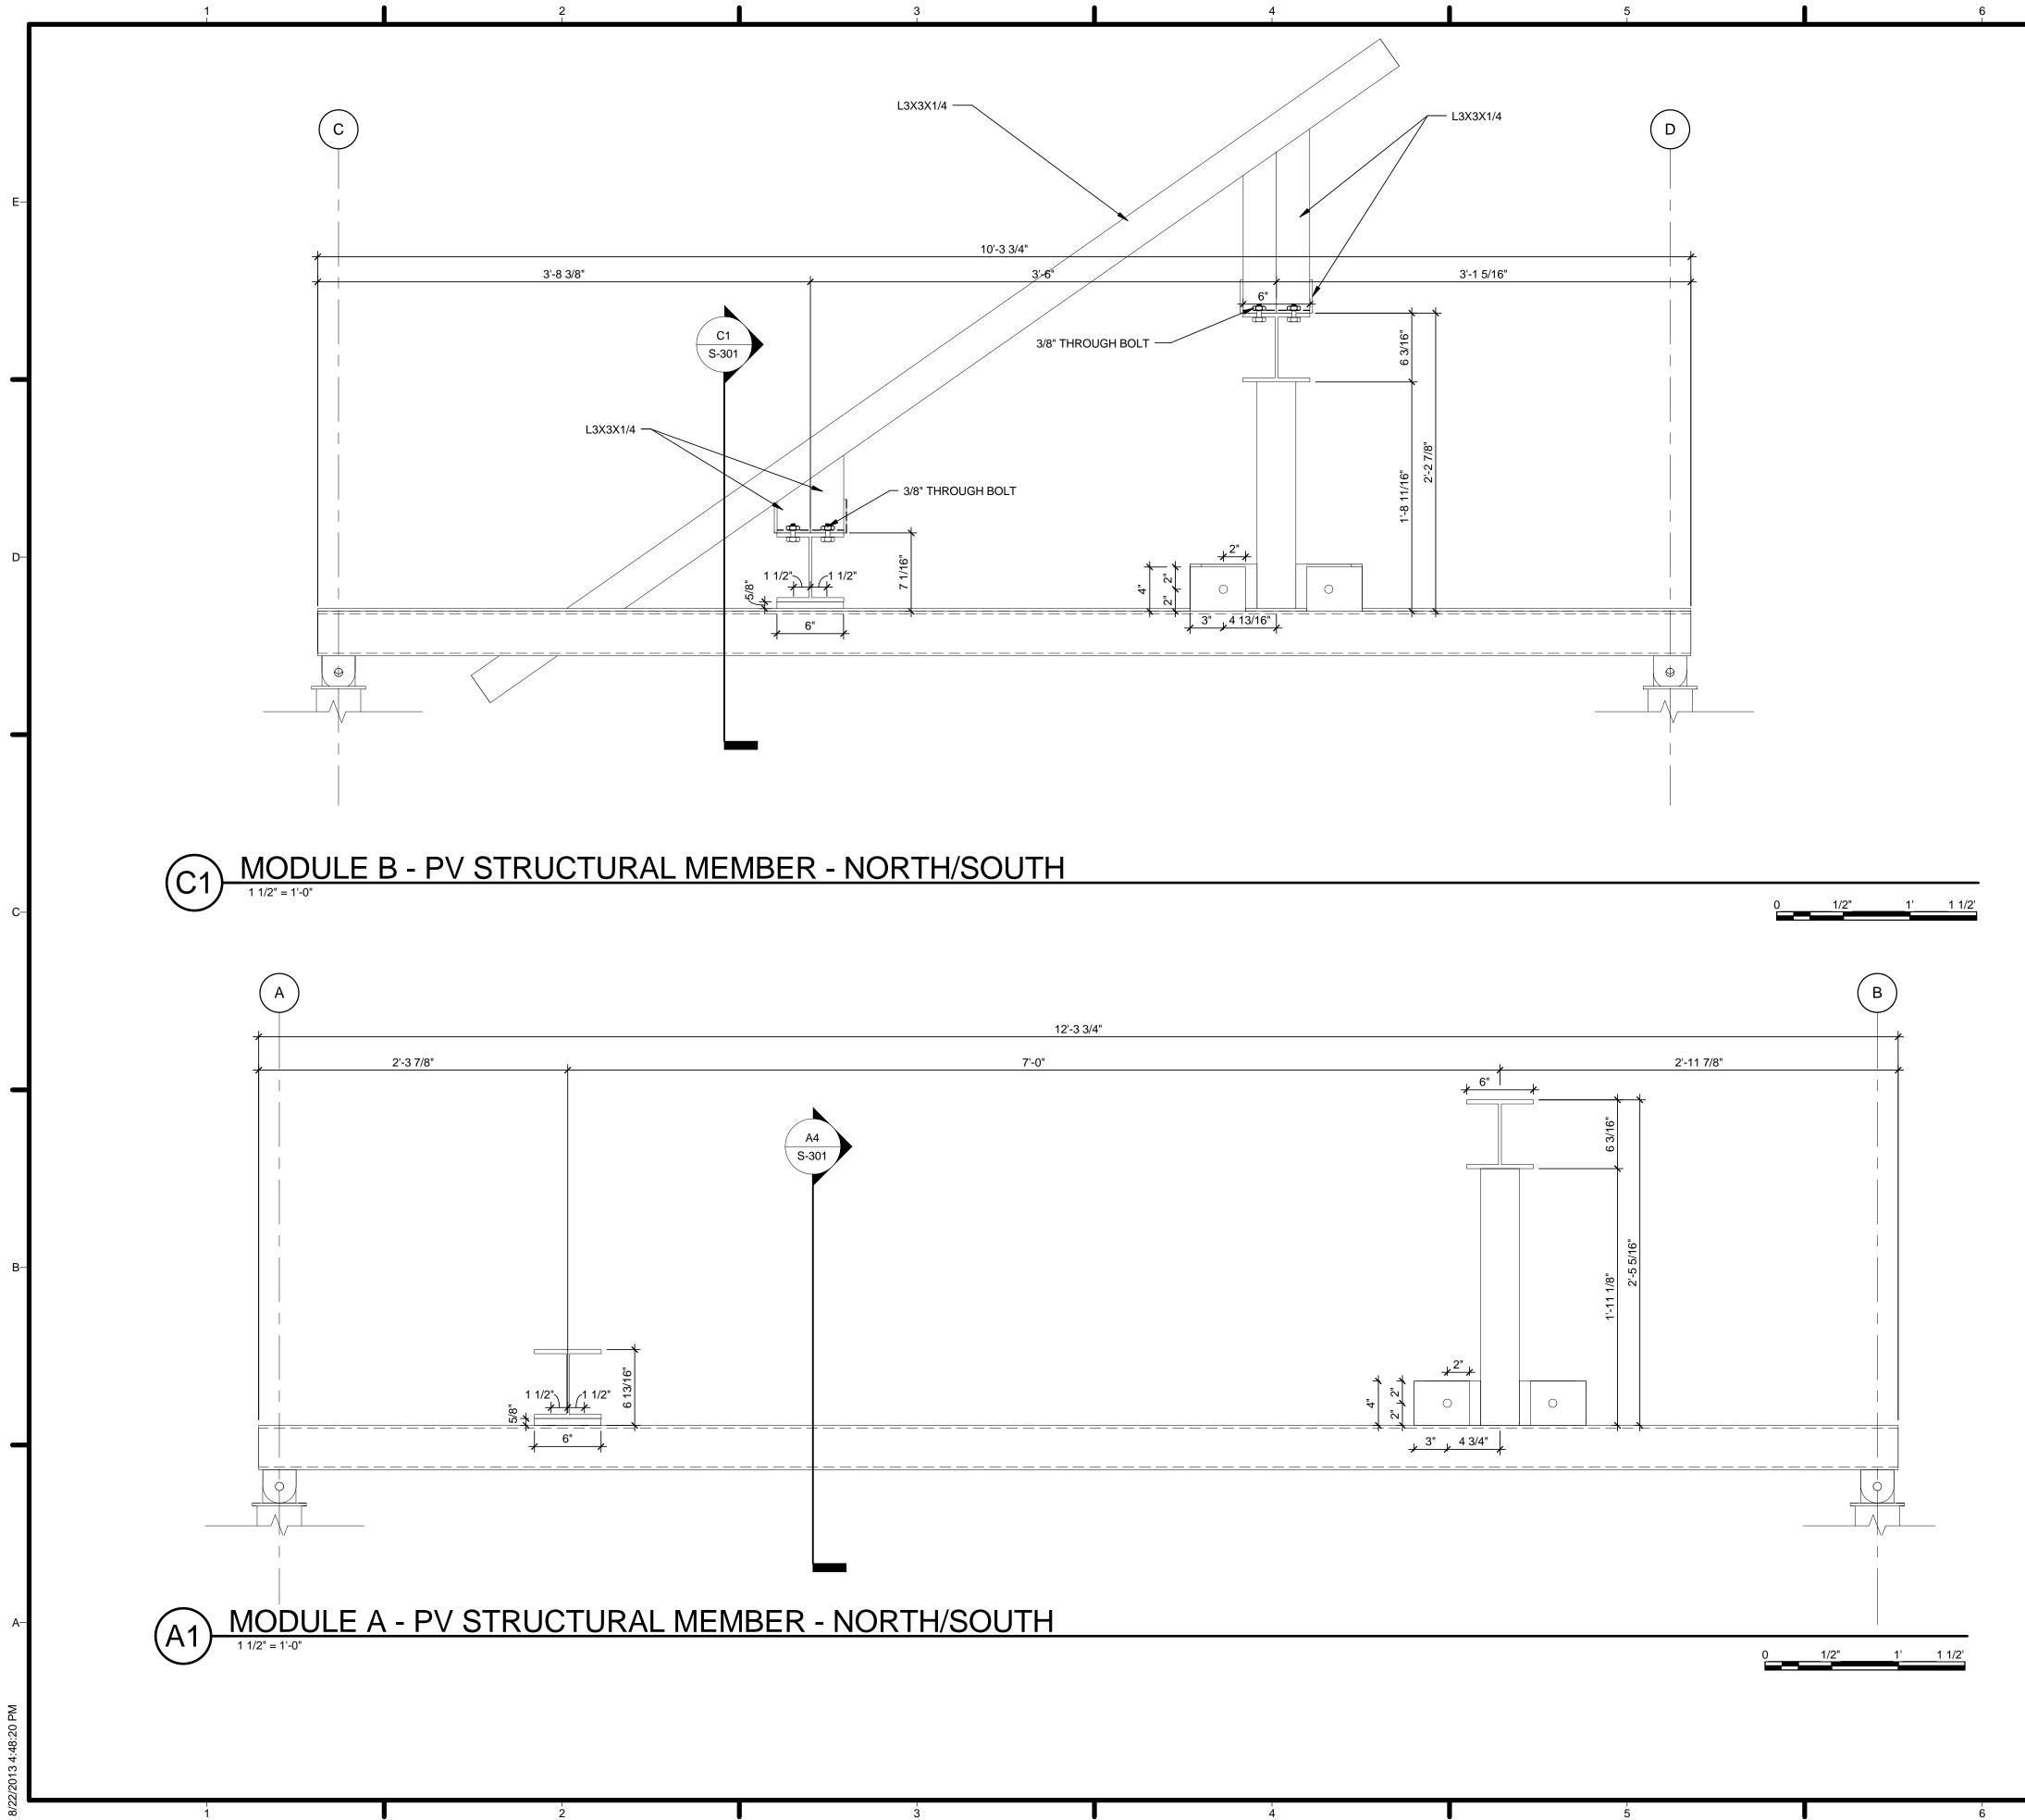




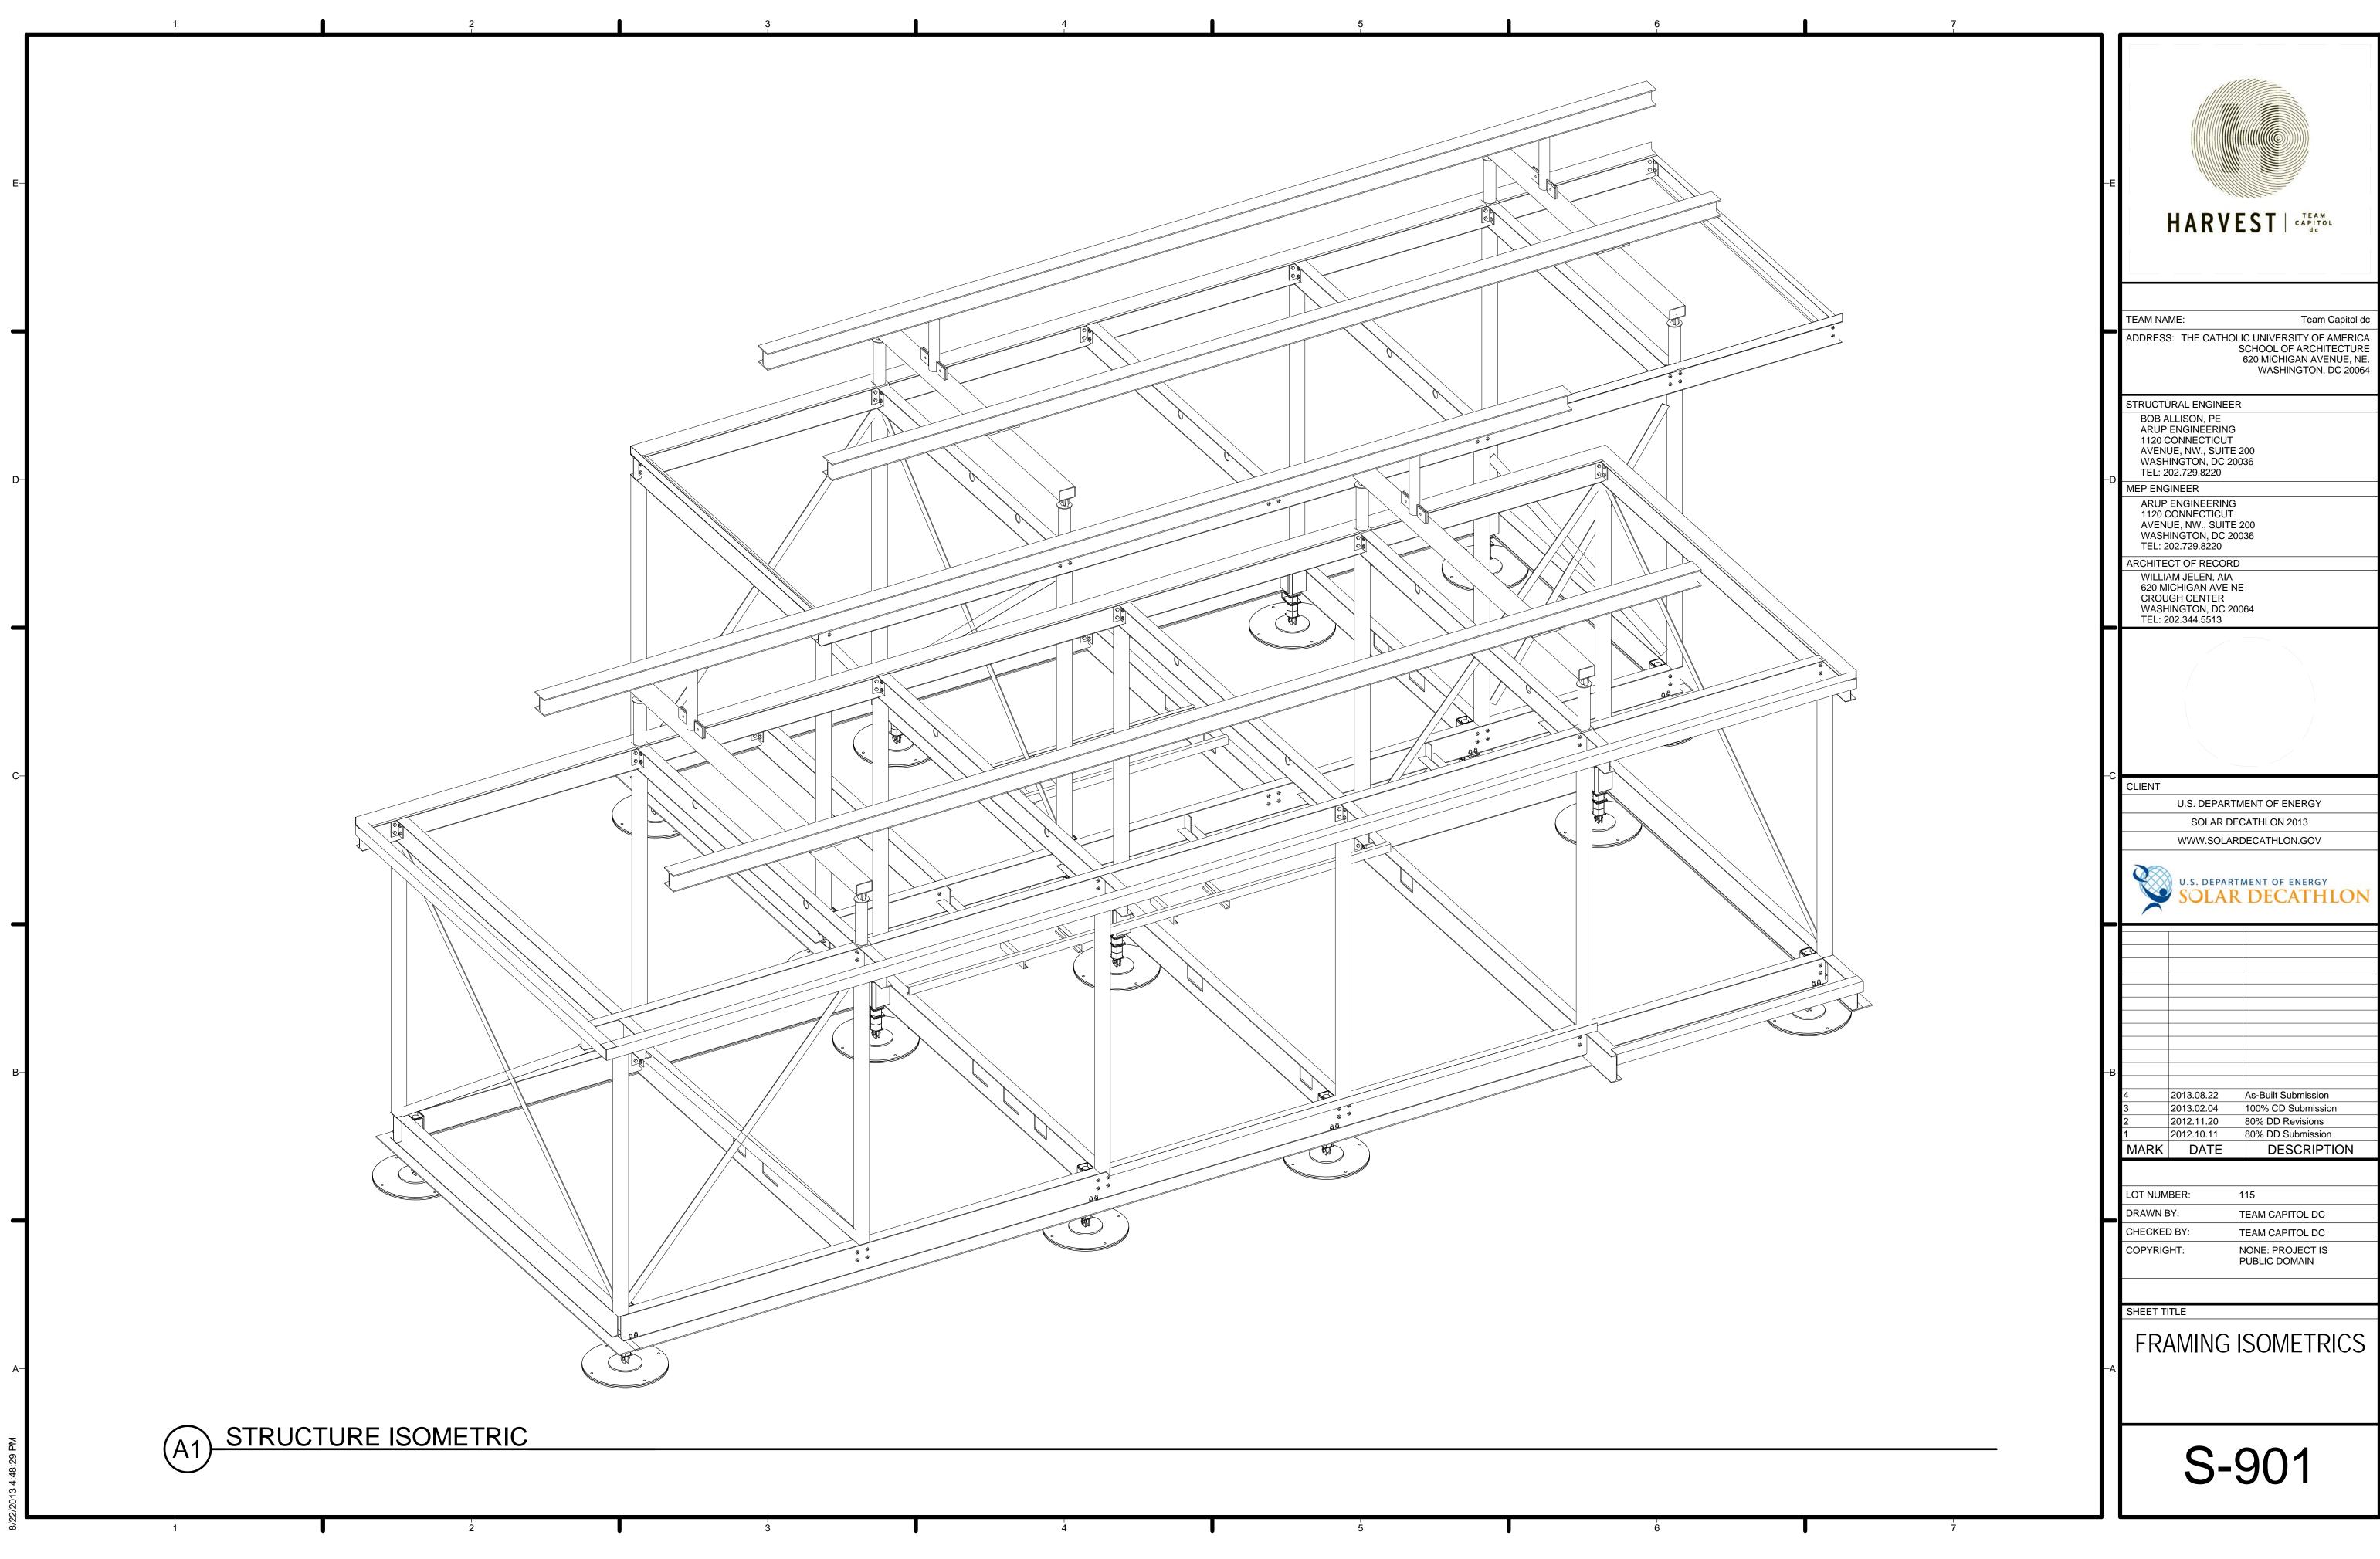


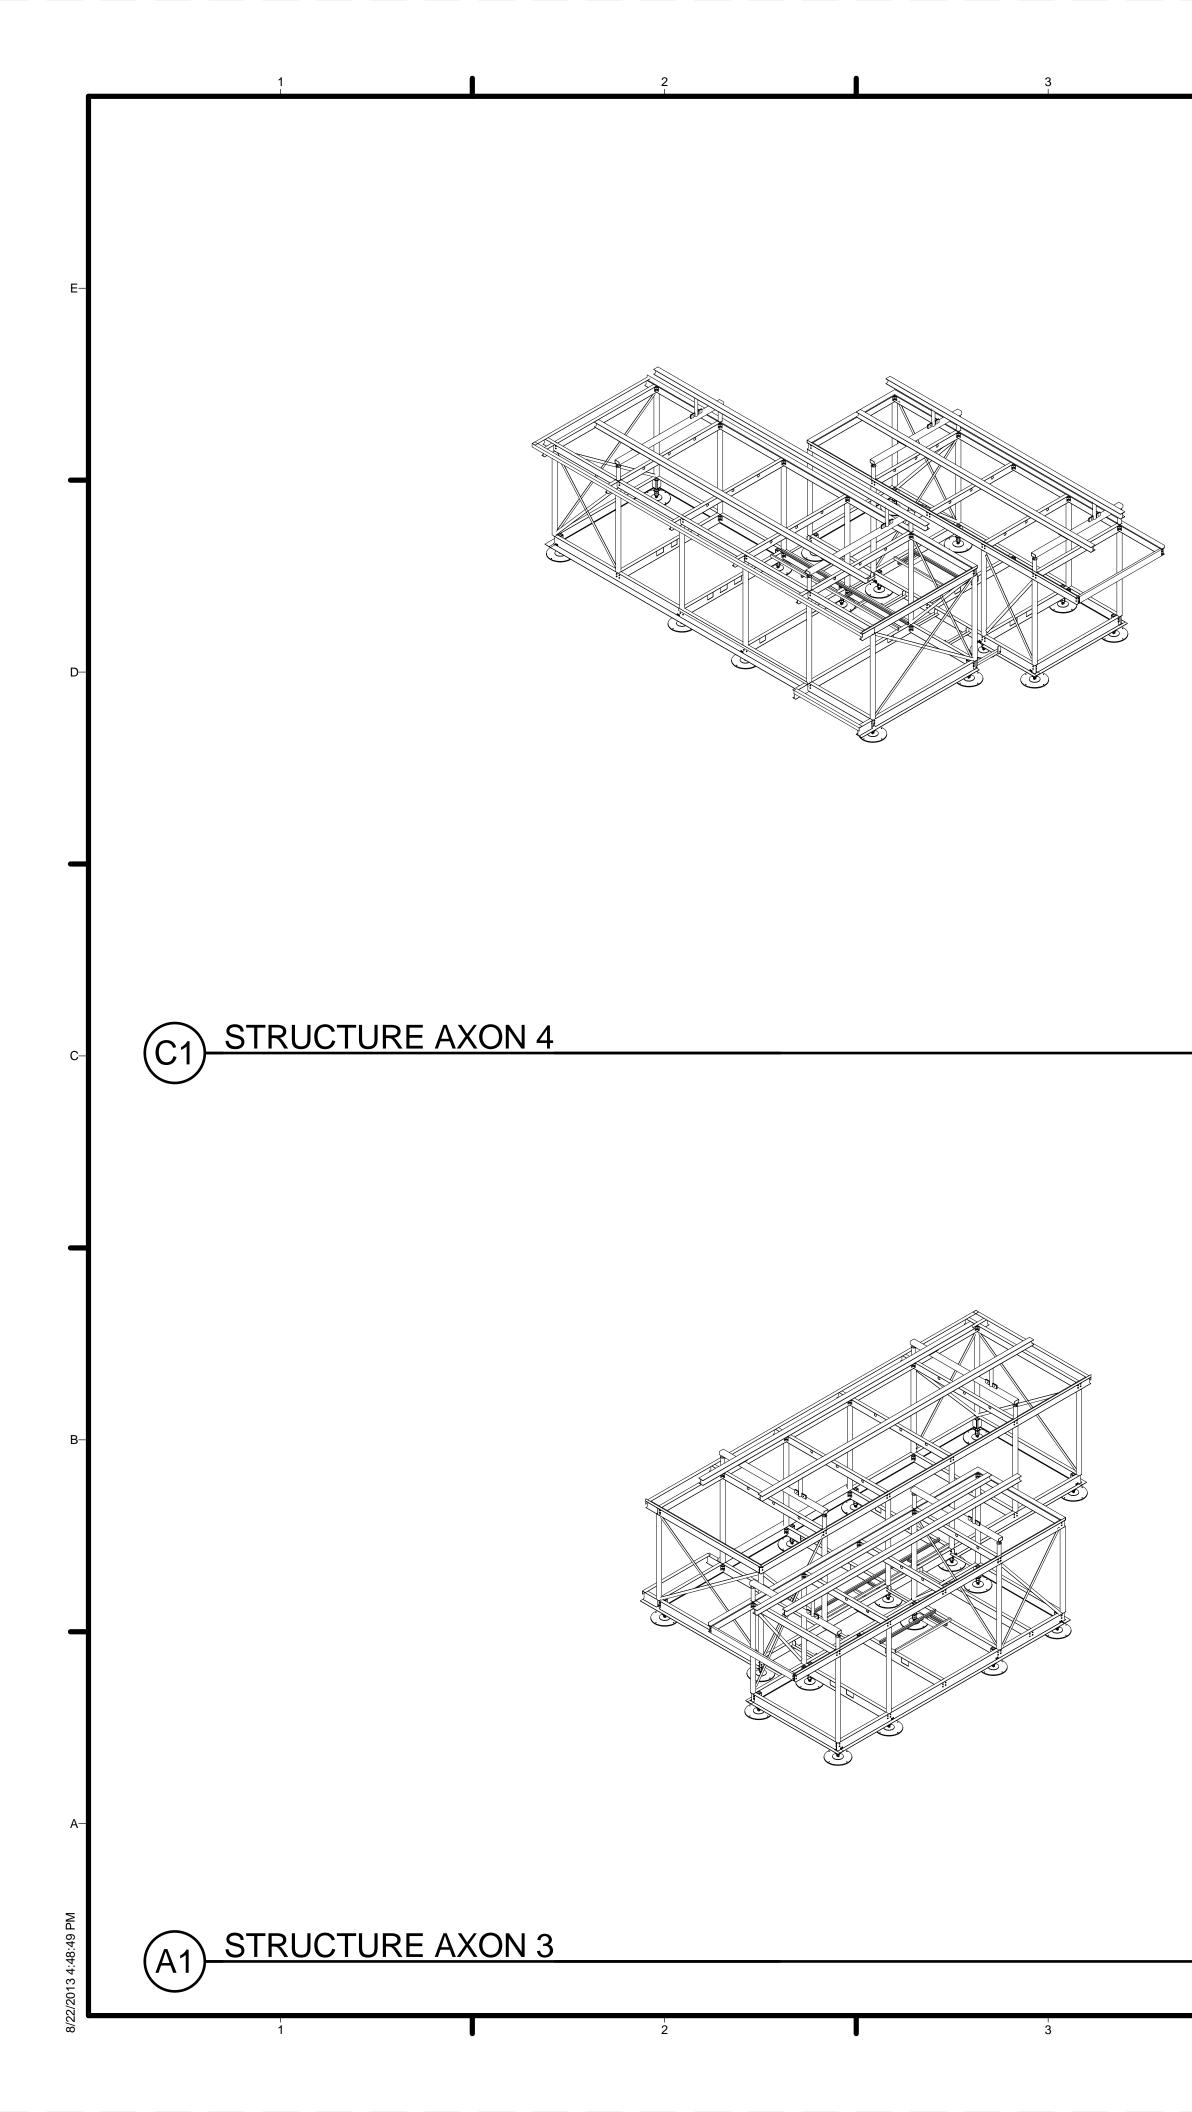


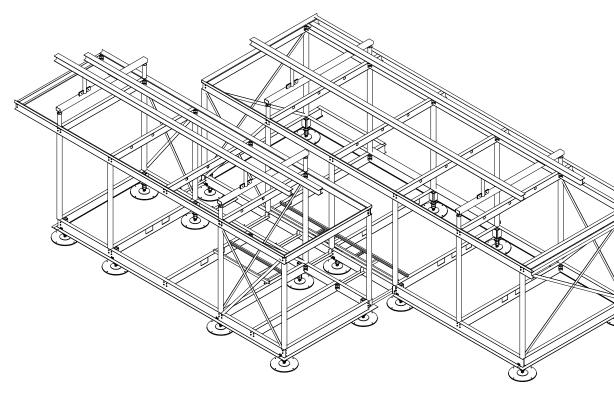
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GENERAL SHEET NOTES	
1/2" RADIUS AROUND EDGES OF OPENINGS IN BEAMS	-E HARVEST CAPITOL dc
REFERENCE KEYNOTES	TEAM NAME: Team Capitol dc ADDRESS: THE CATHOLIC UNIVERSITY OF AMERICA SCHOOL OF ARCHITECTURE 620 MICHIGAN AVENUE, NE. WASHINGTON, DC 20064
	STRUCTURAL ENGINEER BOB ALLISON, PE ARUP ENGINEERING 1120 CONNECTICUT AVENUE, NW., SUITE 200 WASHINGTON, DC 20036 TEL: 202.729.8220 MEP ENGINEER ARUP ENGINEERING 1120 CONNECTICUT AVENUE, NW., SUITE 200 WASHINGTON, DC 20036 TEL: 202.729.8220 ARCHITECT OF RECORD WILLIAM JELEN, AIA 620 MICHIGAN AVE NE CROUGH CENTER WASHINGTON, DC 20064 TEL: 202.344.5513
	-C CLIENT U.S. DEPARTMENT OF ENERGY
	SOLAR DECATHLON 2013
SHEET KEYNOTES	WWW.SOLARDECATHLON.GOV
	B A 2013.08.22 As-Built Submission 3 2013.02.04 100% CD Submission 2 2012.11.20 80% DD Revisions 1 2012.10.11 80% DD Submission MARK DATE DESCRIPTION
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	SHEET TITLE BEAM OPENINGS
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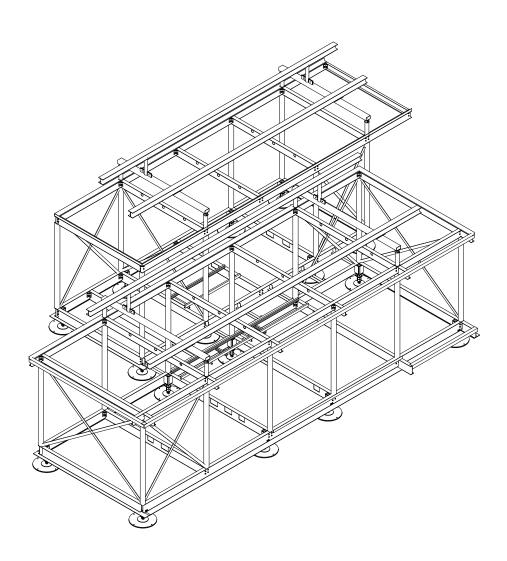
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GENERAL SHEET NOTES	
	-E HARVEST CAPITOL dc
REFERENCE KEYNOTES	TEAM NAME: Team Capitol do ADDRESS: THE CATHOLIC UNIVERSITY OF AMERICA SCHOOL OF ARCHITECTURE 620 MICHIGAN AVENUE, NE WASHINGTON, DC 20064
	BOB ALLISON, PE ARUP ENGINEERING 1120 CONNECTICUT AVENUE, NW., SUITE 200 WASHINGTON, DC 20036 TEL: 202.729.8220 MEP ENGINEER
	ARUP ENGINEERING 1120 CONNECTICUT AVENUE, NW., SUITE 200 WASHINGTON, DC 20036 TEL: 202.729.8220 ARCHITECT OF RECORD WILLIAM JELEN, AIA 620 MICHIGAN AVE NE CROUGH CENTER
	WASHINGTON, DC 20064 TEL: 202.344.5513
	-C CLIENT
	U.S. DEPARTMENT OF ENERGY SOLAR DECATHLON 2013
SHEET KEYNOTES	WWW.SOLARDECATHLON.GOV
	U.S. DEPARTMENT OF ENERGY SOLAR DECATHLON
	-В 4 2013.08.22 As-Built Submission 3 2013.02.04 100% CD Submission
	3 2013.02.04 100% CD Submission 2 2012.11.20 80% DD Revisions 1 2012.10.11 80% DD Submission MARK DATE DESCRIPTION
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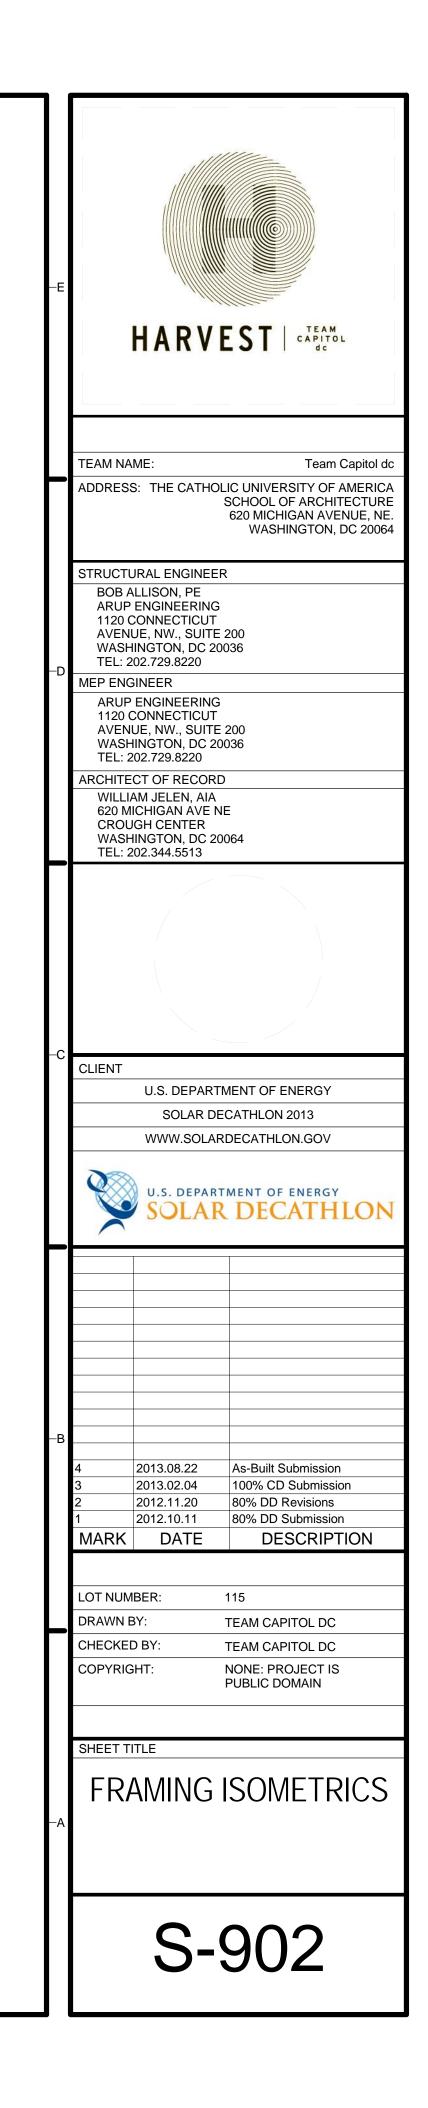




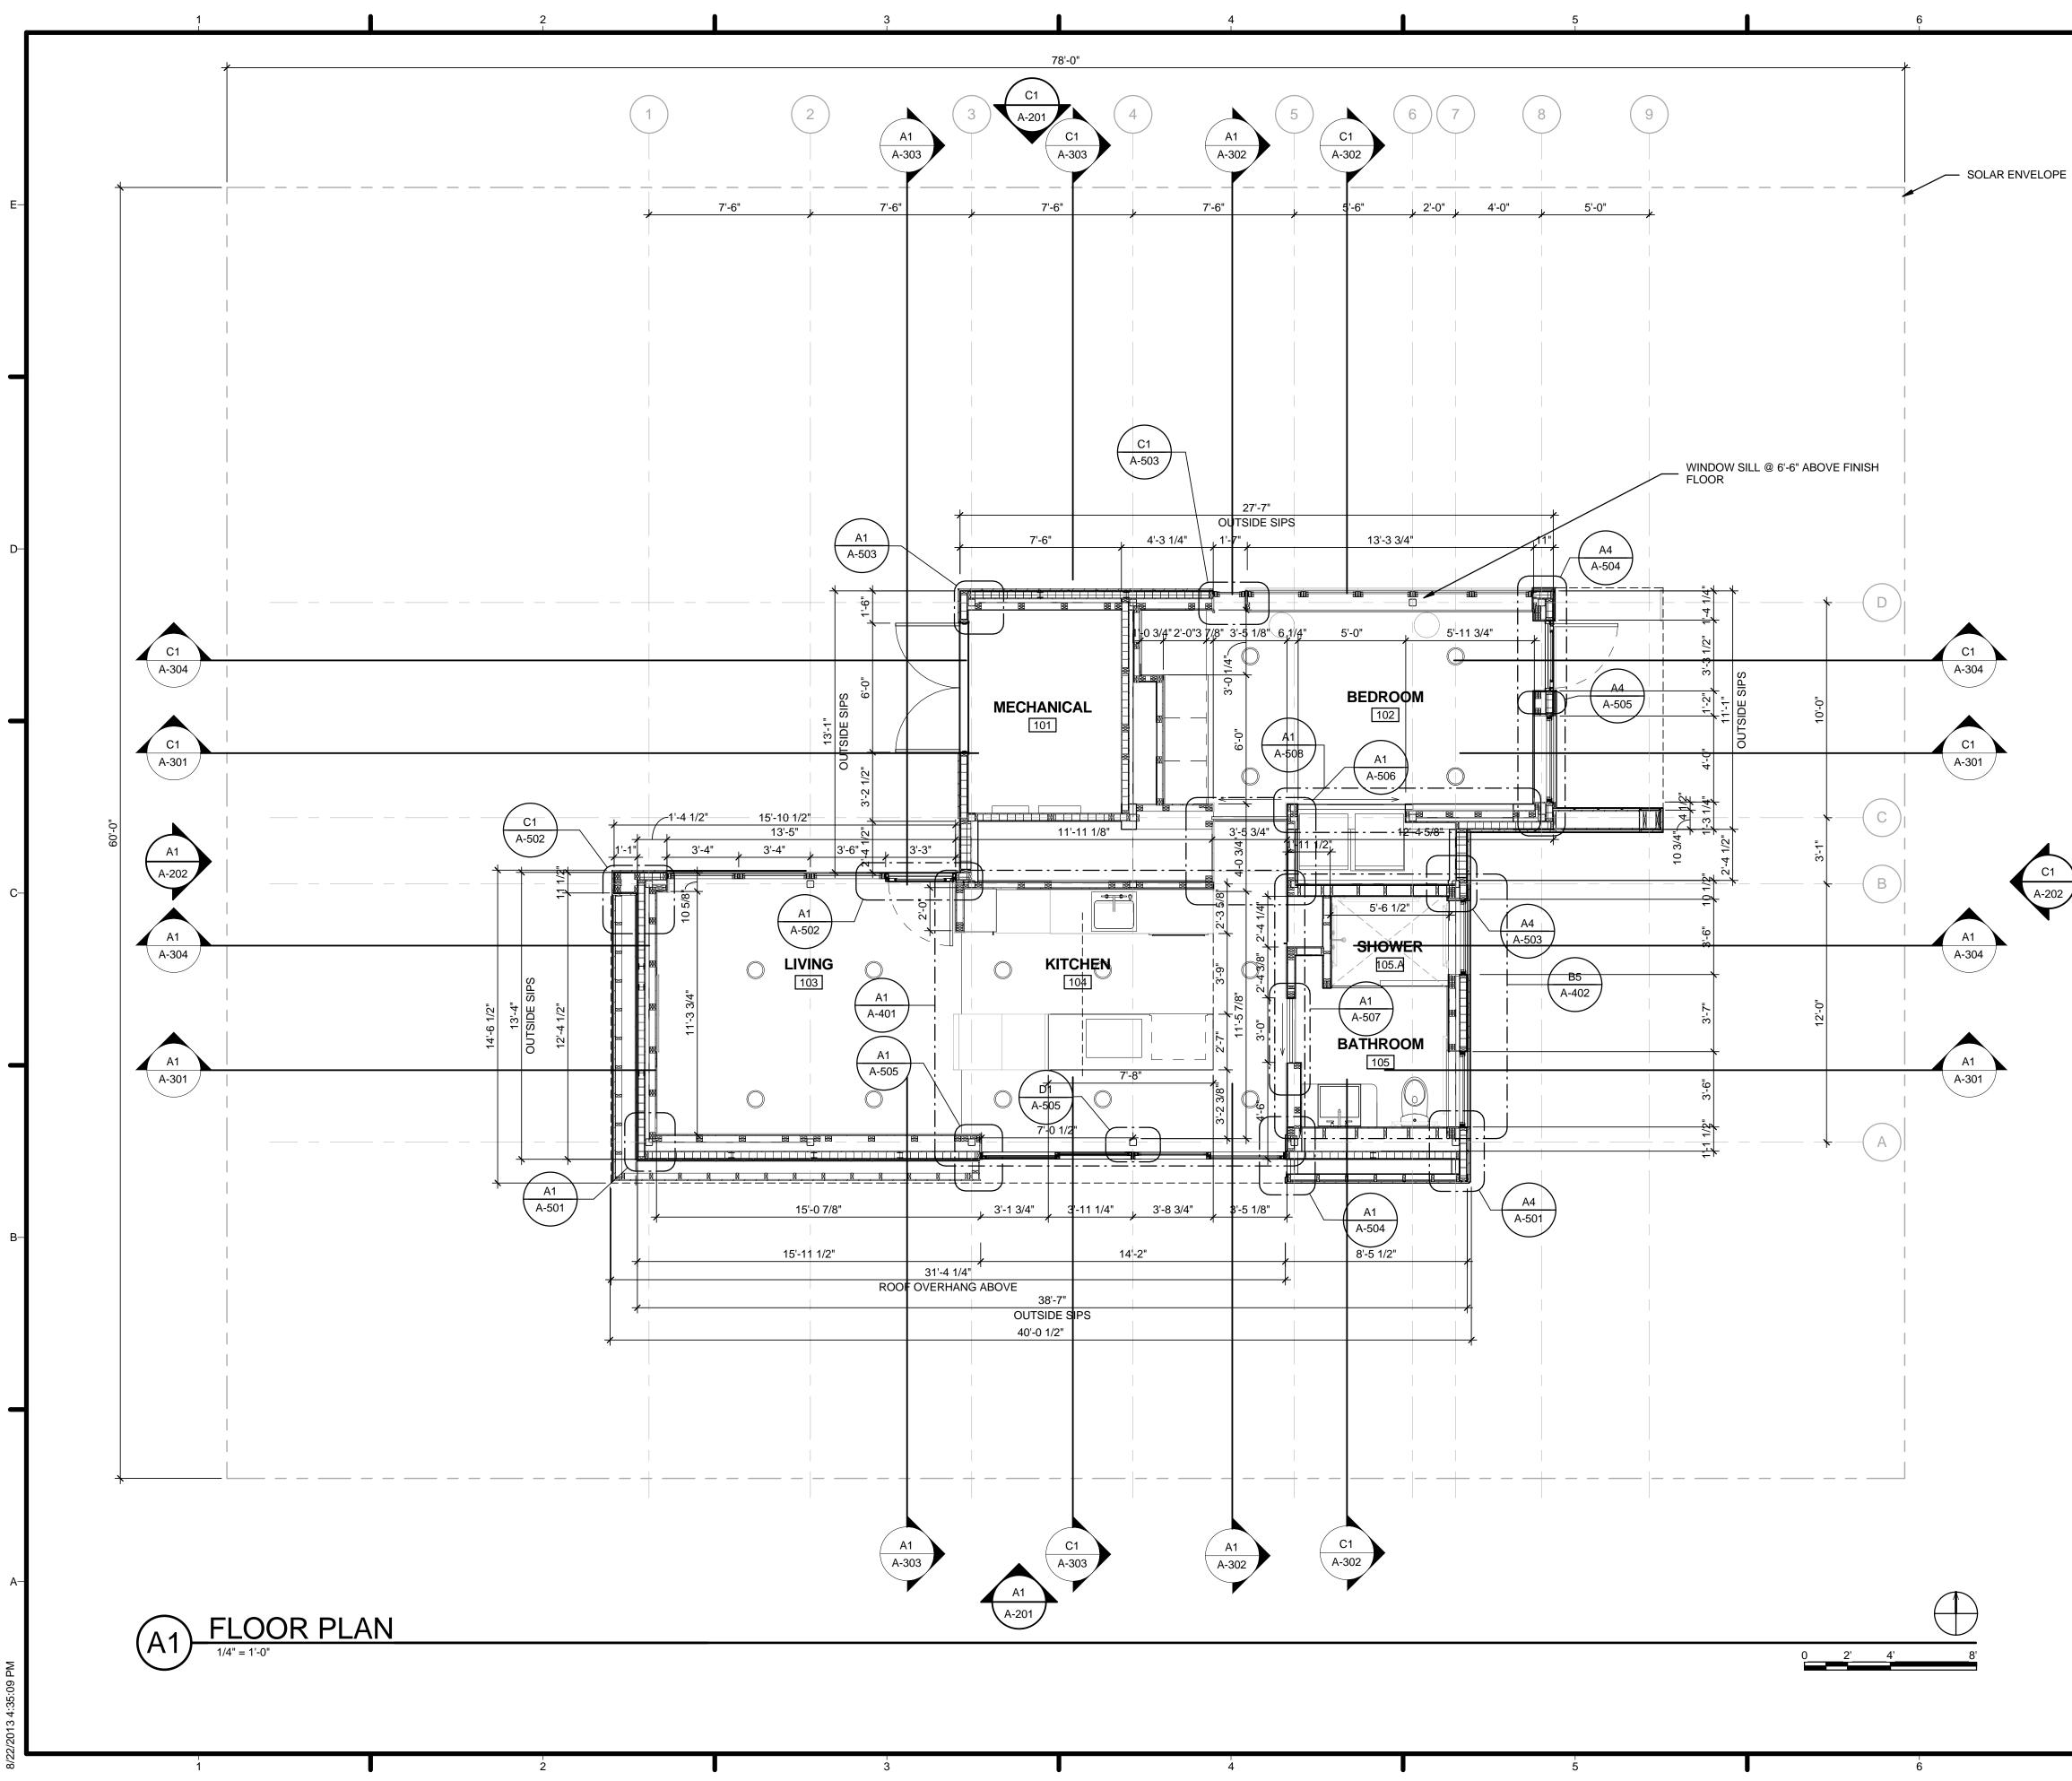




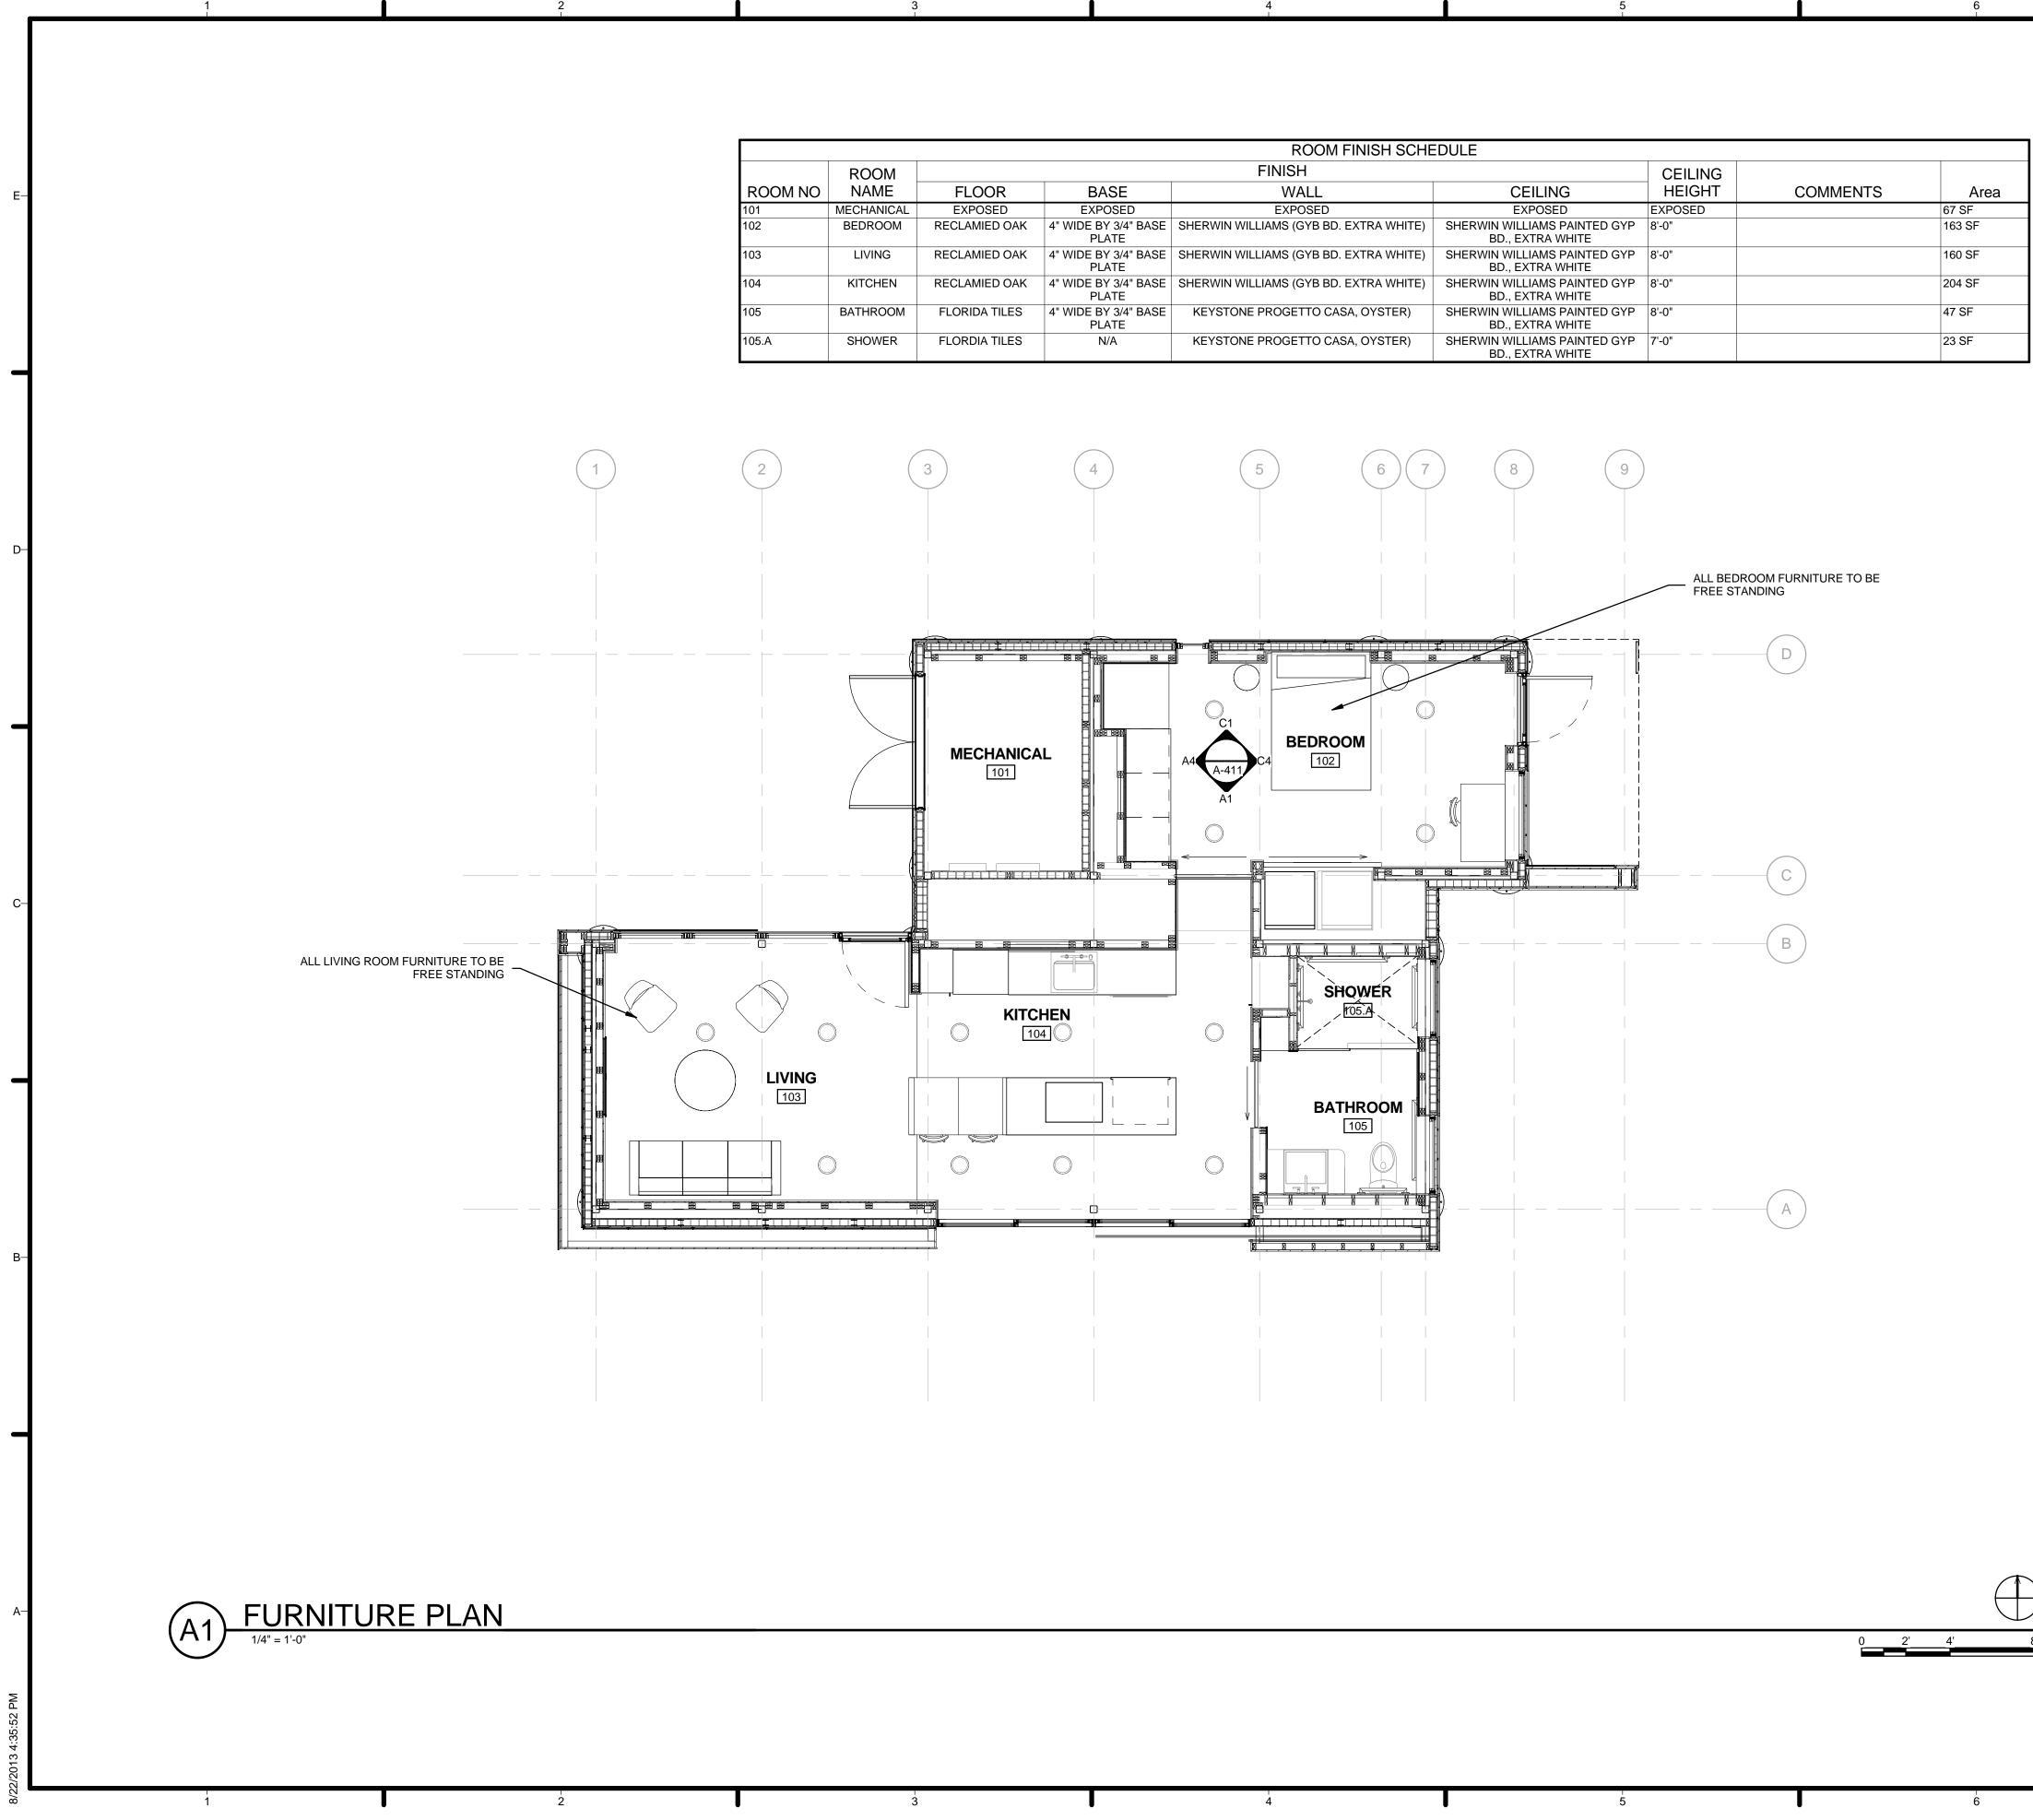




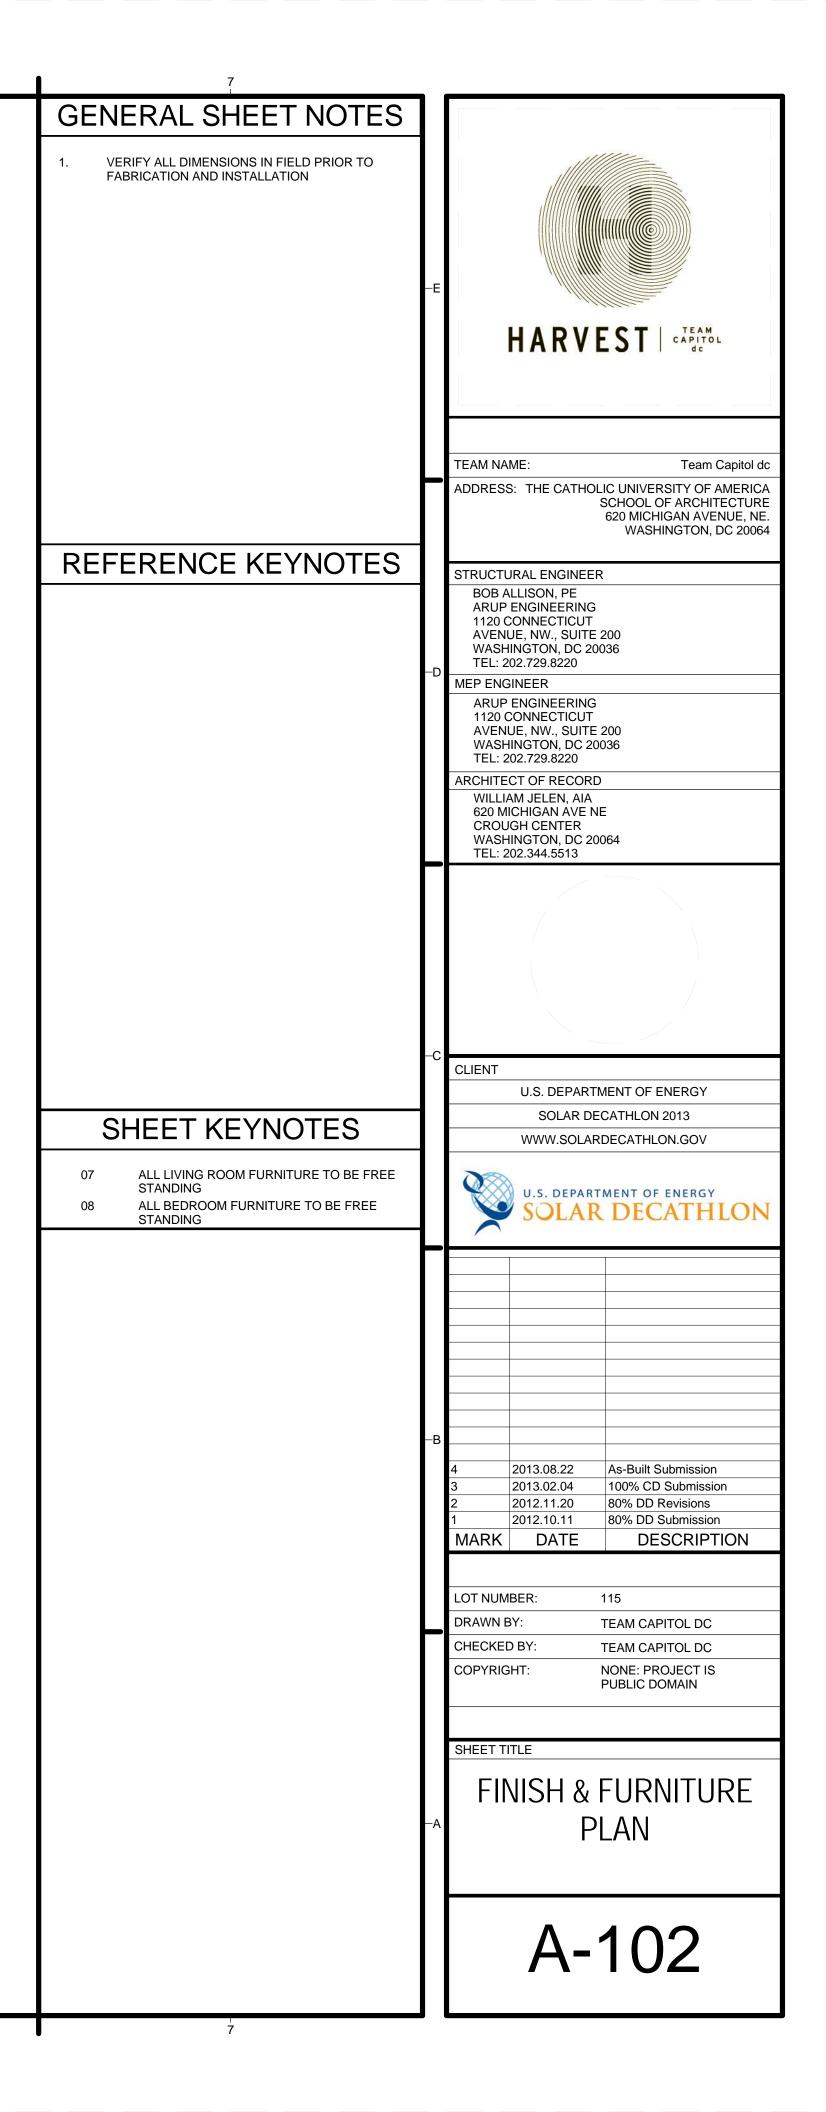


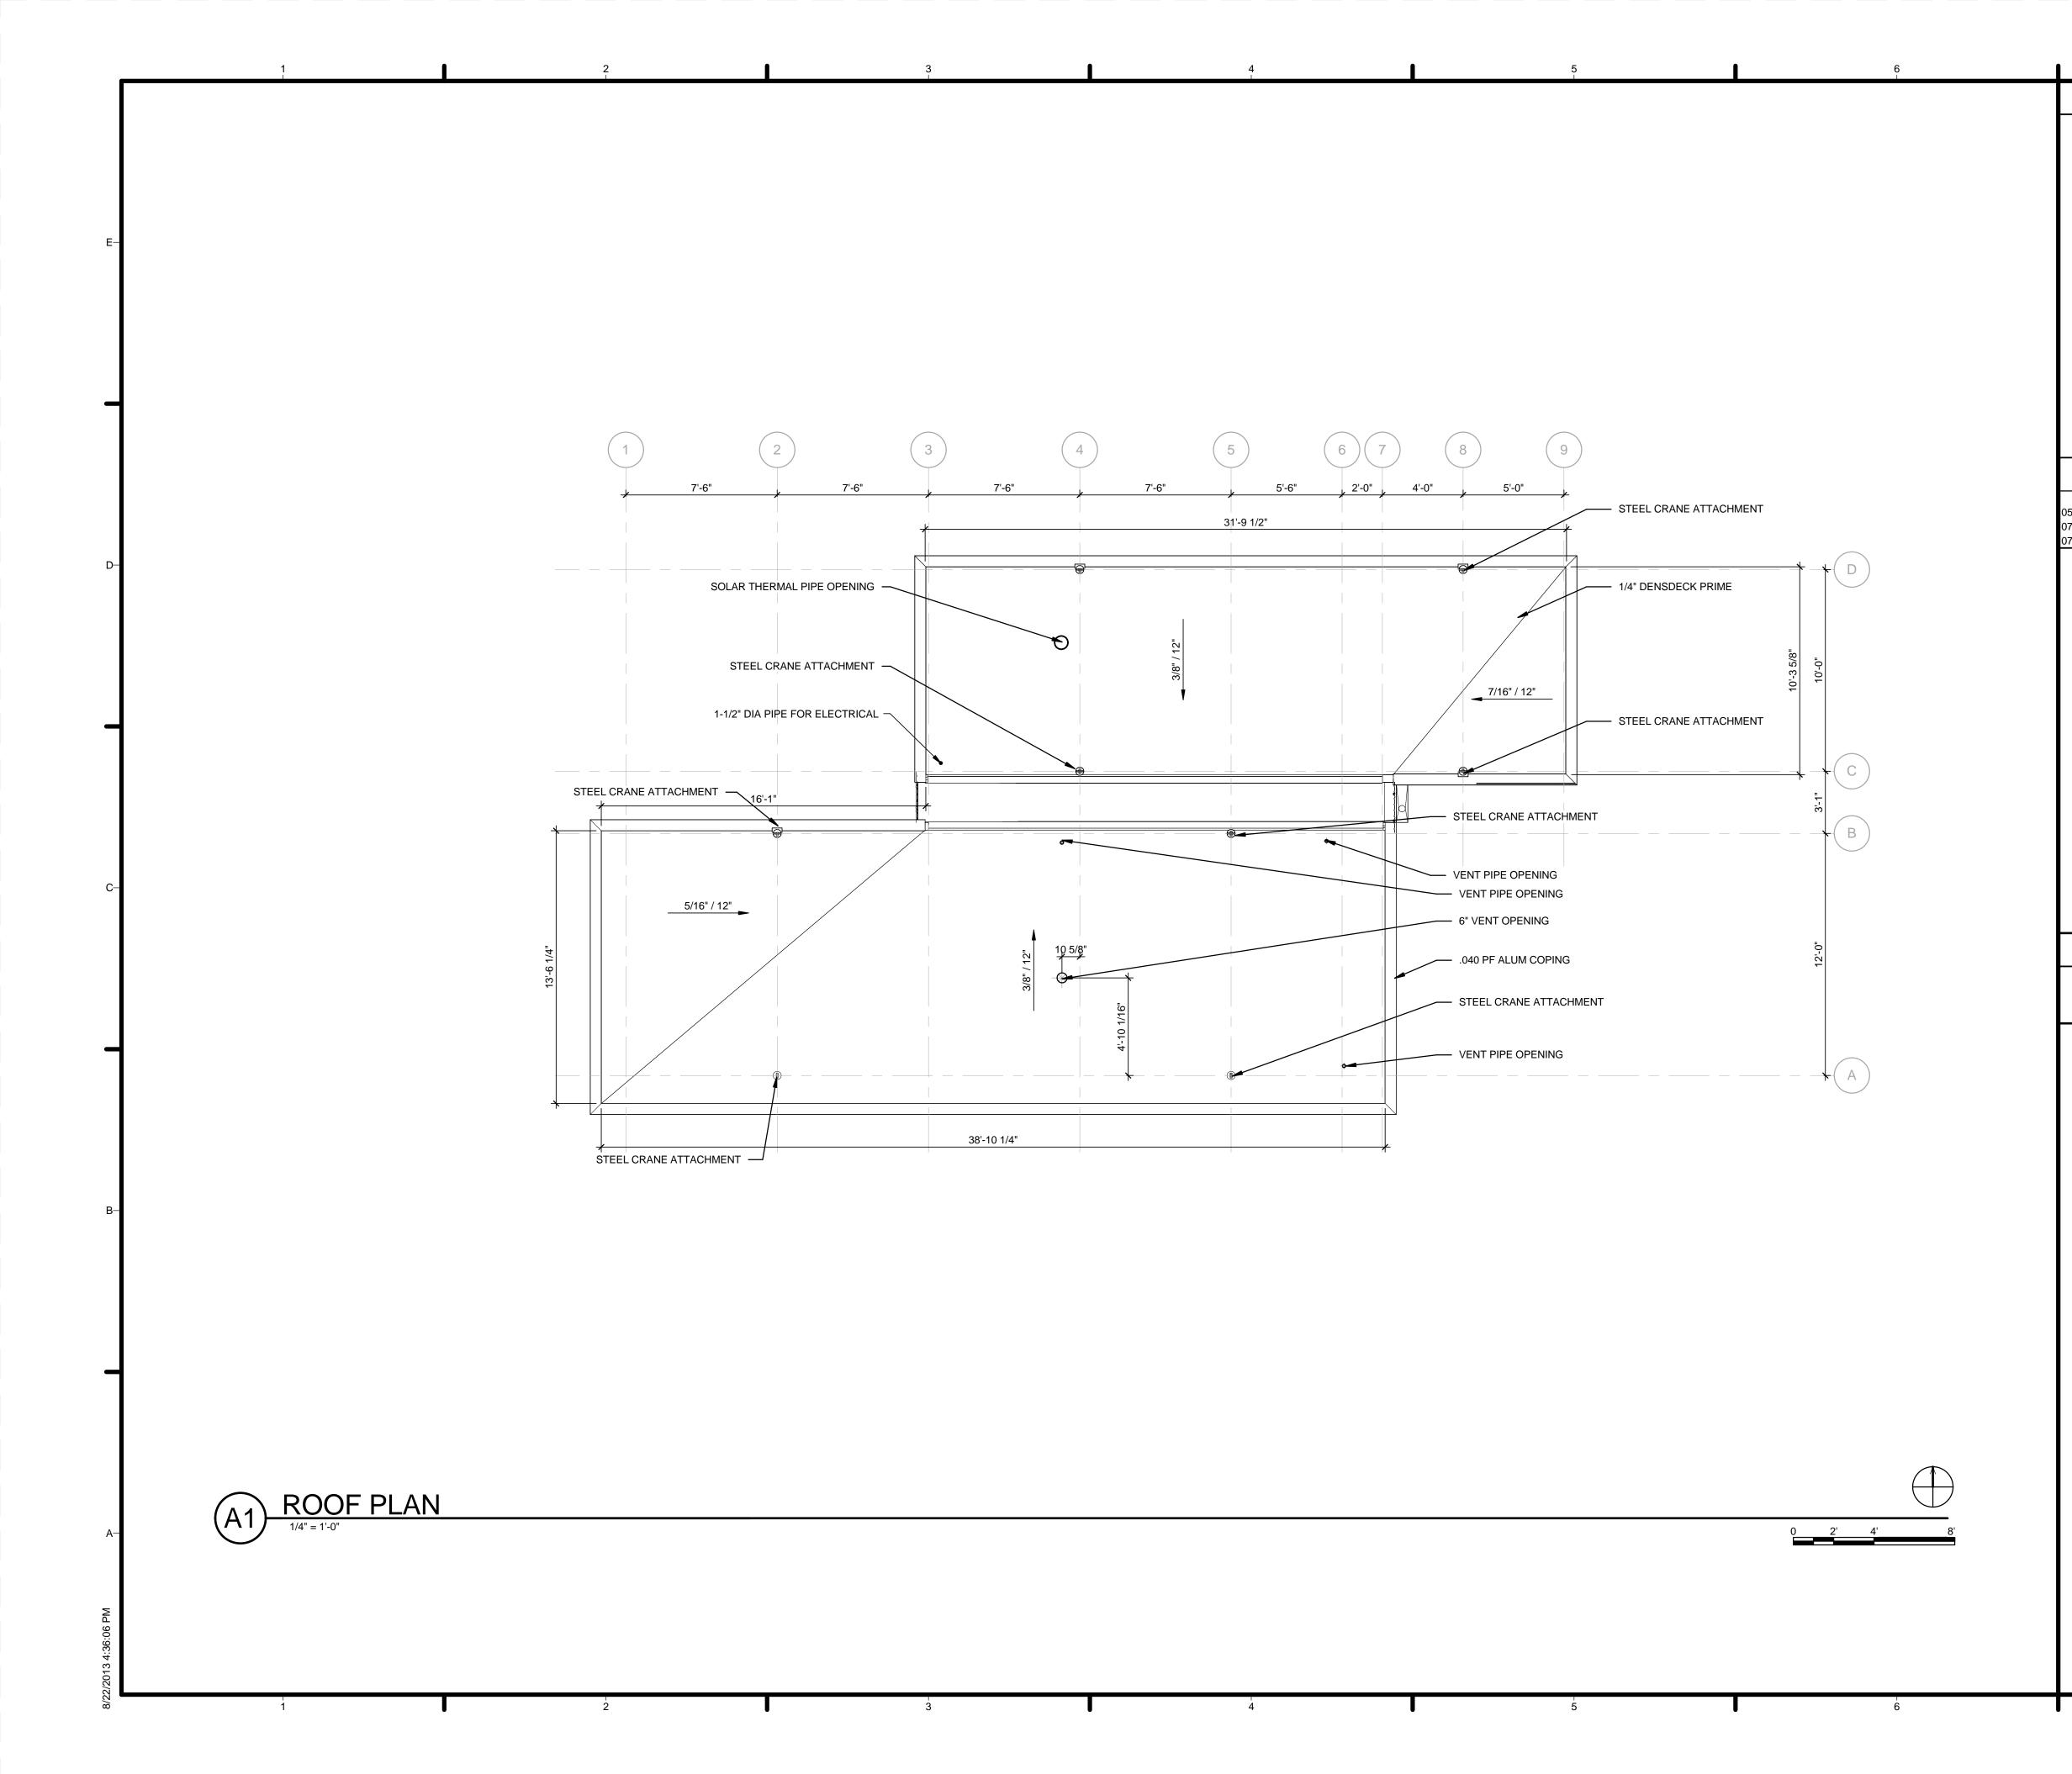


DPE	 GENERAL SHEET NOTES 1. VERIFY ALL DIMENSIONS IN FIELD PRIOR TO FABRICATION AND INSTALLATION 2. SEE S-101 FOR FOOTING PLAN 	-H	TEAM NAME: Team Capitol dc TEAM NAME: Team Capitol dc ADDRESS: THE CATHOLIC UNIVERSITY OF AMERICA SCHOOL OF ARCHITECTURE SCHOOL OF ARCHITECTURE
	REFERENCE KEYNOTES	—D	620 MICHIGAN AVENUE, NE. WASHINGTON, DC 20064STRUCTURAL ENGINEERBOB ALLISON, PE ARUP ENGINEERING 1120 CONNECTICUT
	21 SOLAR ENVELOPE 31 WINDOW SILL @ 6'-6" ABOVE FINISH FLOOR	-c	CLIENT U.S. DEPARTMENT OF ENERGY SOLAR DECATHLON 2013 WWW.SOLARDECATHLON.GOV U.S. DEPARTMENT OF ENERGY SOLAR DECATHLON
		-B	Image: Second system Image: Second system Image: Second
		—A	SHEET TITLE FLOOR PLAN A-101

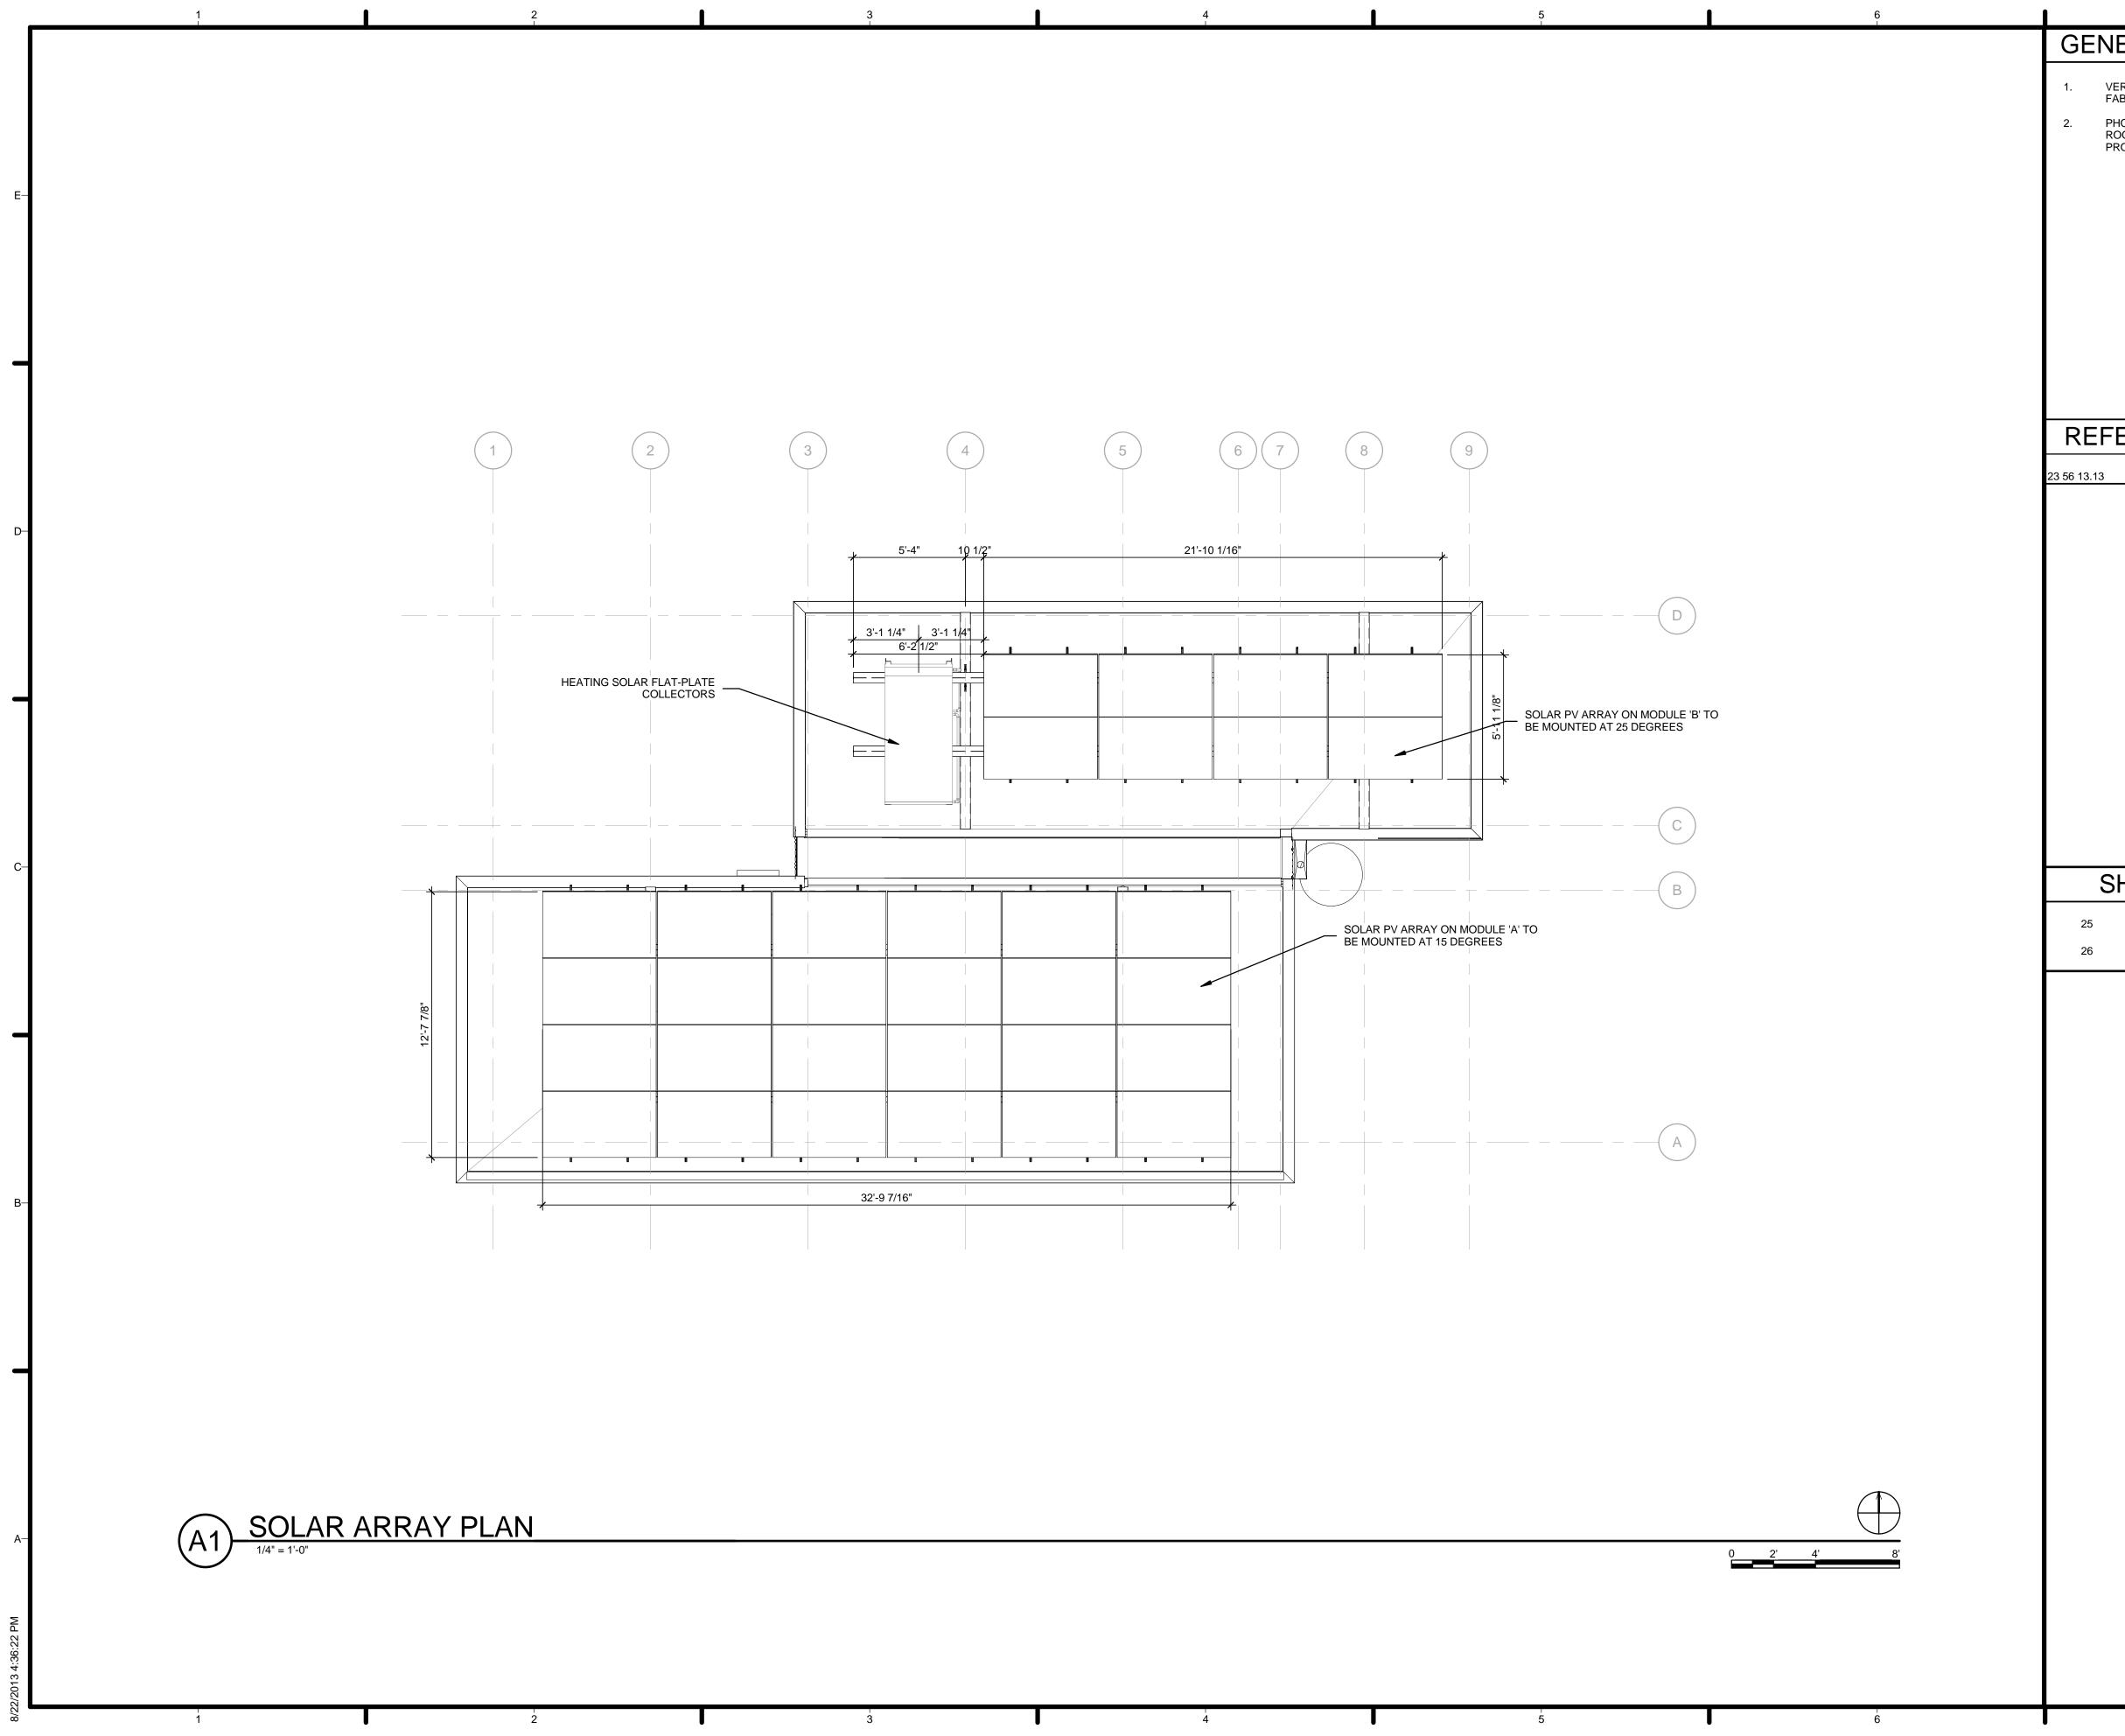


		ROOM FINISH SCHE	EDULE			
		FINISH		CEILING		
R	BASE	WALL	CEILING	HEIGHT	COMMENTS	Area
ED	EXPOSED	EXPOSED	EXPOSED	EXPOSED		67 SF
D OAK	4" WIDE BY 3/4" BASE PLATE	SHERWIN WILLIAMS (GYB BD. EXTRA WHITE)	SHERWIN WILLIAMS PAINTED GYP BD., EXTRA WHITE	8'-0"		163 SF
O OAK	4" WIDE BY 3/4" BASE PLATE	SHERWIN WILLIAMS (GYB BD. EXTRA WHITE)	SHERWIN WILLIAMS PAINTED GYP BD., EXTRA WHITE	8'-0"		160 SF
D OAK	4" WIDE BY 3/4" BASE PLATE	SHERWIN WILLIAMS (GYB BD. EXTRA WHITE)	SHERWIN WILLIAMS PAINTED GYP BD., EXTRA WHITE	8'-0"		204 SF
ILES	4" WIDE BY 3/4" BASE PLATE	KEYSTONE PROGETTO CASA, OYSTER)	SHERWIN WILLIAMS PAINTED GYP BD., EXTRA WHITE	8'-0"		47 SF
TILES	N/A	KEYSTONE PROGETTO CASA, OYSTER)	SHERWIN WILLIAMS PAINTED GYP BD_EXTRA WHITE	7'-0"		23 SF

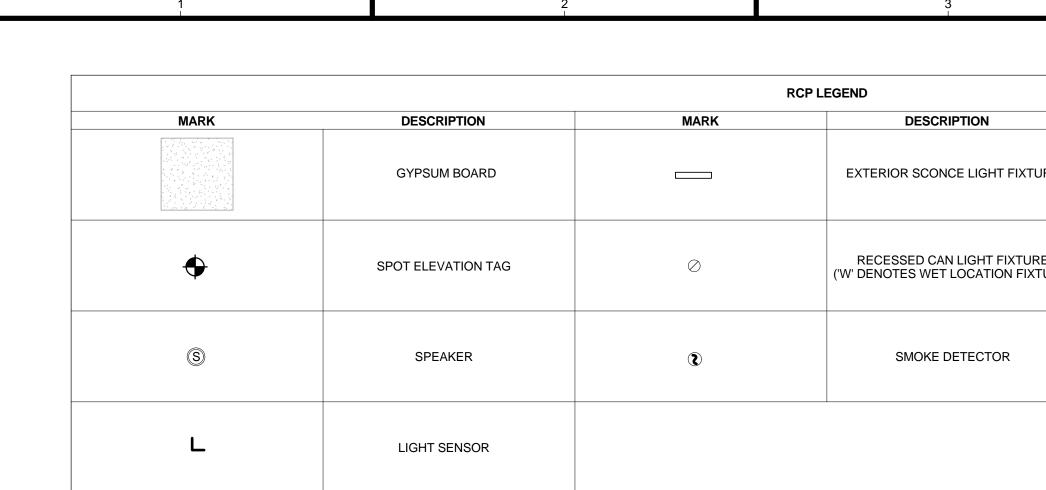




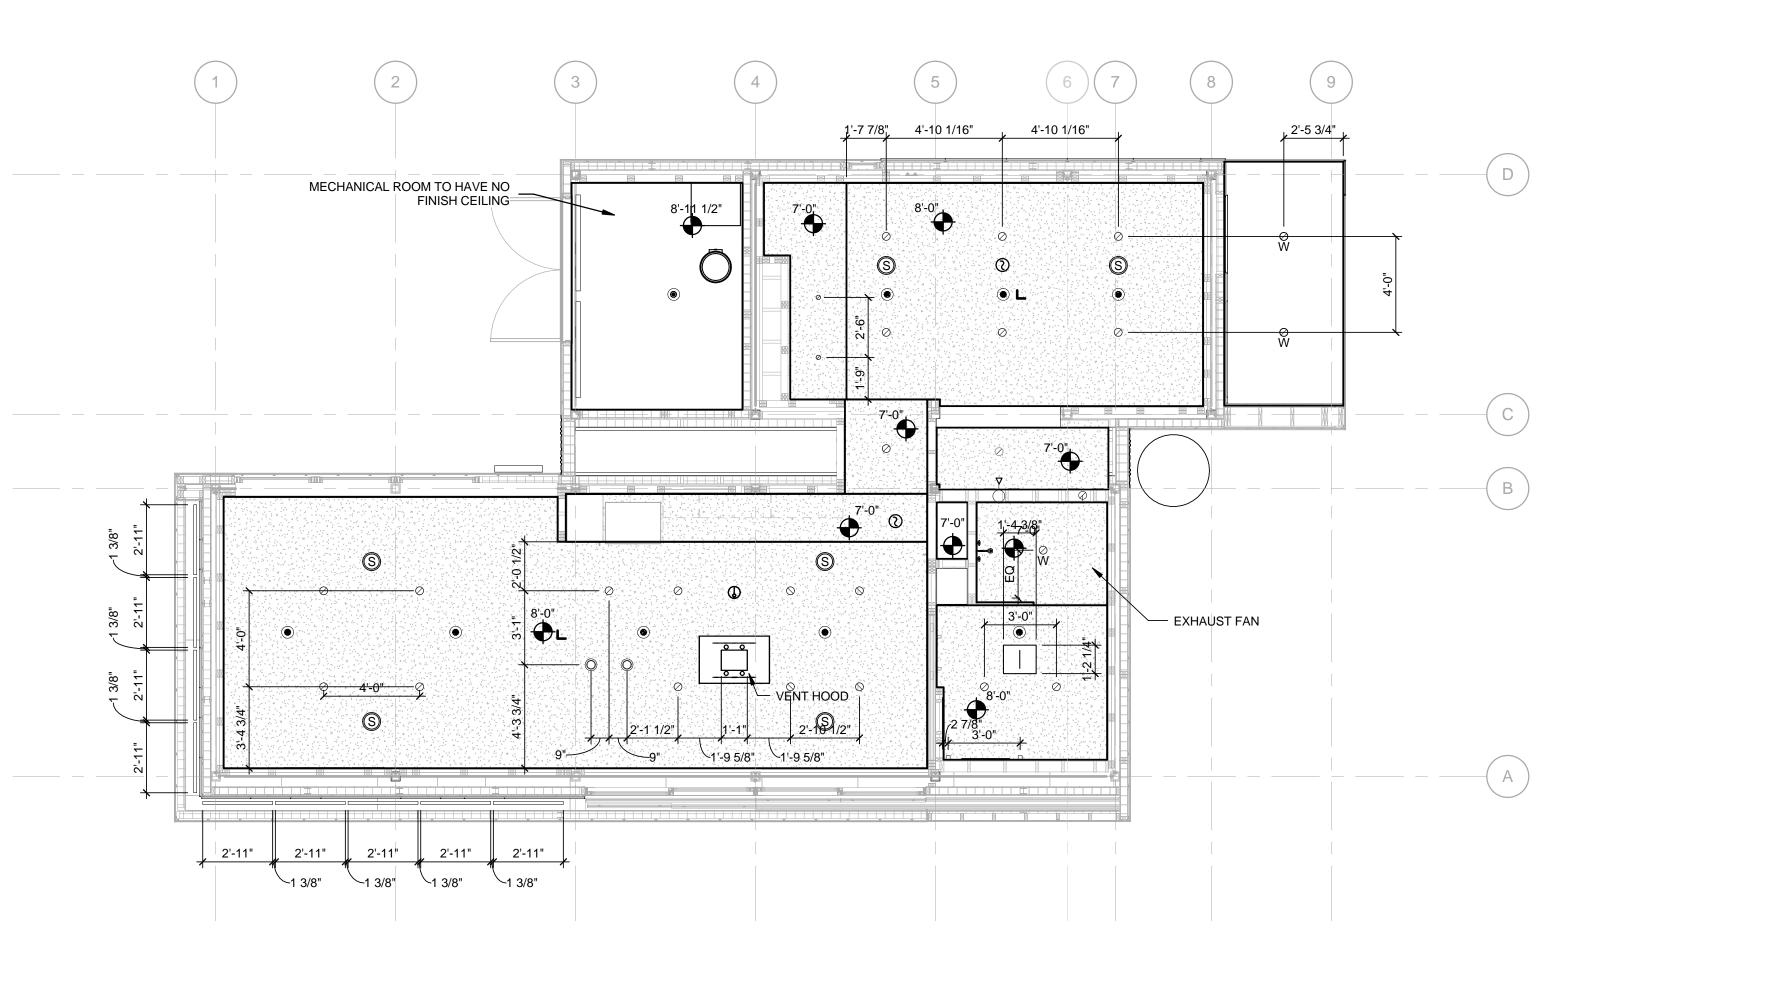
 Server a constraint of the constrai	HARVEST LEAM de
REFERENCE KEYNOTES 05 12 23.D1 STEEL CRANE ATTACHMENT	TEAM NAME: Team Capitol dc ADDRESS: THE CATHOLIC UNIVERSITY OF AMERICA SCHOOL OF ARCHITECTURE 620 MICHIGAN AVENUE, NE. WASHINGTON, DC 20064 STRUCTURAL ENGINEER BOB ALLISON, PE ARUP ENGINEERING 1120 CONNECTICUT
07 62 00.A5 .040 PF ALUM COPING 07 71 14 1/4" DENSDECK PRIME	AVENUE, NW., SUITE 200 WASHINGTON, DC 20036 TEL: 202.729.8220 MEP ENGINEER ARUP ENGINEERING 1120 CONNECTICUT AVENUE, NW., SUITE 200 WASHINGTON, DC 20036 TEL: 202.729.8220 ARCHITECT OF RECORD WILLIAM JELEN, AIA 620 MICHIGAN AVE NE
	CROUGH CENTER WASHINGTON, DC 20064 TEL: 202.344.5513
SHEET KEYNOTES 22 SOLAR THERMAL PIPE OPENING 23 VENT PIPE OPENING 90 6" VENT OPENING	C CLIENT U.S. DEPARTMENT OF ENERGY SOLAR DECATHLON 2013 WWW.SOLARDECATHLON.GOV U.S. DEPARTMENT OF ENERGY SOLAR DECATHLON
	-В 4 2013.08.22 As-Built Submission
	32013.02.04100% CD Submission22012.11.2080% DD Revisions12012.10.1180% DD SubmissionMARKDATEDESCRIPTIONLOT NUMBER: 115DRAWN BY: TEAM CAPITOL DCCHECKED BY:TEAM CAPITOL DCCOPYRIGHT:NONE: PROJECT IS PUBLIC DOMAIN
	SHEET TITLE ROOF PLAN
7	A-111



GENERAL SHEET NOTES	
 VERIFY ALL DIMENSIONS IN FIELD PRIOR TO FABRICATION AND INSTALLATION PHOTOVOLTAIC ARRAY TO BE SECURED ON ROOF WITH RACK MOUNTING SYSTEM AS PROVIDED BY PV CONSULTANT 	HARVEST
REFERENCE KEYNOTES 23 56 13.13 HEATING SOLAR FLAT-PLATE COLLECTORS	TEAM NAME: Team Capitol dc ADDRESS: THE CATHOLIC UNIVERSITY OF AMERICA SCHOOL OF ARCHITECTURE 620 MICHIGAN AVENUE, NE. WASHINGTON, DC 20064 STRUCTURAL ENGINEER BOB ALLISON, PE ARUP ENGINEERING 1120 CONNECTICUT AVENUE, NW., SUITE 200 WASHINGTON, DC 20036 TEL: 202.729.8220 MEP ENGINEER ARUP ENGINEERING 1120 CONNECTICUT AVENUE, NW., SUITE 200 WASHINGTON, DC 20036 TEL: 202.729.8220 ARCHITECT OF RECORD WILLIAM JELEN, AIA 620 MICHIGAN AVE NE CROUGH CENTER WASHINGTON, DC 20064 TEL: 202.344.5513
SHEET KEYNOTES 25 SOLAR PV ARRAY ON MODULE 'A' TO BE MOUNTED AT 15 DEGREES 26 SOLAR PV ARRAY ON MODULE 'B' TO BE MOUNTED AT 25 DEGREES	C CLIENT U.S. DEPARTMENT OF ENERGY SOLAR DECATHLON 2013 WWW.SOLARDECATHLON.GOV U.S. DEPARTMENT OF ENERGY SOLAR DECATHLON
	-B 4 2013.08.22 As-Built Submission 3 2013.02.04 100% CD Submission 2 2012.11.20 80% DD Revisions 1 2012.10.11 80% DD Submission MARK DATE DESCRIPTION LOT NUMBER: 115 DRAWN BY: TEAM CAPITOL DC CHECKED BY: TEAM CAPITOL DC COPYRIGHT: NONE: PROJECT IS PUBLIC DOMAIN
	BHEET TITLE PV ARRAY PLAN A-112

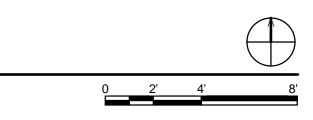


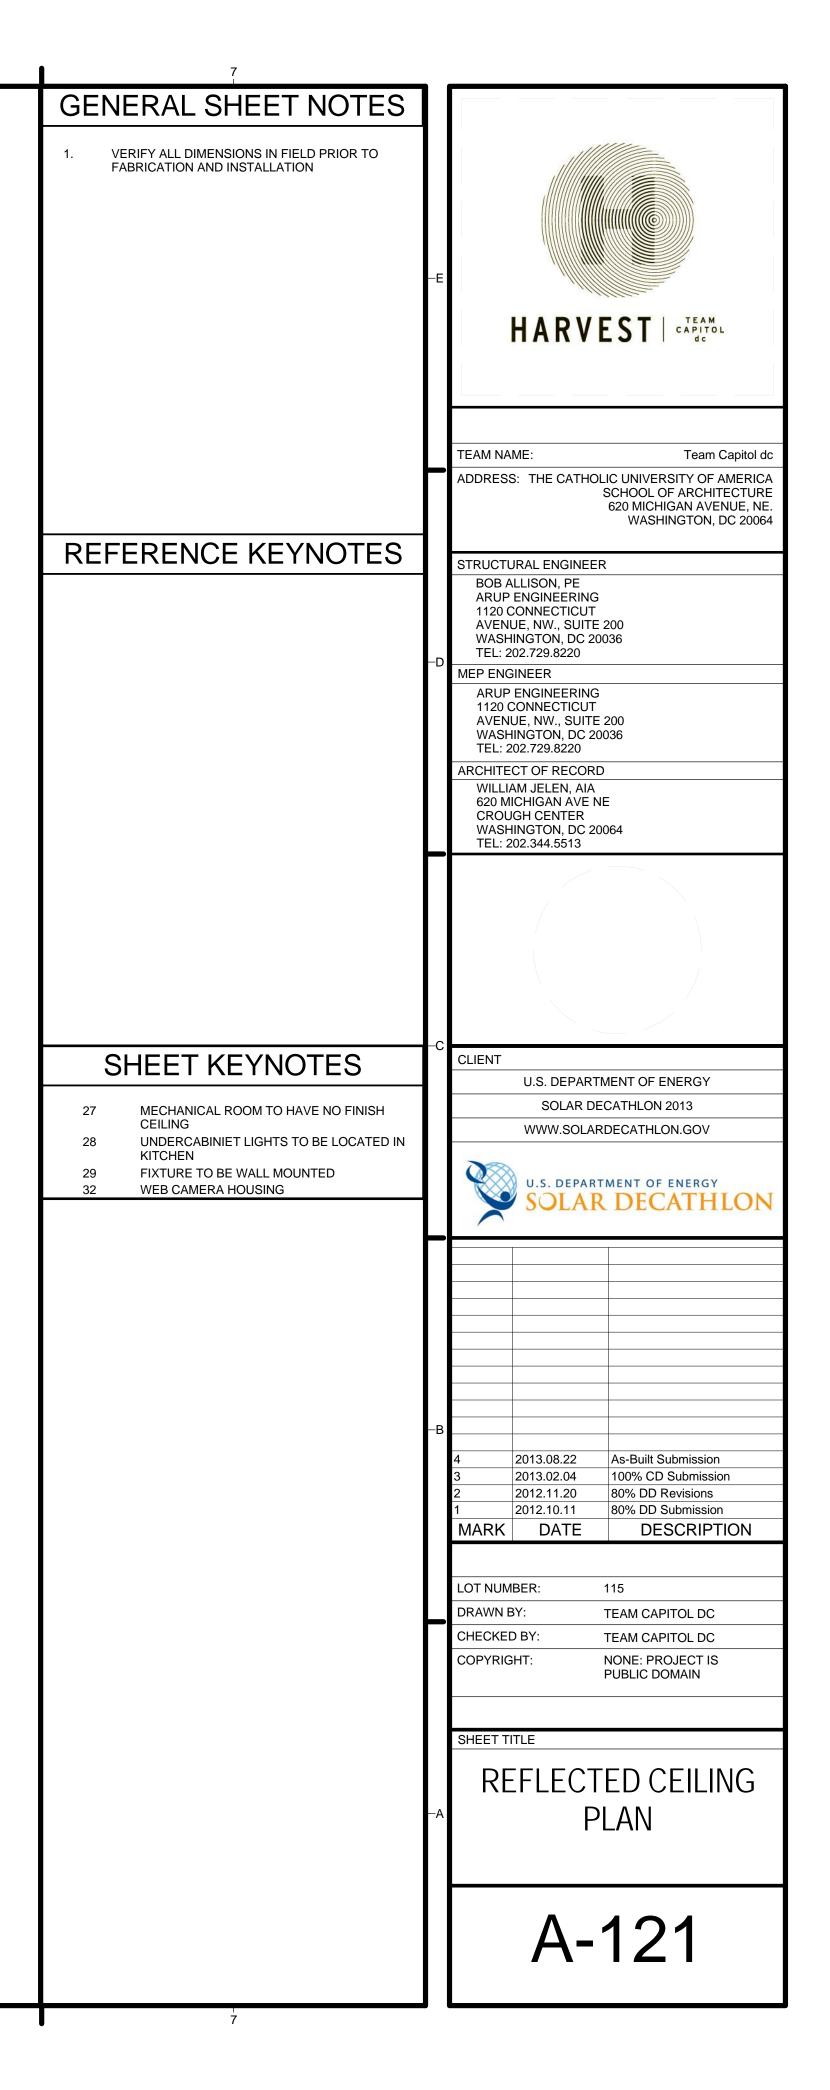
NOTE: SEE ELECTRICAL PLANS FOR LIGHTING & FIRE PROTECTION SPECFIFICATIONS. DRAWING FOR COORDINATION ONLY

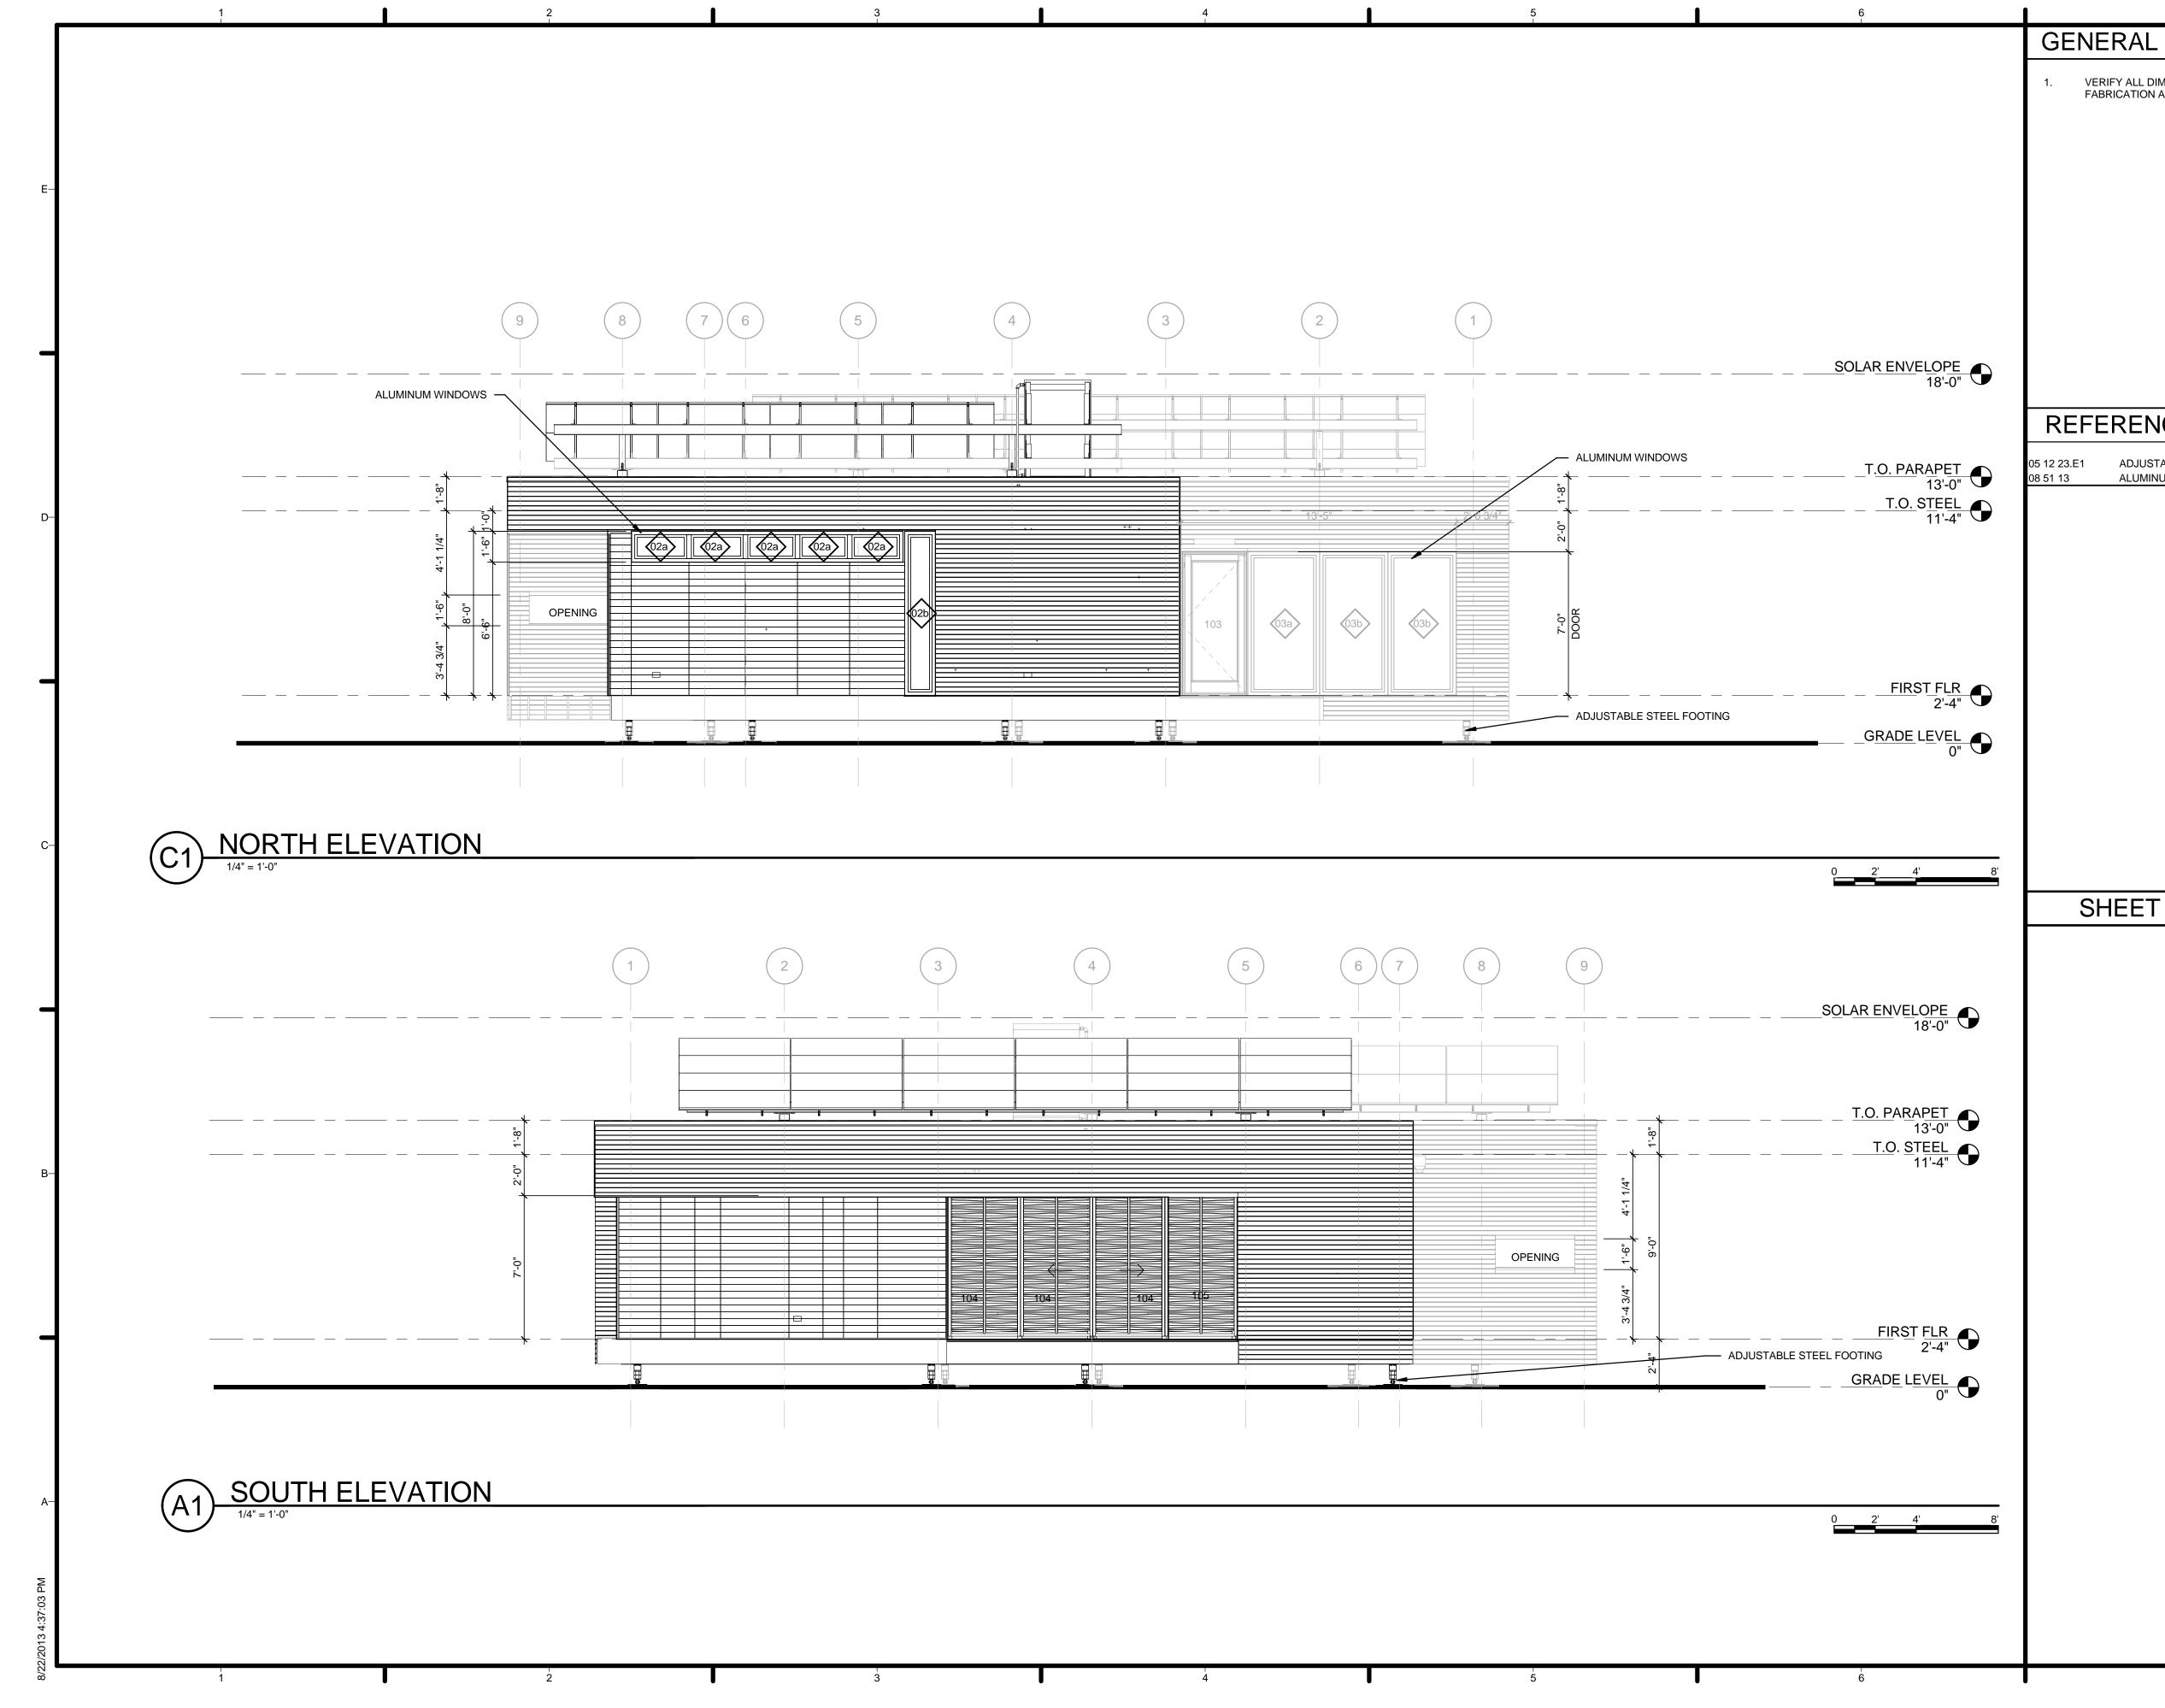


(A1) REFLECTED CEILING PLAN

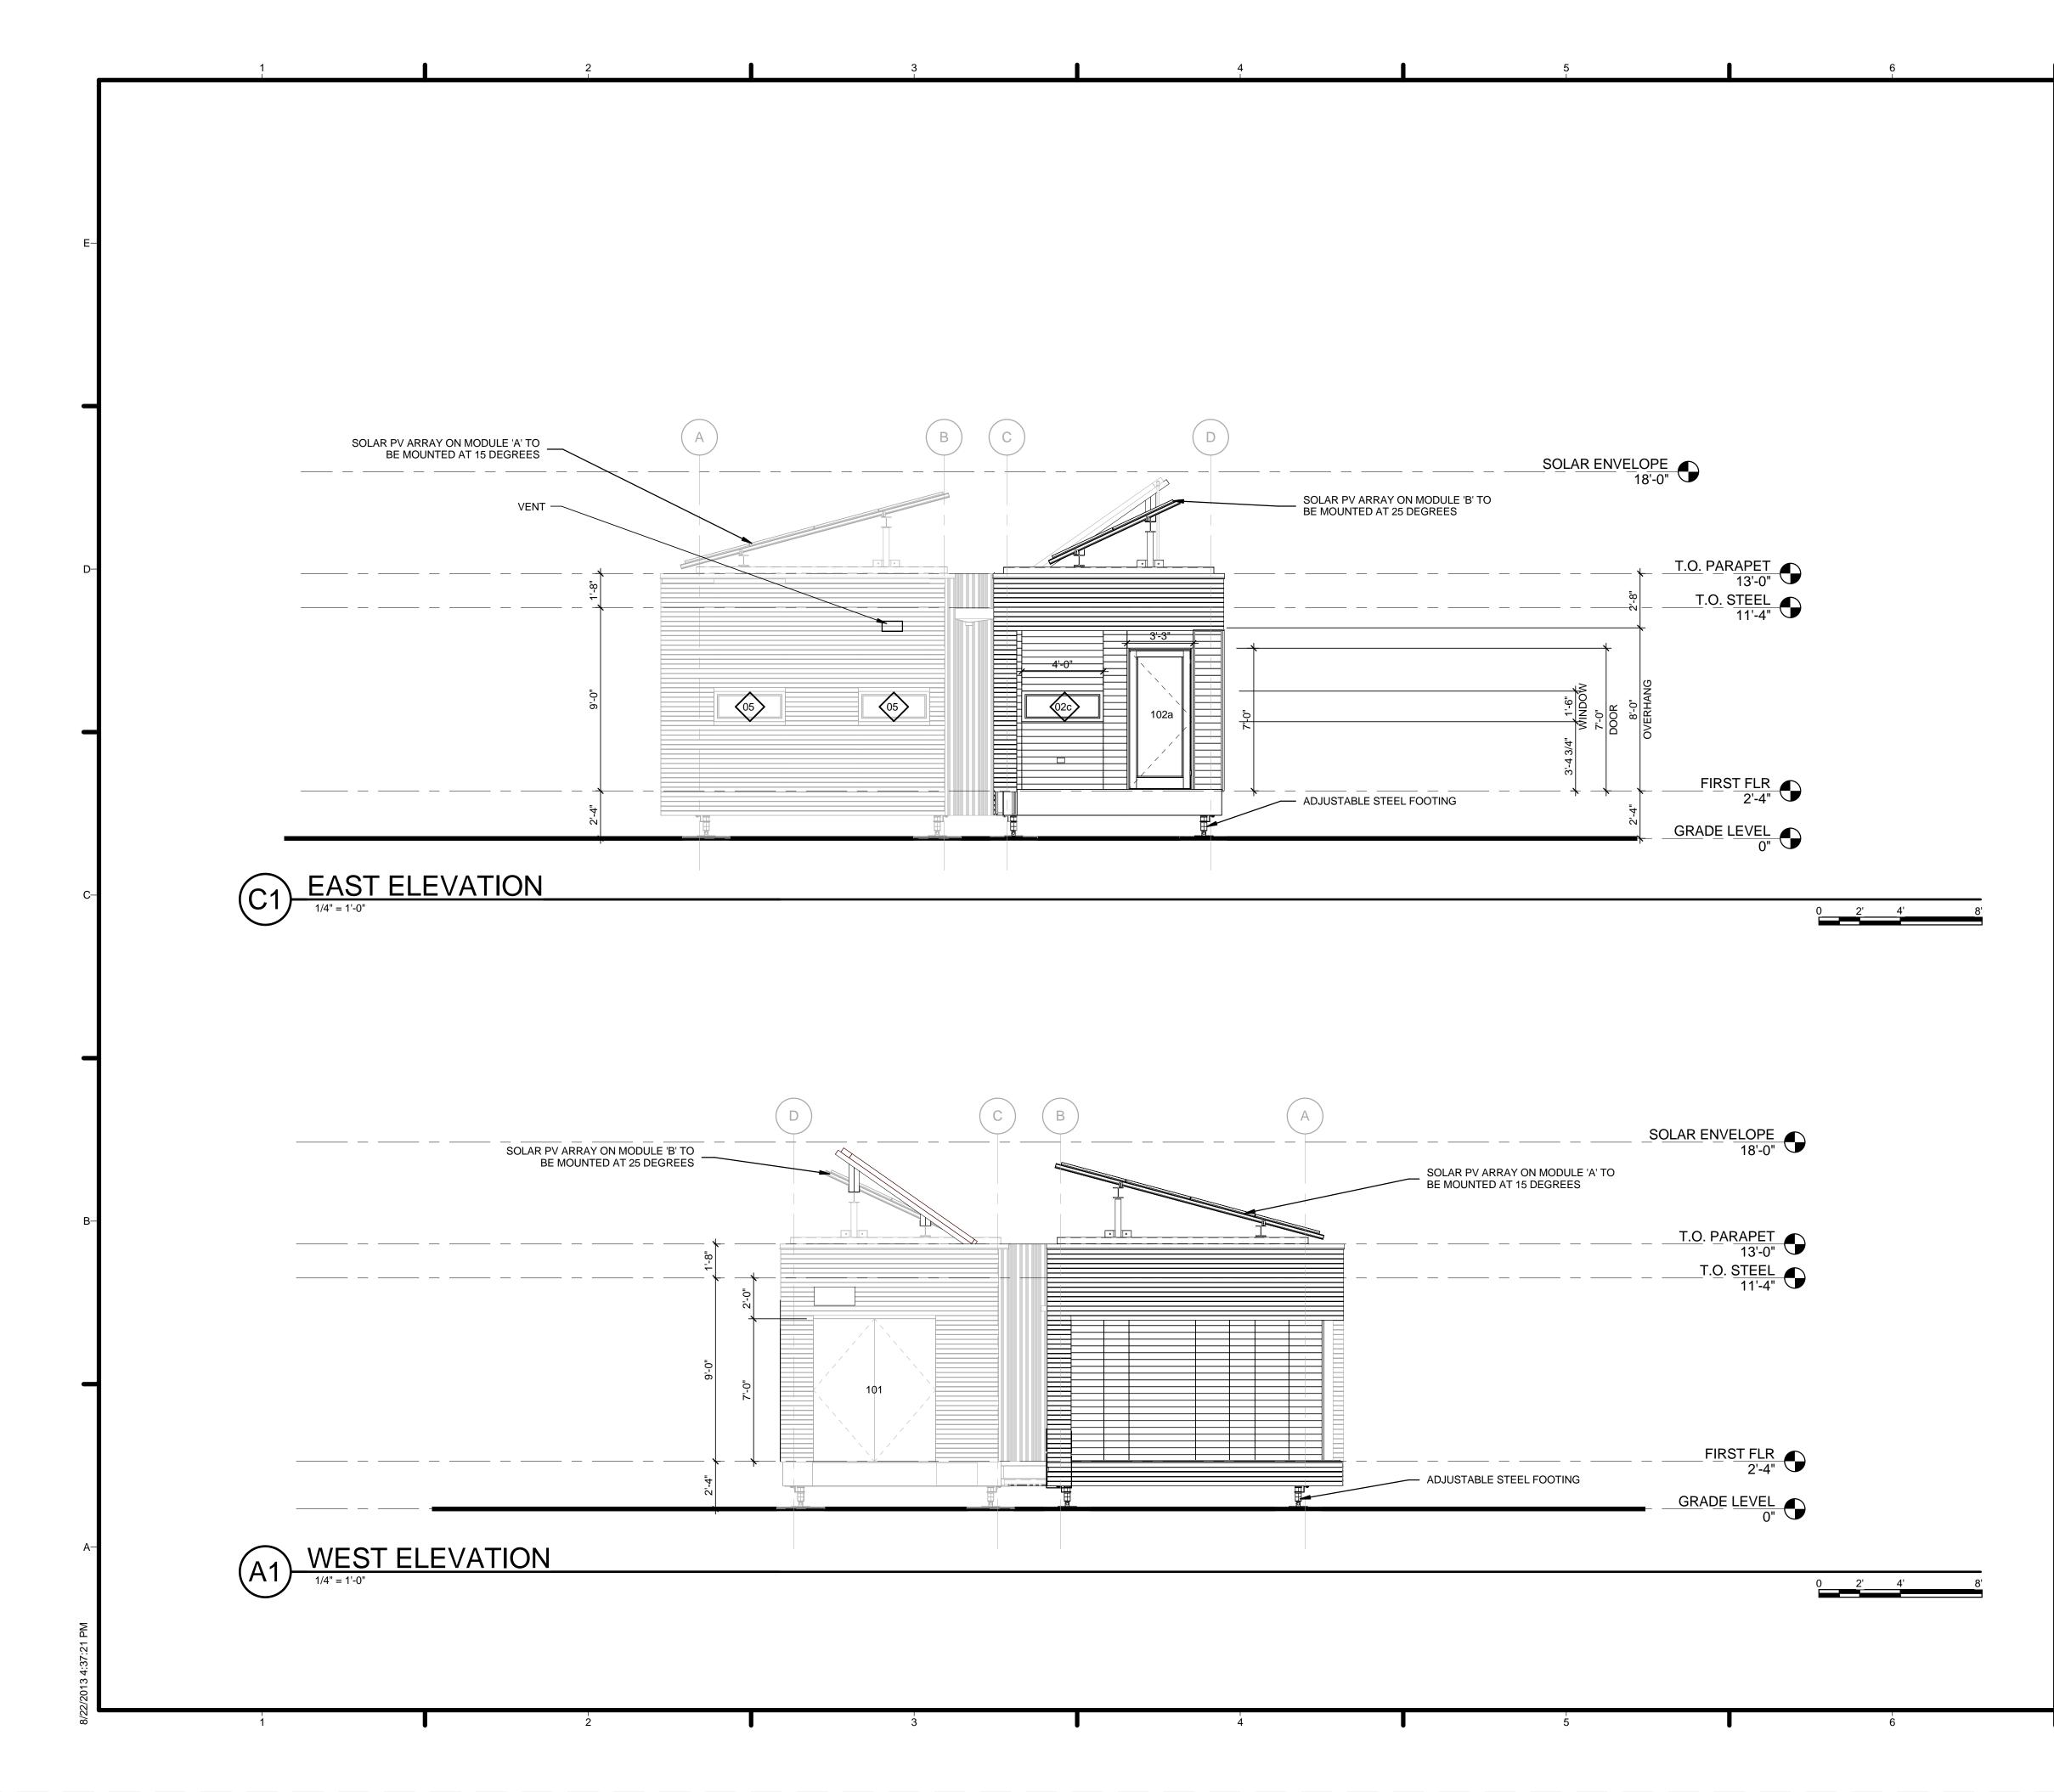
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URE		STRIP LIGHT FIXTURE
RE TURE)	1	LOW PROFILE TASK LIGHT FIXTURE
	٢	HEAT DETECTOR



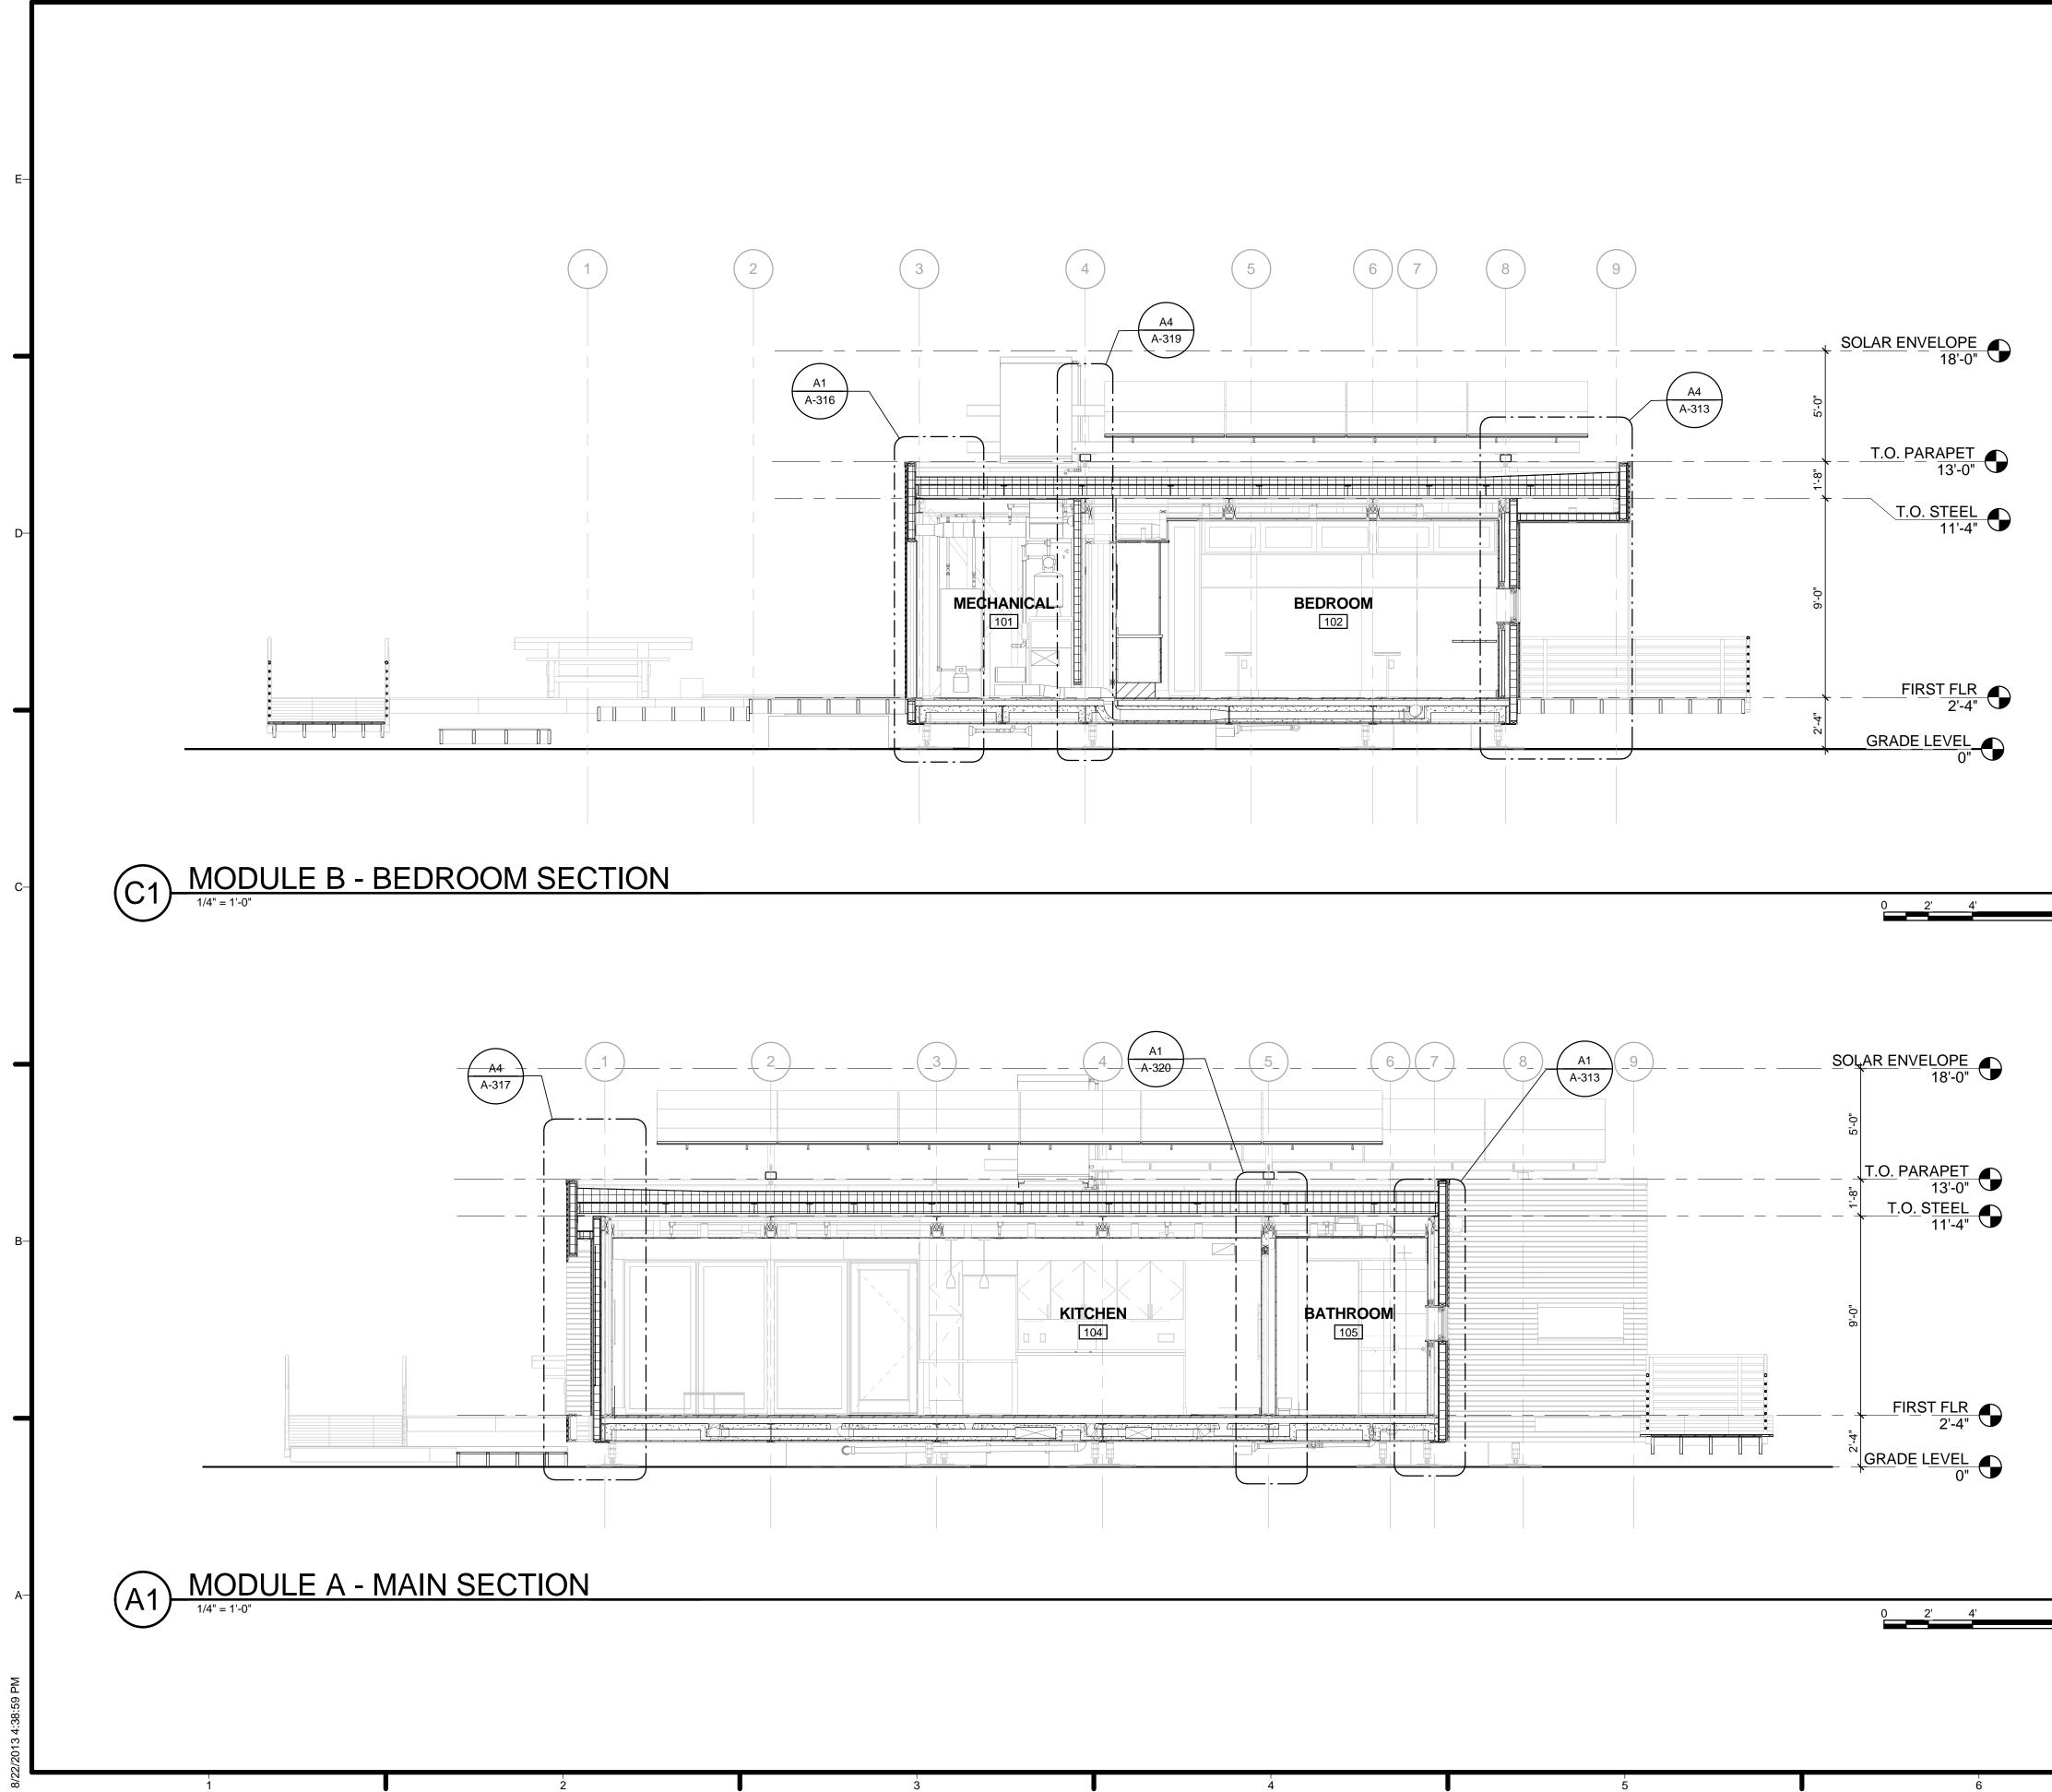




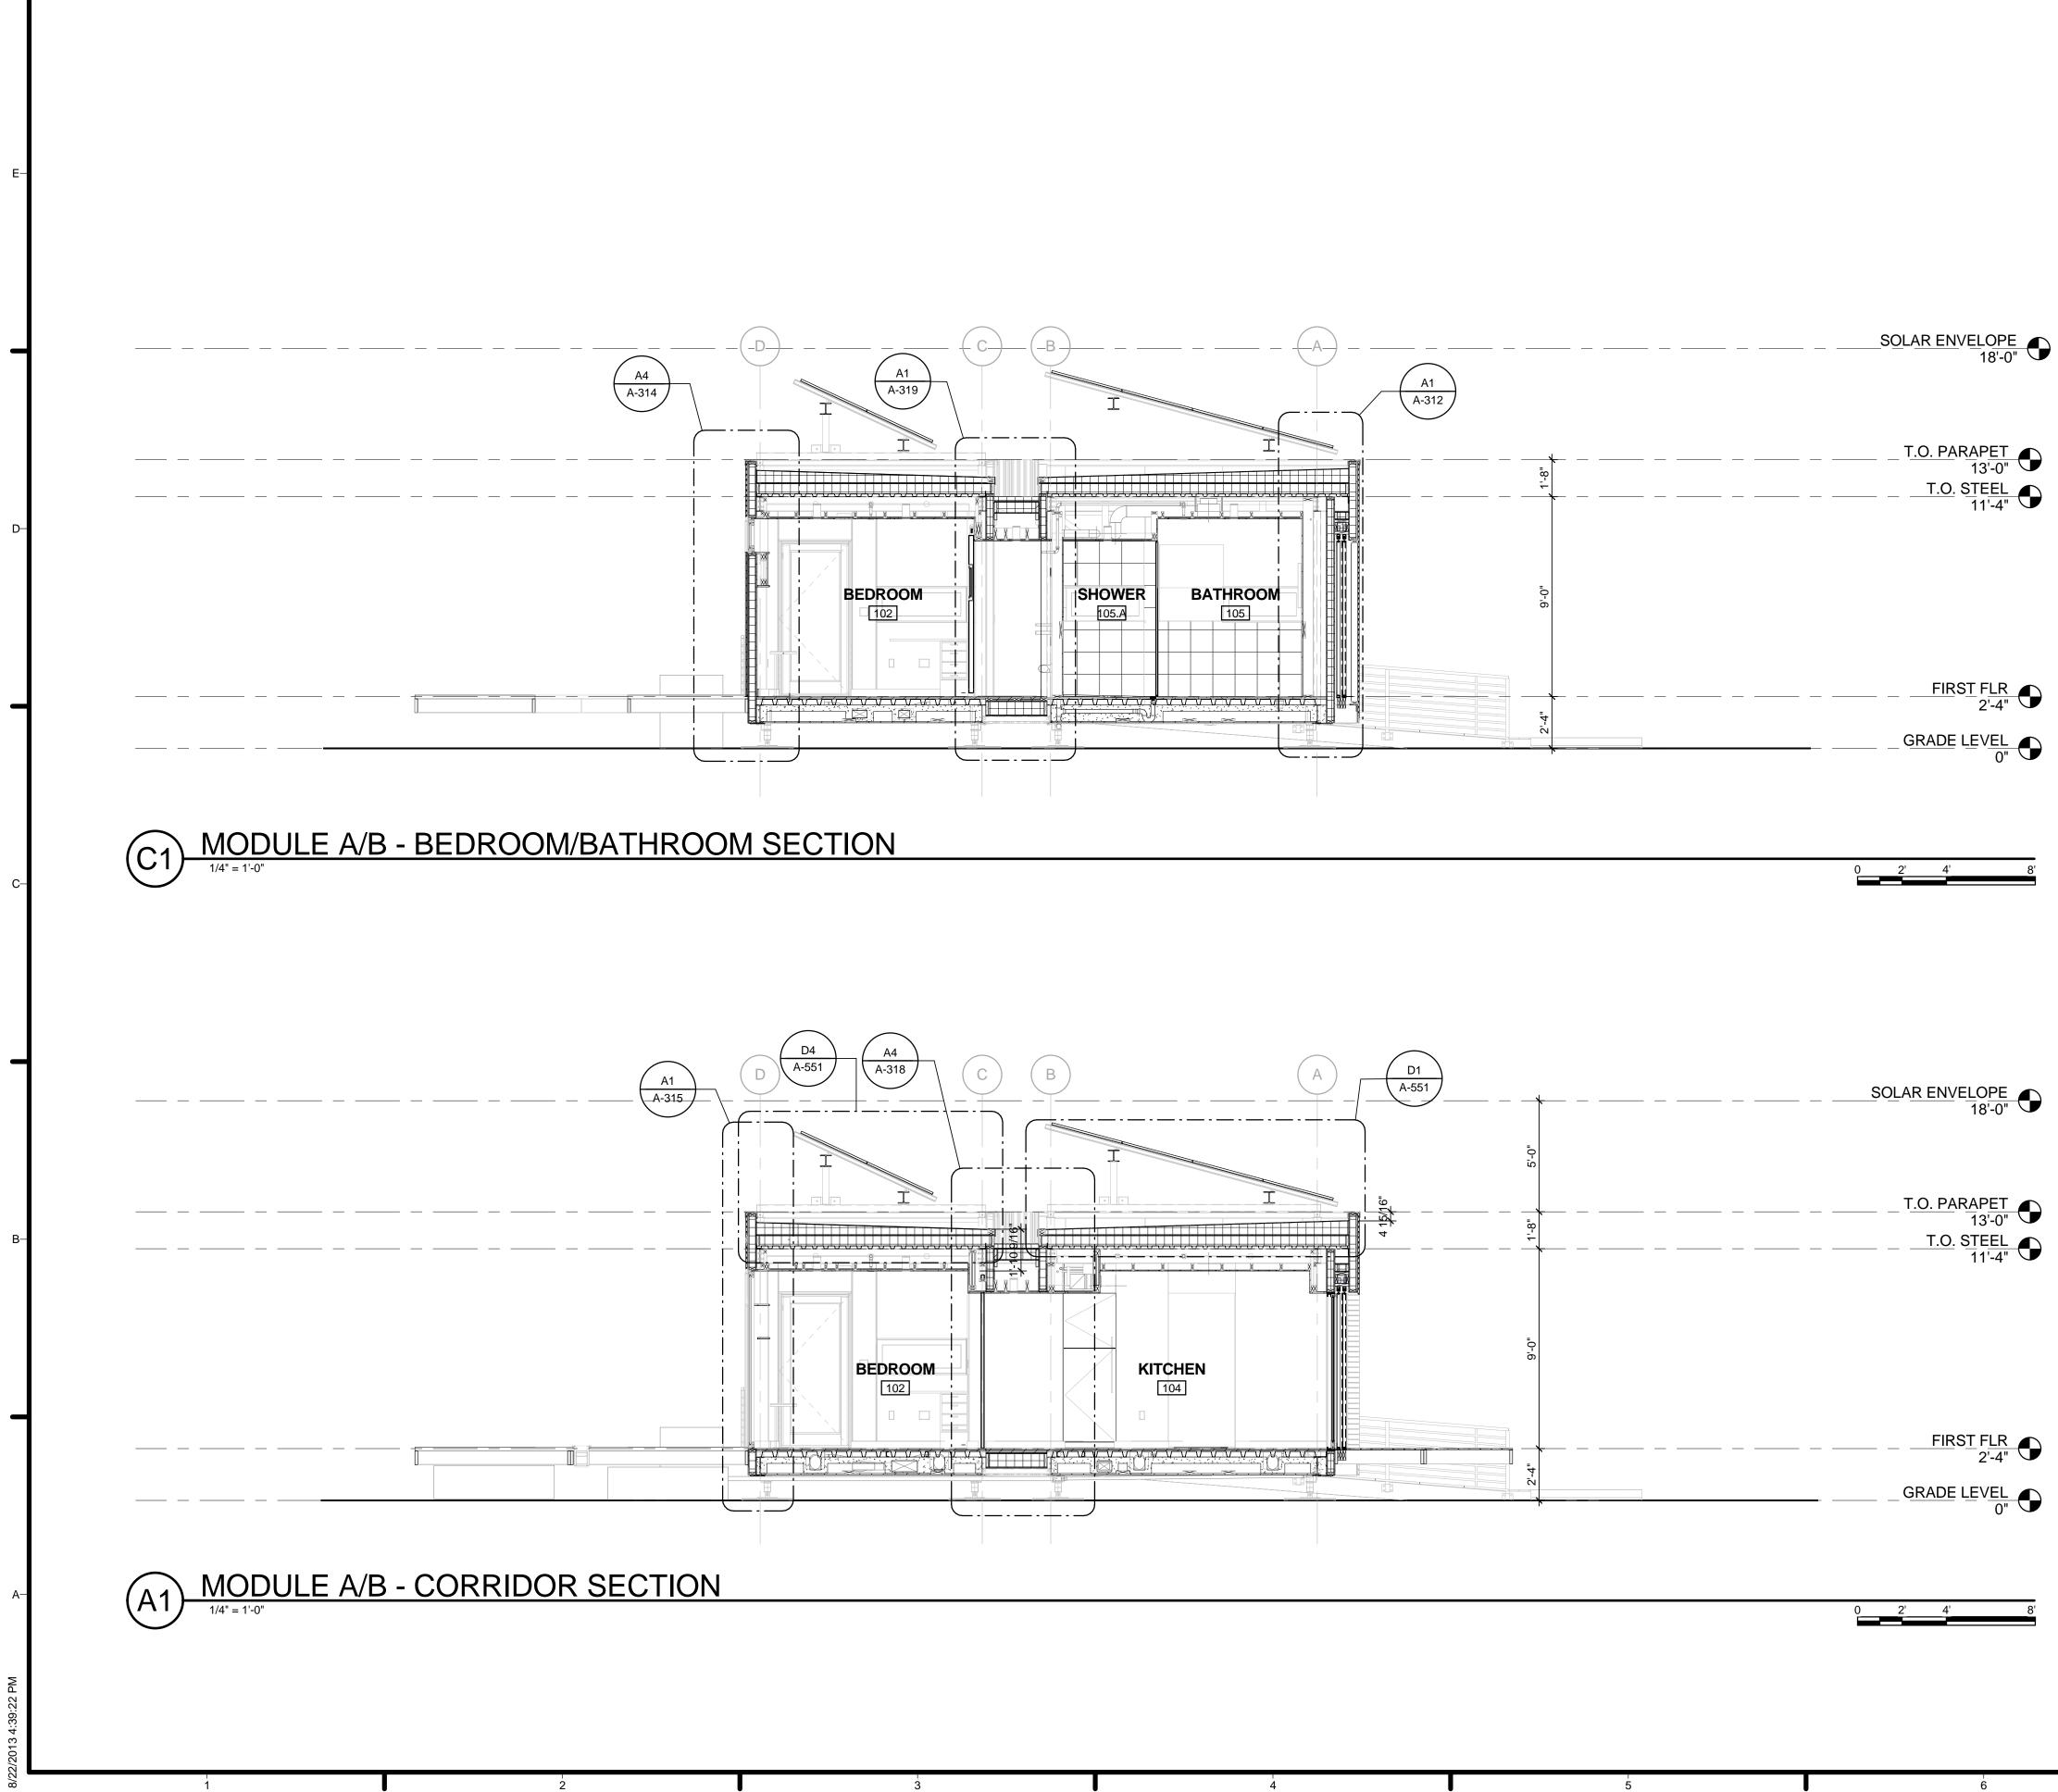
GENERAL SHEET NOTES 1. VERIFY ALL DIMENSIONS IN FIELD PRIOR TO ABRICATION AND INSTALLATION	-e HARVEST CAPITOL
	TEAM NAME: Team Capitol dc ADDRESS: THE CATHOLIC UNIVERSITY OF AMERICA SCHOOL OF ARCHITECTURE 620 MICHIGAN AVENUE, NE. WASHINGTON, DC 20064
REFERENCE KEYNOTES	STRUCTURAL ENGINEER
05 12 23.E1 ADJUSTABLE STEEL FOOTING 08 51 13 ALUMINUM WINDOWS	BOB ALLISON, PE ARUP ENGINEERING 1120 CONNECTICUT AVENUE, NW., SUITE 200 WASHINGTON, DC 20036 TEL: 202.729.8220 MEP ENGINEER ARUP ENGINEERING 1120 CONNECTICUT AVENUE, NW., SUITE 200 WASHINGTON, DC 20036 TEL: 202.729.8220 ARCHITECT OF RECORD WILLIAM JELEN, AIA 620 MICHIGAN AVE NE CROUGH CENTER WASHINGTON, DC 20064 TEL: 202.344.5513
SHEET KEYNOTES	C CLIENT U.S. DEPARTMENT OF ENERGY SOLAR DECATHLON 2013 WWW.SOLARDECATHLON.GOV U.S. DEPARTMENT OF ENERGY SOLAR DECATHLON
	-В 4 2013.08.22 As-Built Submission 3 2013.02.04 100% CD Submission 2 2012.11.20 80% DD Revisions 1 2012.10.11 80% DD Submission MARK DATE DESCRIPTION
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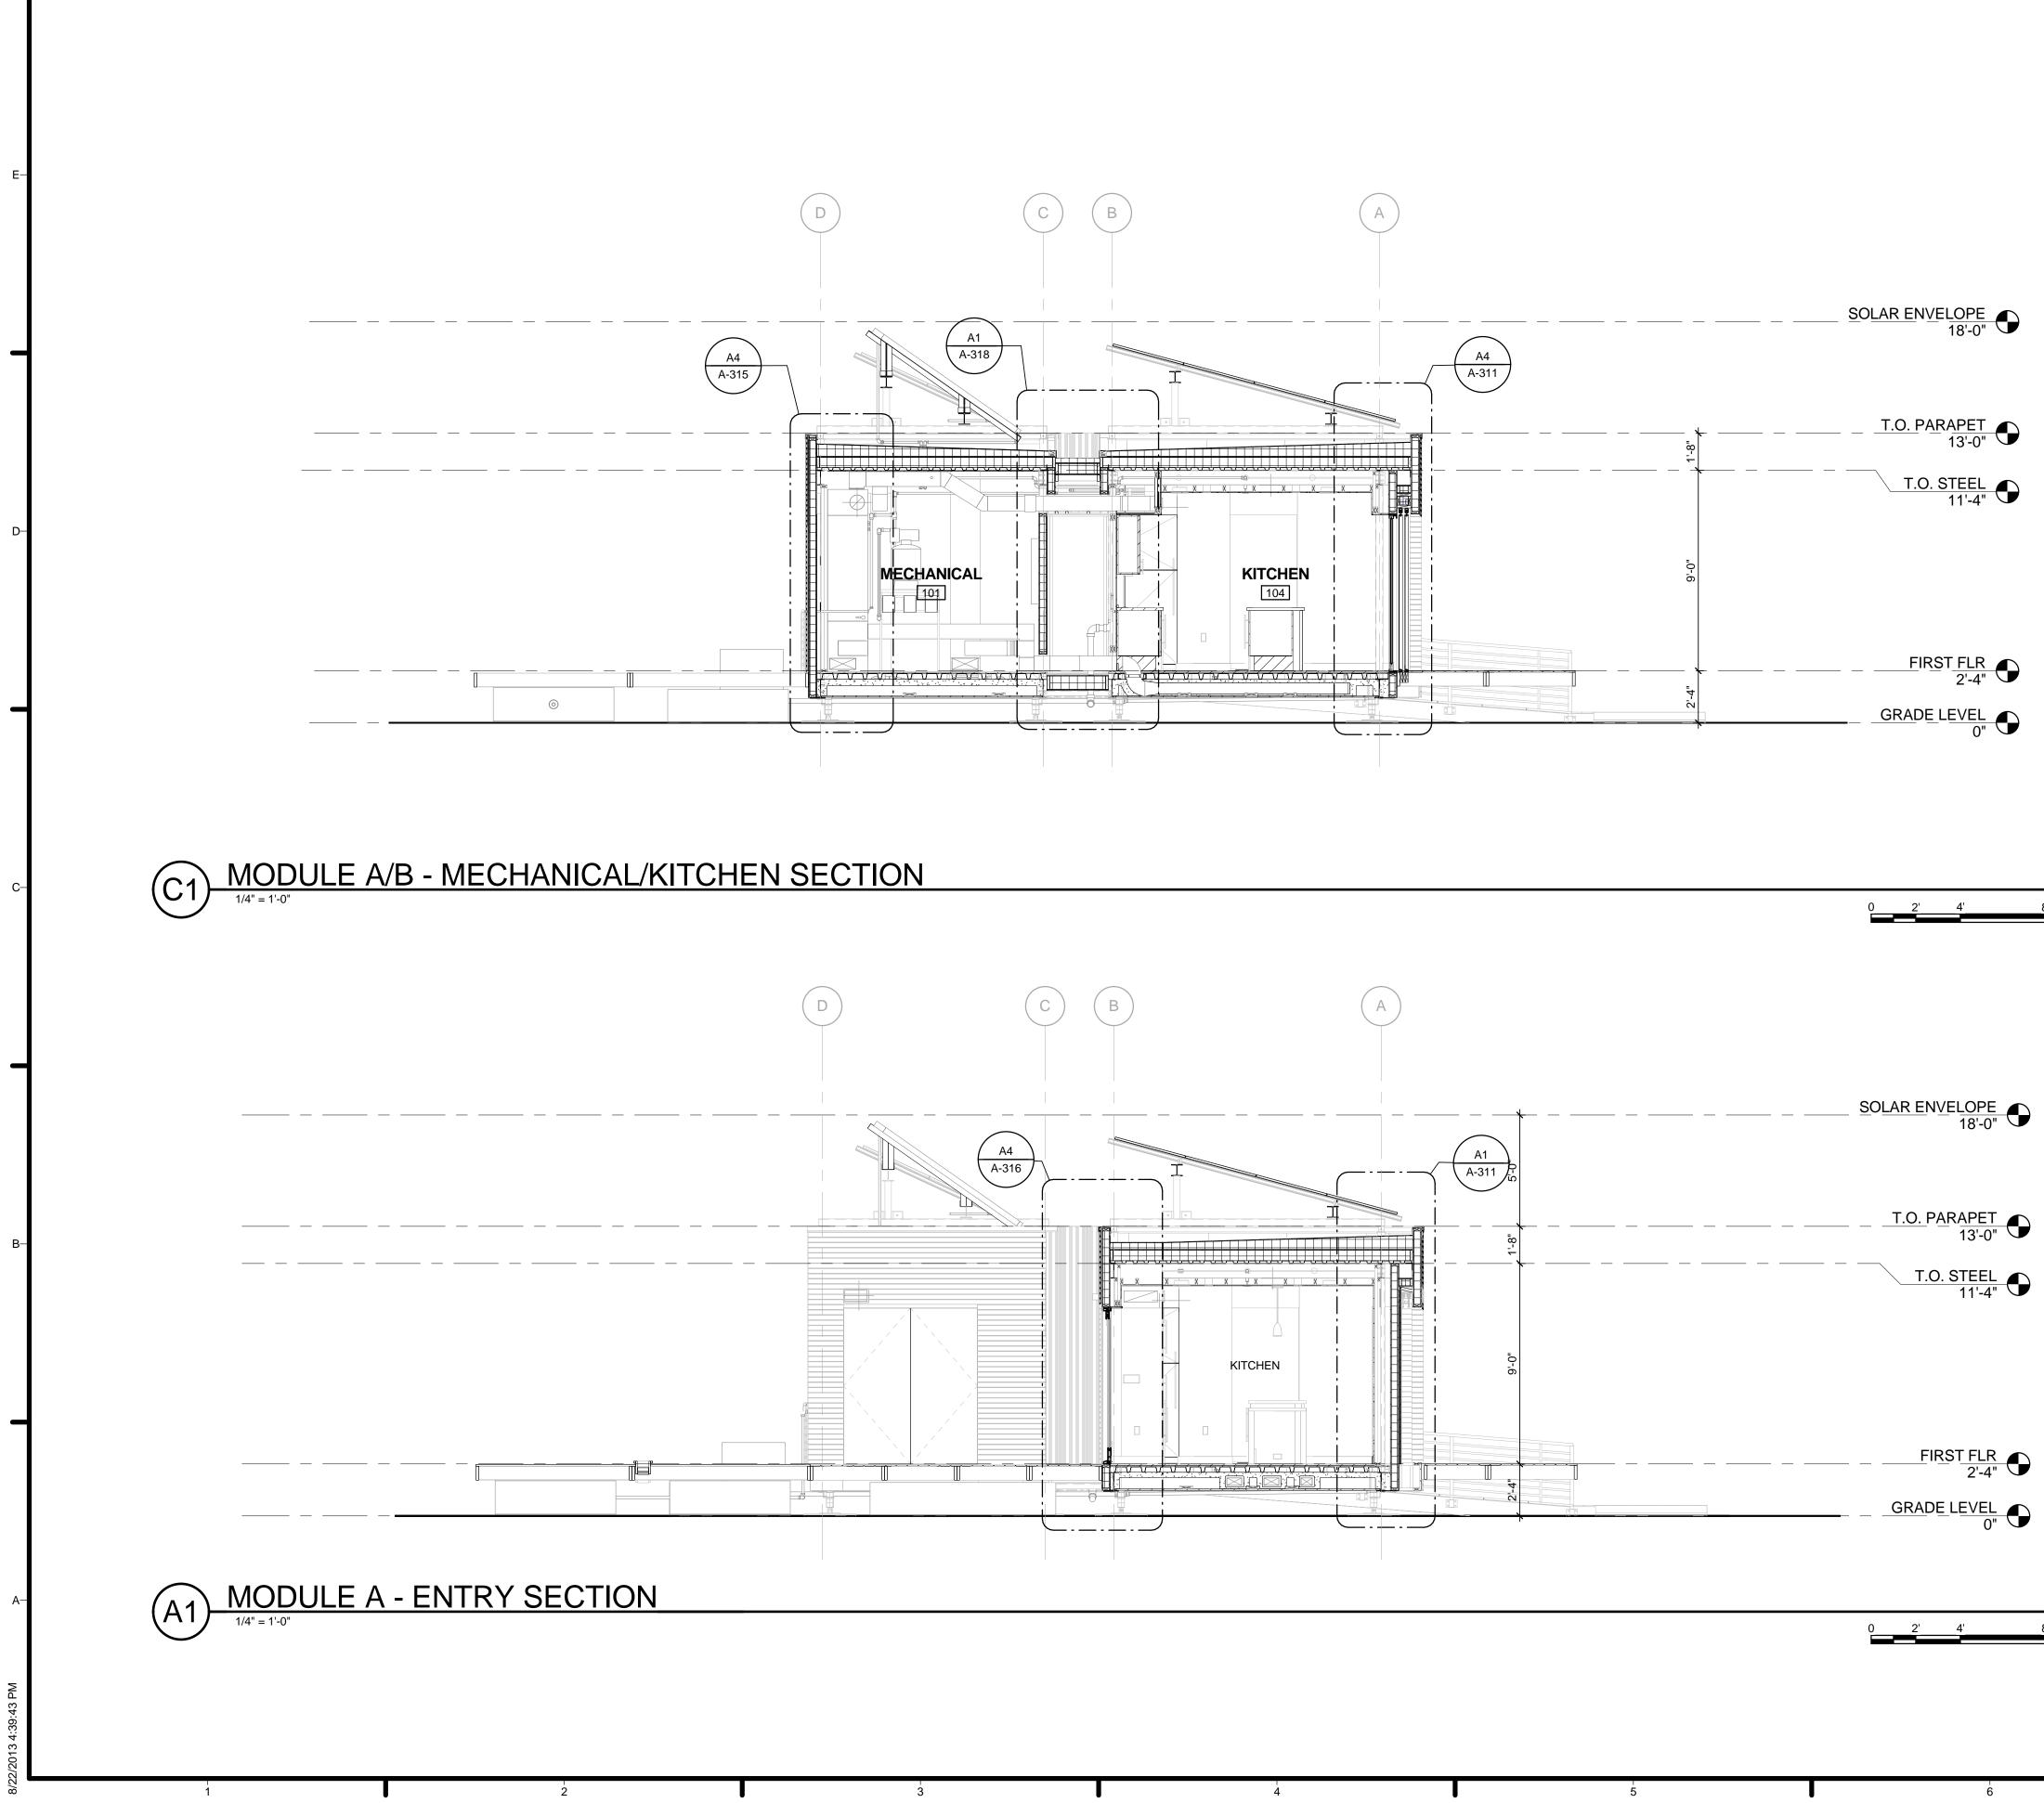
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GENERAL SHEET NOTES		
1. VERIFY ALL DIMENSIONS IN FIELD PRIOR TO FABRICATION AND INSTALLATION		
	-Ε	
		HARVEST
		TEAM NAME: Team Capitol dc ADDRESS: THE CATHOLIC UNIVERSITY OF AMERICA
		SCHOOL OF ARCHITECTURE 620 MICHIGAN AVENUE, NE. WASHINGTON, DC 20064
REFERENCE KEYNOTES		STRUCTURAL ENGINEER
05 12 23.E1 ADJUSTABLE STEEL FOOTING	_	BOB ALLISON, PE ARUP ENGINEERING 1120 CONNECTICUT
	-D	AVENUE, NW., SUITE 200 WASHINGTON, DC 20036 TEL: 202.729.8220
		MEP ENGINEER ARUP ENGINEERING 1120 CONNECTICUT
		AVENUE, NW., SUITE 200 WASHINGTON, DC 20036 TEL: 202.729.8220
		ARCHITECT OF RECORD WILLIAM JELEN, AIA
		620 MICHIGAN AVE NE CROUGH CENTER WASHINGTON, DC 20064
		TEL: 202.344.5513
	-c	CLIENT
		U.S. DEPARTMENT OF ENERGY
SHEET KEYNOTES		SOLAR DECATHLON 2013 WWW.SOLARDECATHLON.GOV
25 SOLAR PV ARRAY ON MODULE 'A' TO BE MOUNTED AT 15 DEGREES		U.S. DEPARTMENT OF ENERGY
26 SOLAR PV ARRAY ON MODULE 'B' TO BE MOUNTED AT 25 DEGREES		Solar Decathlon
	Γ	
	-В	4 2013.08.22 As-Built Submission
		3 2013.02.04 100% CD Submission 2 2012.11.20 80% DD Revisions
		12012.10.1180% DD SubmissionMARKDATEDESCRIPTION
		LOT NUMBER: 115
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		SHEET TITLE
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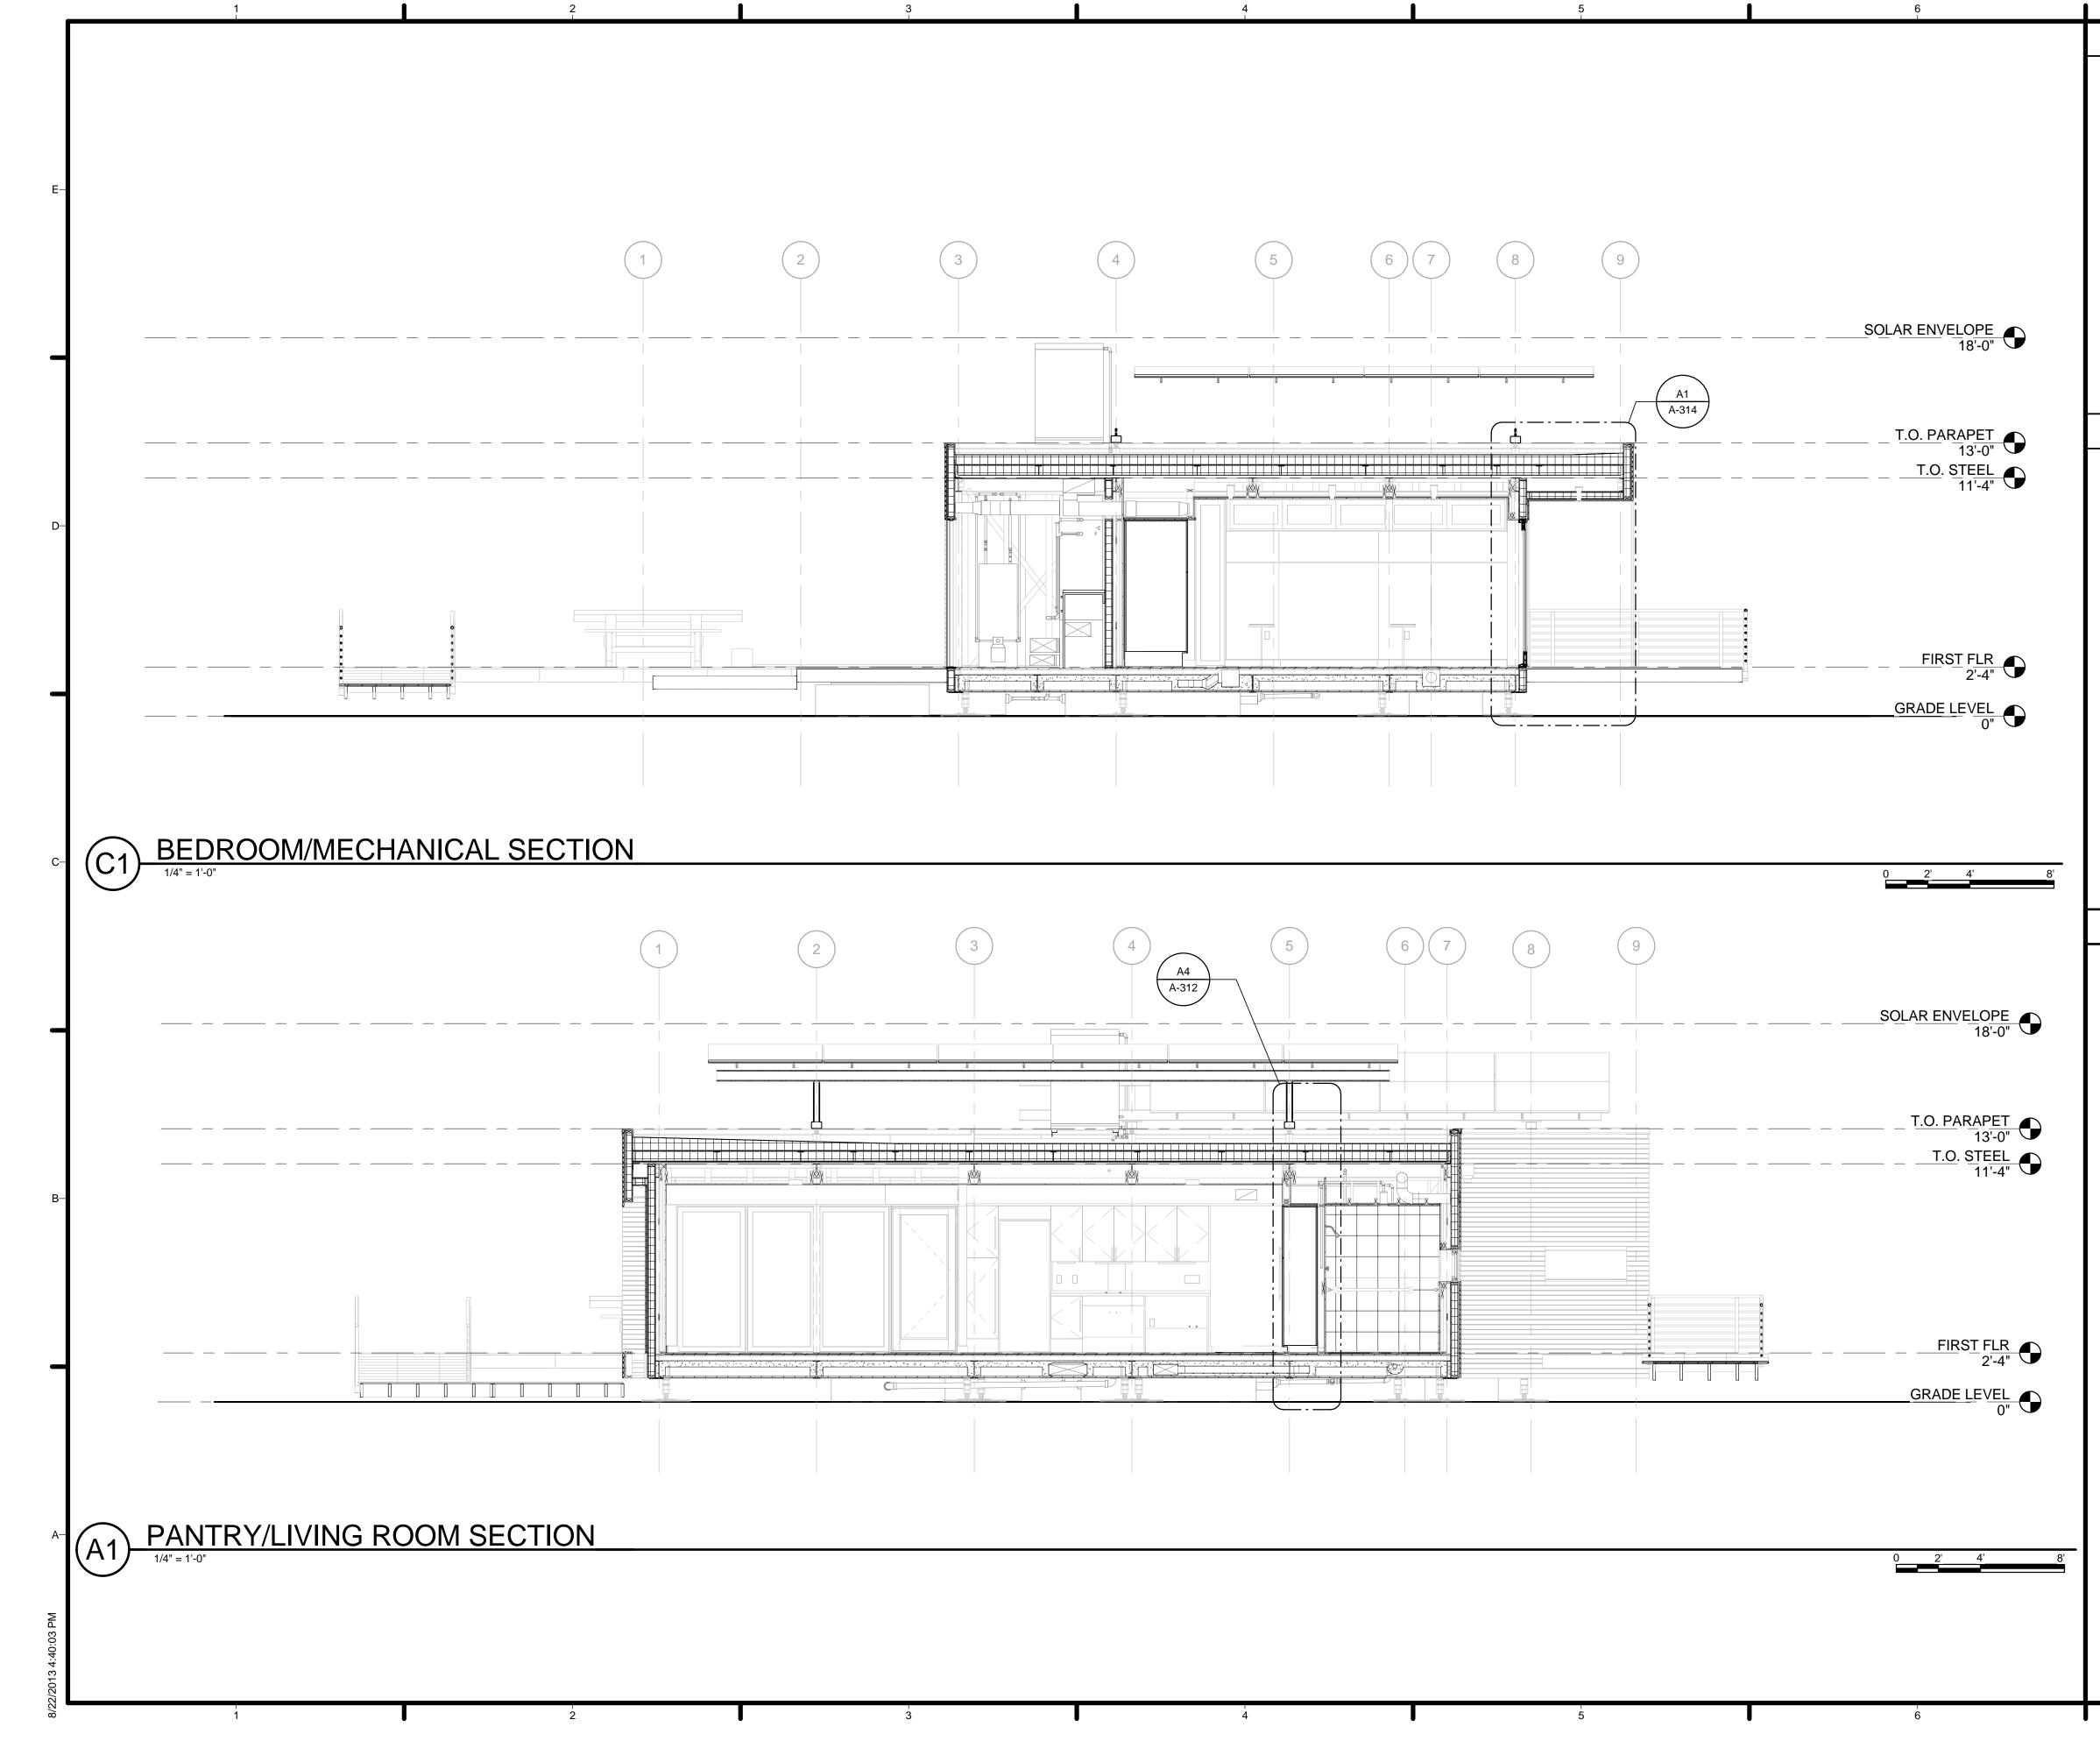
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GENERAL SHEET NOTES 1. VERIFY ALL DIMENSIONS IN FIELD PRIOR TO BERICATION AND INSTALLATION	—Е	HARVEST CAPITOL
REFERENCE KEYNOTES	—D	TEAM NAME:Team Capitol dcADDRESS:THE CATHOLIC UNIVERSITY OF AMERICA SCHOOL OF ARCHITECTURE 620 MICHIGAN AVENUE, NE. WASHINGTON, DC 20064STRUCTURAL ENGINEERBOB ALLISON, PE
SHEET KEYNOTES	-c	CROUGH CENTER WASHINGTON, DC 20064 TEL: 202.344.5513 CLIENT U.S. DEPARTMENT OF ENERGY SOLAR DECATHLON 2013 WWW.SOLARDECATHLON.GOV U.S. DEPARTMENT OF ENERGY SOLAR DECATHLON.GOV
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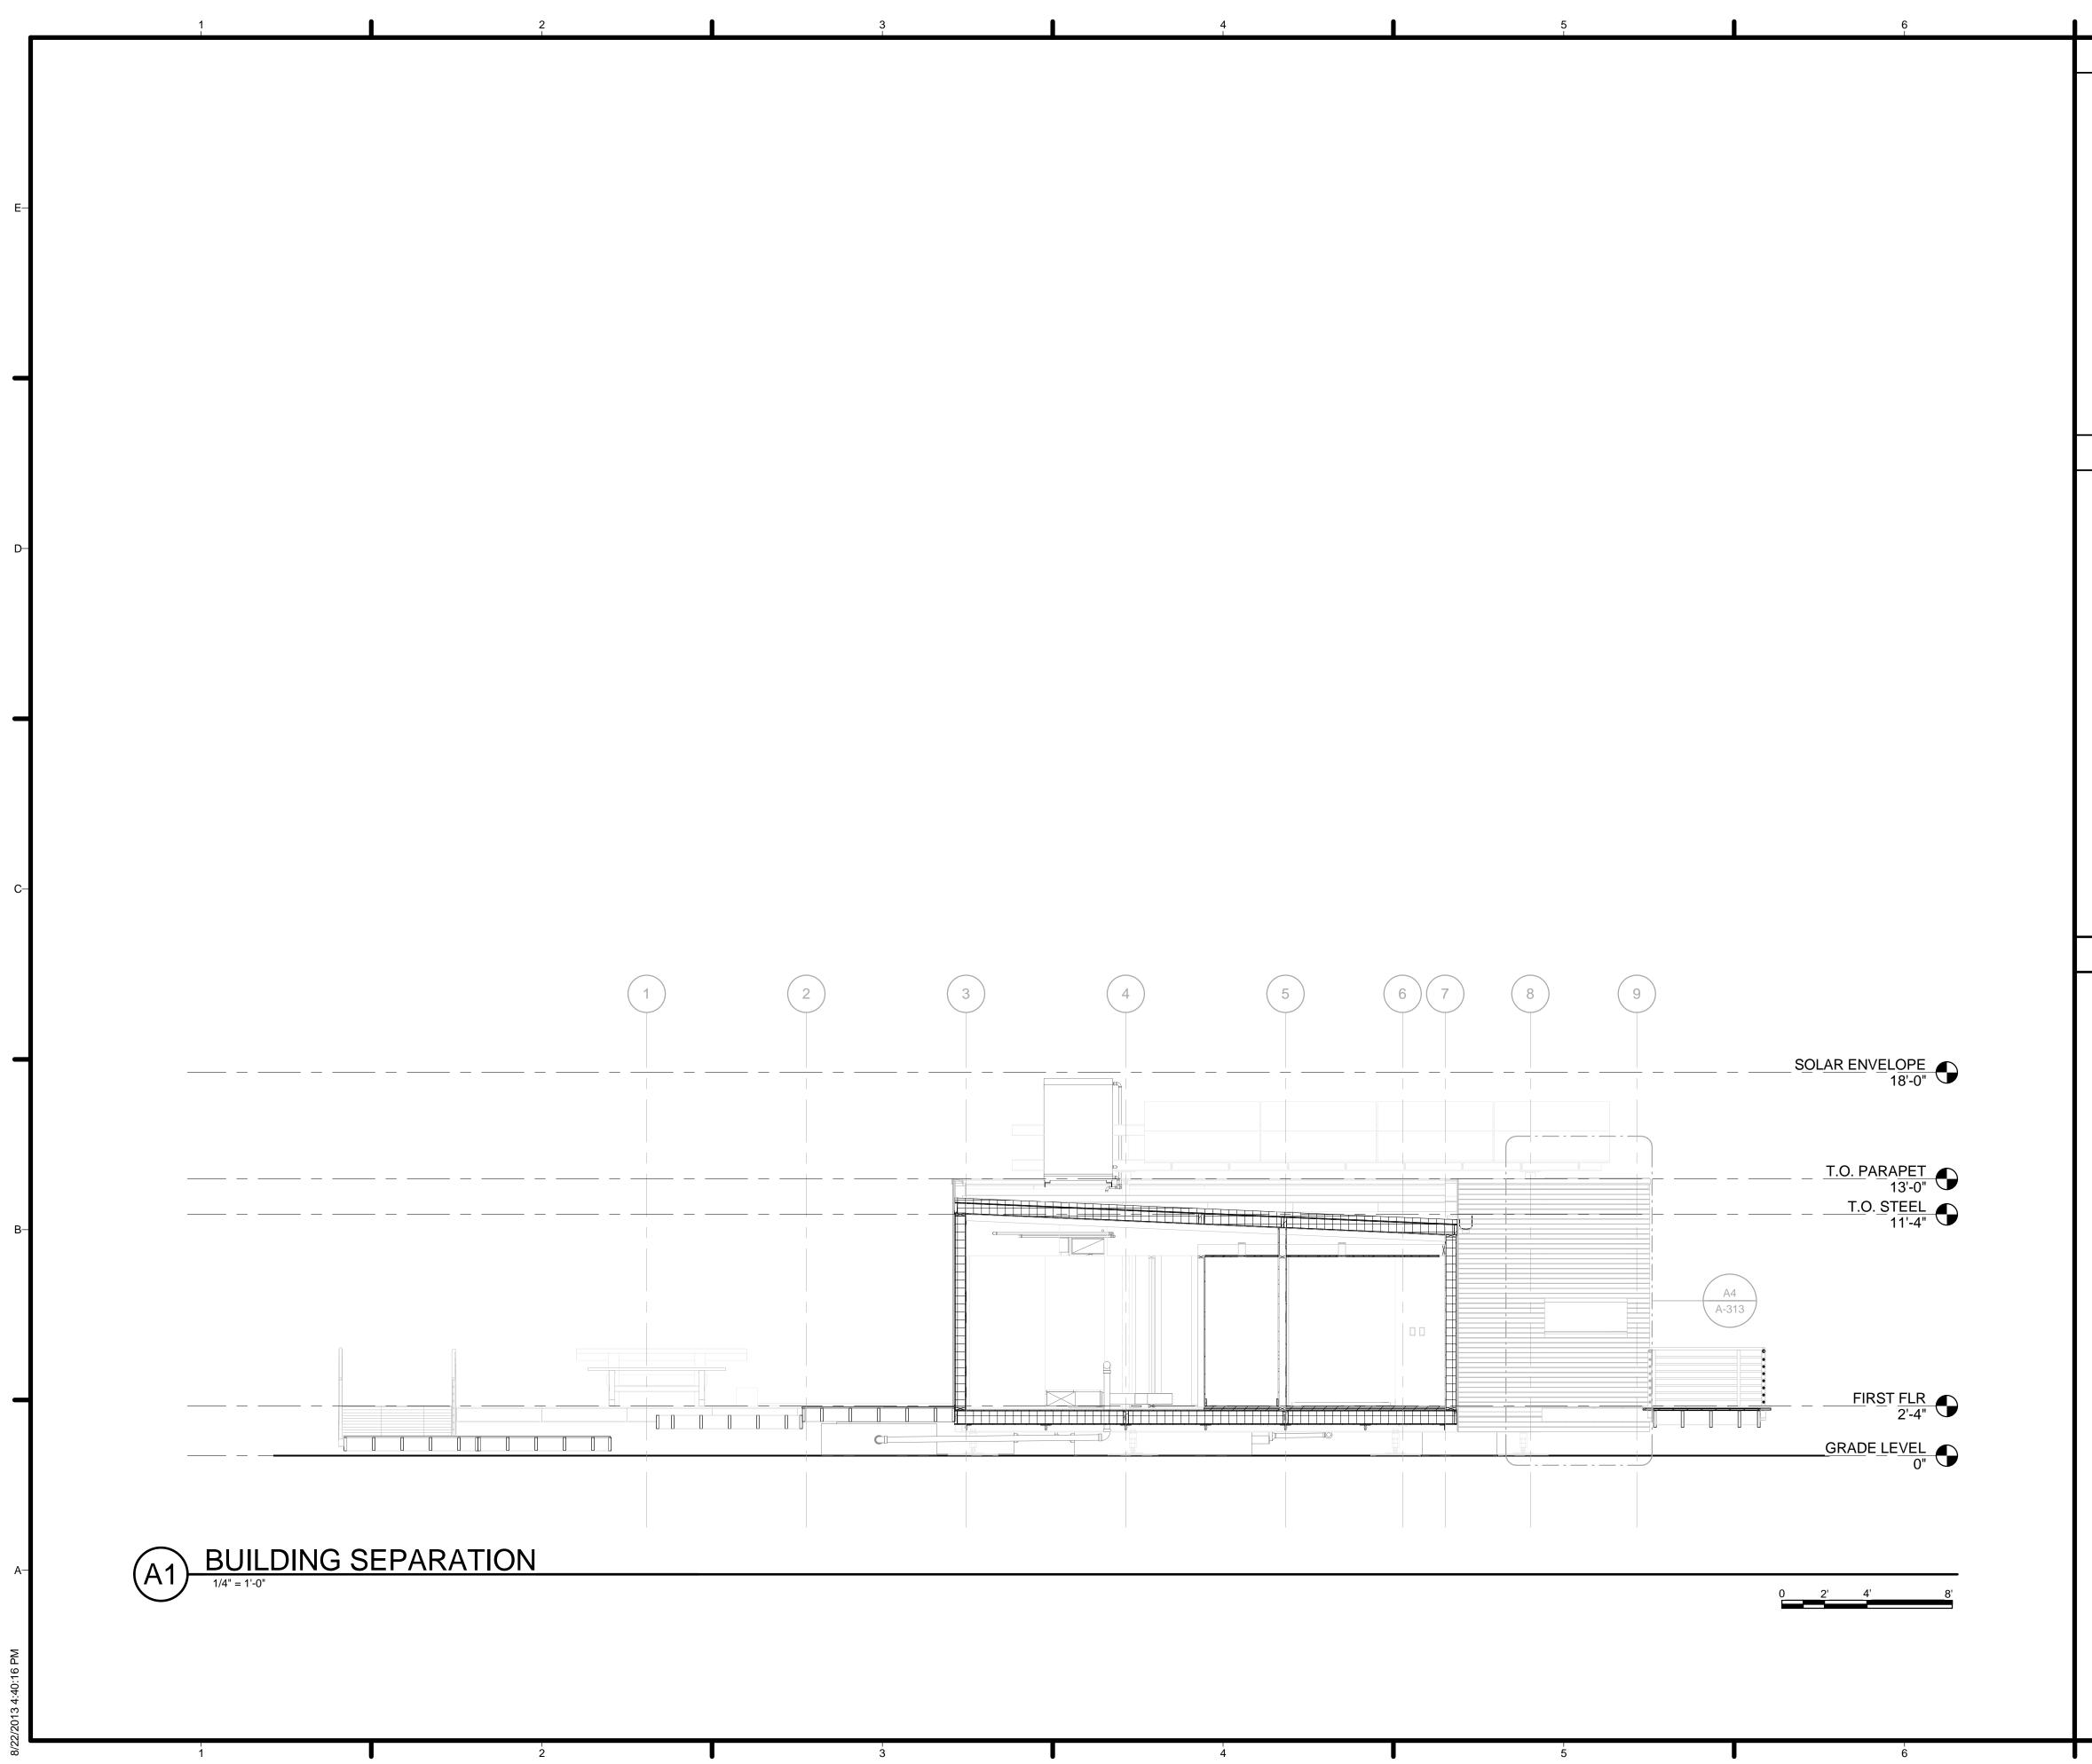
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GENERAL SHEET NOTES		
1. VERIFY ALL DIMENSIONS IN FIELD PRIOR TO FABRICATION AND INSTALLATION		
	E	HARVEST
		TEAM NAME: Team Capitol dc ADDRESS: THE CATHOLIC UNIVERSITY OF AMERICA SCHOOL OF ARCHITECTURE 620 MICHIGAN AVENUE, NE. WASHINGTON, DC 20064
REFERENCE KEYNOTES		
	-D	STRUCTURAL ENGINEER BOB ALLISON, PE ARUP ENGINEERING 1120 CONNECTICUT AVENUE, NW., SUITE 200 WASHINGTON, DC 20036 TEL: 202.729.8220 MEP ENGINEER
		ARUP ENGINEERING 1120 CONNECTICUT AVENUE, NW., SUITE 200 WASHINGTON, DC 20036 TEL: 202.729.8220 ARCHITECT OF RECORD
		WILLIAM JELEN, AIA 620 MICHIGAN AVE NE CROUGH CENTER WASHINGTON, DC 20064 TEL: 202.344.5513
	–c	CLIENT U.S. DEPARTMENT OF ENERGY
SHEET KEYNOTES		SOLAR DECATHLON 2013 WWW.SOLARDECATHLON.GOV
		U.S. DEPARTMENT OF ENERGY SOLAR DECATHLON
	-В	4 2013.08.22 As-Built Submission 3 2013.02.04 100% CD Submission
		22012.11.2080% DD Revisions12012.10.1180% DD SubmissionMARKDATEDESCRIPTION
		LOT NUMBER:115DRAWN BY:TEAM CAPITOL DCCHECKED BY:TEAM CAPITOL DCCOPYRIGHT:NONE: PROJECT IS PUBLIC DOMAIN
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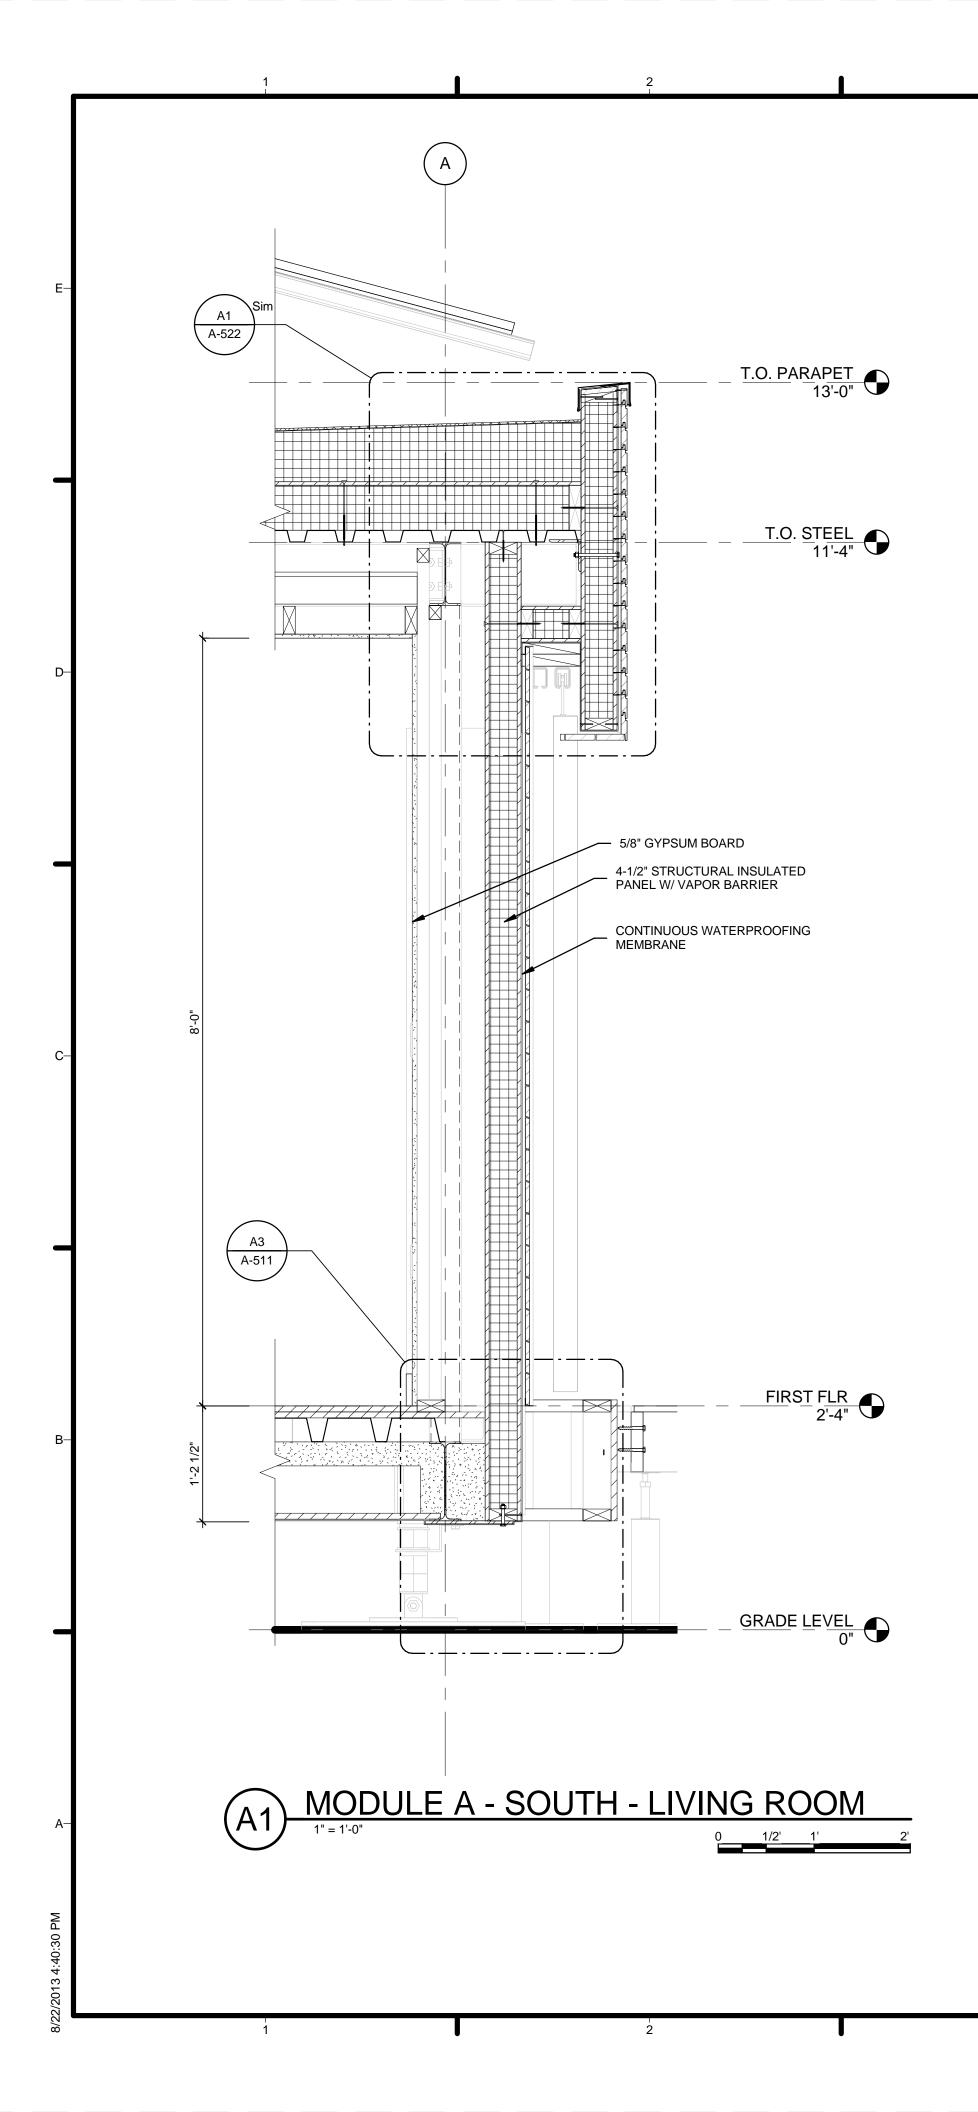
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GENERAL SHEET NOTES 1. VERIFY ALL DIMENSIONS IN FIELD PRIOR TO BERICATION AND INSTALLATION	-E HARVEST	
REFERENCE KEYNOTES	TEAM NAME: Team Capitol ADDRESS: THE CATHOLIC UNIVERSITY OF AMERI SCHOOL OF ARCHITECTU 620 MICHIGAN AVENUE, N WASHINGTON, DC 200 STRUCTURAL ENGINEER BOB ALLISON, PE ARUP ENGINEERING 1120 CONNECTICUT AVENUE, NW., SUITE 200 WASHINGTON, DC 20036 TEL: 202.729.8220 MEP ENGINEER ARUP ENGINEERING 1120 CONNECTICUT AVENUE, NW., SUITE 200 WASHINGTON, DC 20036 TEL: 202.729.8220 MEP ENGINEER ARUP ENGINEERRING 1120 CONNECTICUT AVENUE, NW., SUITE 200 WASHINGTON, DC 20036 TEL: 202.729.8220 ARCHITECT OF RECORD WILLIAM JELEN, AIA 620 MICHIGAN AVE NE CROUGH CENTER WASHINGTON, DC 20064 TEL: 202.344.5513	CA RE NE.
SHEET KEYNOTES	-C CLIENT U.S. DEPARTMENT OF ENERGY SOLAR DECATHLON 2013 WWW.SOLARDECATHLON.GOV U.S. DEPARTMENT OF ENERGY SOLAR DECATHLO	Ν
	-B 4 2013.08.22 As-Built Submission 3 2013.02.04 100% CD Submission 2 2012.11.20 80% DD Revisions 1 2012.10.11 80% DD Submission MARK DATE DESCRIPTION I OT NUMBER: 115 DRAWN BY: TEAM CAPITOL DC CHECKED BY: TEAM CAPITOL DC	
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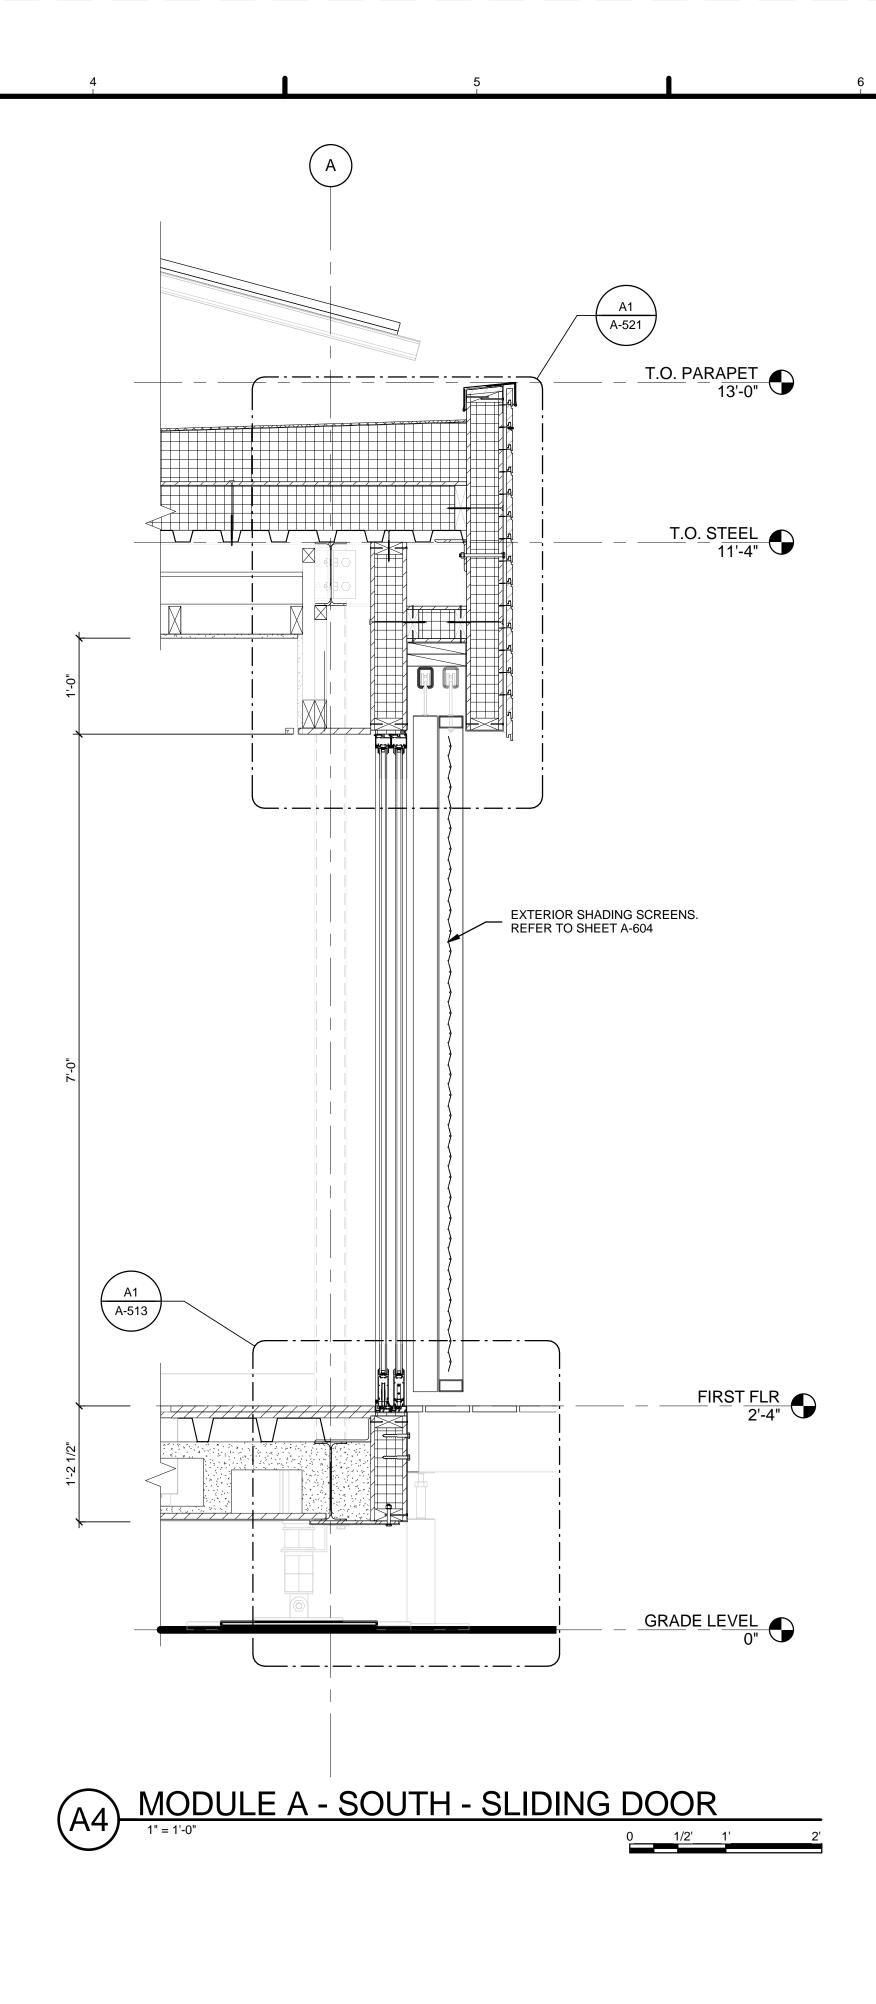


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GENERAL SHEET NOTES 1. VERIFY ALL DIMENSIONS IN FIELD PRIOR TO FABRICATION AND INSTALLATION	-E	HARVEST CAPITOL
REFERENCE KEYNOTES		TEAM NAME: Team Capitol dc ADDRESS: THE CATHOLIC UNIVERSITY OF AMERICA SCHOOL OF ARCHITECTURE 620 MICHIGAN AVENUE, NE. WASHINGTON, DC 20064 STRUCTURAL ENGINEER BOB ALLISON, PE
	-D	ARUP ENGINEERING 1120 CONNECTICUT AVENUE, NW., SUITE 200 WASHINGTON, DC 20036 TEL: 202 729 8220
		620 MICHIGAN AVE NE CROUGH CENTER WASHINGTON, DC 20064 TEL: 202.344.5513
SHEET KEYNOTES	-c	CLIENT U.S. DEPARTMENT OF ENERGY SOLAR DECATHLON 2013 WWW.SOLARDECATHLON.GOV U.S. DEPARTMENT OF ENERGY SOLAR DECATHLON
	-B	4 2013.08.22 As-Built Submission 3 2013.02.04 100% CD Submission 2 2012.11.20 80% DD Revisions 1 2012.10.11 80% DD Submission MARK DATE DESCRIPTION LOT NUMBER: 115 DRAWN BY: TEAM CAPITOL DC
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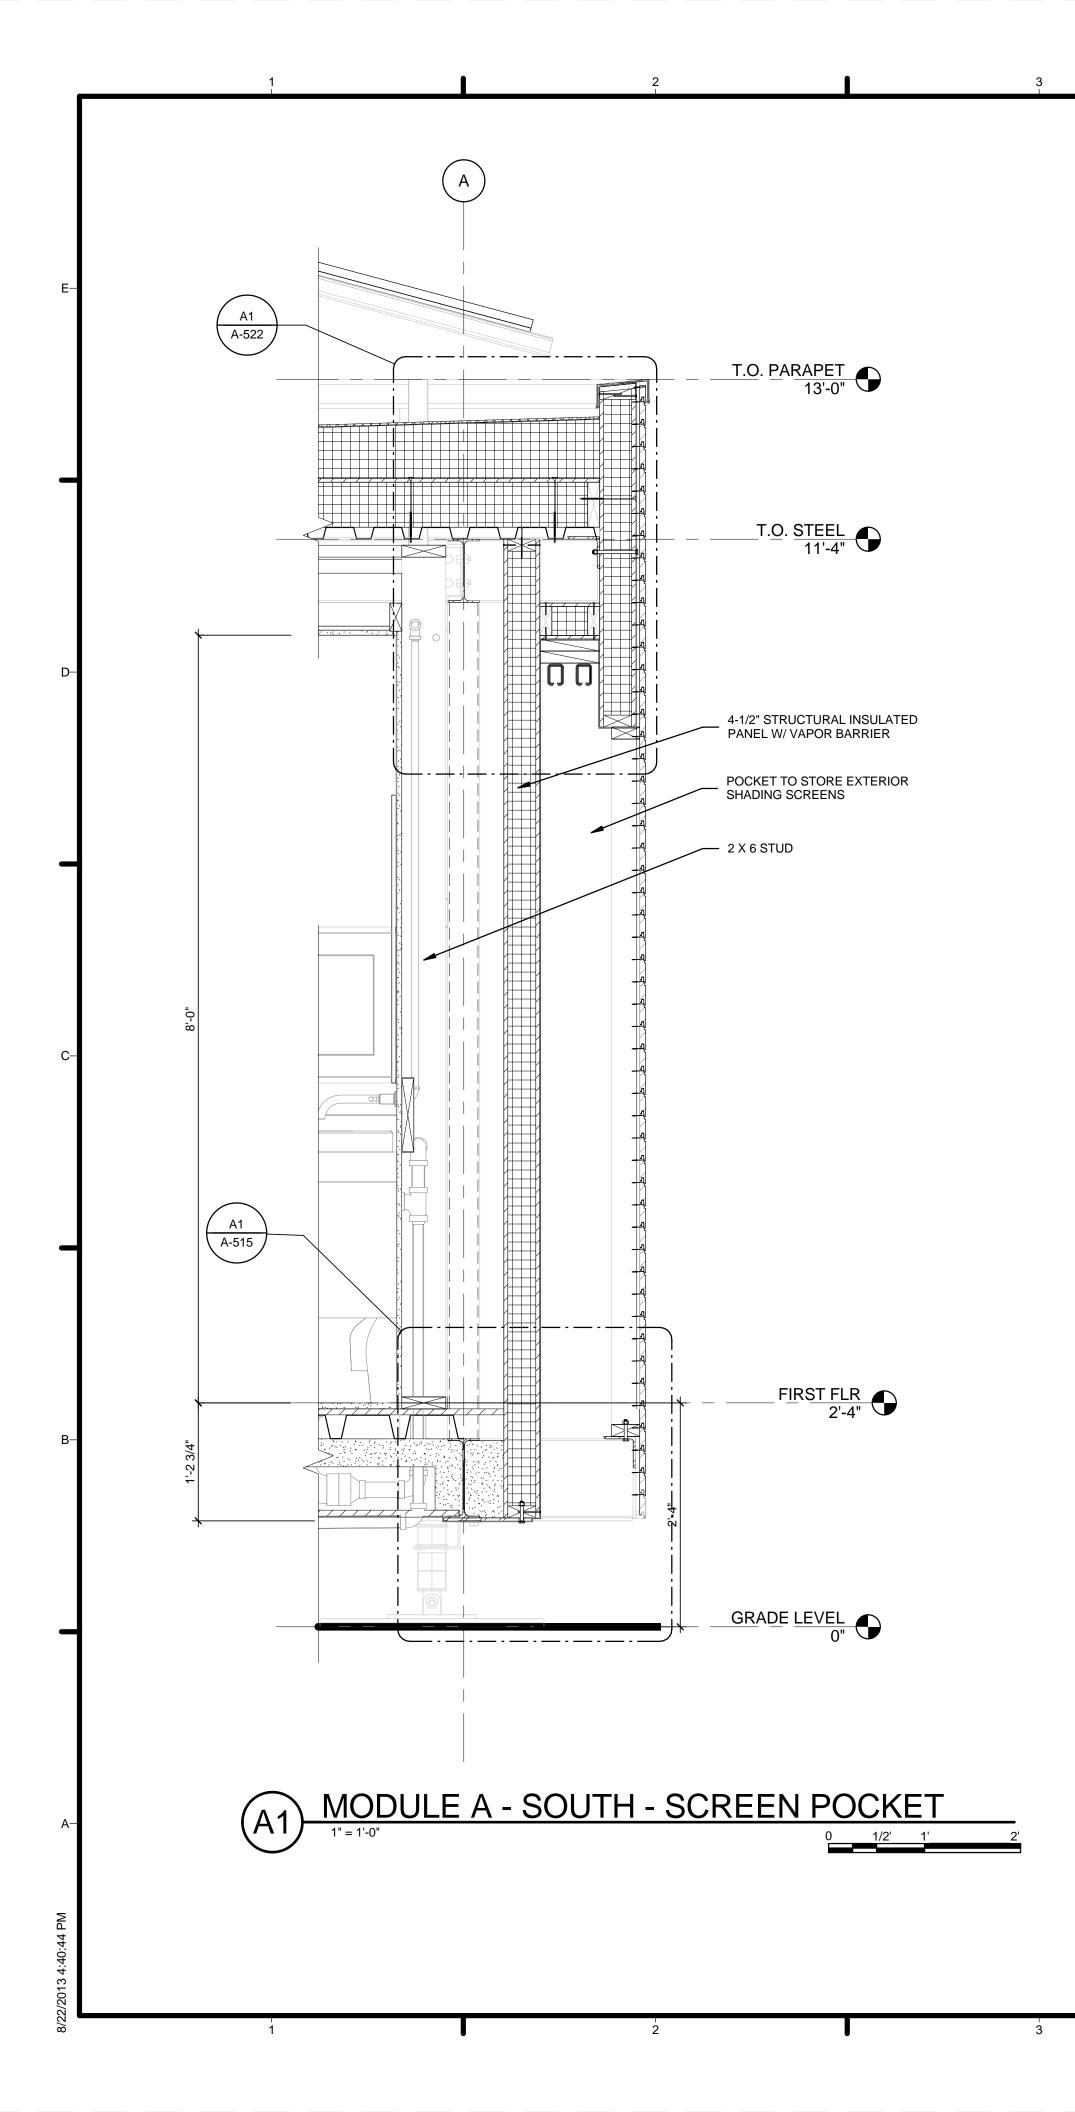


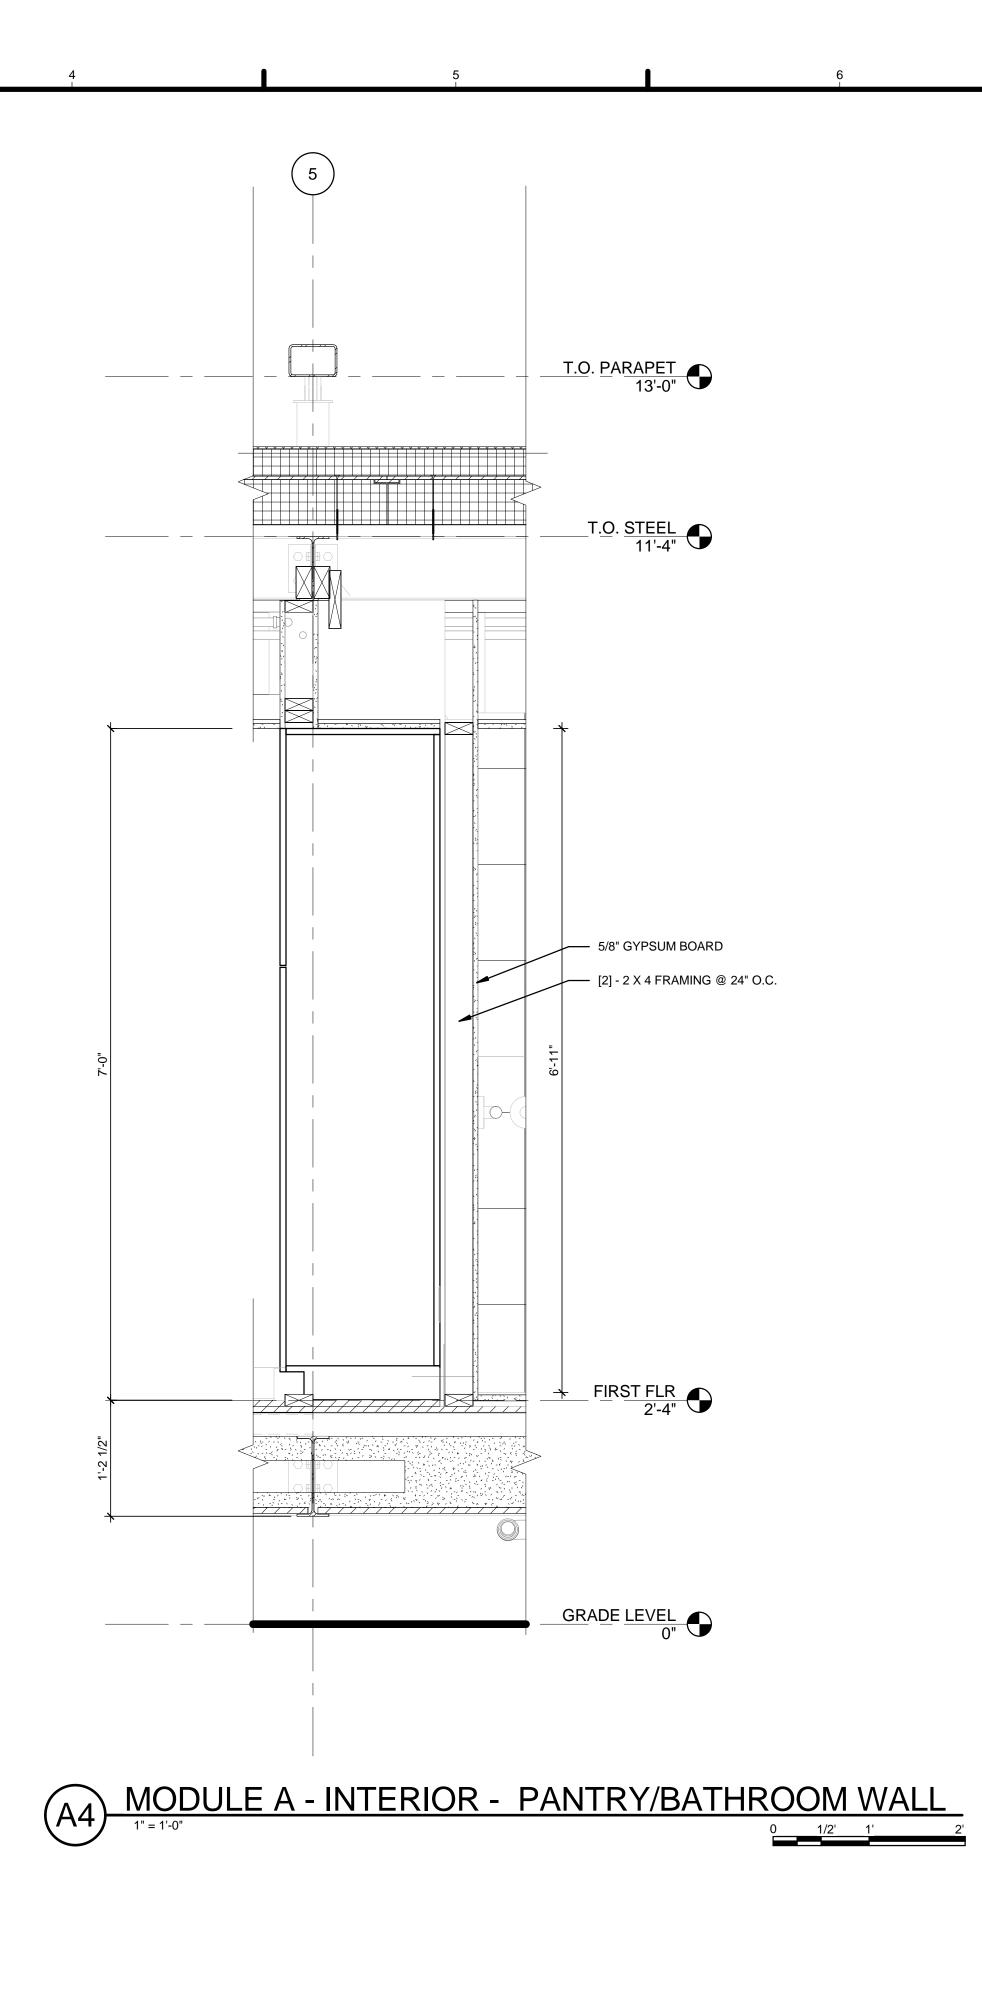
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7 GENERAL SHEET NOTES 1. VERIFY ALL DIMENSIONS IN FIELD PRIOR TO FABRICATION AND INSTALLATION SHERE SHEET NOTES REFERENCE KEYNOTES	E HARVEST TEAM NAME: Team Capitol dc ADDRESS: THE CATHOLIC UNIVERSITY OF AMERICA SCHOOL OF ARCHITECTURE 620 MICHIGAN AVENUE, NE. WASHINGTON, DC 20064 STRUCTURAL ENGINEER BOB ALLISON, PE ARUP ENGINEERING
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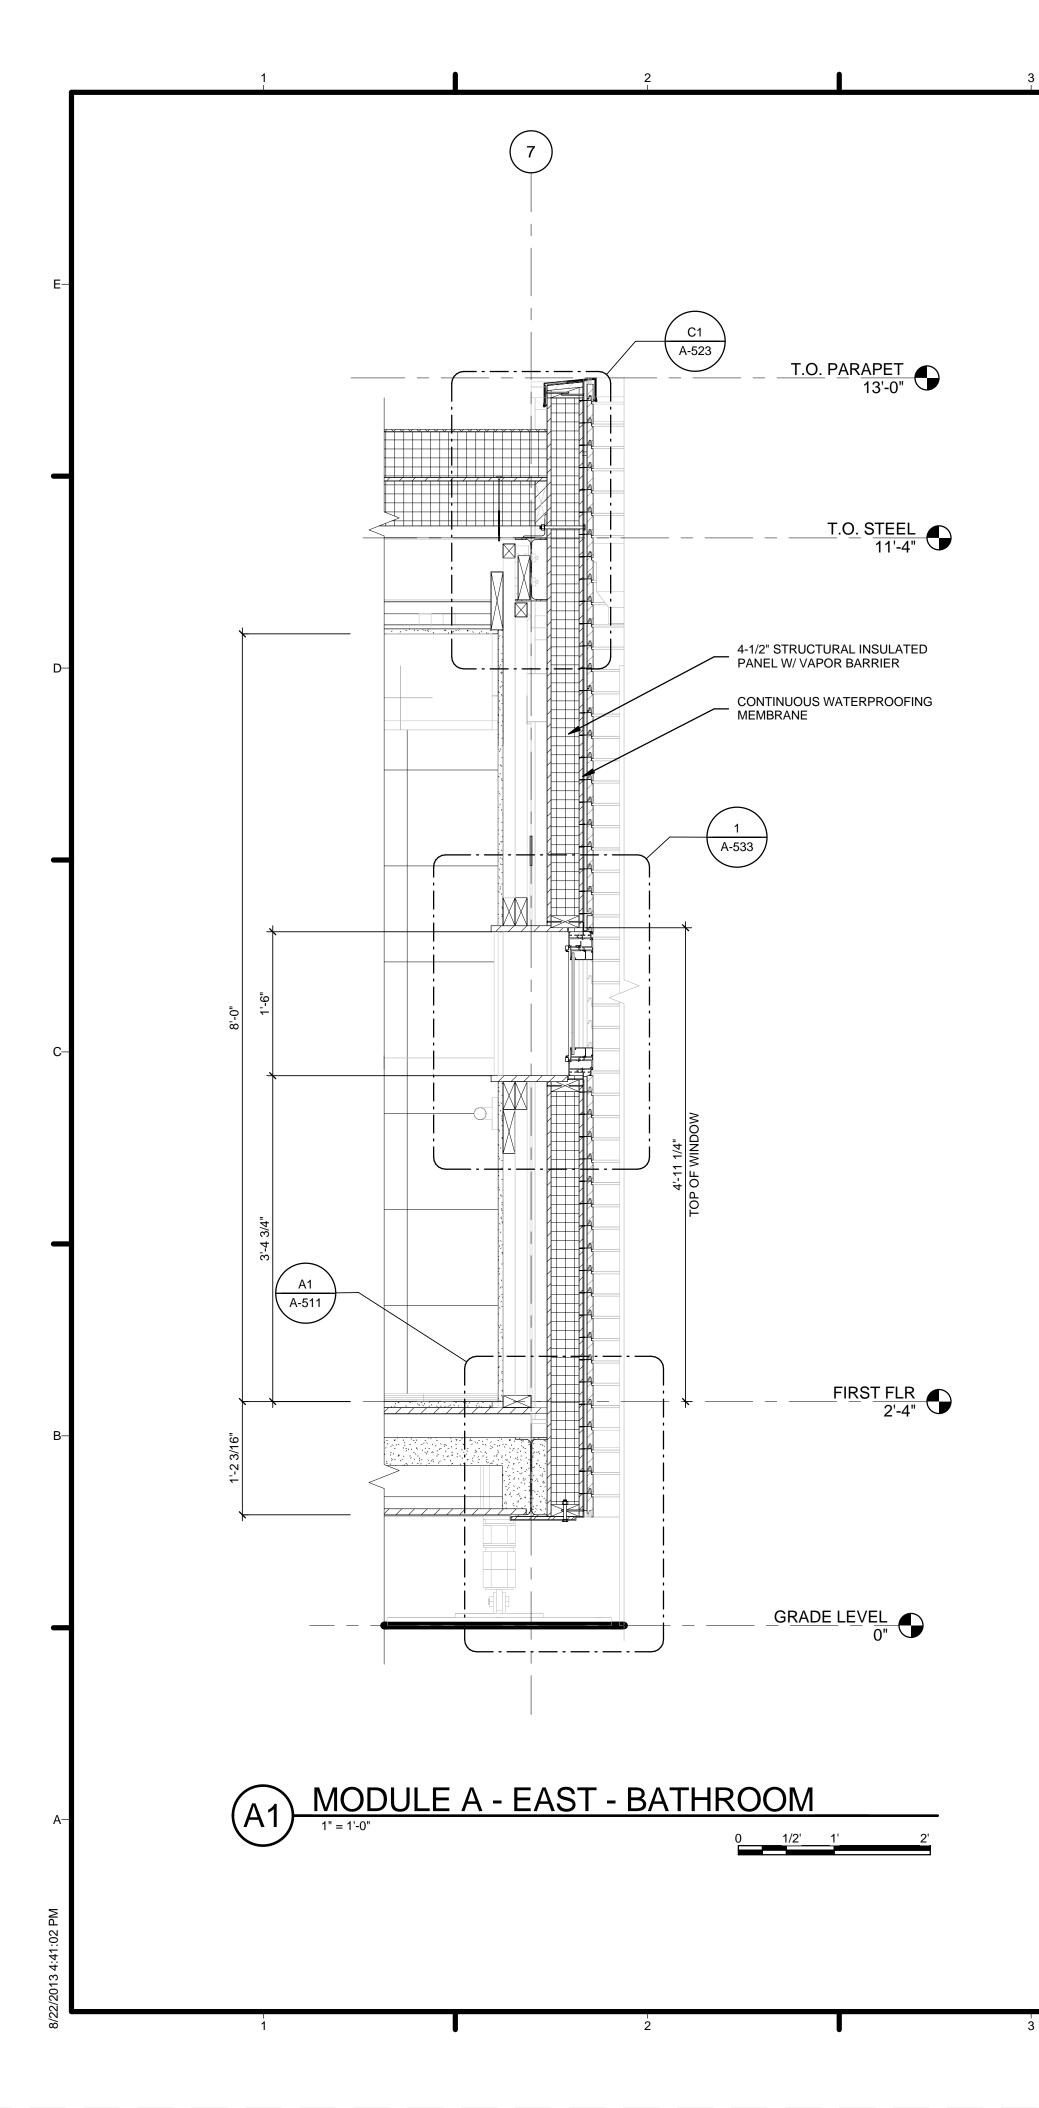


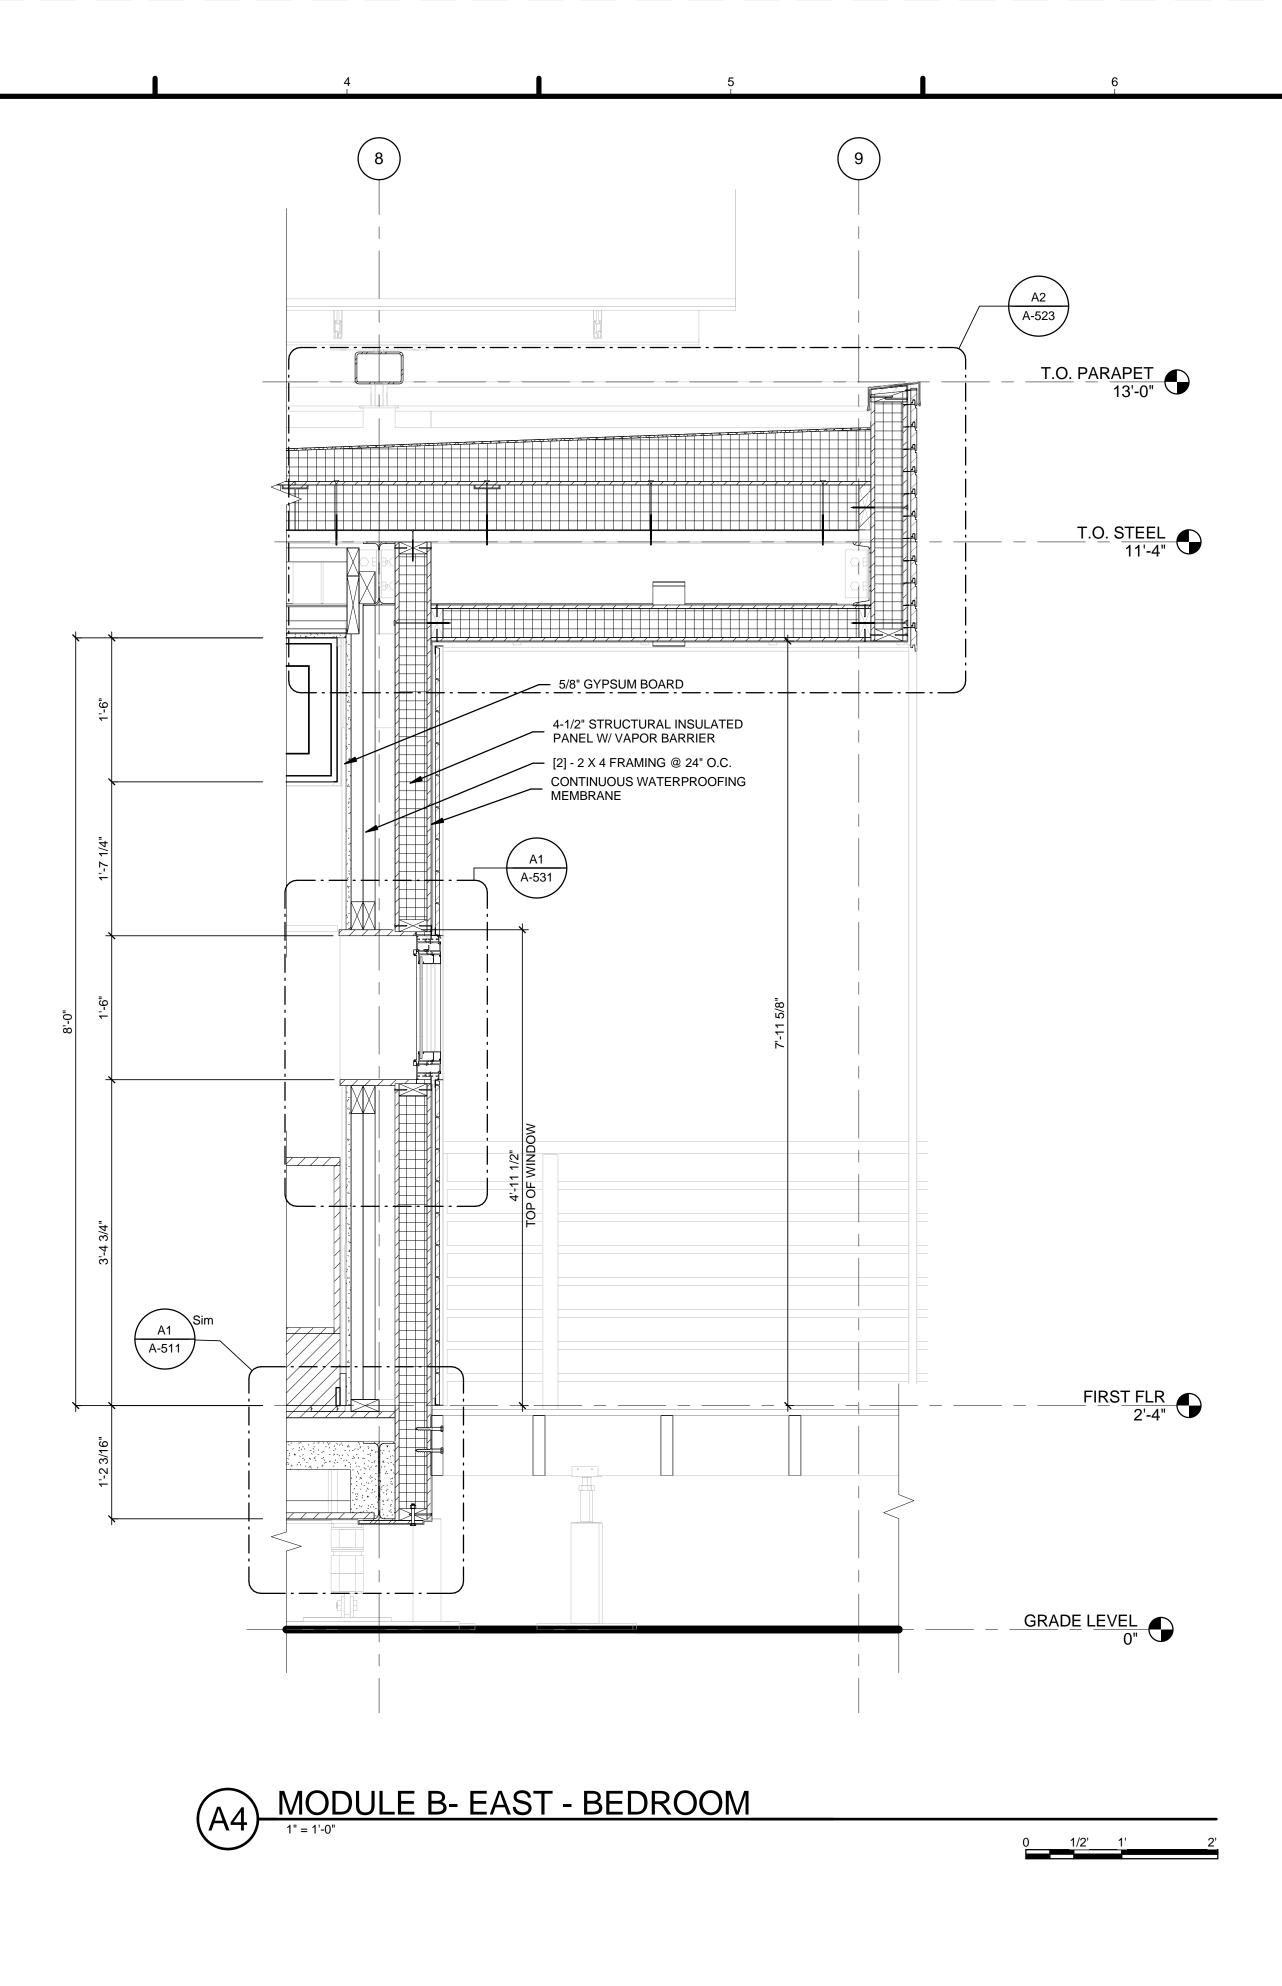
GENERAL SHEET NOTES	
 VERIFY ALL DIMENSIONS IN FIELD PRIOR TO FABRICATION AND INSTALLATION SEE SHEET C-102 FOR MODULE IDENTITY 	-E HARVEST L CAPITOL
REFERENCE KEYNOTES	TEAM NAME: Team Capitol de ADDRESS: THE CATHOLIC UNIVERSITY OF AMERICA SCHOOL OF ARCHITECTURE 620 MICHIGAN AVENUE, NE WASHINGTON, DC 20064
05 12 23.C2 L 4 X 4 X 5/16 06 12 00.A2 4-1/2" STRUCTURAL INSULATED PANEL W/ VAPOR BARRIER 09 29 10.A3 5/8" GYPSUM BOARD	BOB ALLISON, PE ARUP ENGINEERING 1120 CONNECTICUT AVENUE, NW., SUITE 200 WASHINGTON, DC 20036 TEL: 202.729.8220
	D HEL: 202.125.0220 MEP ENGINEER ARUP ENGINEERING 1120 CONNECTICUT AVENUE, NW., SUITE 200 WASHINGTON, DC 20036 TEL: 202.729.8220 ARCHITECT OF RECORD WILLIAM JELEN, AIA 620 MICHIGAN AVE NE CROUGH CENTER WASHINGTON, DC 20064 TEL: 202.344.5513
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	CLIENT U.S. DEPARTMENT OF ENERGY
SHEET KEYNOTES	SOLAR DECATHLON 2013
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05 CONTINUOUS WATERPROOFING MEMBRANE 37 EXTERIOR SHADING SCREENS. REFER TO SHEET A-604	U.S. DEPARTMENT OF ENERGY SOLAR DECATHLON
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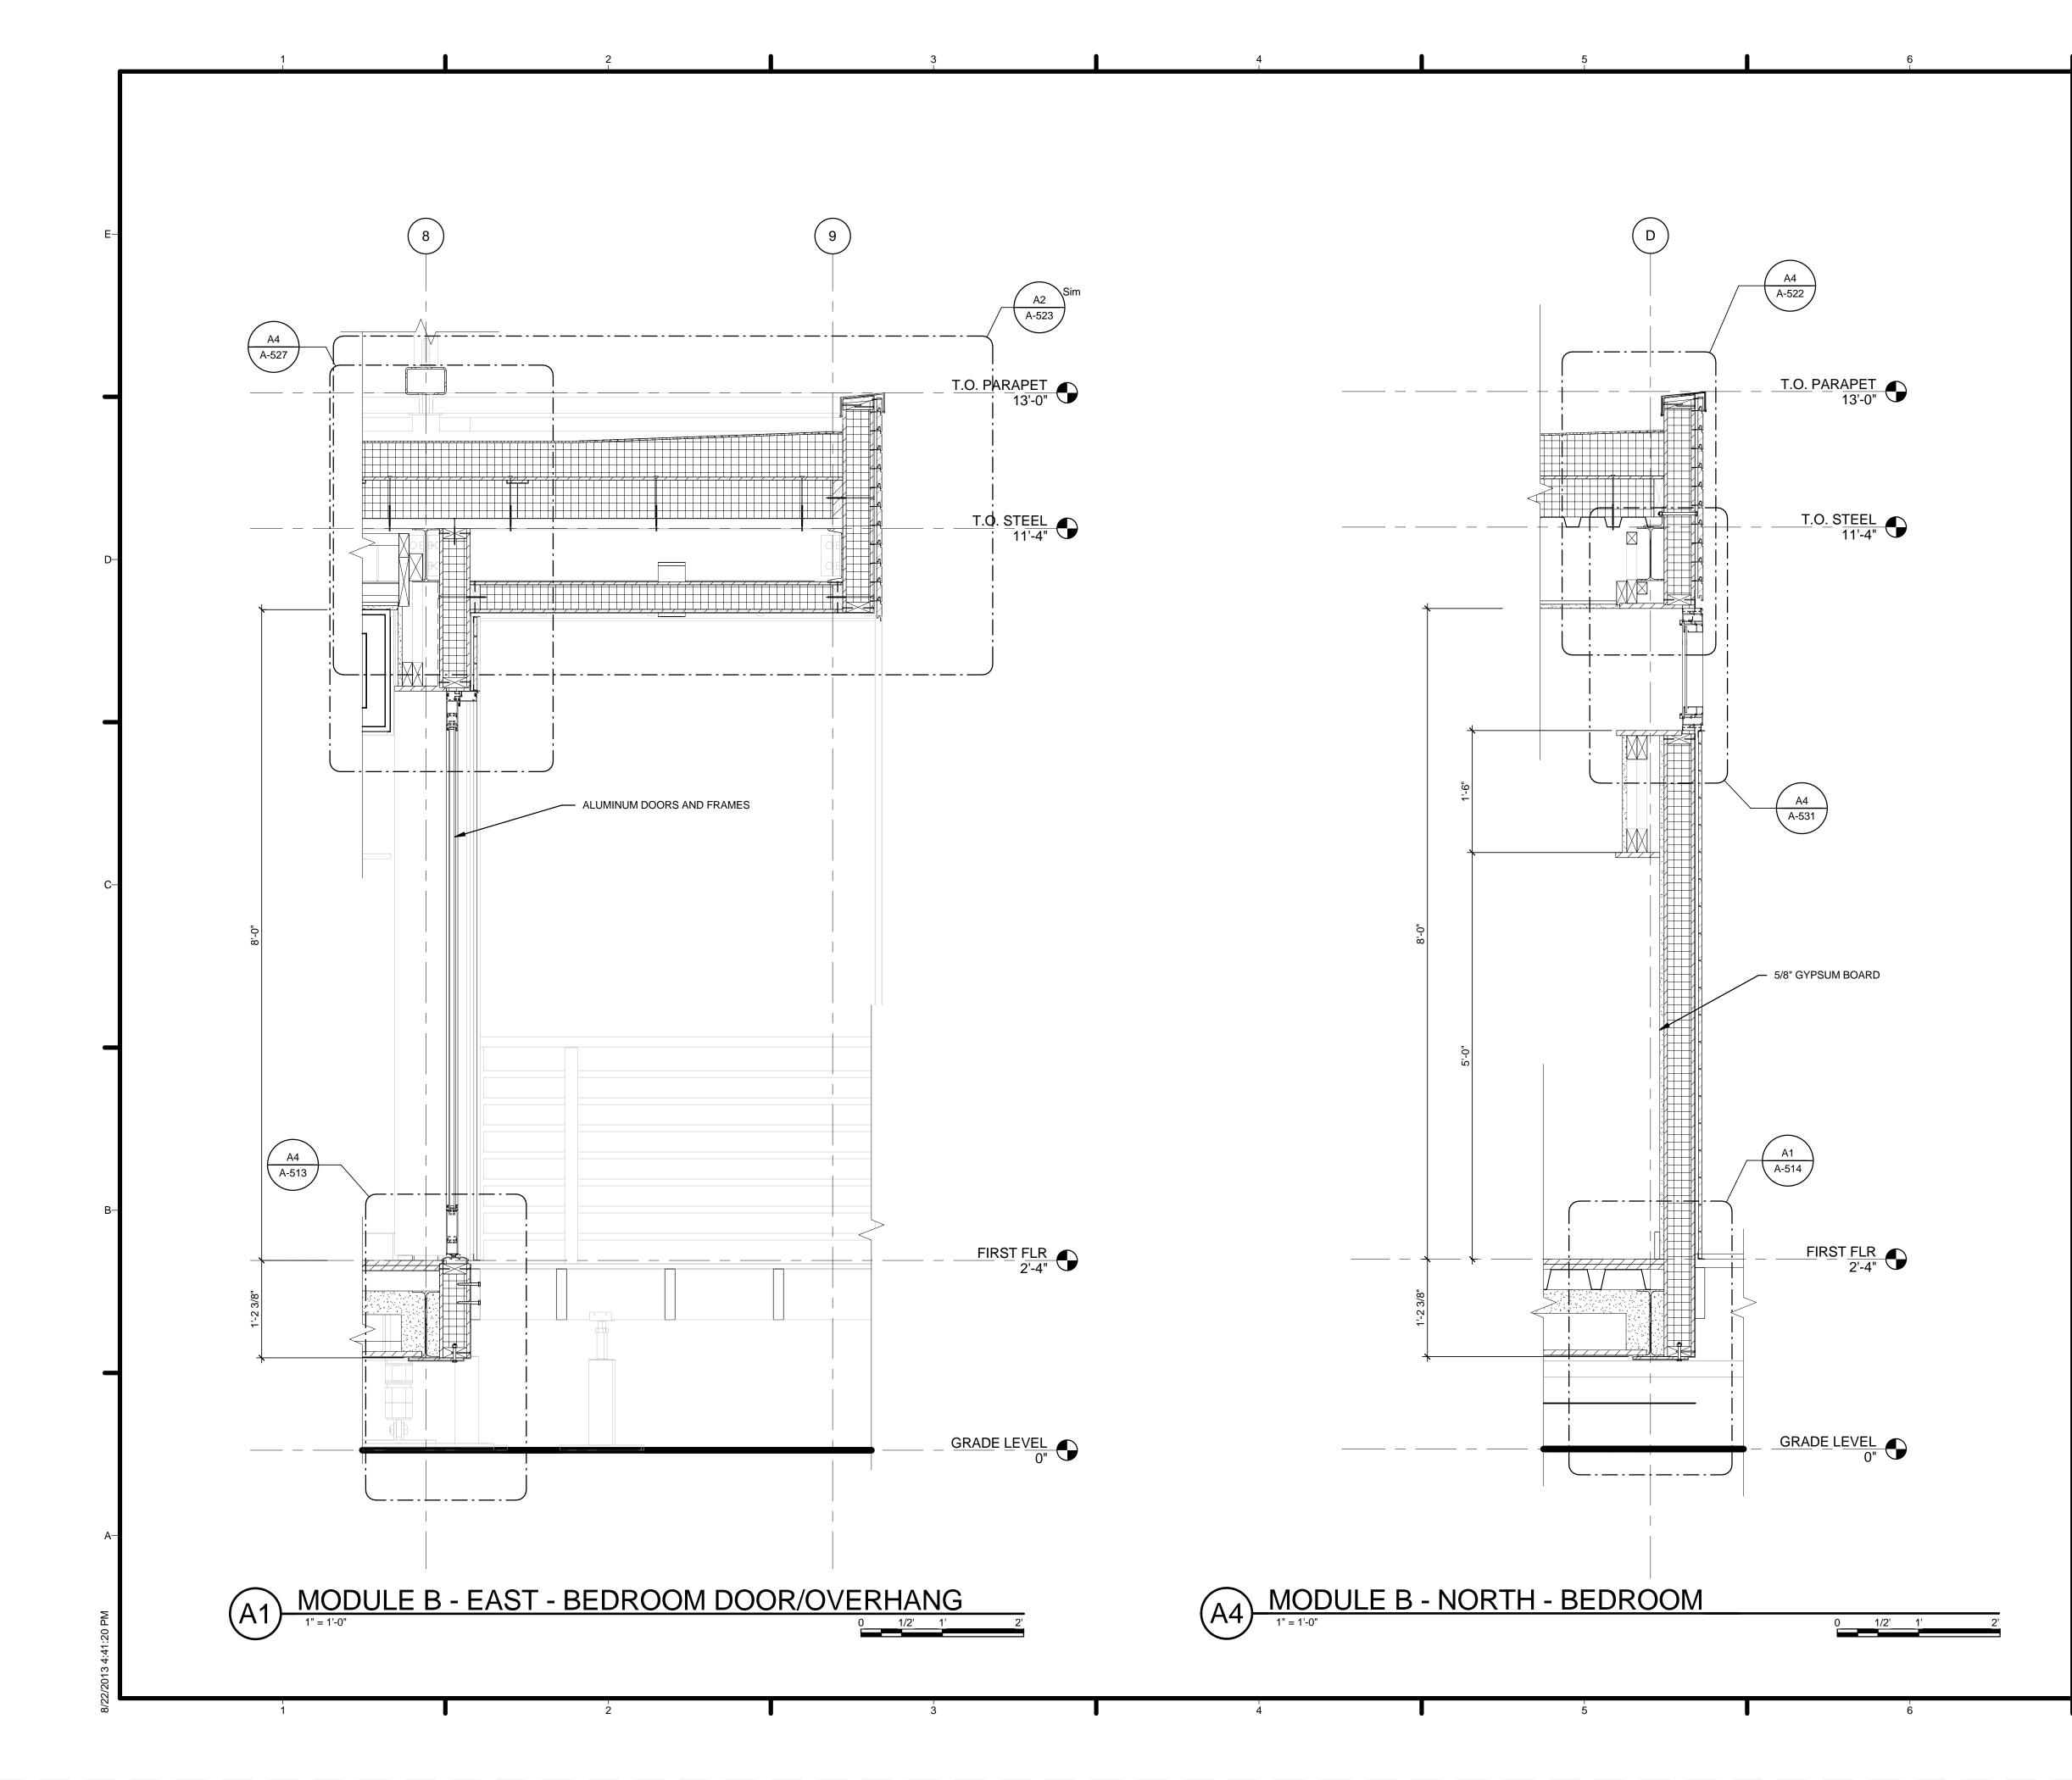


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		ARUP ENGINEERING 1120 CONNECTICUT AVENUE, NW., SUITE 200 WASHINGTON, DC 20036 TEL: 202.729.8220 ARCHITECT OF RECORD WILLIAM JELEN, AIA 620 MICHIGAN AVE NE CROUGH CENTER WASHINGTON, DC 20064 TEL: 202.344.5513
SHEET KEYNOTES 38 POCKET TO STORE EXTERIOR SHADING	-c	CLIENT U.S. DEPARTMENT OF ENERGY SOLAR DECATHLON 2013 WWW.SOLARDECATHLON.GOV
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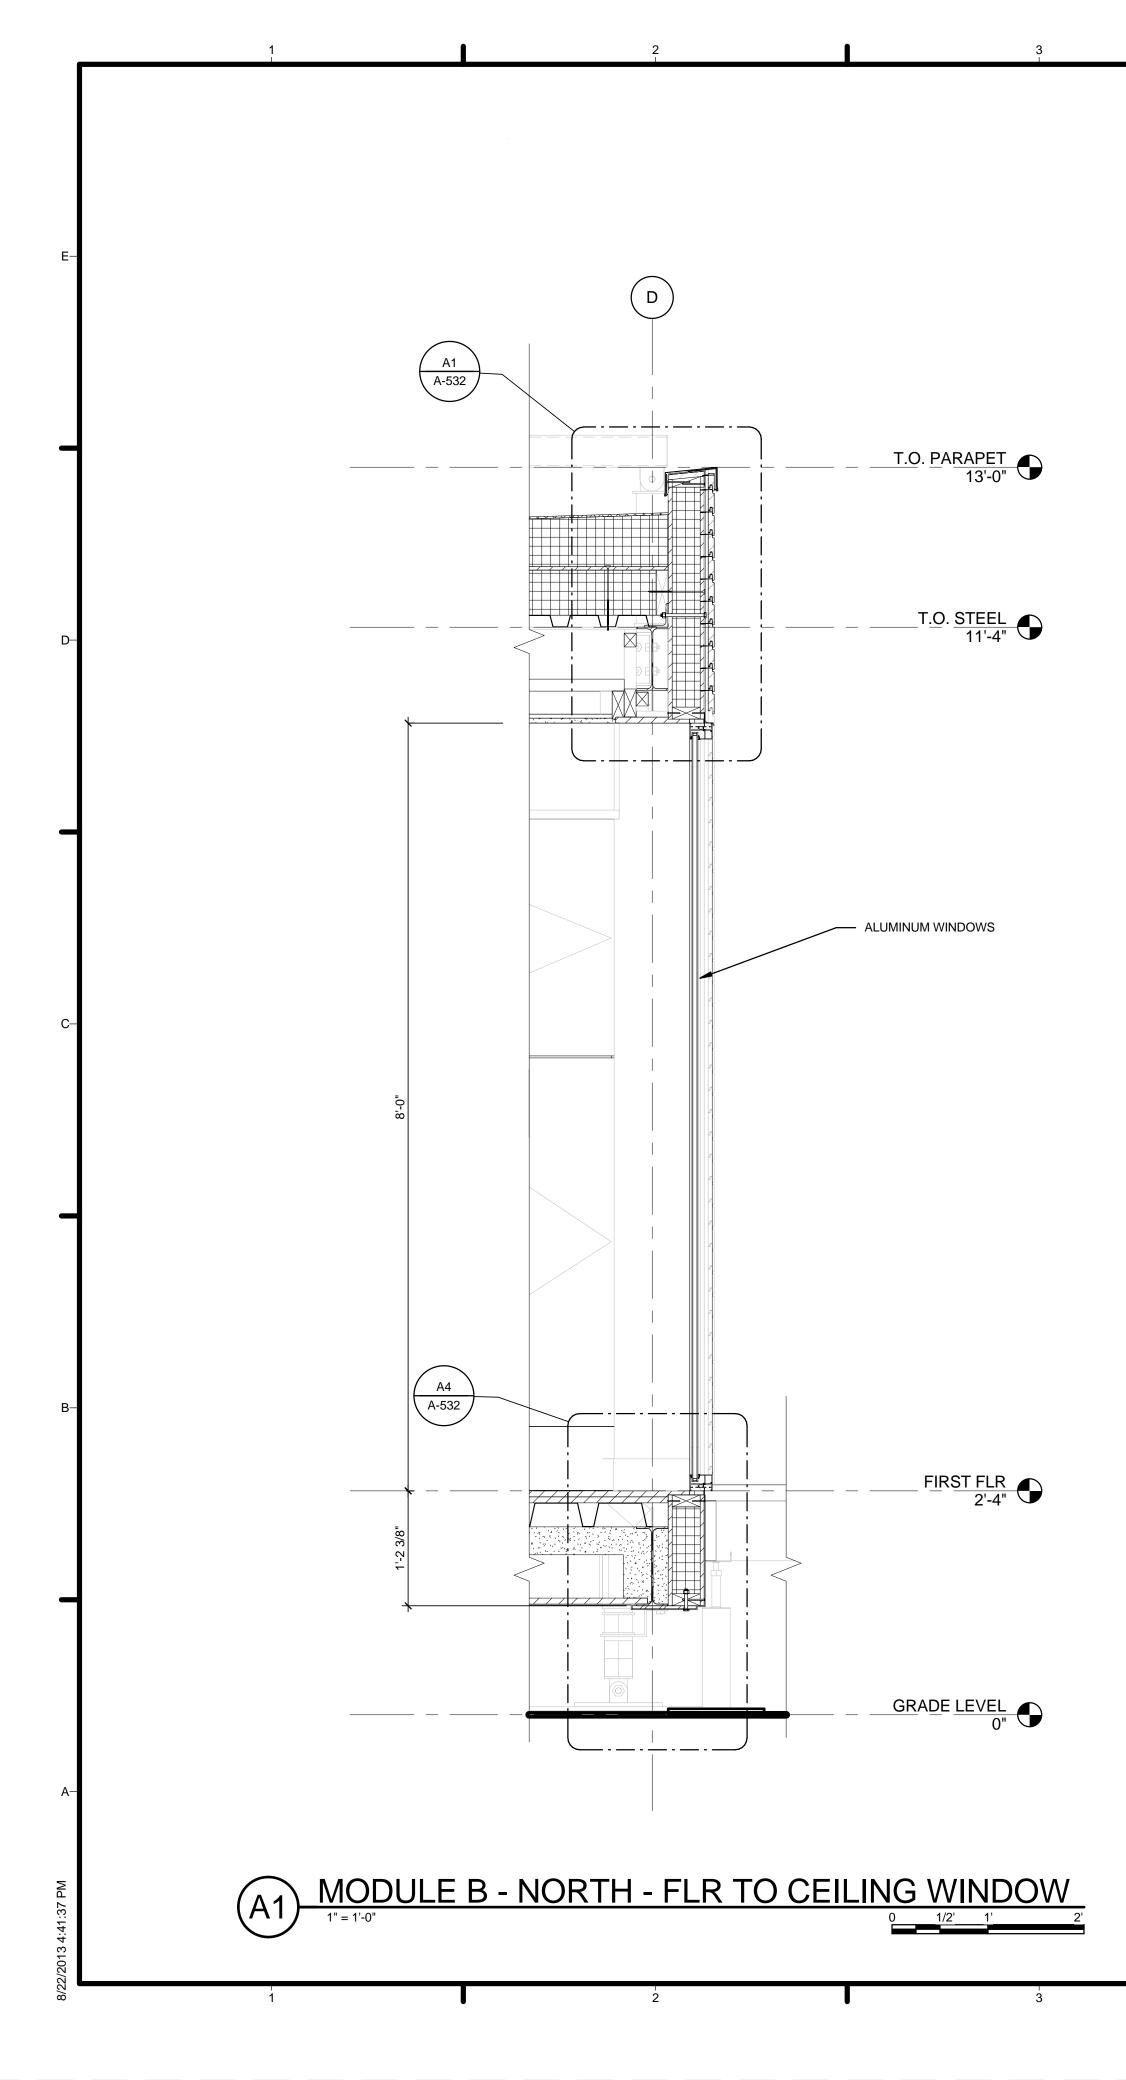


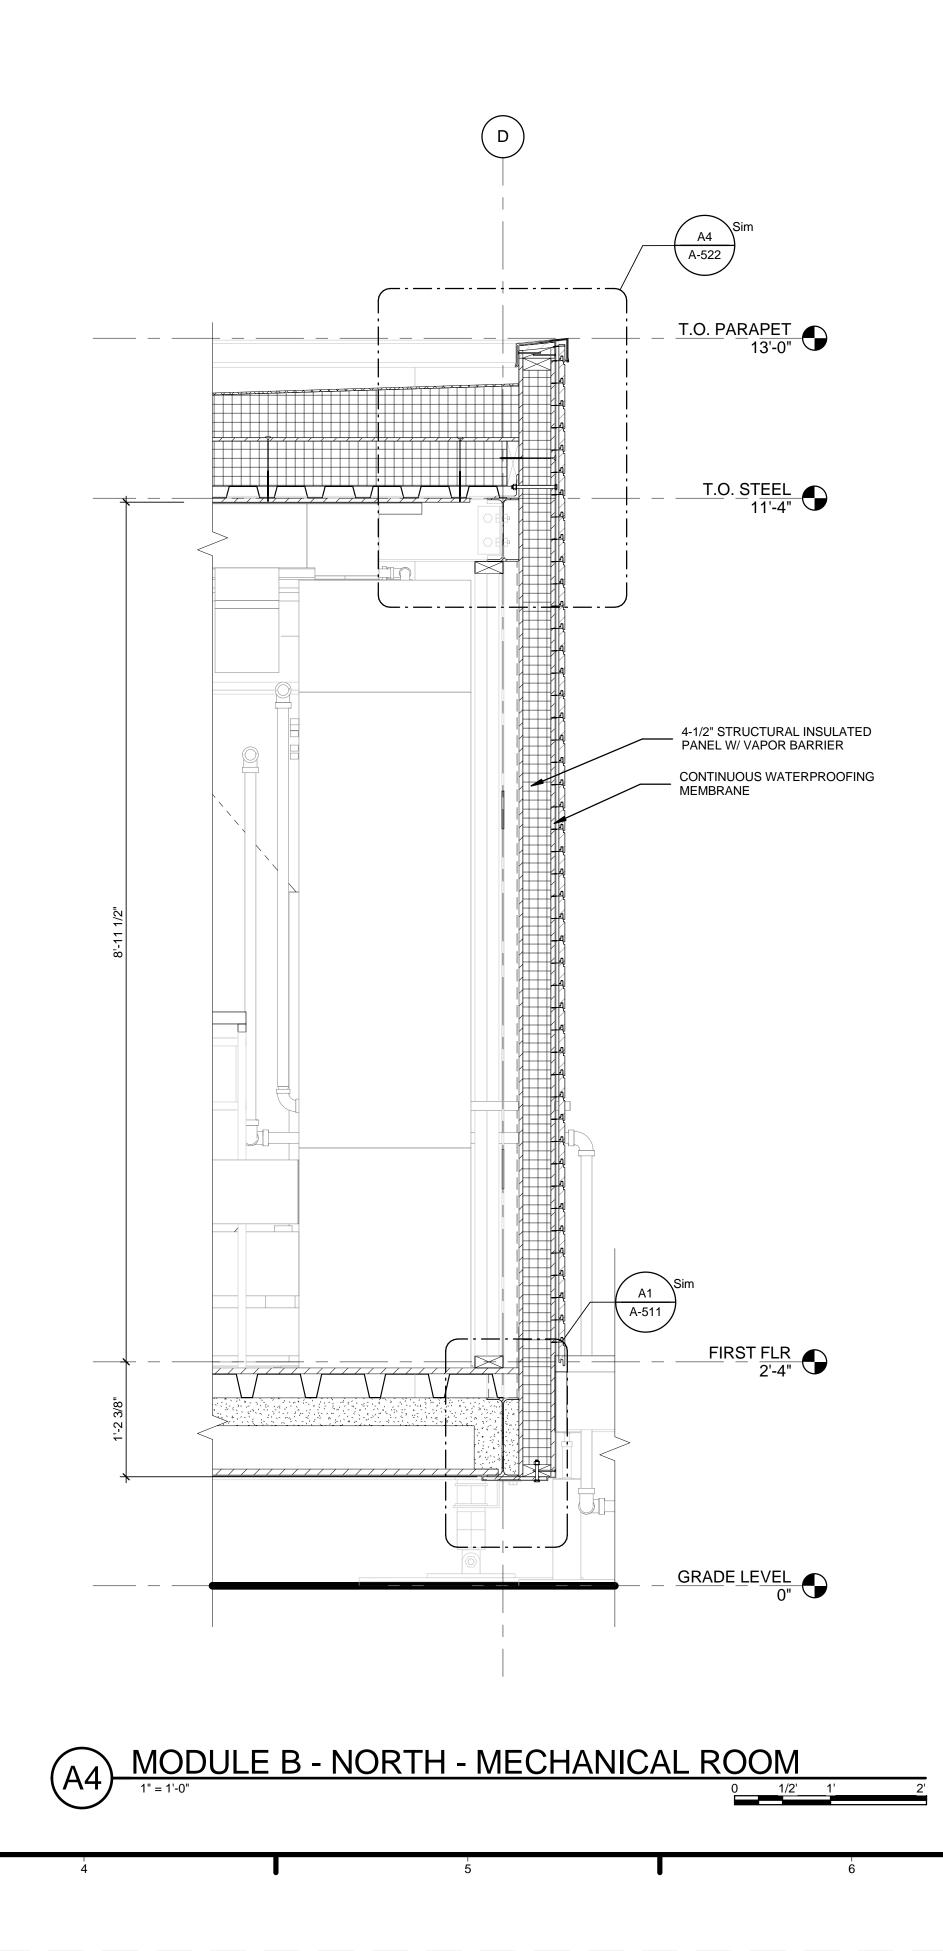


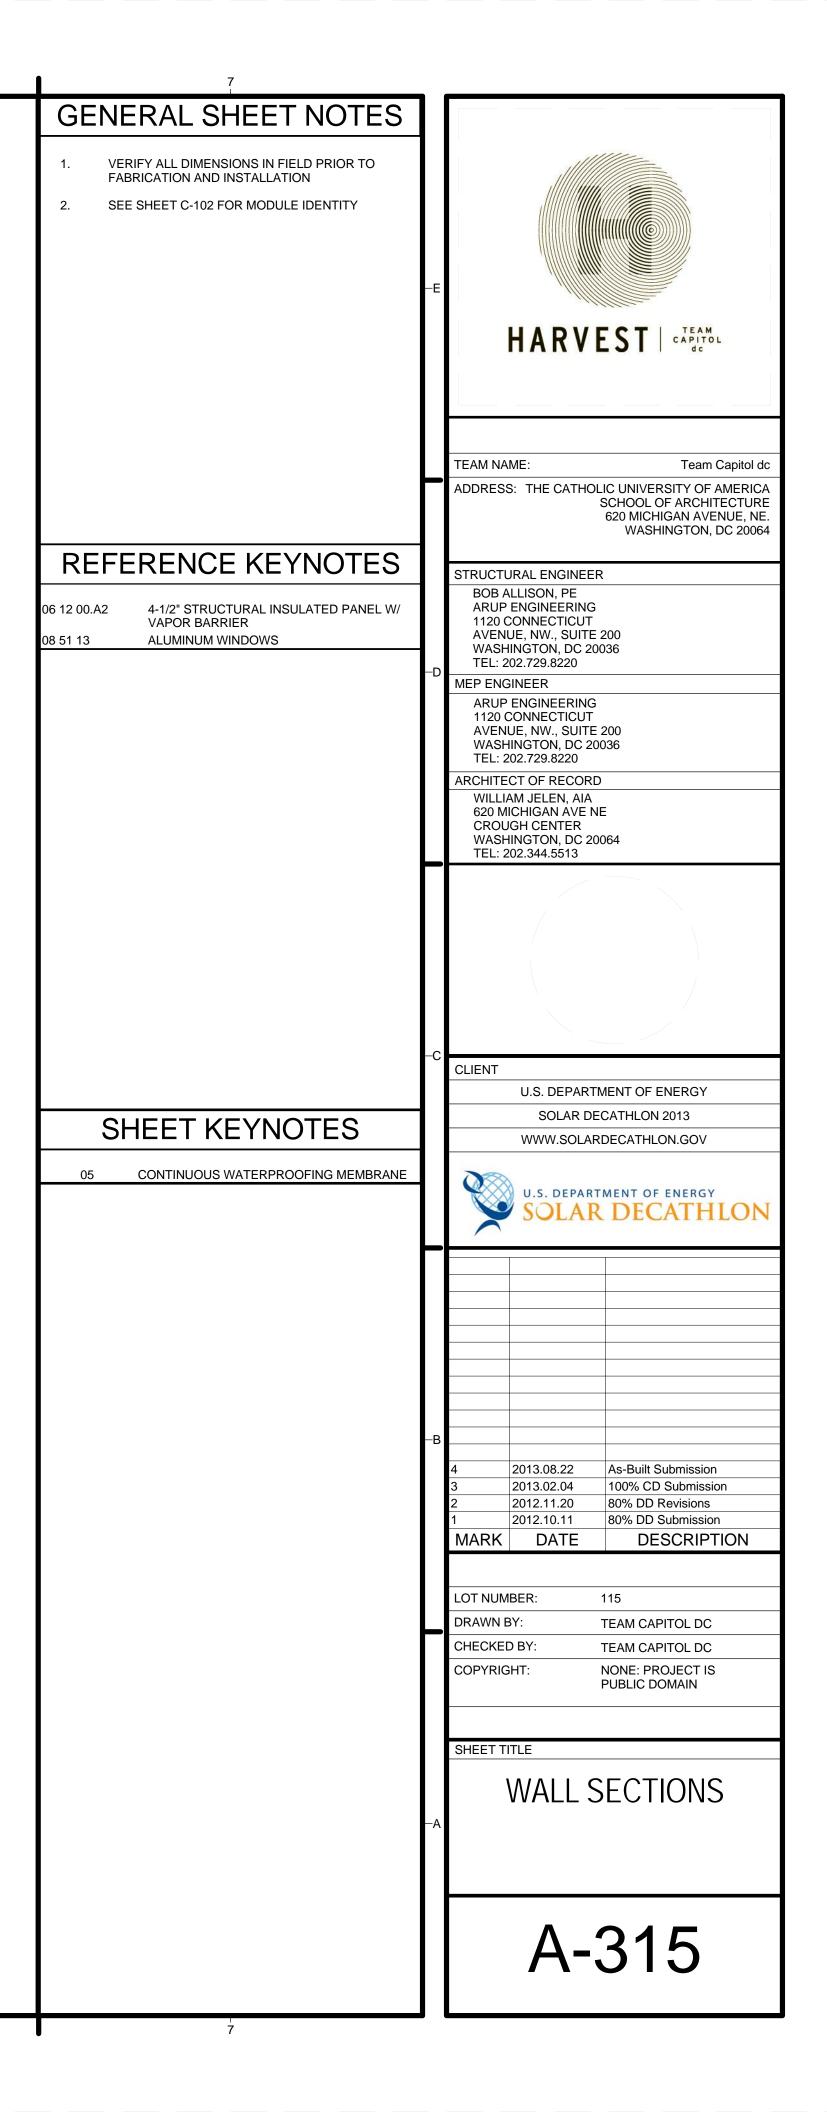
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REFERENCE KEYNOTES		TEAM NAME: Team Capitol dc ADDRESS: THE CATHOLIC UNIVERSITY OF AMERICA SCHOOL OF ARCHITECTURE 620 MICHIGAN AVENUE, NE. WASHINGTON, DC 20064
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		ARCHITECT OF RECORD WILLIAM JELEN, AIA 620 MICHIGAN AVE NE CROUGH CENTER WASHINGTON, DC 20064 TEL: 202.344.5513
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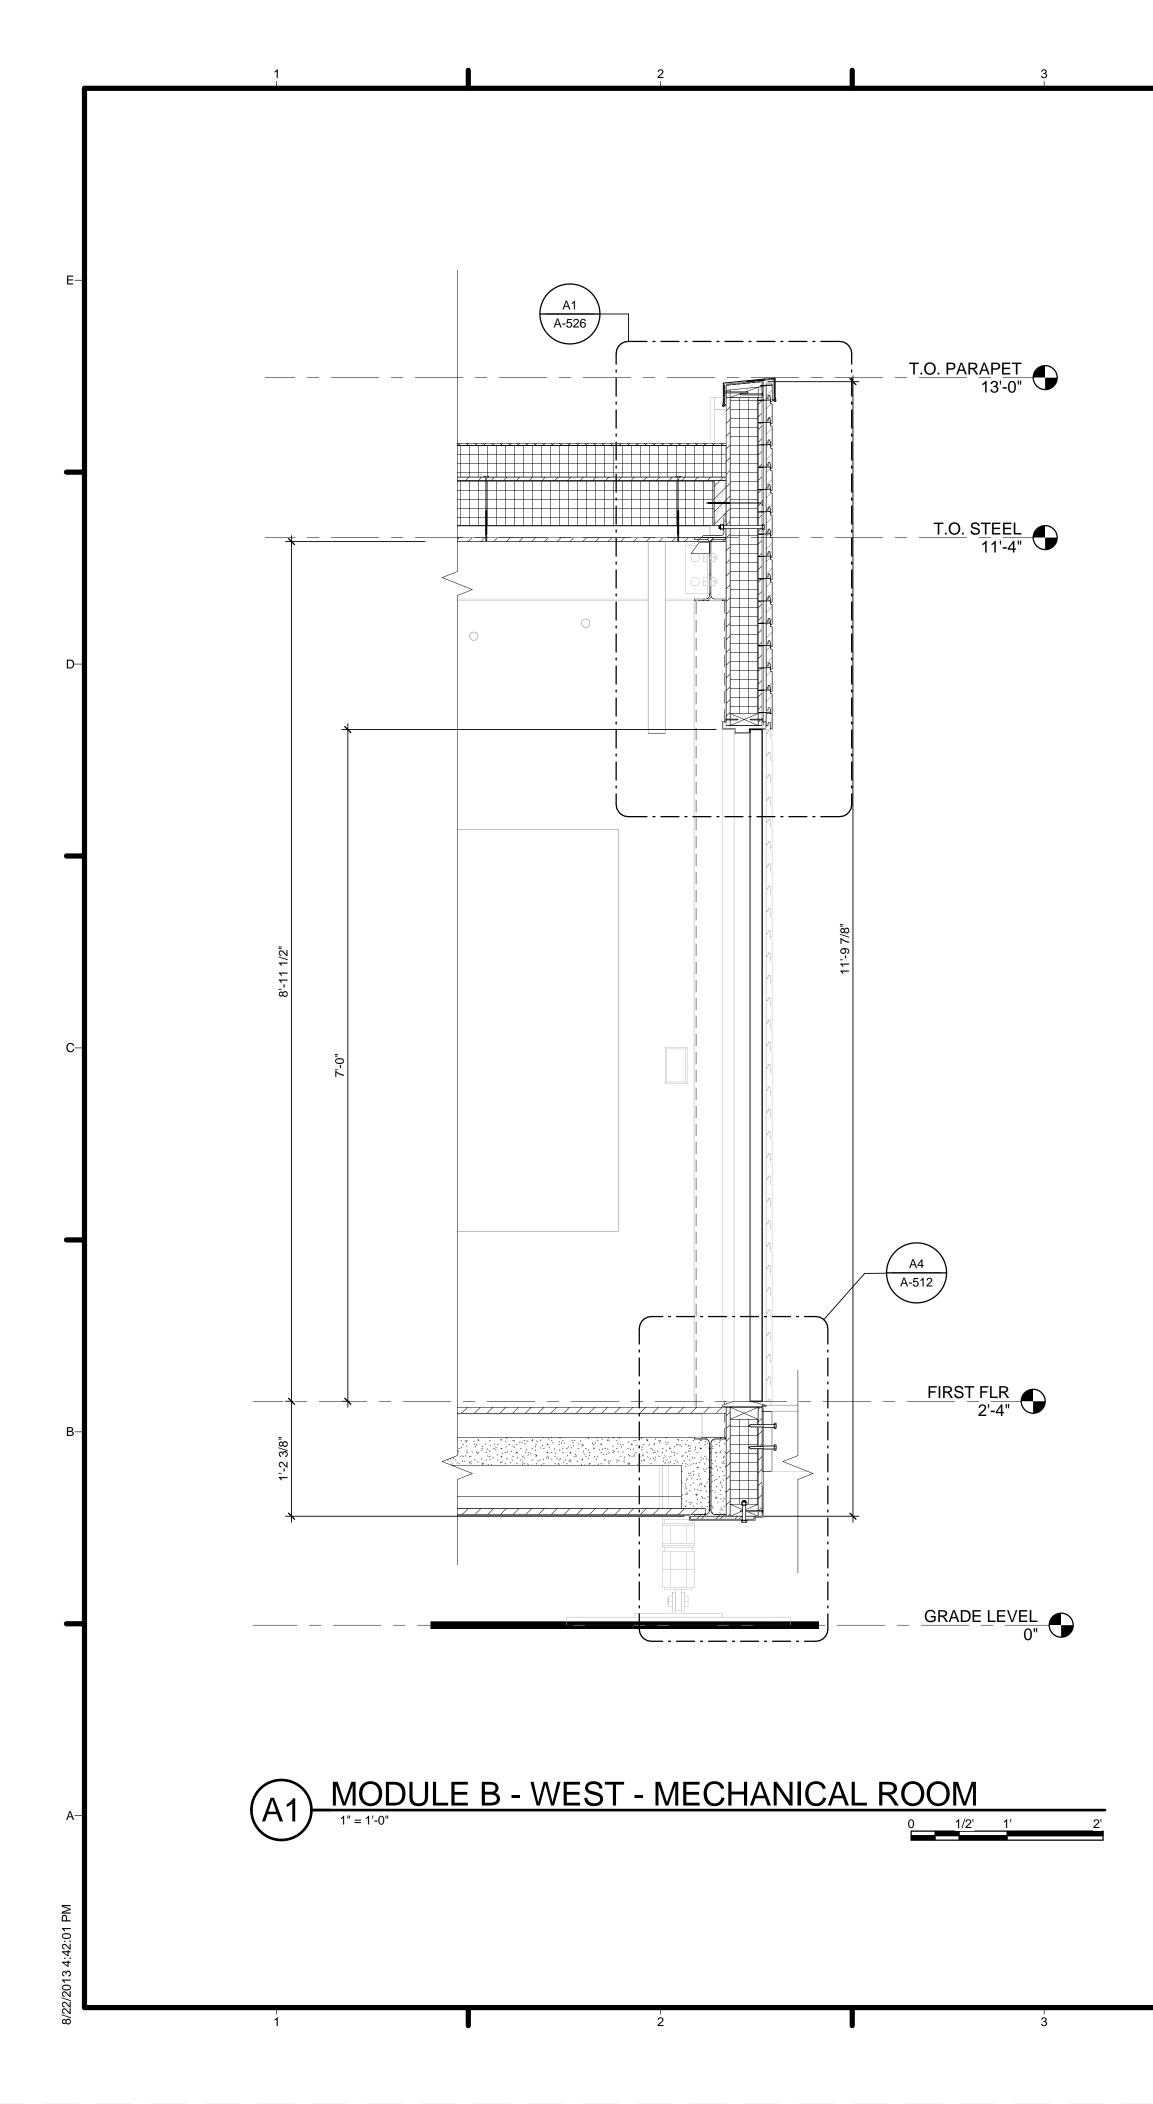


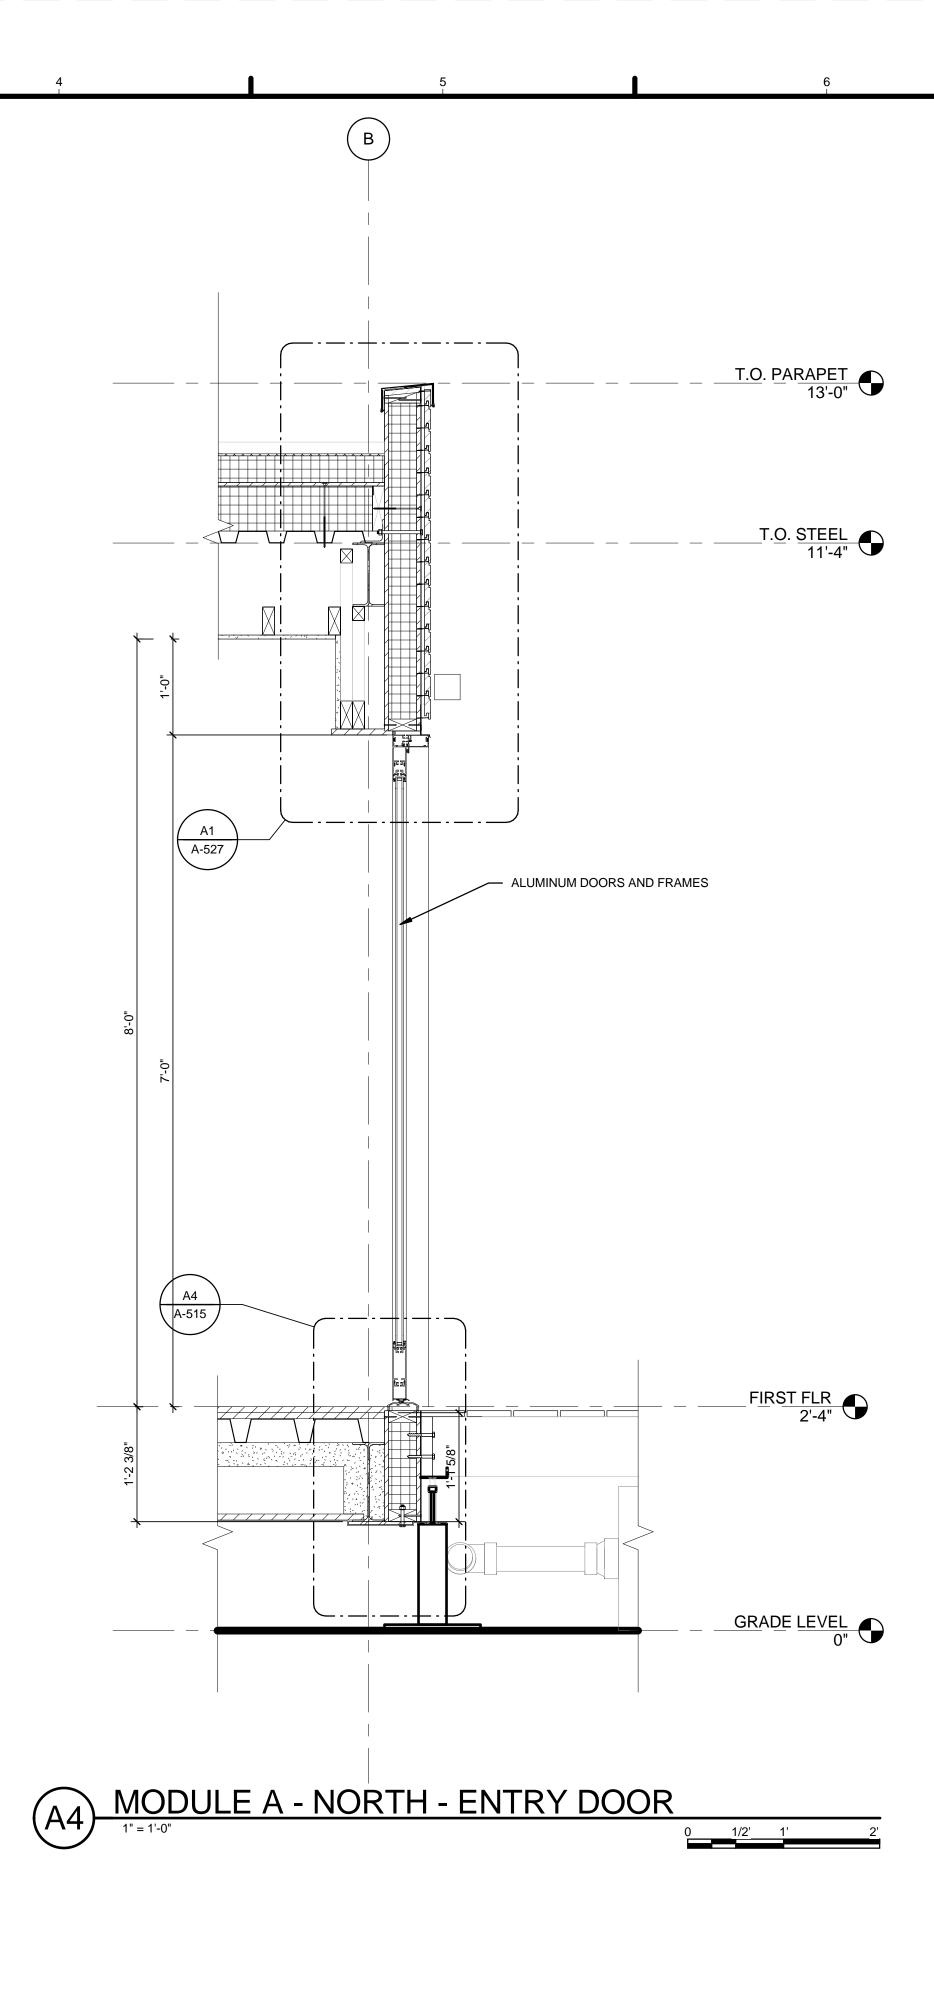
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		TEAM NAME: Team Capitol dc
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		SCHOOL OF ARCHITECTURE 620 MICHIGAN AVENUE, NE. WASHINGTON, DC 20064
REFERENCE KEYNOTES		
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08 11 16 ALUMINUM DOORS AND FRAMES		ARUP ENGINEERING 1120 CONNECTICUT
09 29 10.A3 5/8" GYPSUM BOARD		AVENUE, NW., SUITE 200 WASHINGTON, DC 20036
	-D	TEL: 202.729.8220 MEP ENGINEER
		ARUP ENGINEERING
		1120 CONNECTICUT AVENUE, NW., SUITE 200 WASHINGTON, DC 20036
		TEL: 202.729.8220
		ARCHITECT OF RECORD WILLIAM JELEN, AIA
		620 MICHIGAN AVE NE CROUGH CENTER WASHINGTON, DC 20064
	L	WASHINGTON, DC 20064 TEL: 202.344.5513
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		U.S. DEPARTMENT OF ENERGY SOLAR DECATHLON 2013
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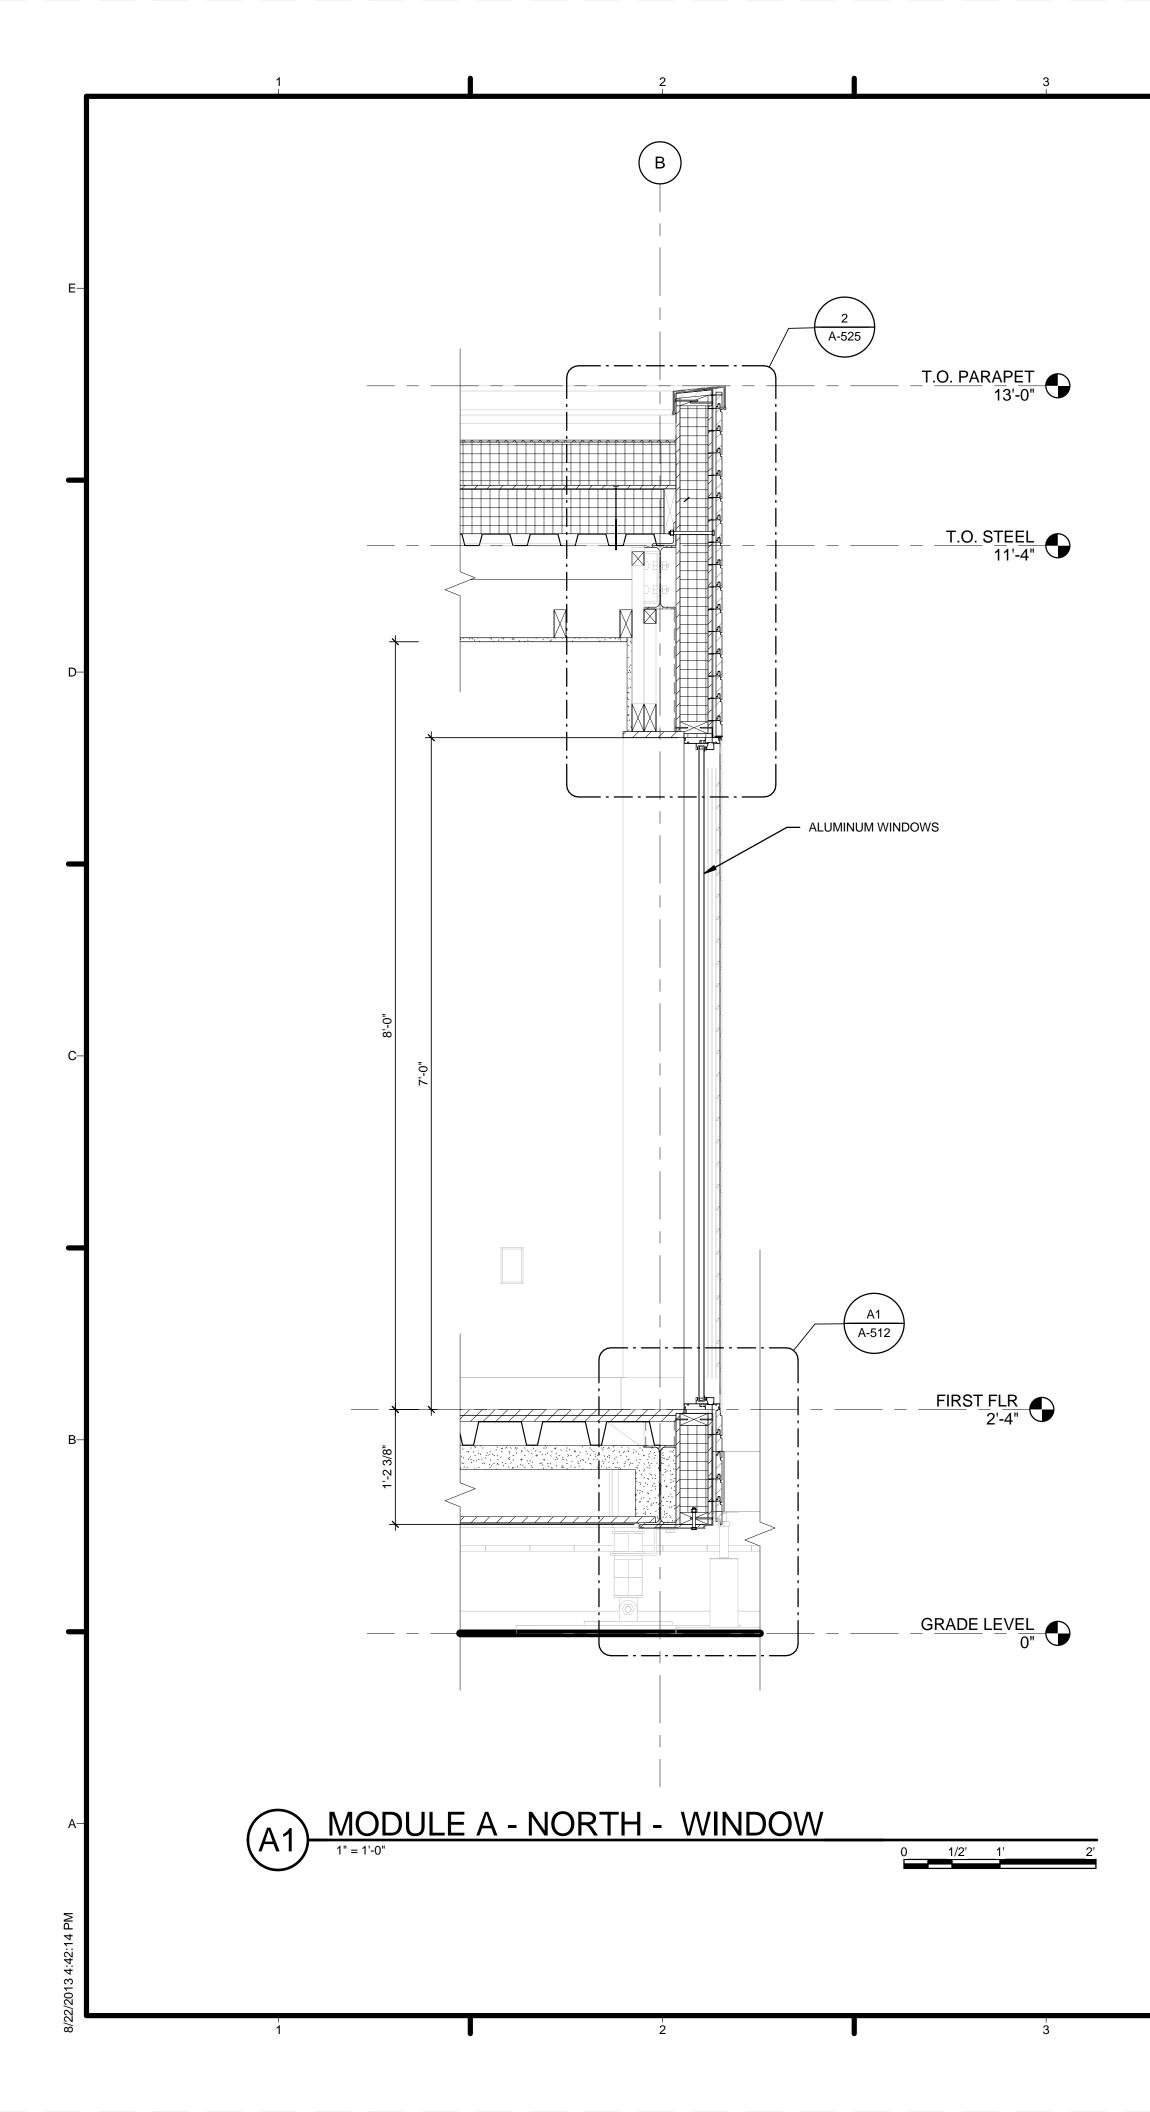


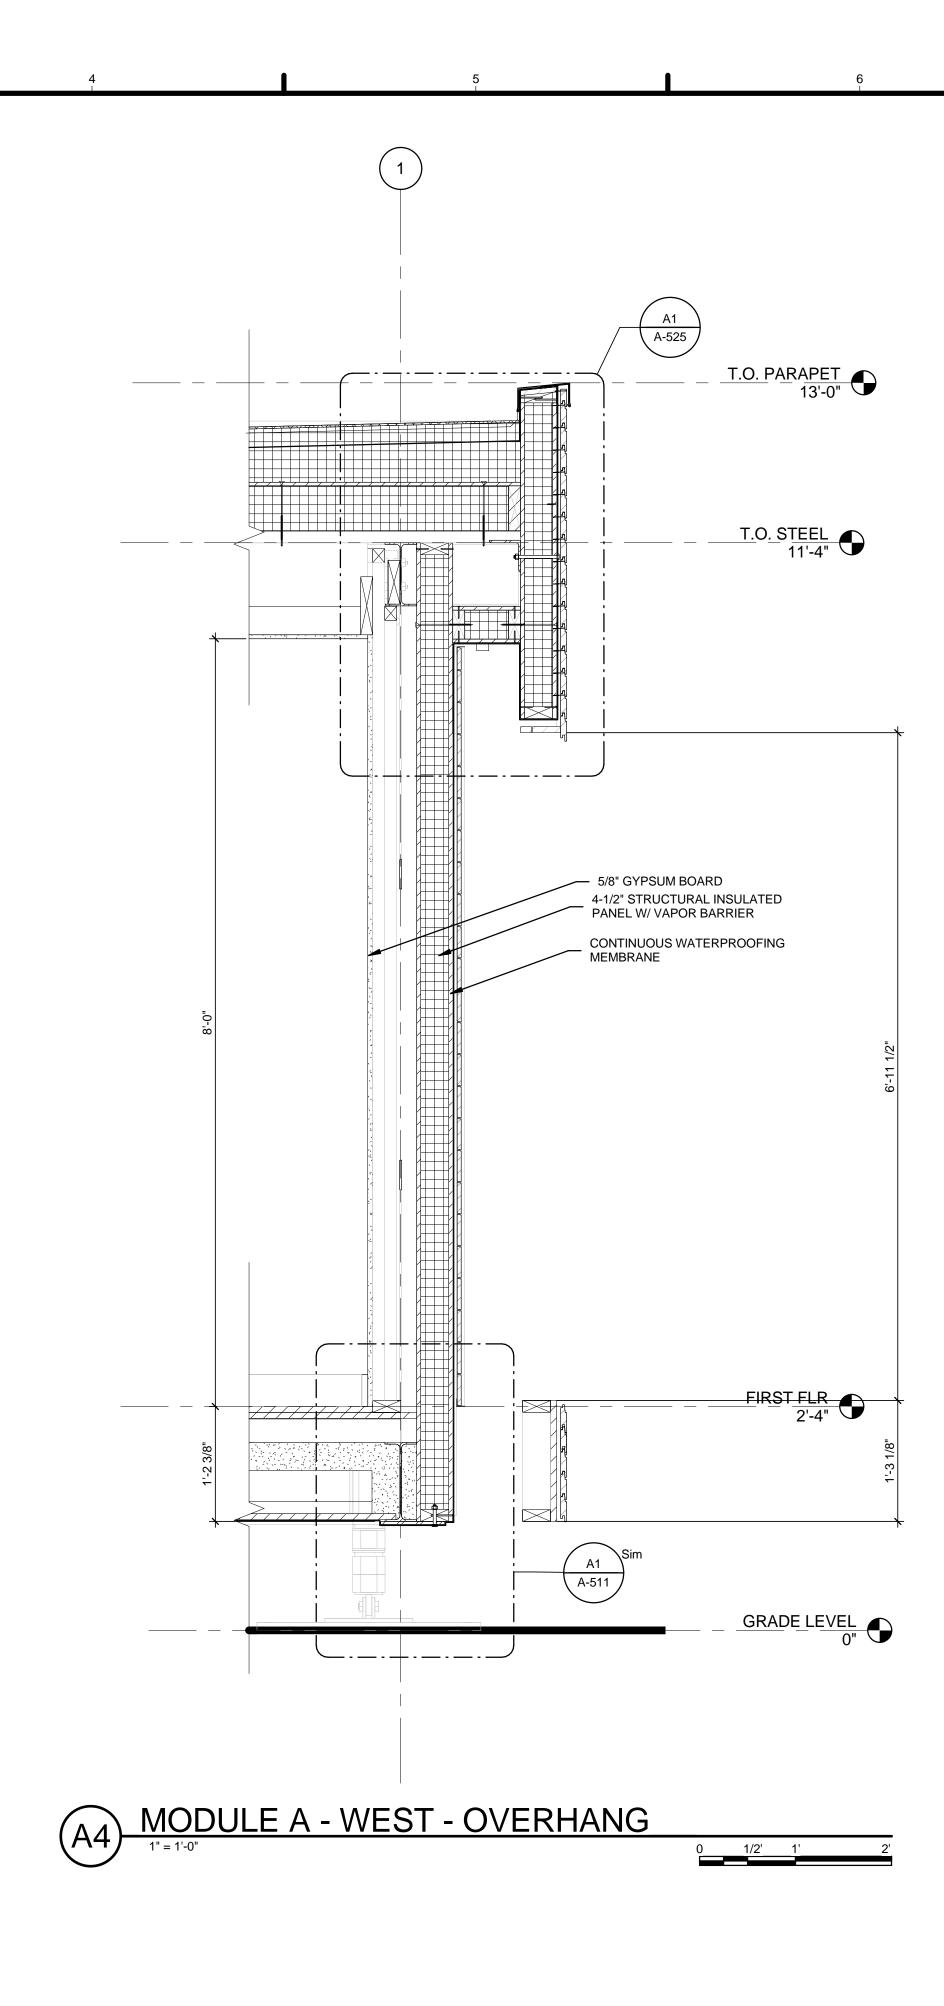




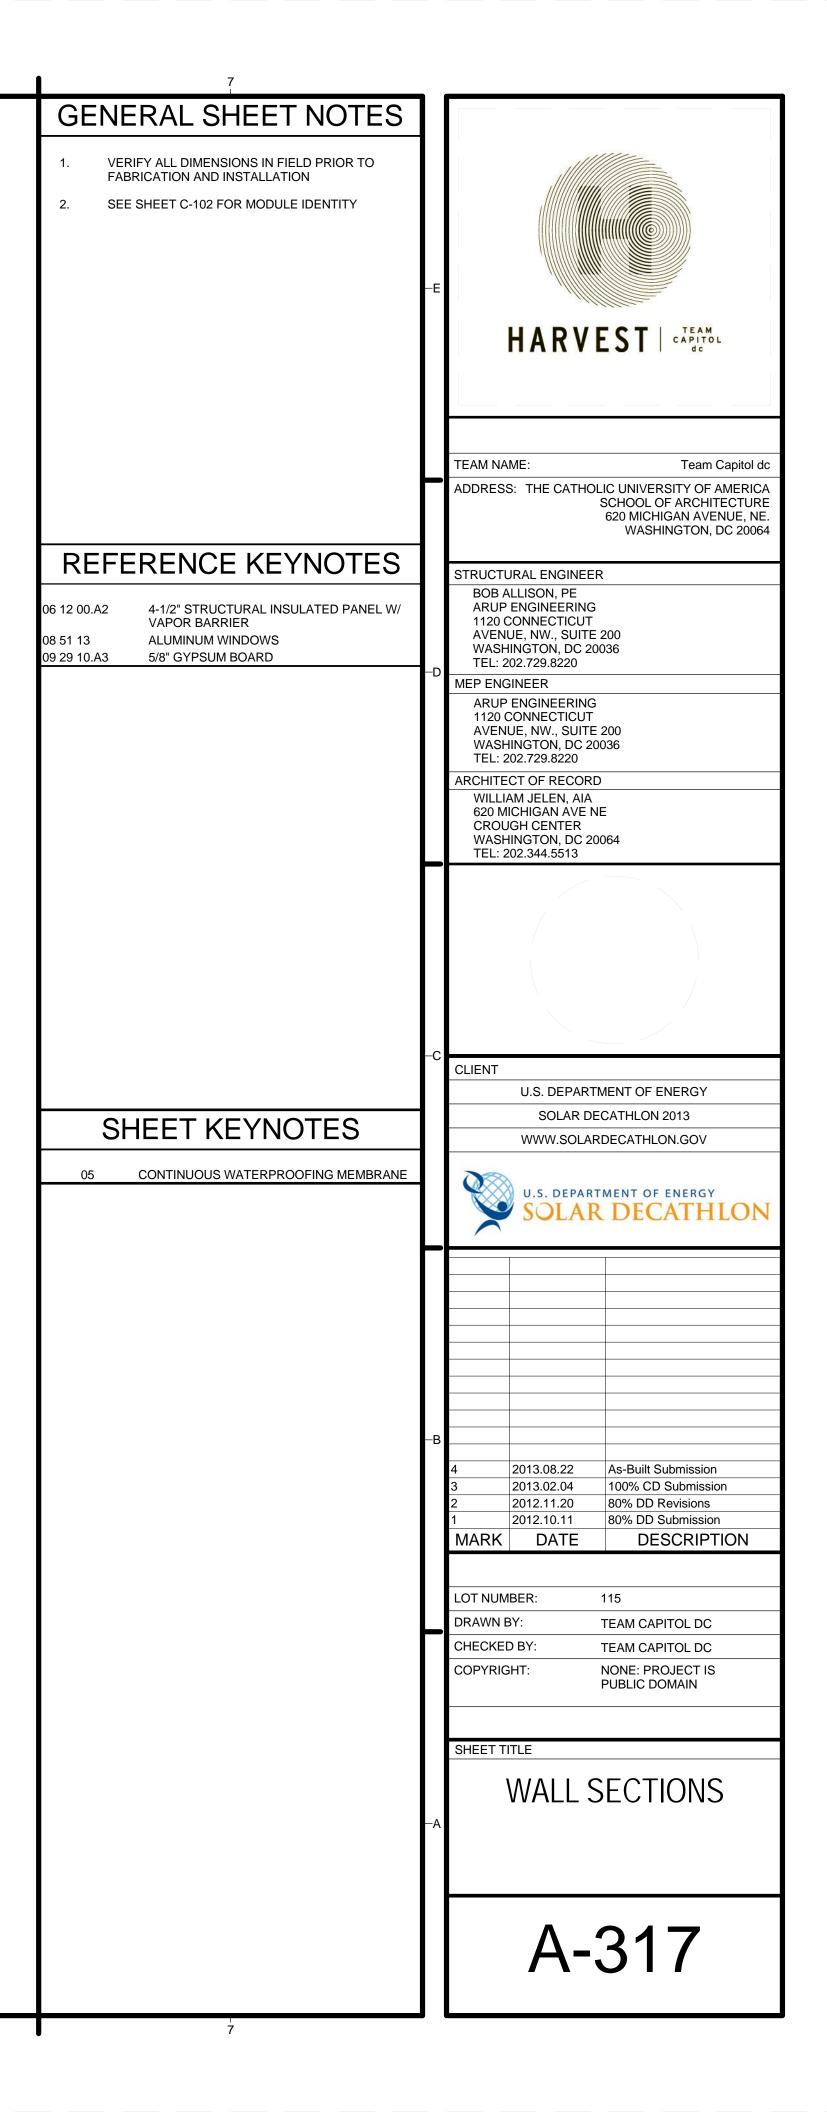


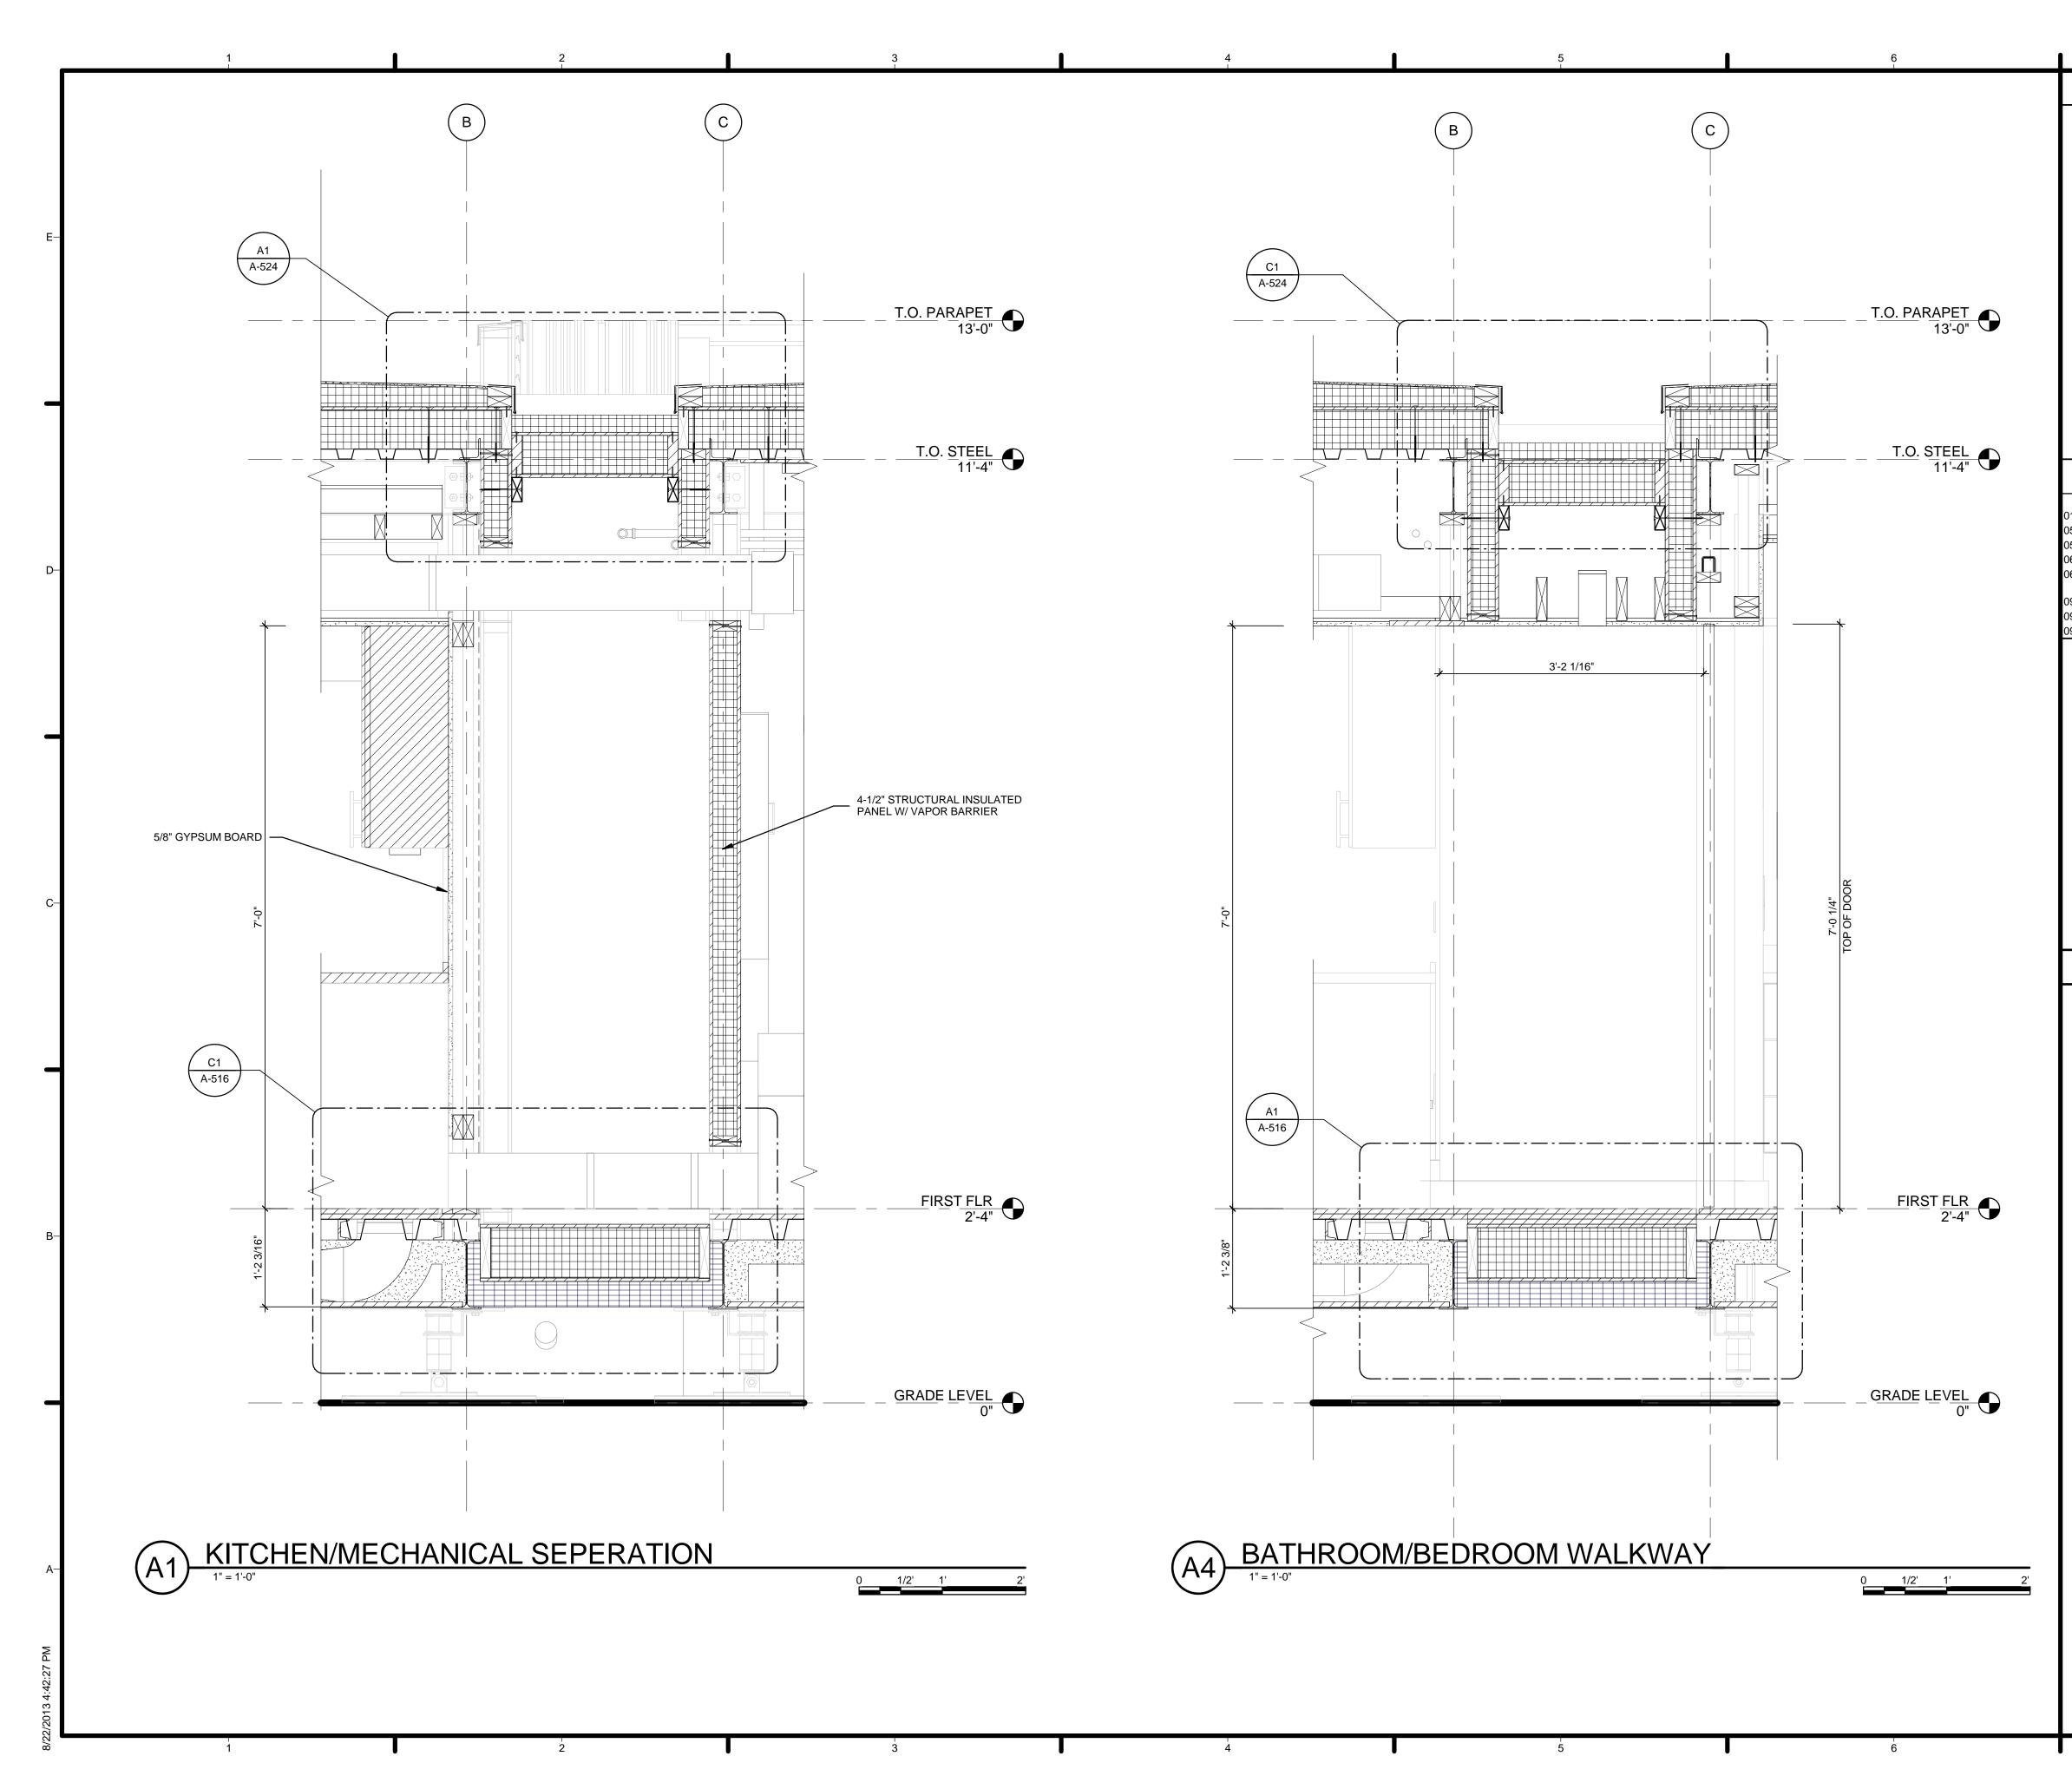
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REFERENCE KEYNOTES 08 11 16 ALUMINUM DOORS AND FRAMES	—D	TEAM NAME:Team Capitol dcADDRESS:THE CATHOLIC UNIVERSITY OF AMERICA SCHOOL OF ARCHITECTURE 620 MICHIGAN AVENUE, NE. WASHINGTON, DC 20064STRUCTURAL ENGINEERBOB ALLISON, PE
SHEET KEYNOTES	C	CLIENT U.S. DEPARTMENT OF ENERGY SOLAR DECATHLON 2013 WWW.SOLARDECATHLON.GOV
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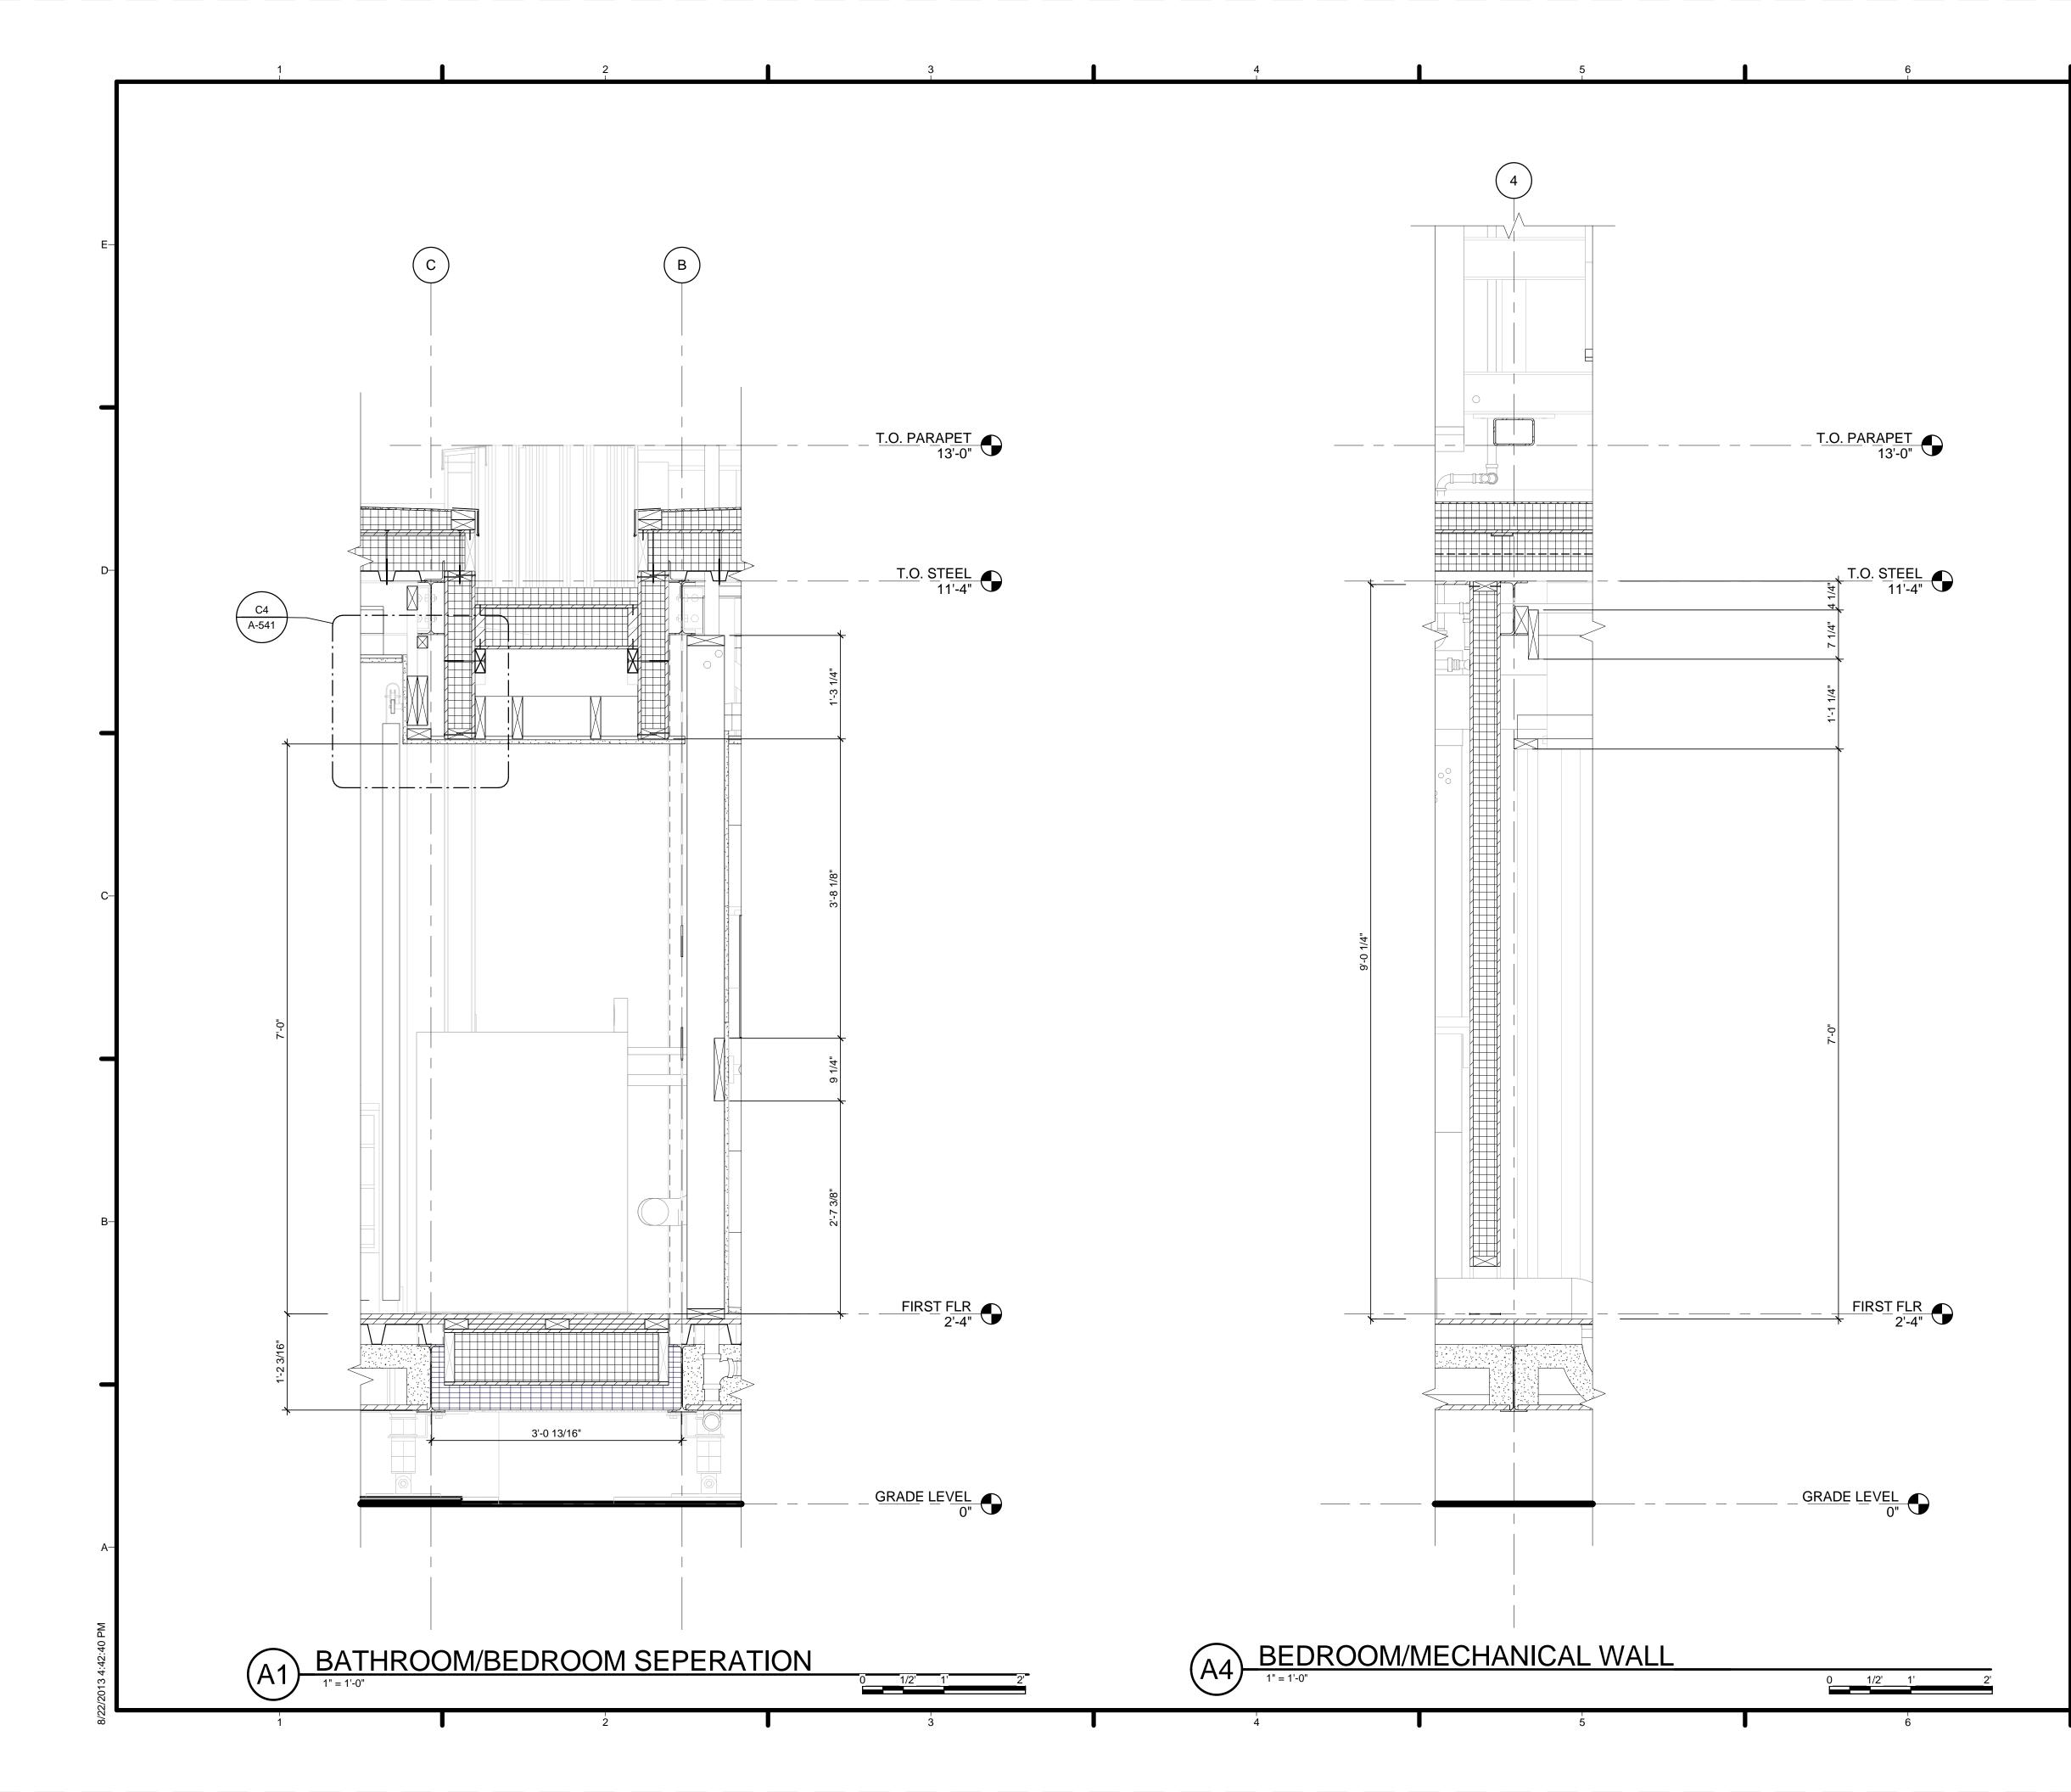


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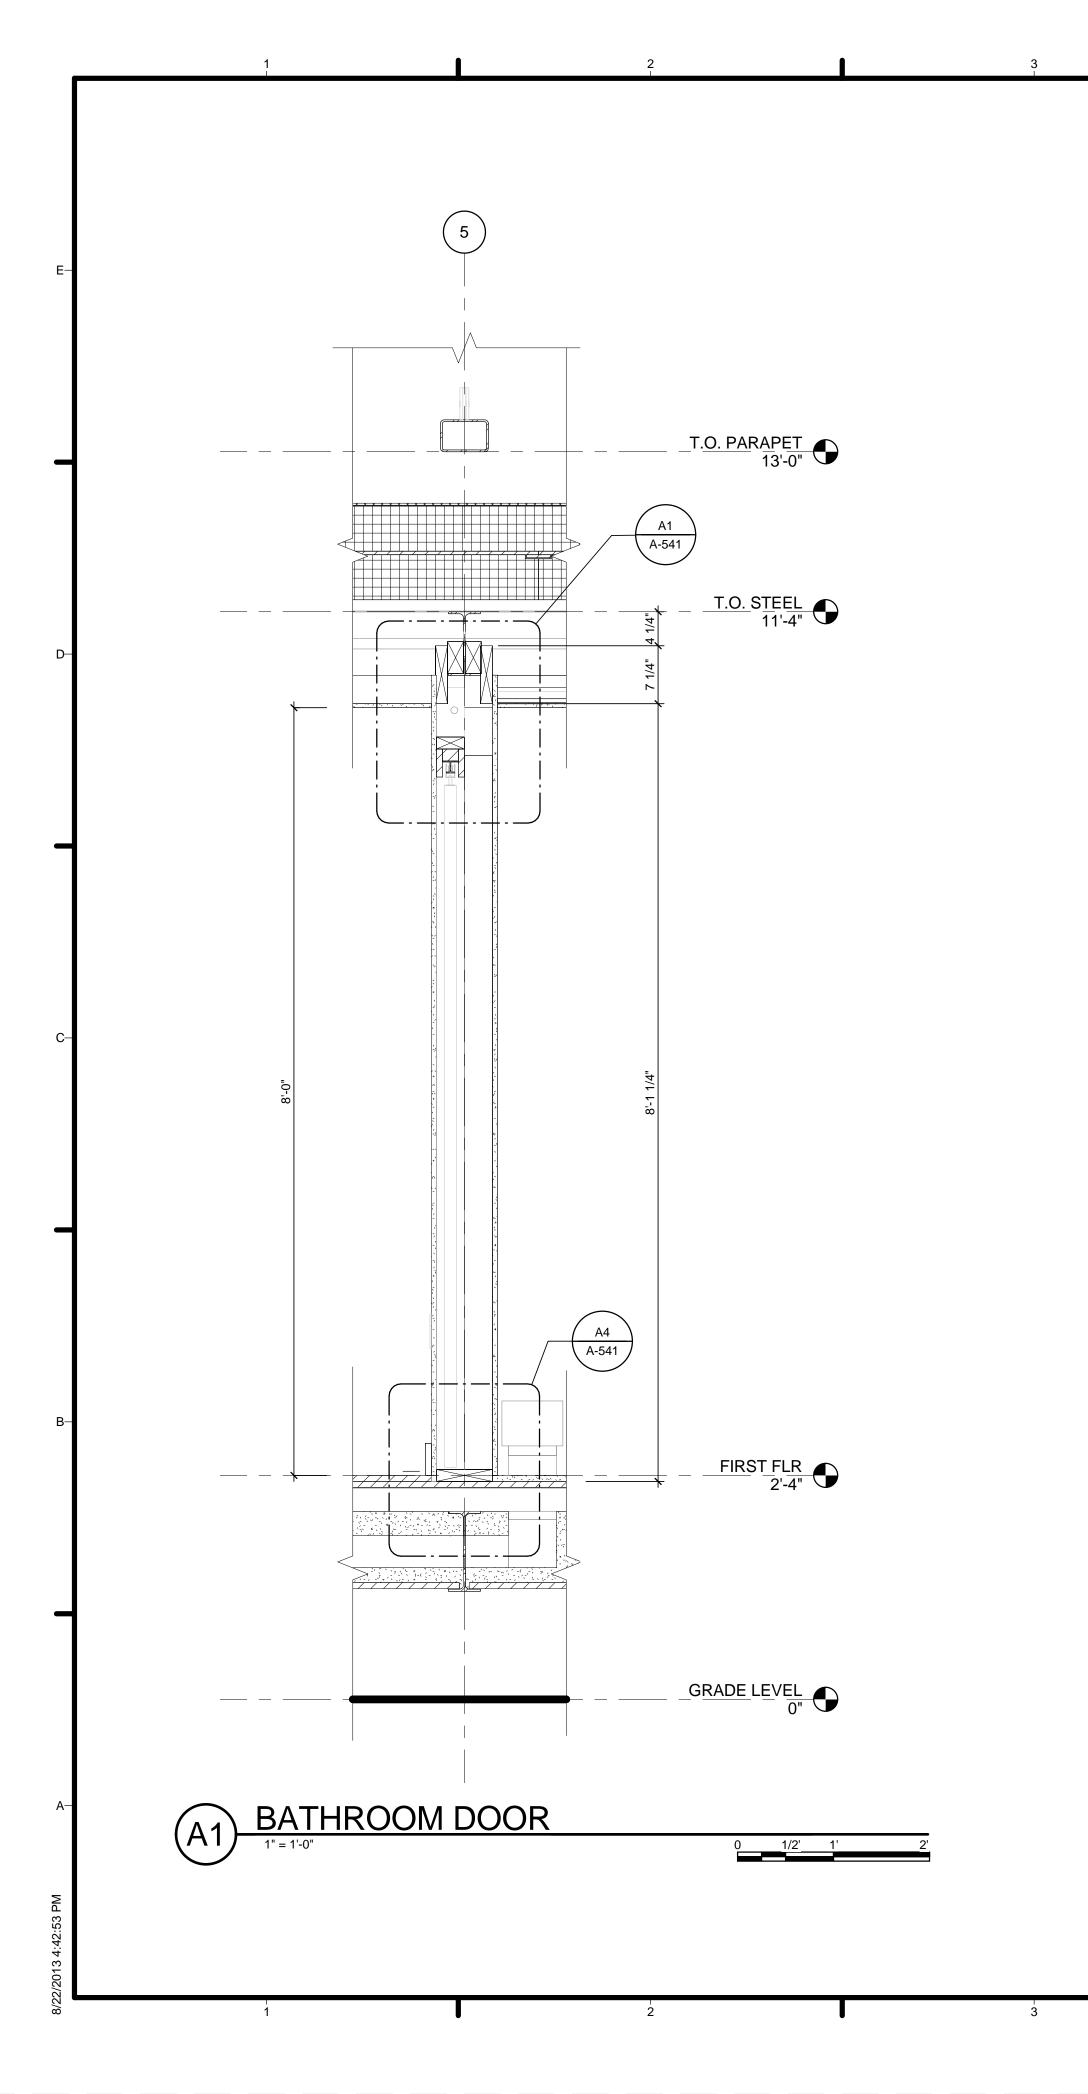




 GENERAL SHEET NOTES VERIFY ALL DIMENSIONS IN FIELD PRIOR TO ABRICATION AND INSTALLATION SEE SHEET C-102 FOR MODULE IDENTITY 	-E HARVEST TEAM dc
REFERENCE KEYNOTES 01 00 00 DIVISION 01 - GENERAL REQUIREMENTS 05 12 23.C1 PL 2-1/2 X 1/4 05 12 23.E1 ADJUSTABLE STEEL FOOTING 06 11 00.B1 2 X 6 STUD 06 12 00.A2 4-1/2" STRUCTURAL INSULATED PANEL W/ VAPOR BARRIER 09 29 00.A3 09 29 10.A3 5/8" GYPSUM BOARD 09 30 13 FLORIDA TILES - 12X12 - OYSTER	 TEAM NAME: Team Capitol dc ADDRESS: THE CATHOLIC UNIVERSITY OF AMERICA SCHOOL OF ARCHITECTURE 620 MICHIGAN AVENUE, NE. WASHINGTON, DC 20064 STRUCTURAL ENGINEER BOB ALLISON, PE ARUP ENGINEERING 1120 CONNECTICUT AVENUE, NW., SUITE 200 WASHINGTON, DC 20036 TEL: 202.729.8220 MEP ENGINEER ARUP ENGINEERING 1120 CONNECTICUT AVENUE, NW., SUITE 200 WASHINGTON, DC 20036 TEL: 202.729.8220 MEP ENGINEERING 1120 CONNECTICUT AVENUE, NW., SUITE 200 WASHINGTON, DC 20036 TEL: 202.729.8220 ARCHITECT OF RECORD WILLIAM JELEN, AIA
SHEET KEYNOTES	C C CLIENT U.S. DEPARTMENT OF ENERGY SOLAR DECATHLON.GOV
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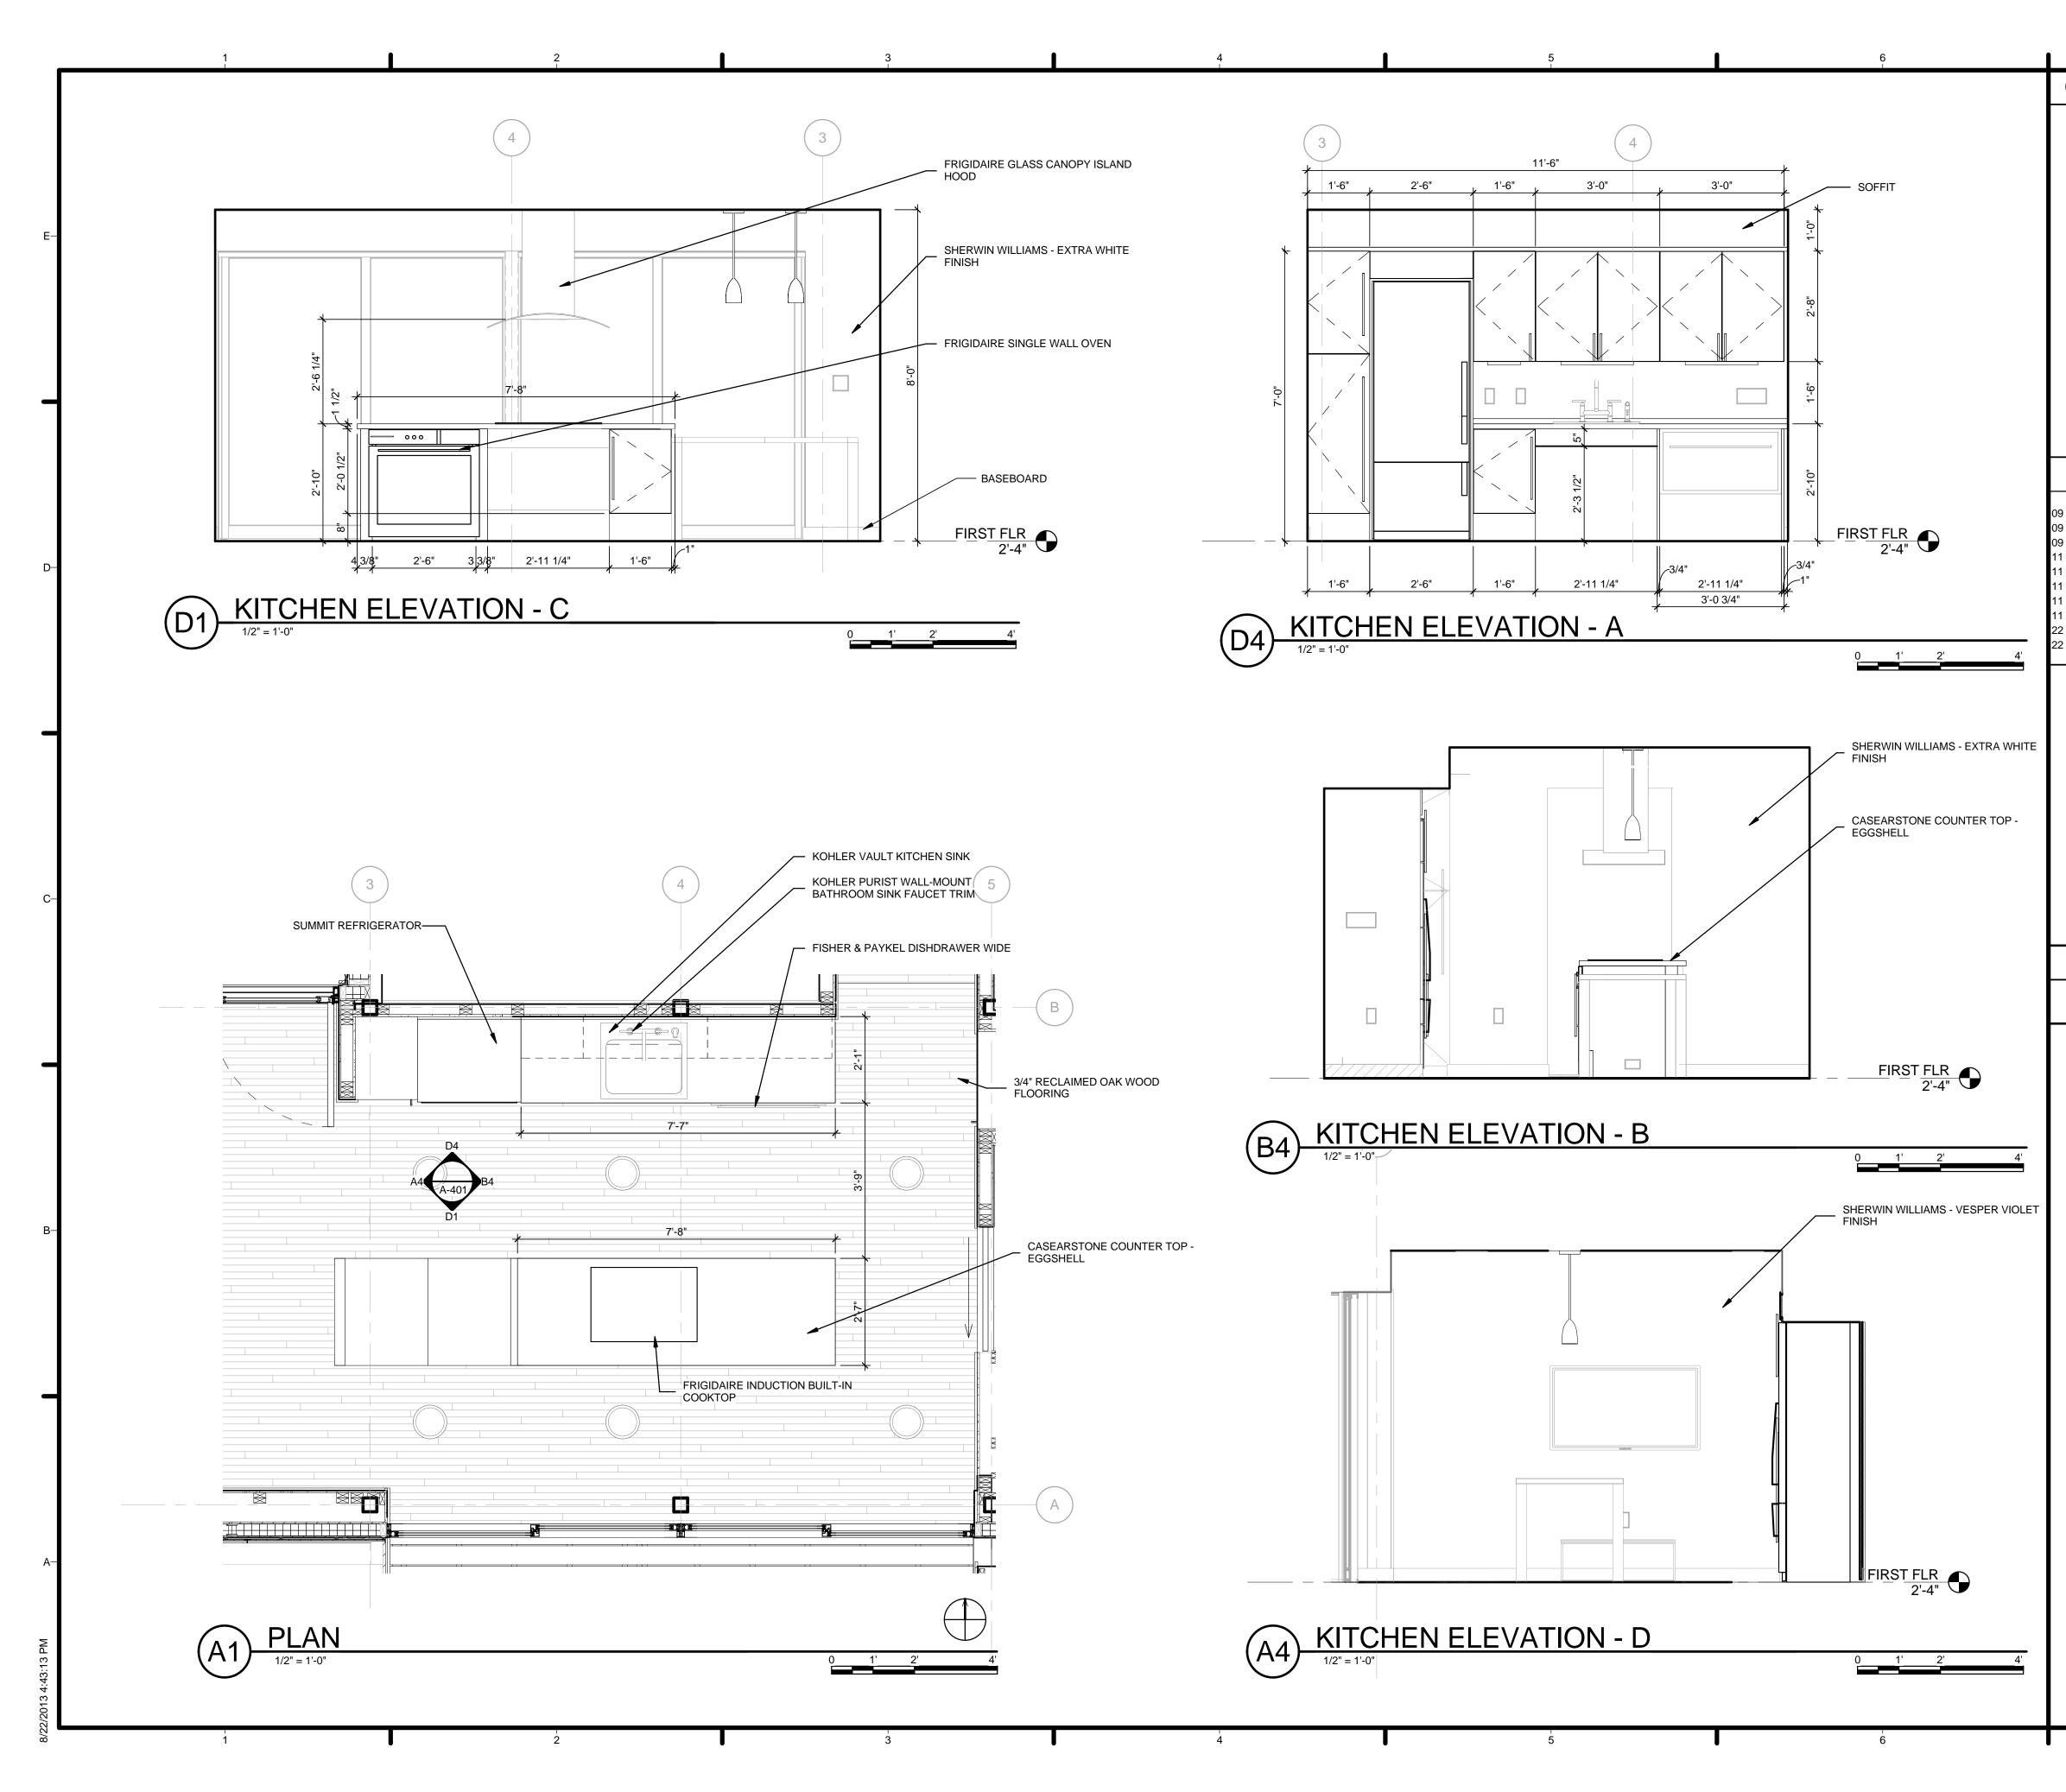


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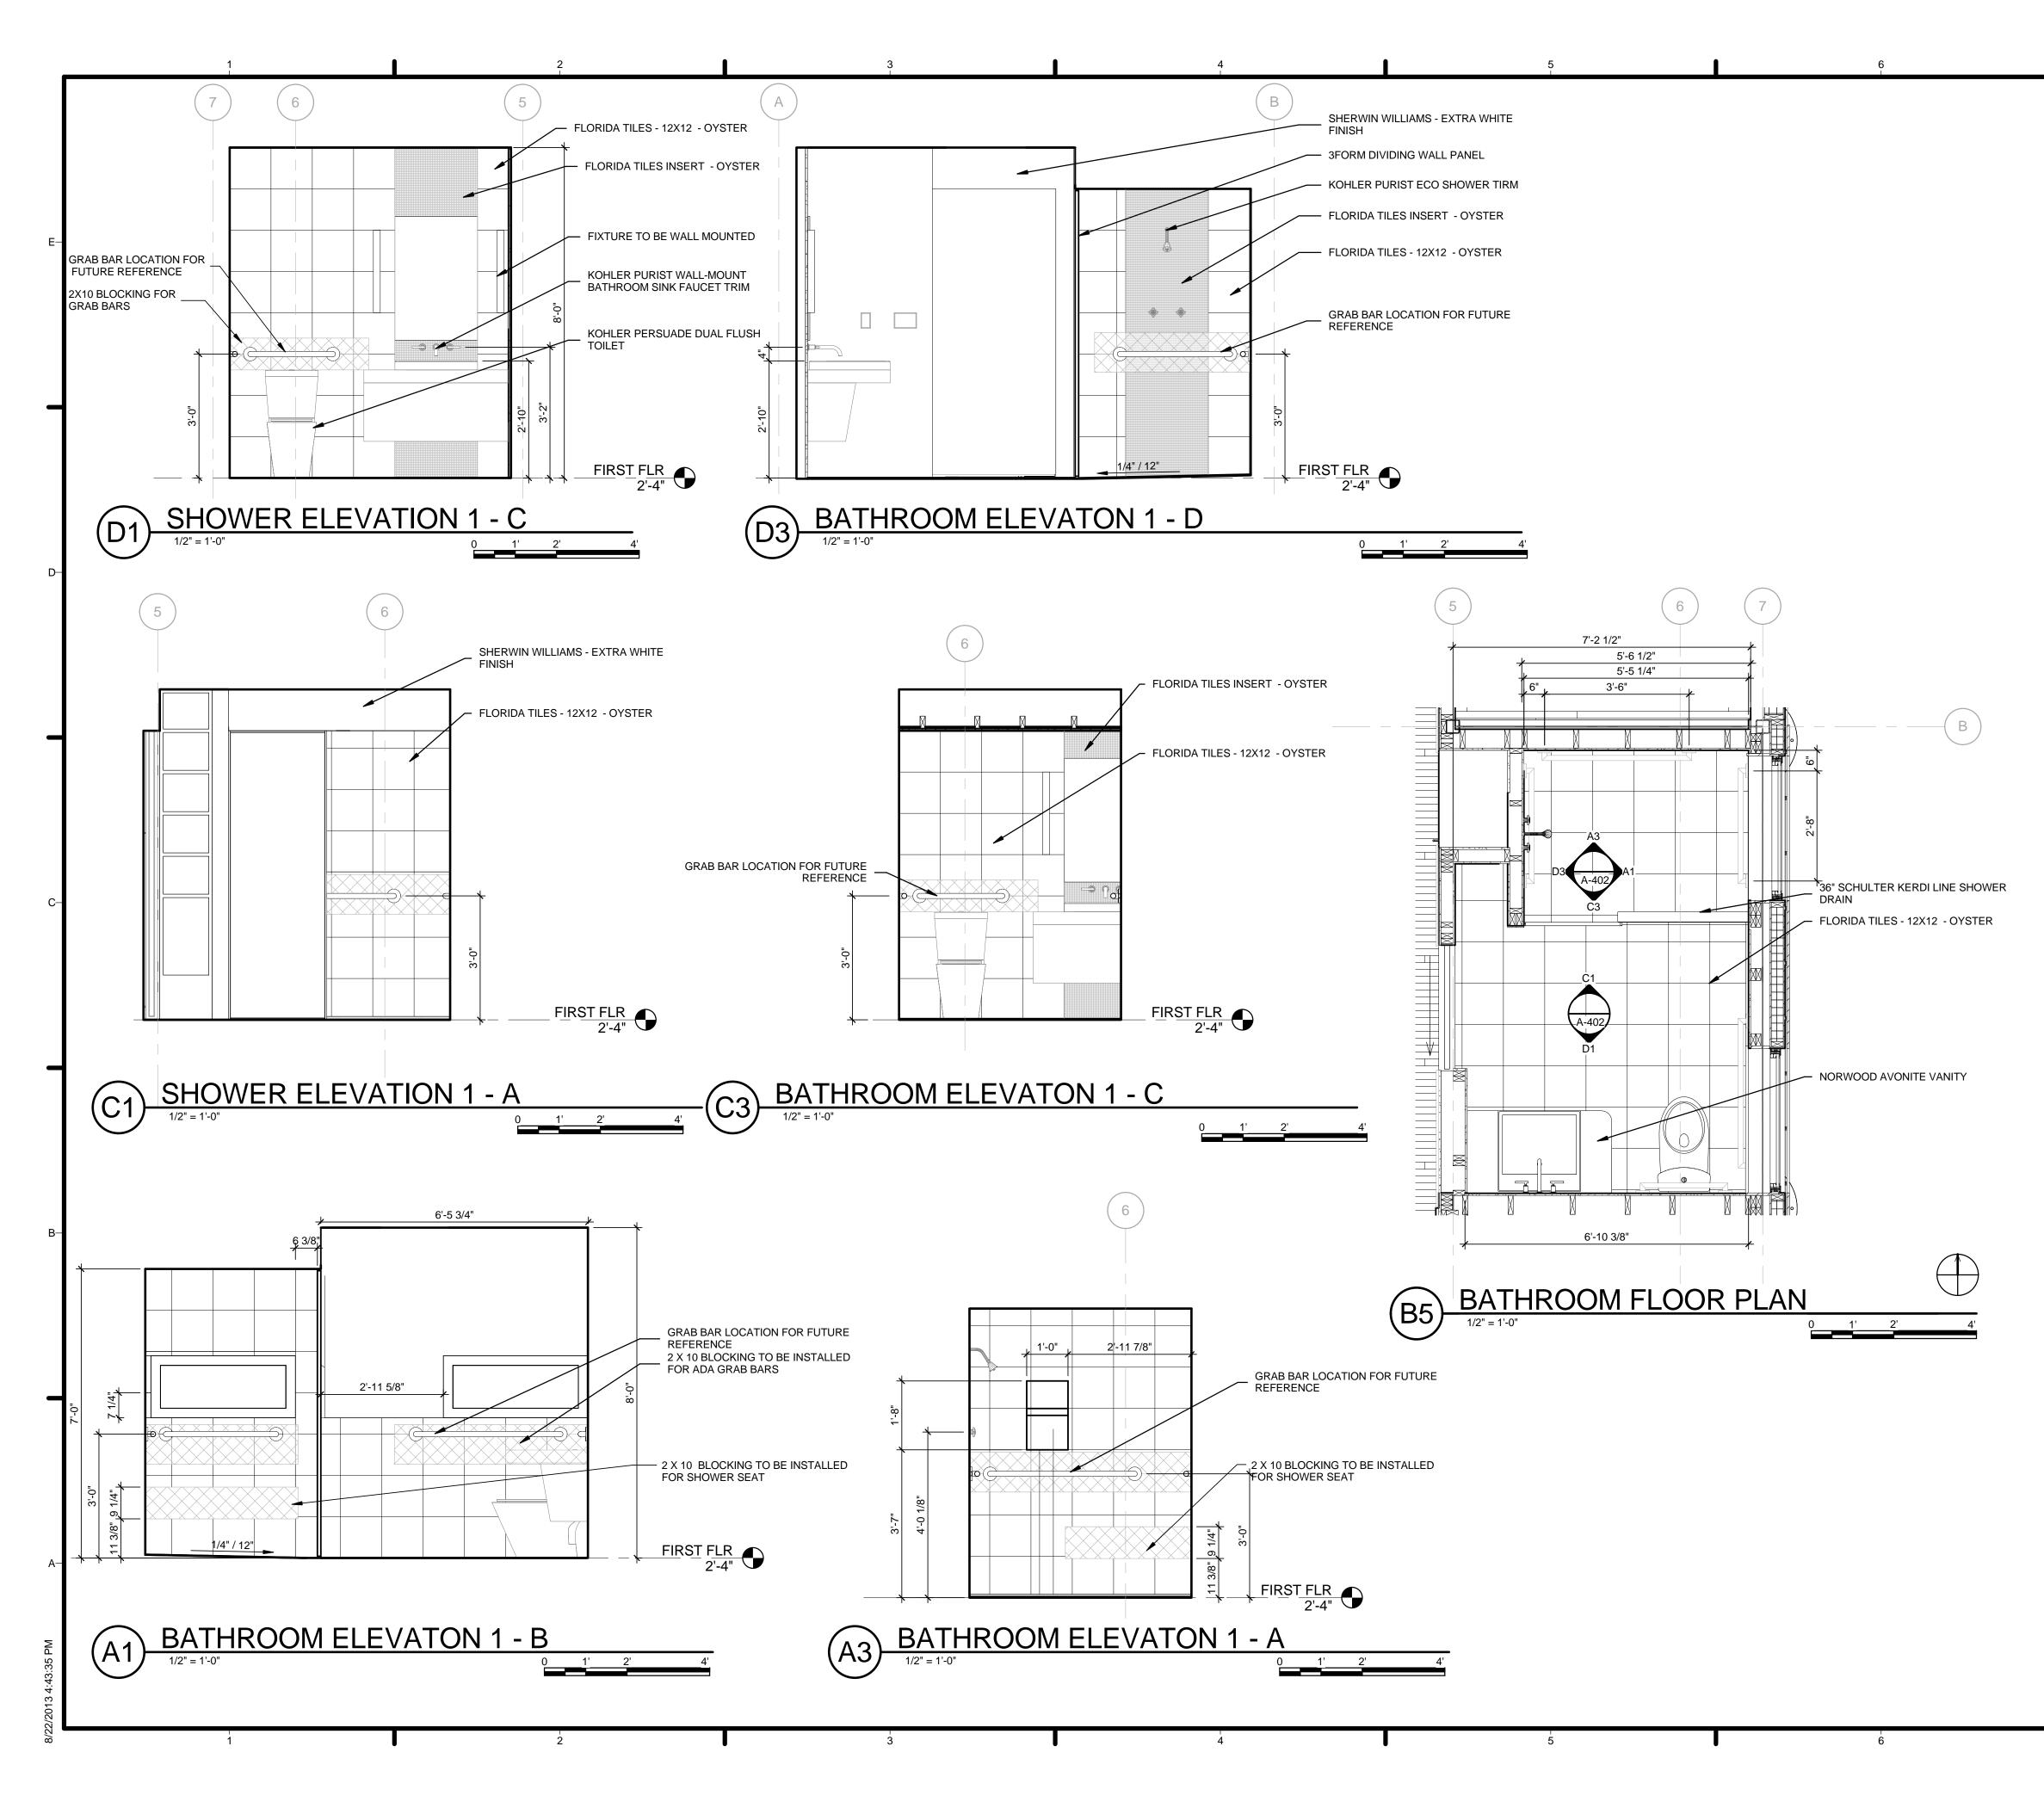


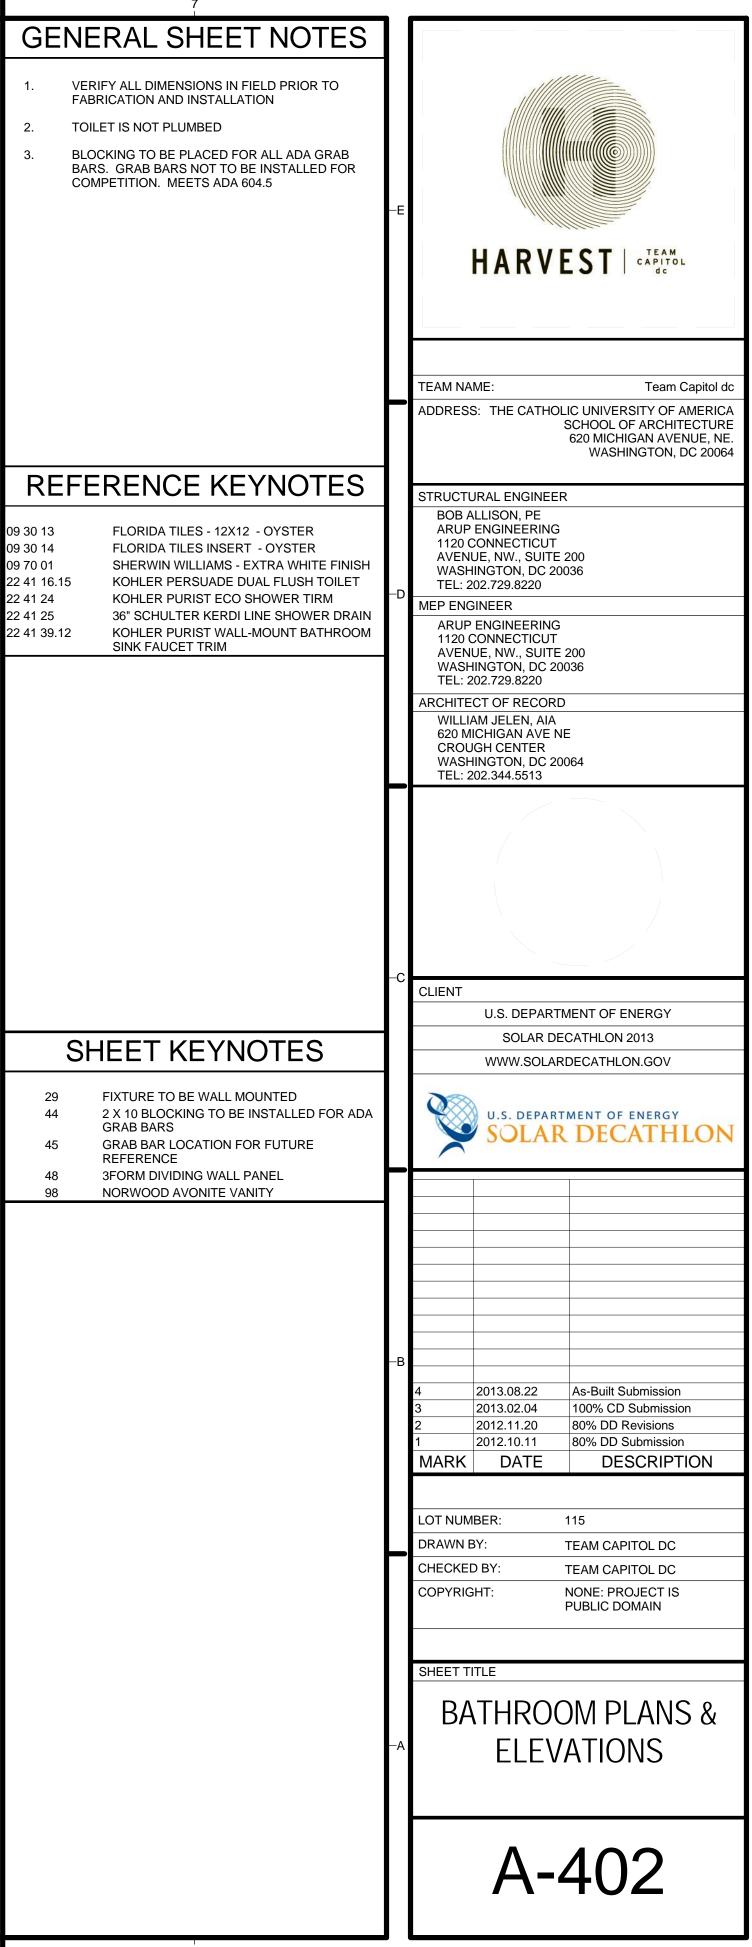
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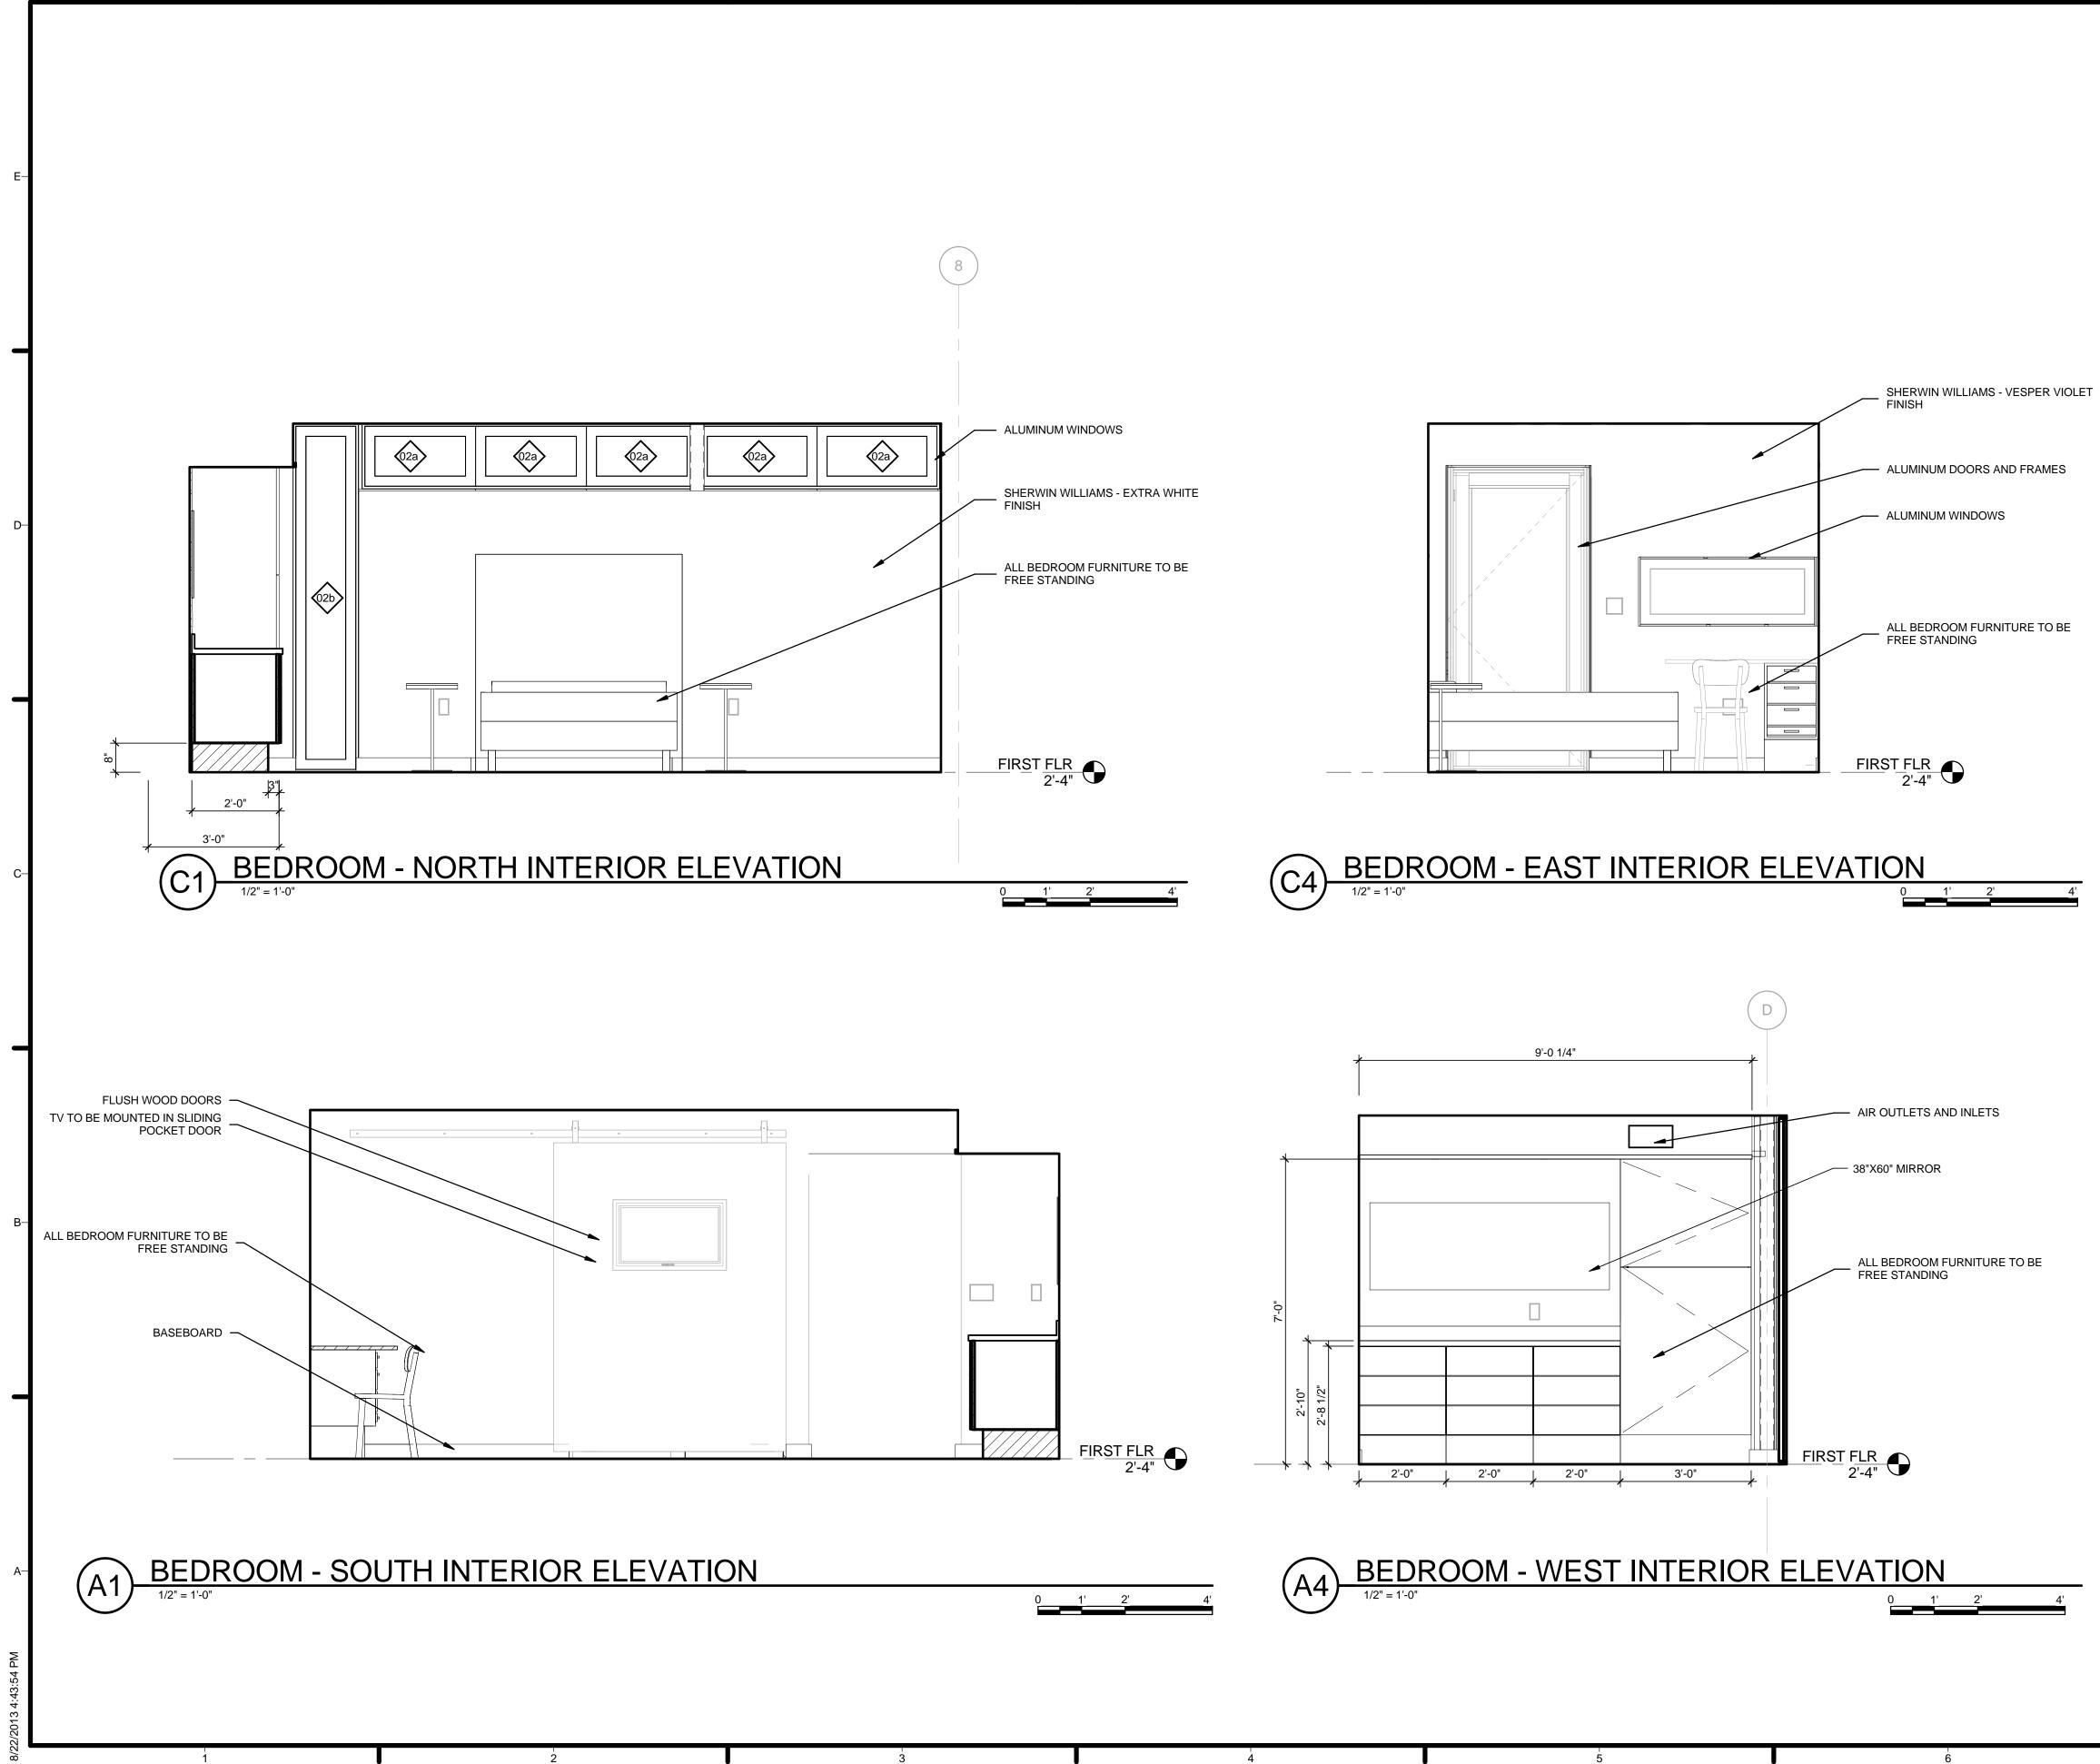
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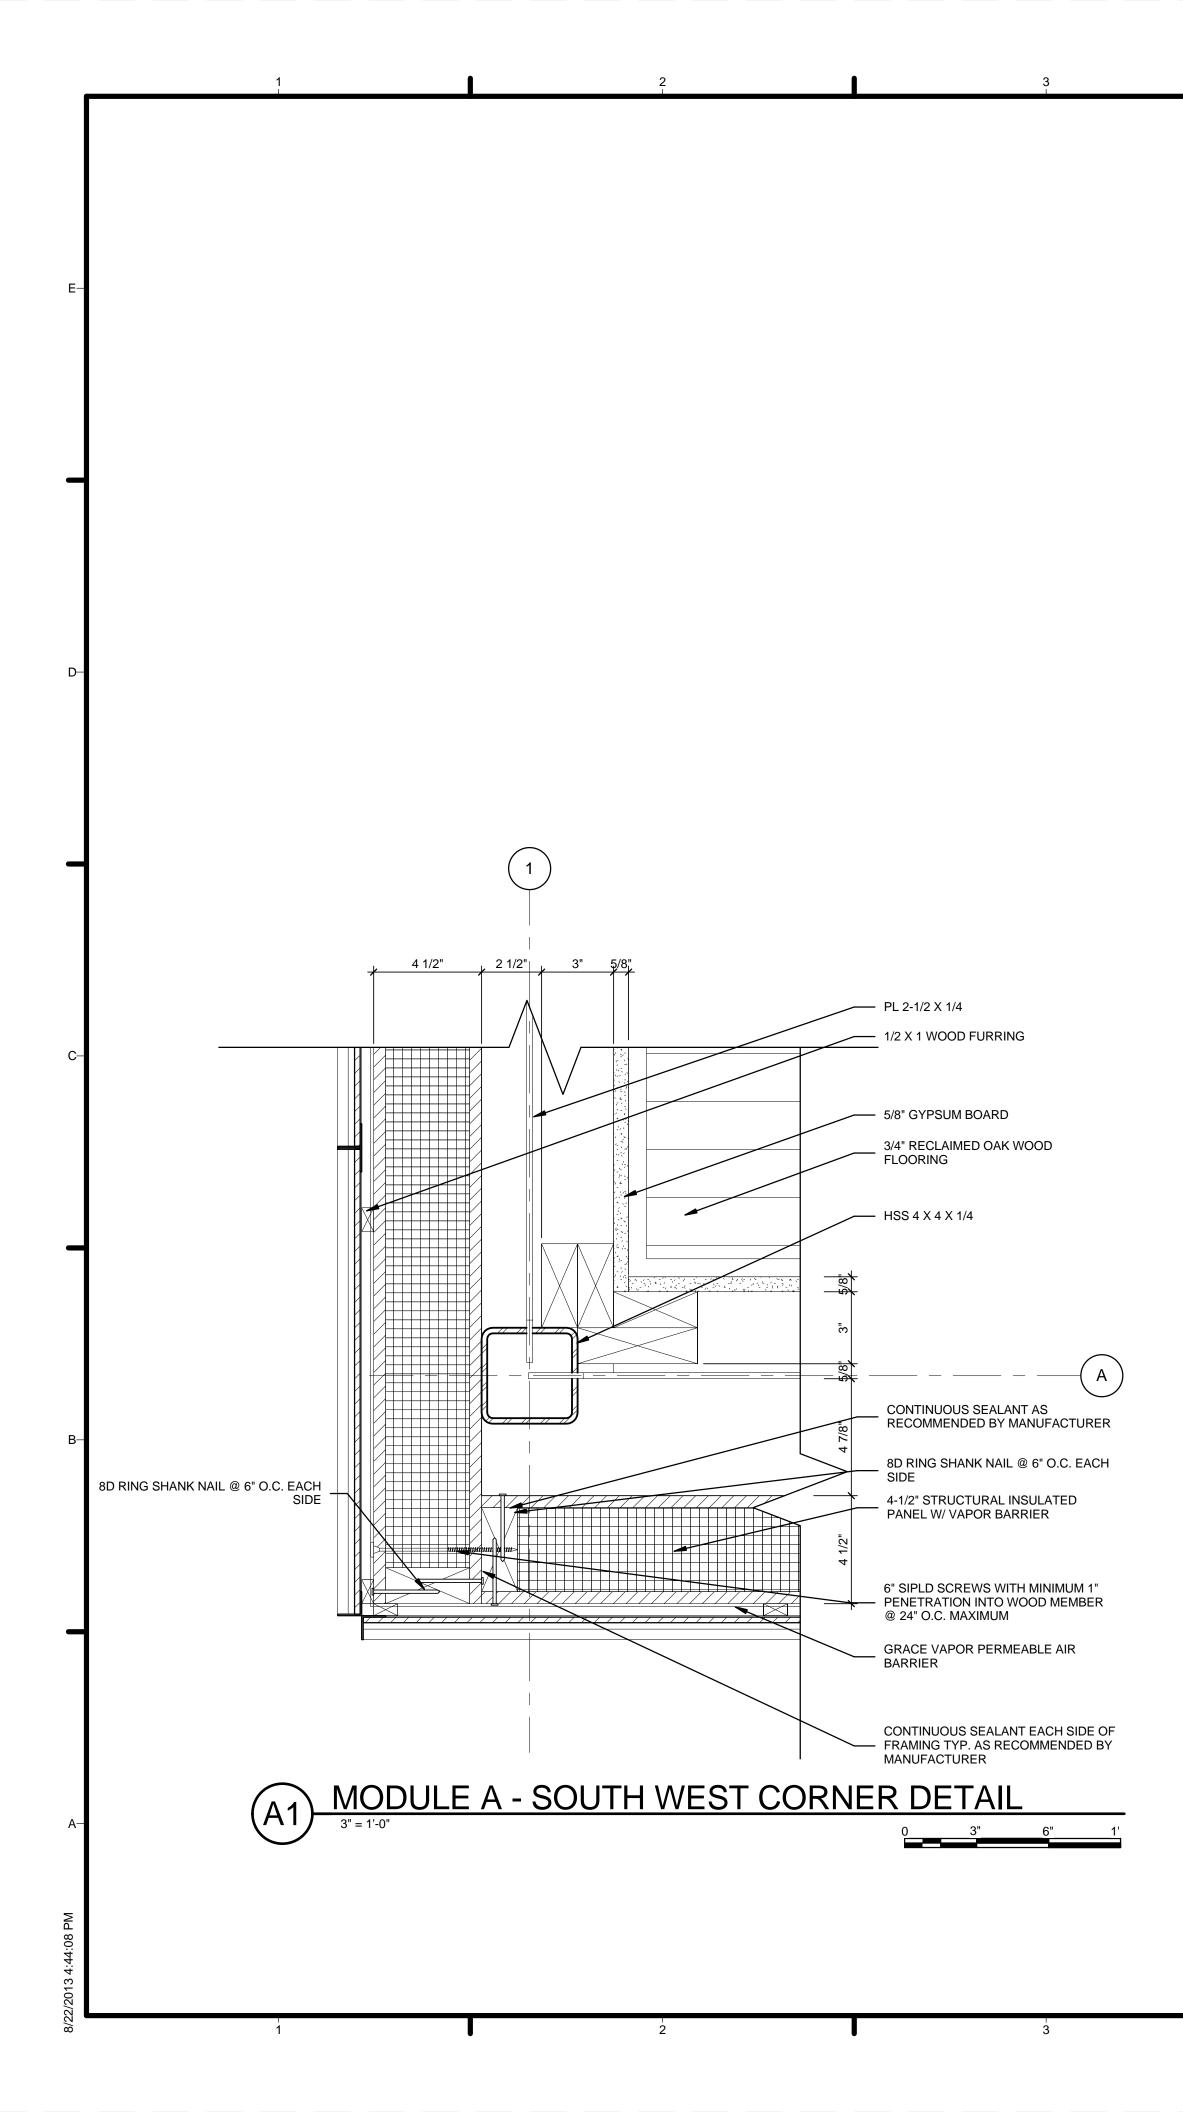
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	REFERENCE KEYNOTES		TEAM NAME: Team Capitol dc ADDRESS: THE CATHOLIC UNIVERSITY OF AMERICA SCHOOL OF ARCHITECTURE 620 MICHIGAN AVENUE, NE. WASHINGTON, DC 20064
	09 64 293/4" RECLAIMED OAK WOOD FLOORING09 70 01SHERWIN WILLIAMS - EXTRA WHITE FINISH09 70 02SHERWIN WILLIAMS - VESPER VIOLET FINISH11 31 13.A1FRIGIDAIRE INDUCTION BUILT-IN COOKTOP11 31 13.A2SUMMIT REFRIGERATOR11 31 13.A3FISHER & PAYKEL DISHDRAWER WIDE11 31 13.A4FRIGIDAIRE SINGLE WALL OVEN11 31 13.A5FRIGIDAIRE GLASS CANOPY ISLAND HOOD	-D	STRUCTURAL ENGINEER BOB ALLISON, PE ARUP ENGINEERING 1120 CONNECTICUT AVENUE, NW., SUITE 200 WASHINGTON, DC 20036 TEL: 202.729.8220 MEP ENGINEER ARUP ENGINEERING 1120 CONNECTICUT AVENUE, NW., SUITE 200
Ξ	22 41 16.14 KOHLER VAULT KITCHEN SINK 22 41 39.12 KOHLER PURIST WALL-MOUNT BATHROOM SINK FAUCET TRIM		WASHINGTON, DC 20036 TEL: 202.729.8220 ARCHITECT OF RECORD WILLIAM JELEN, AIA 620 MICHIGAN AVE NE CROUGH CENTER WASHINGTON, DC 20064 TEL: 202.344.5513
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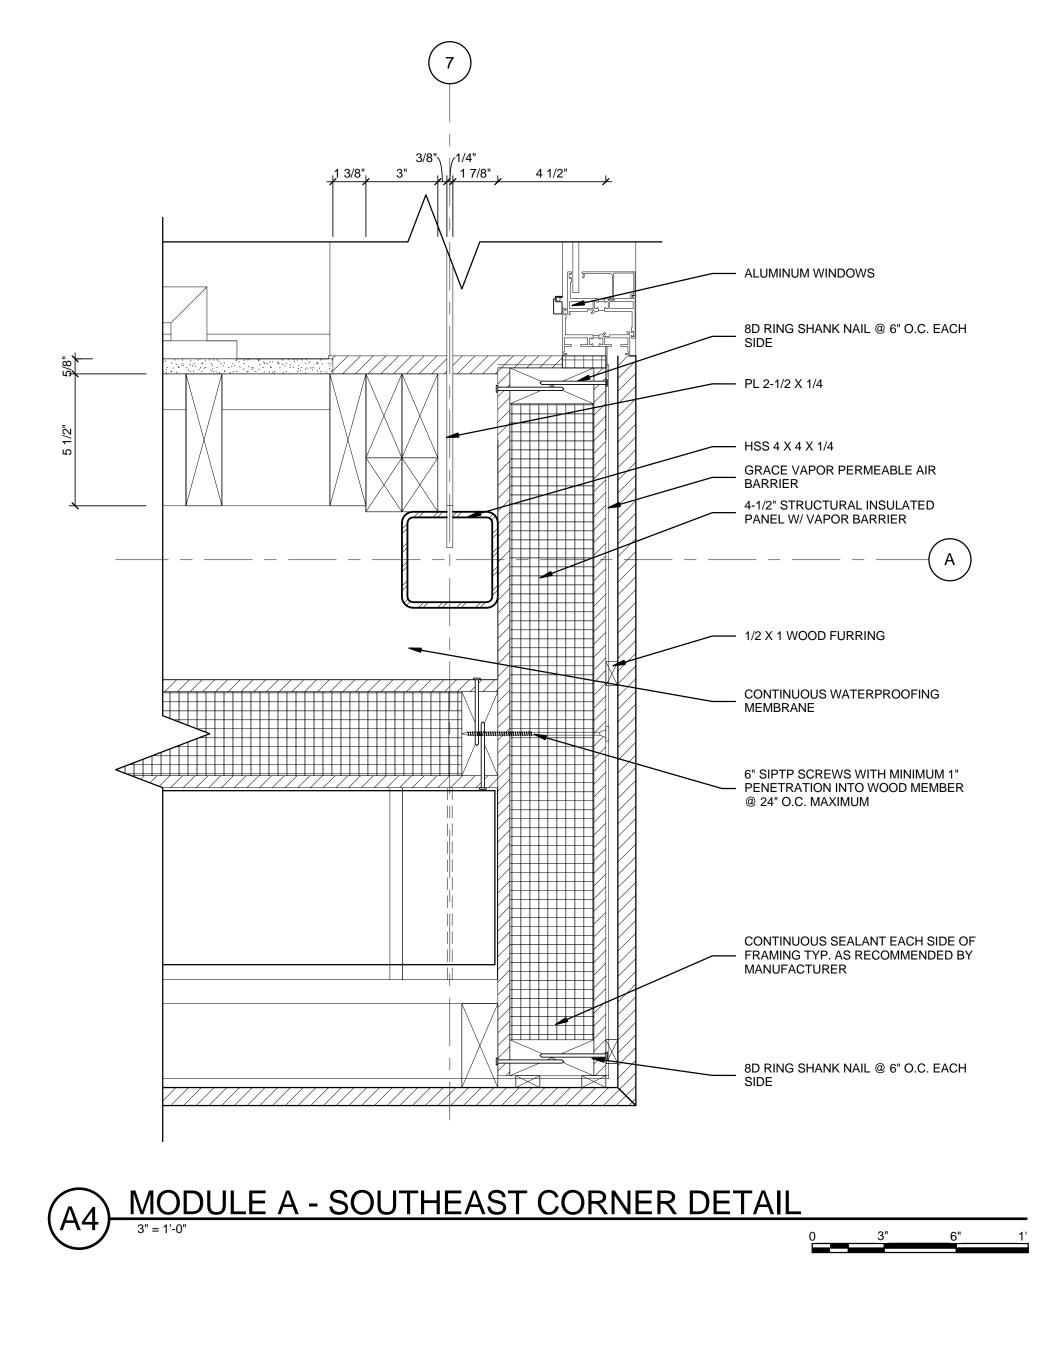


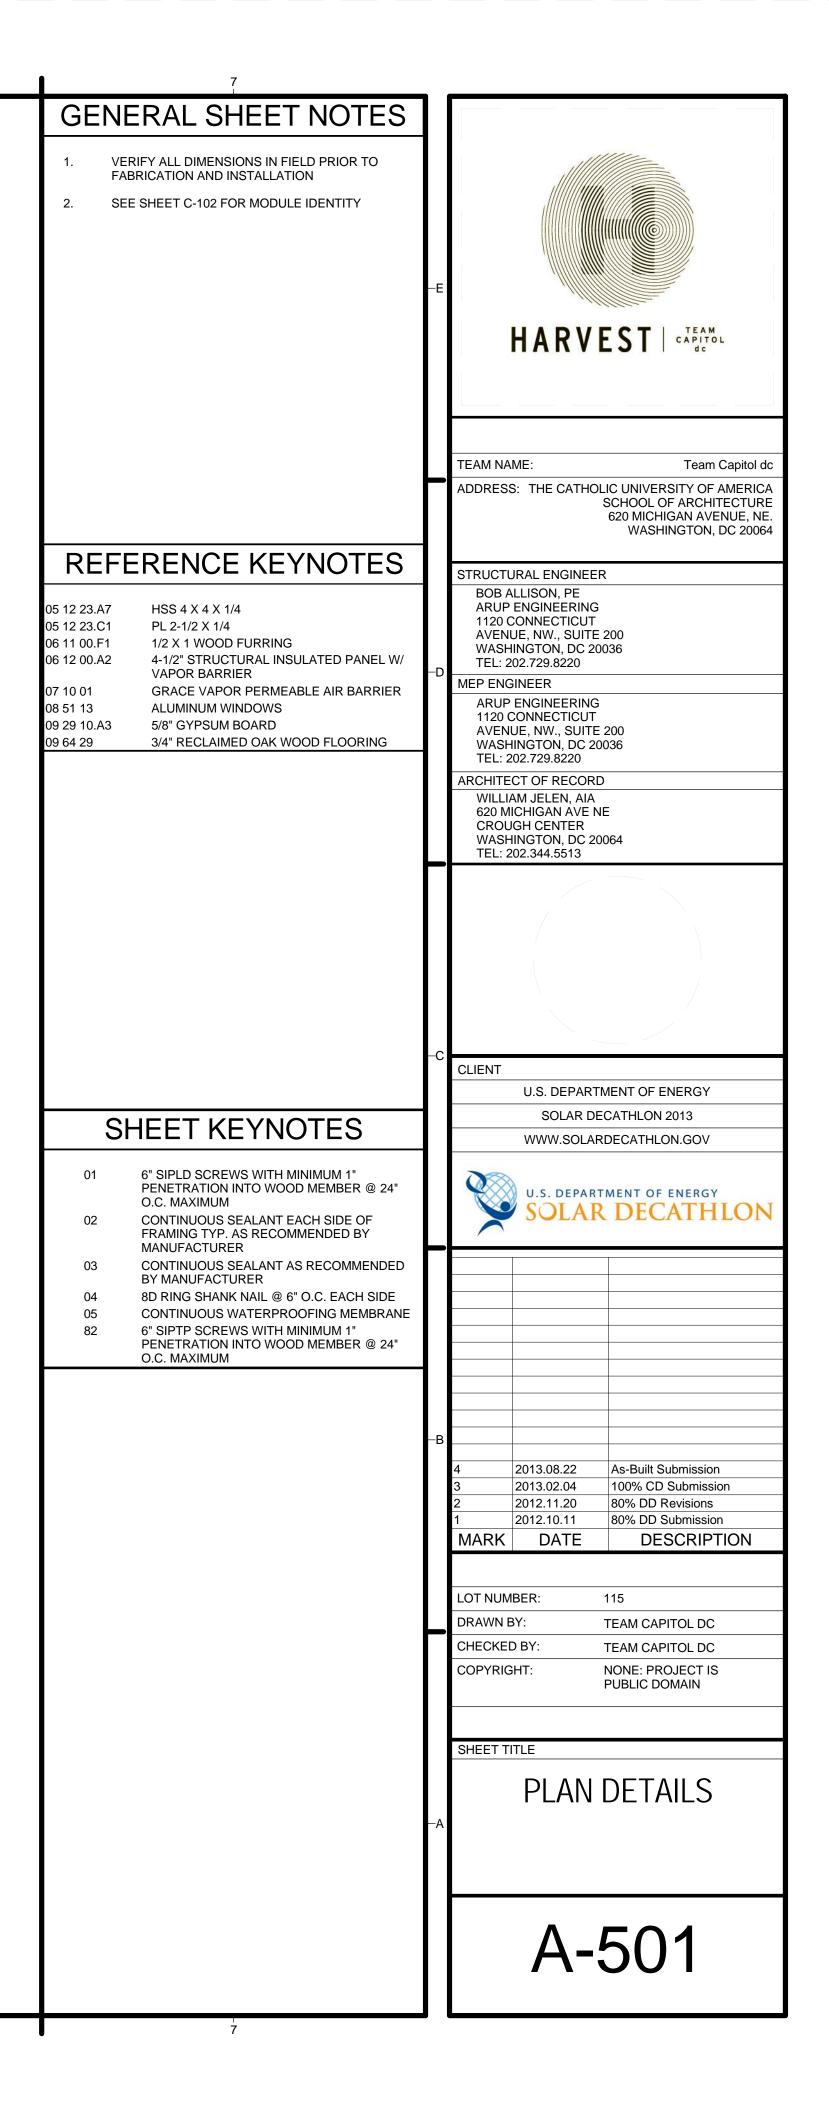


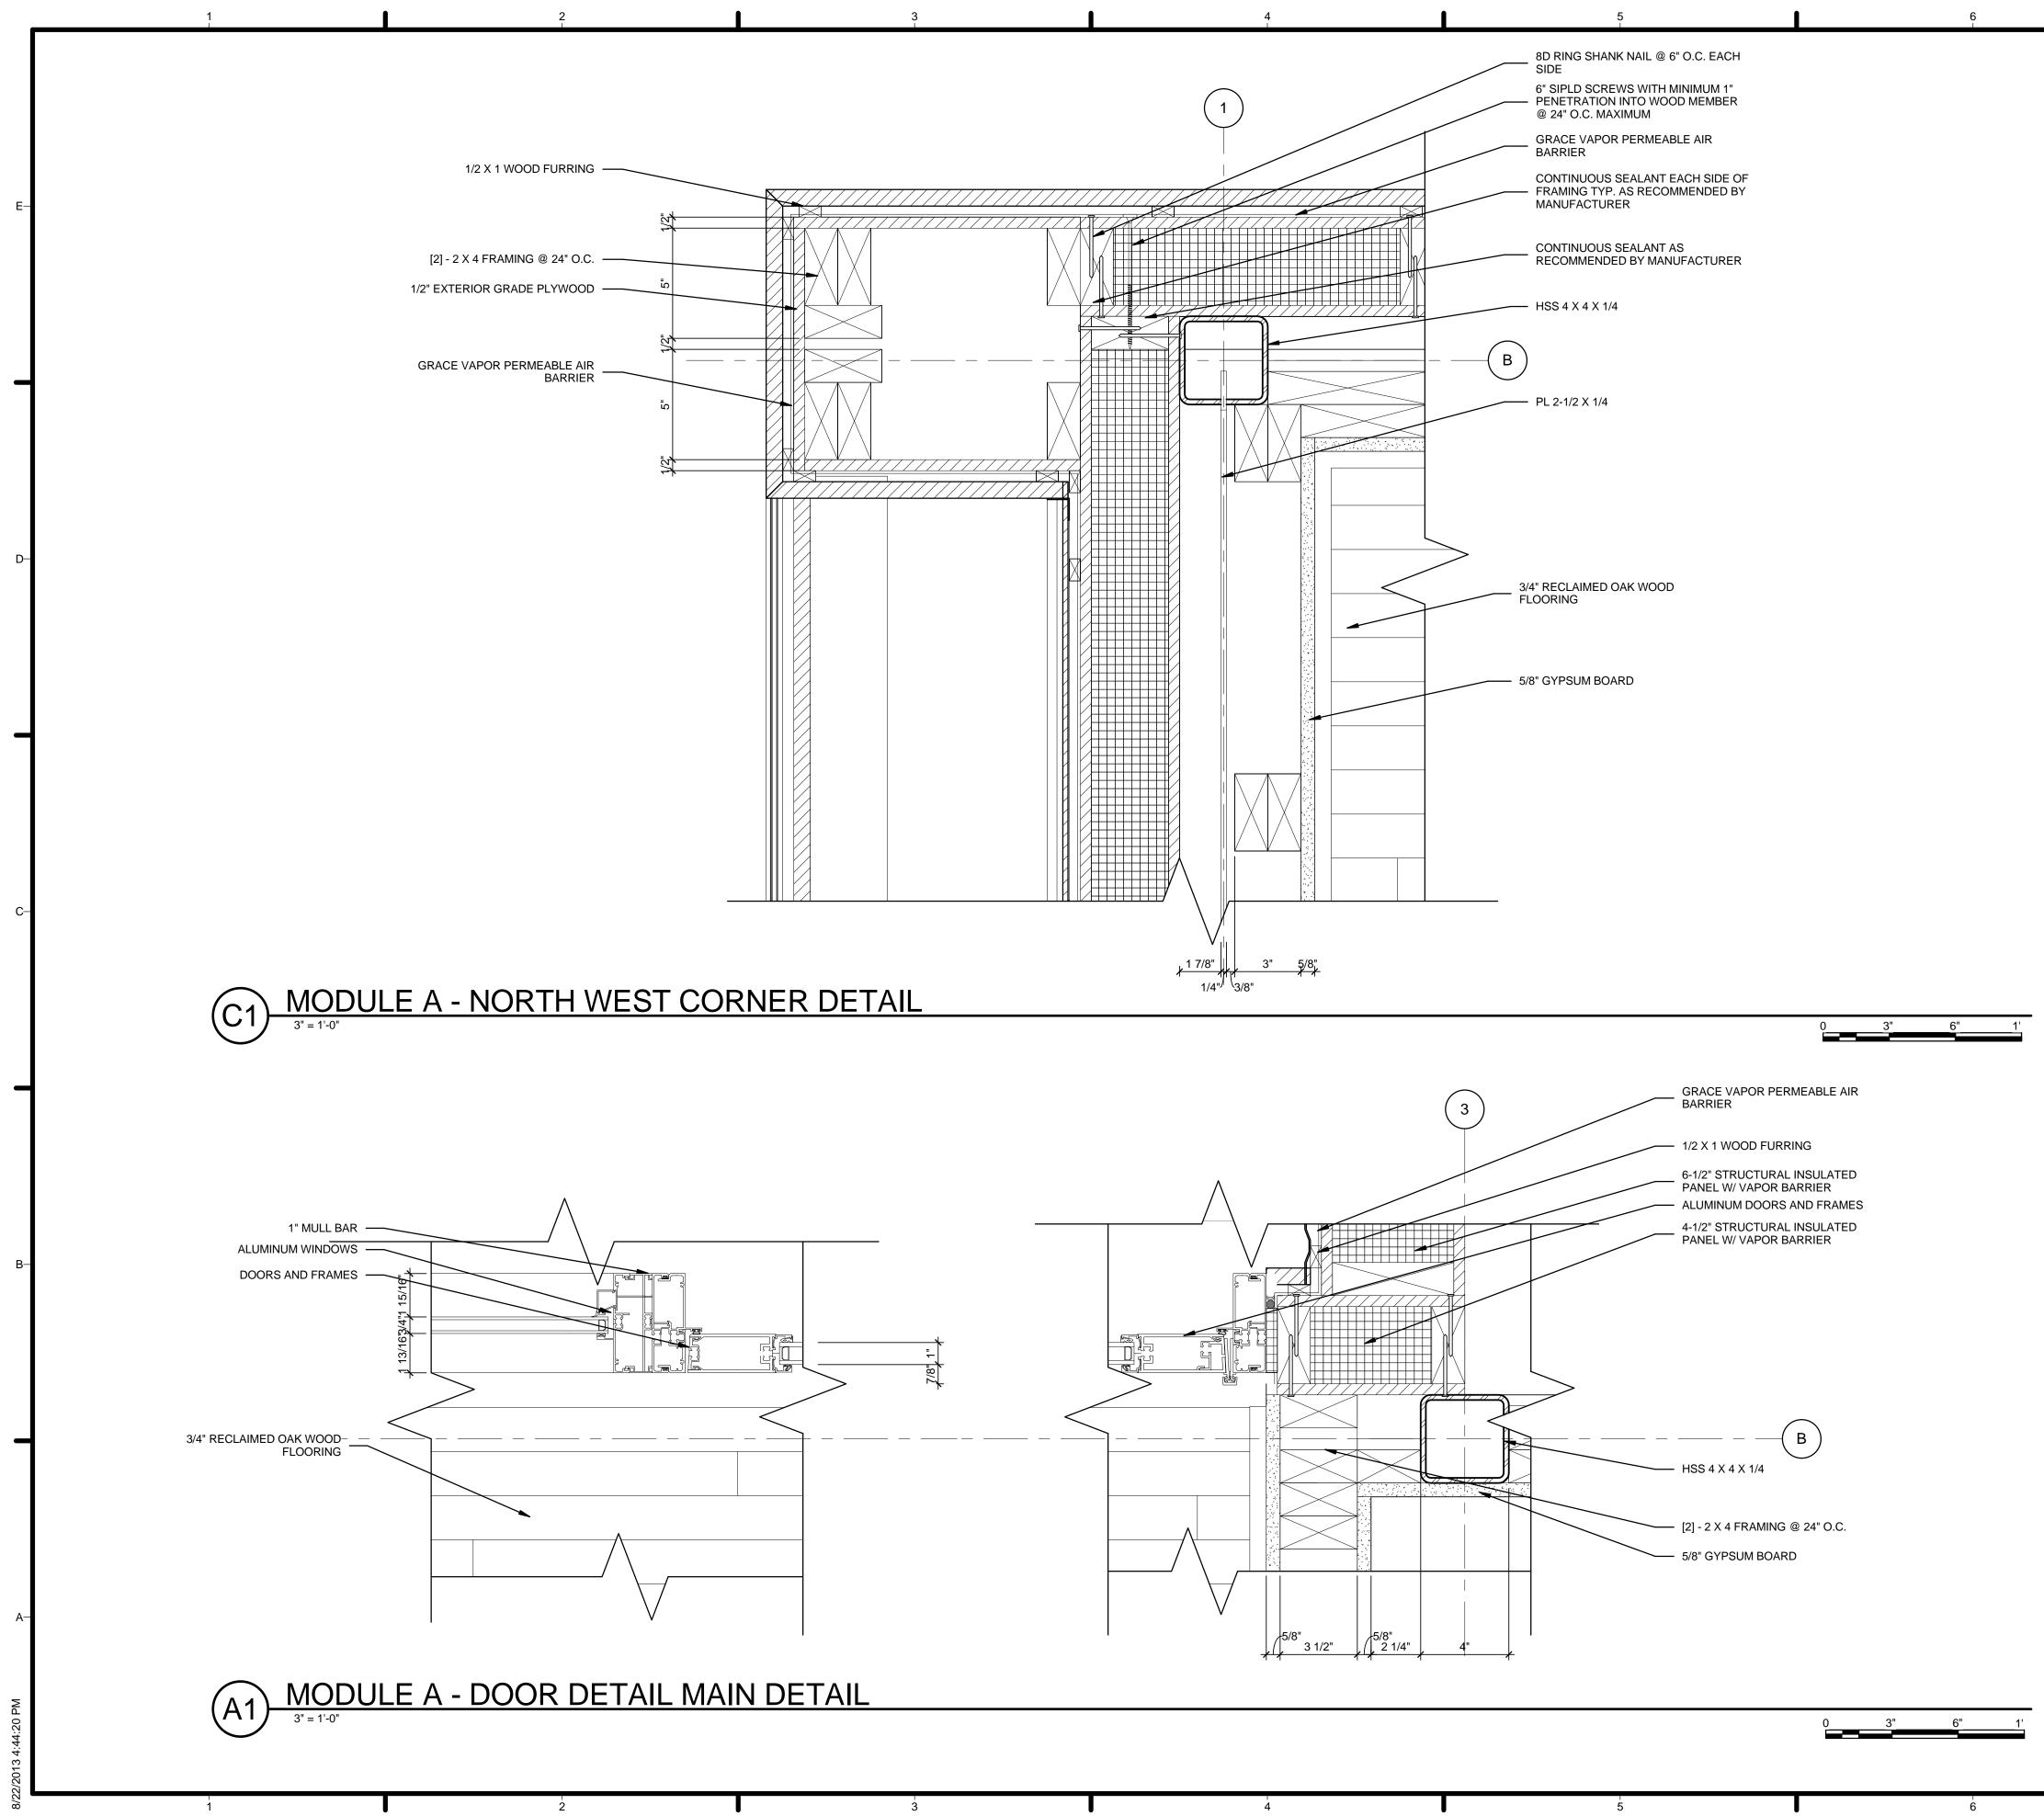


GENERAL SHEET NOTES 1. VERIFY ALL DIMENSIONS IN FIELD PRIOR TO FABRICATION AND INSTALLATION	-E	HARVEST LEAM dc
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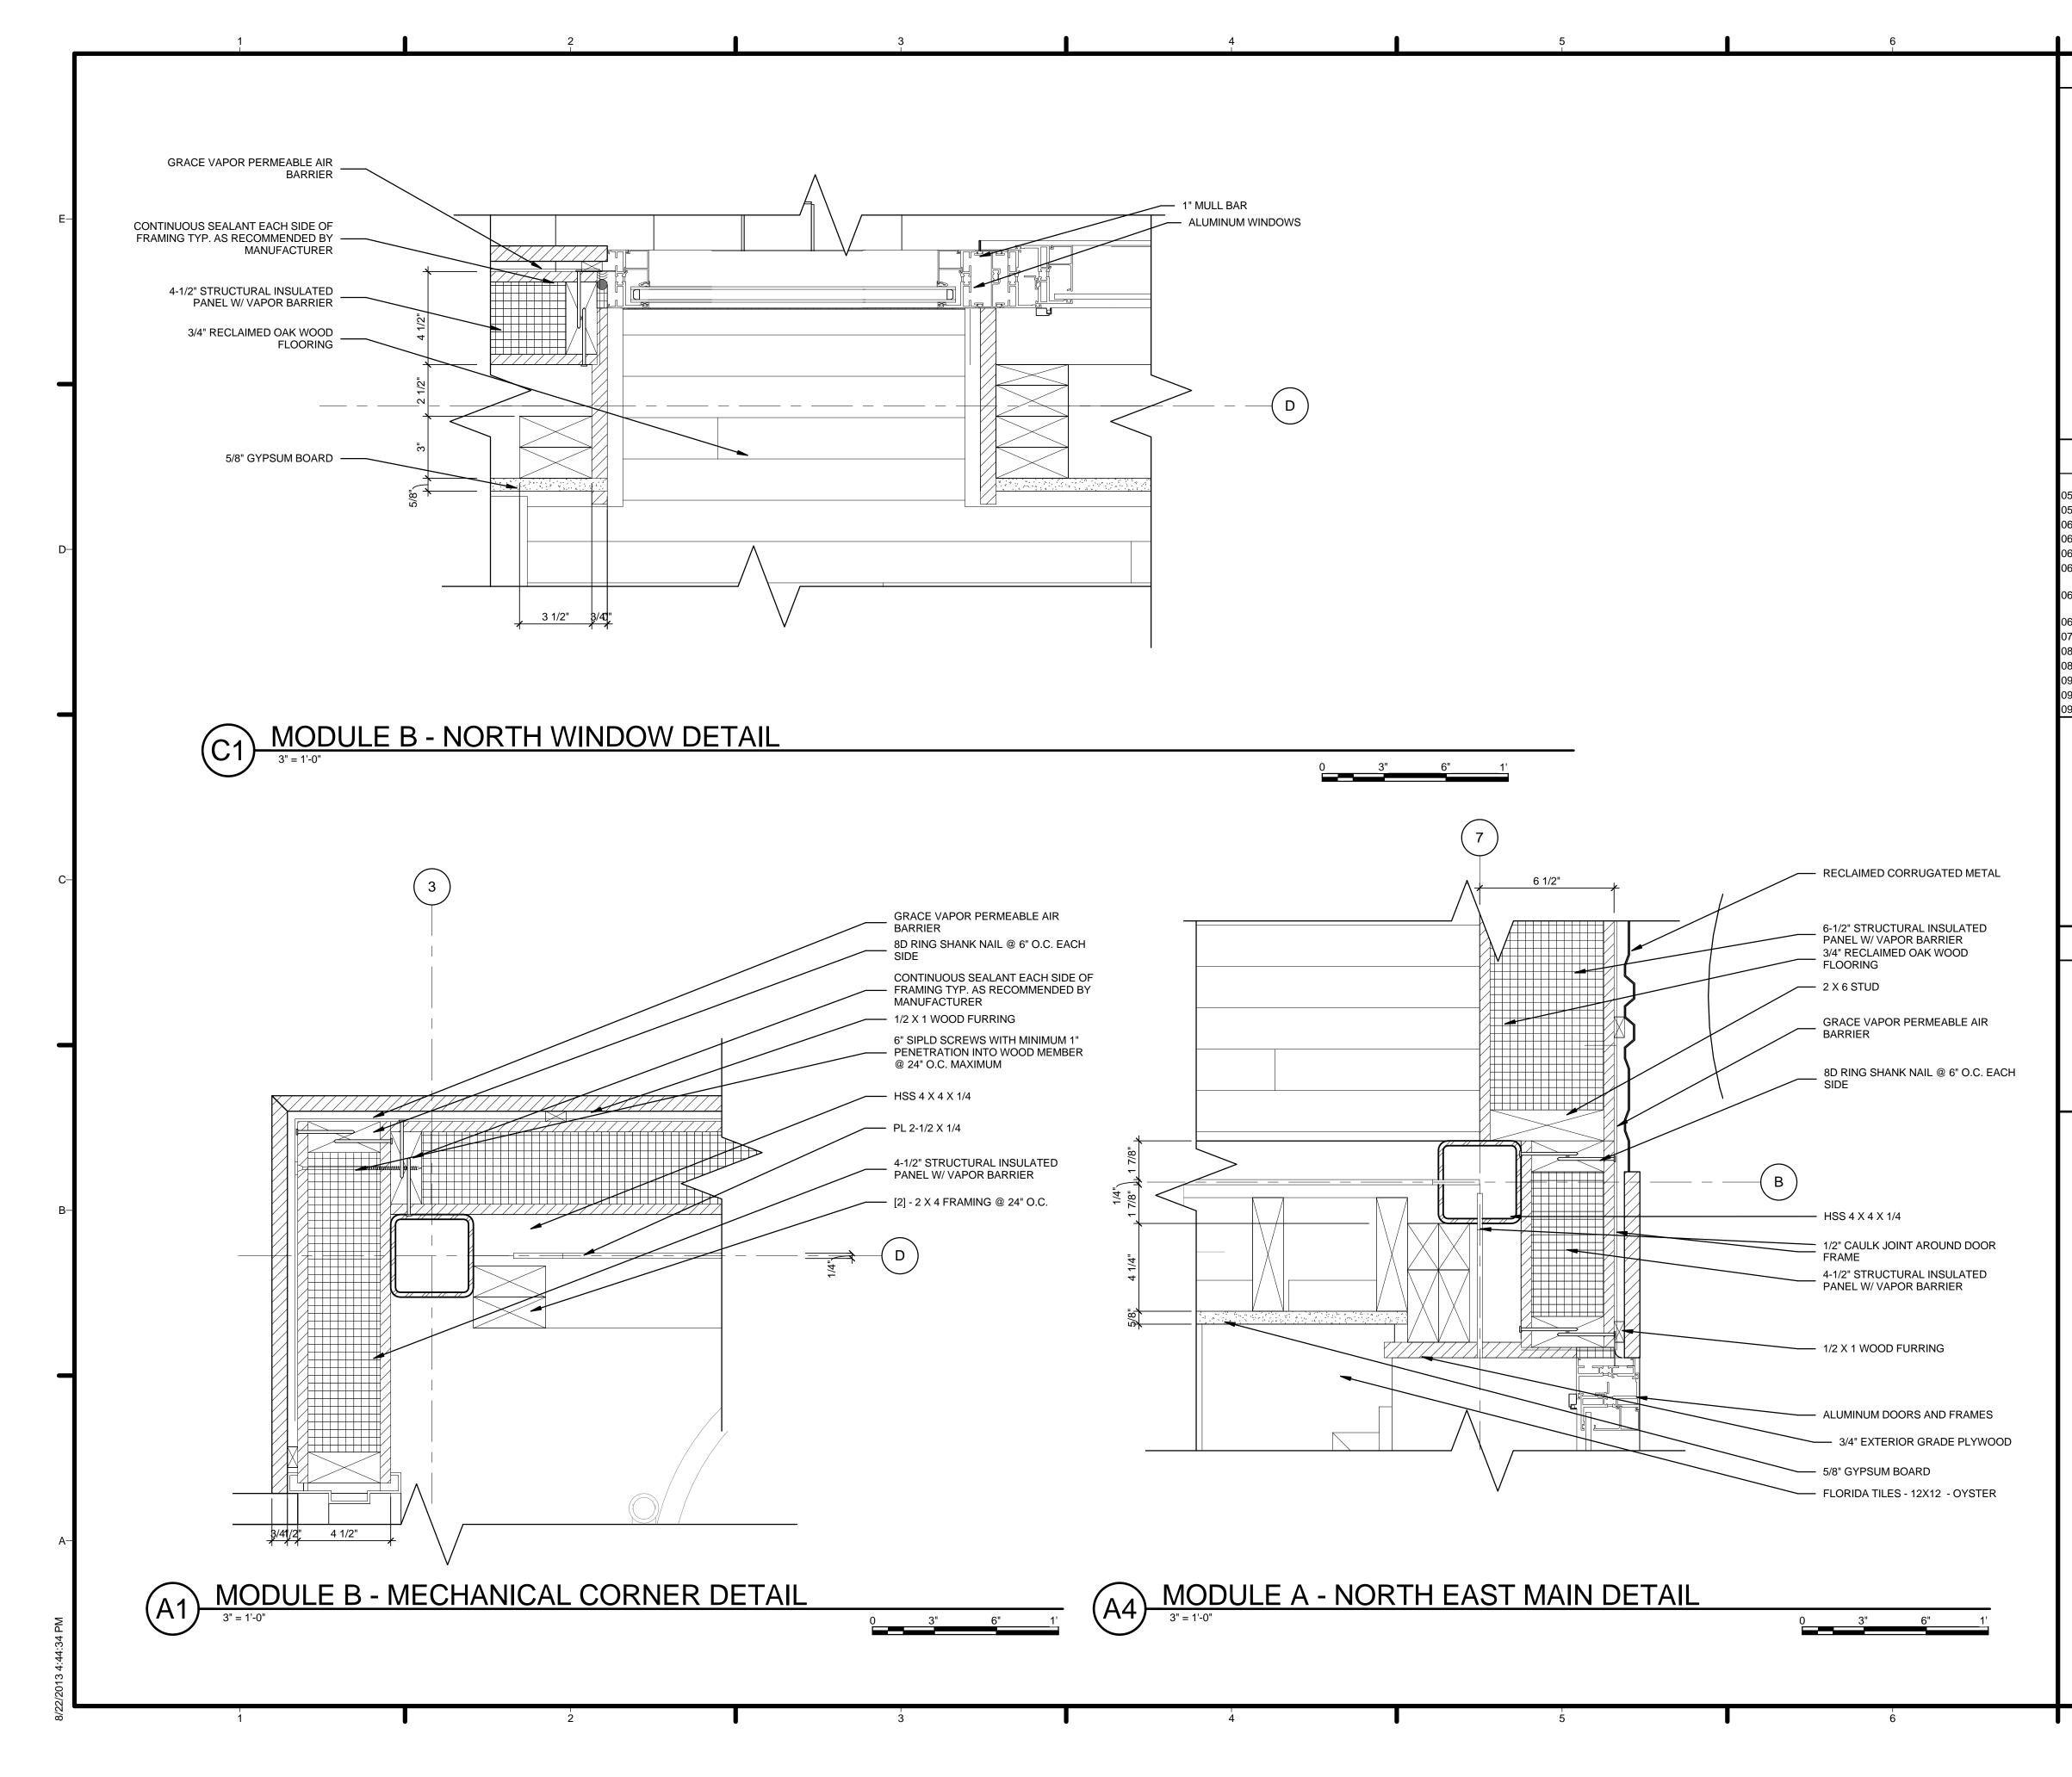




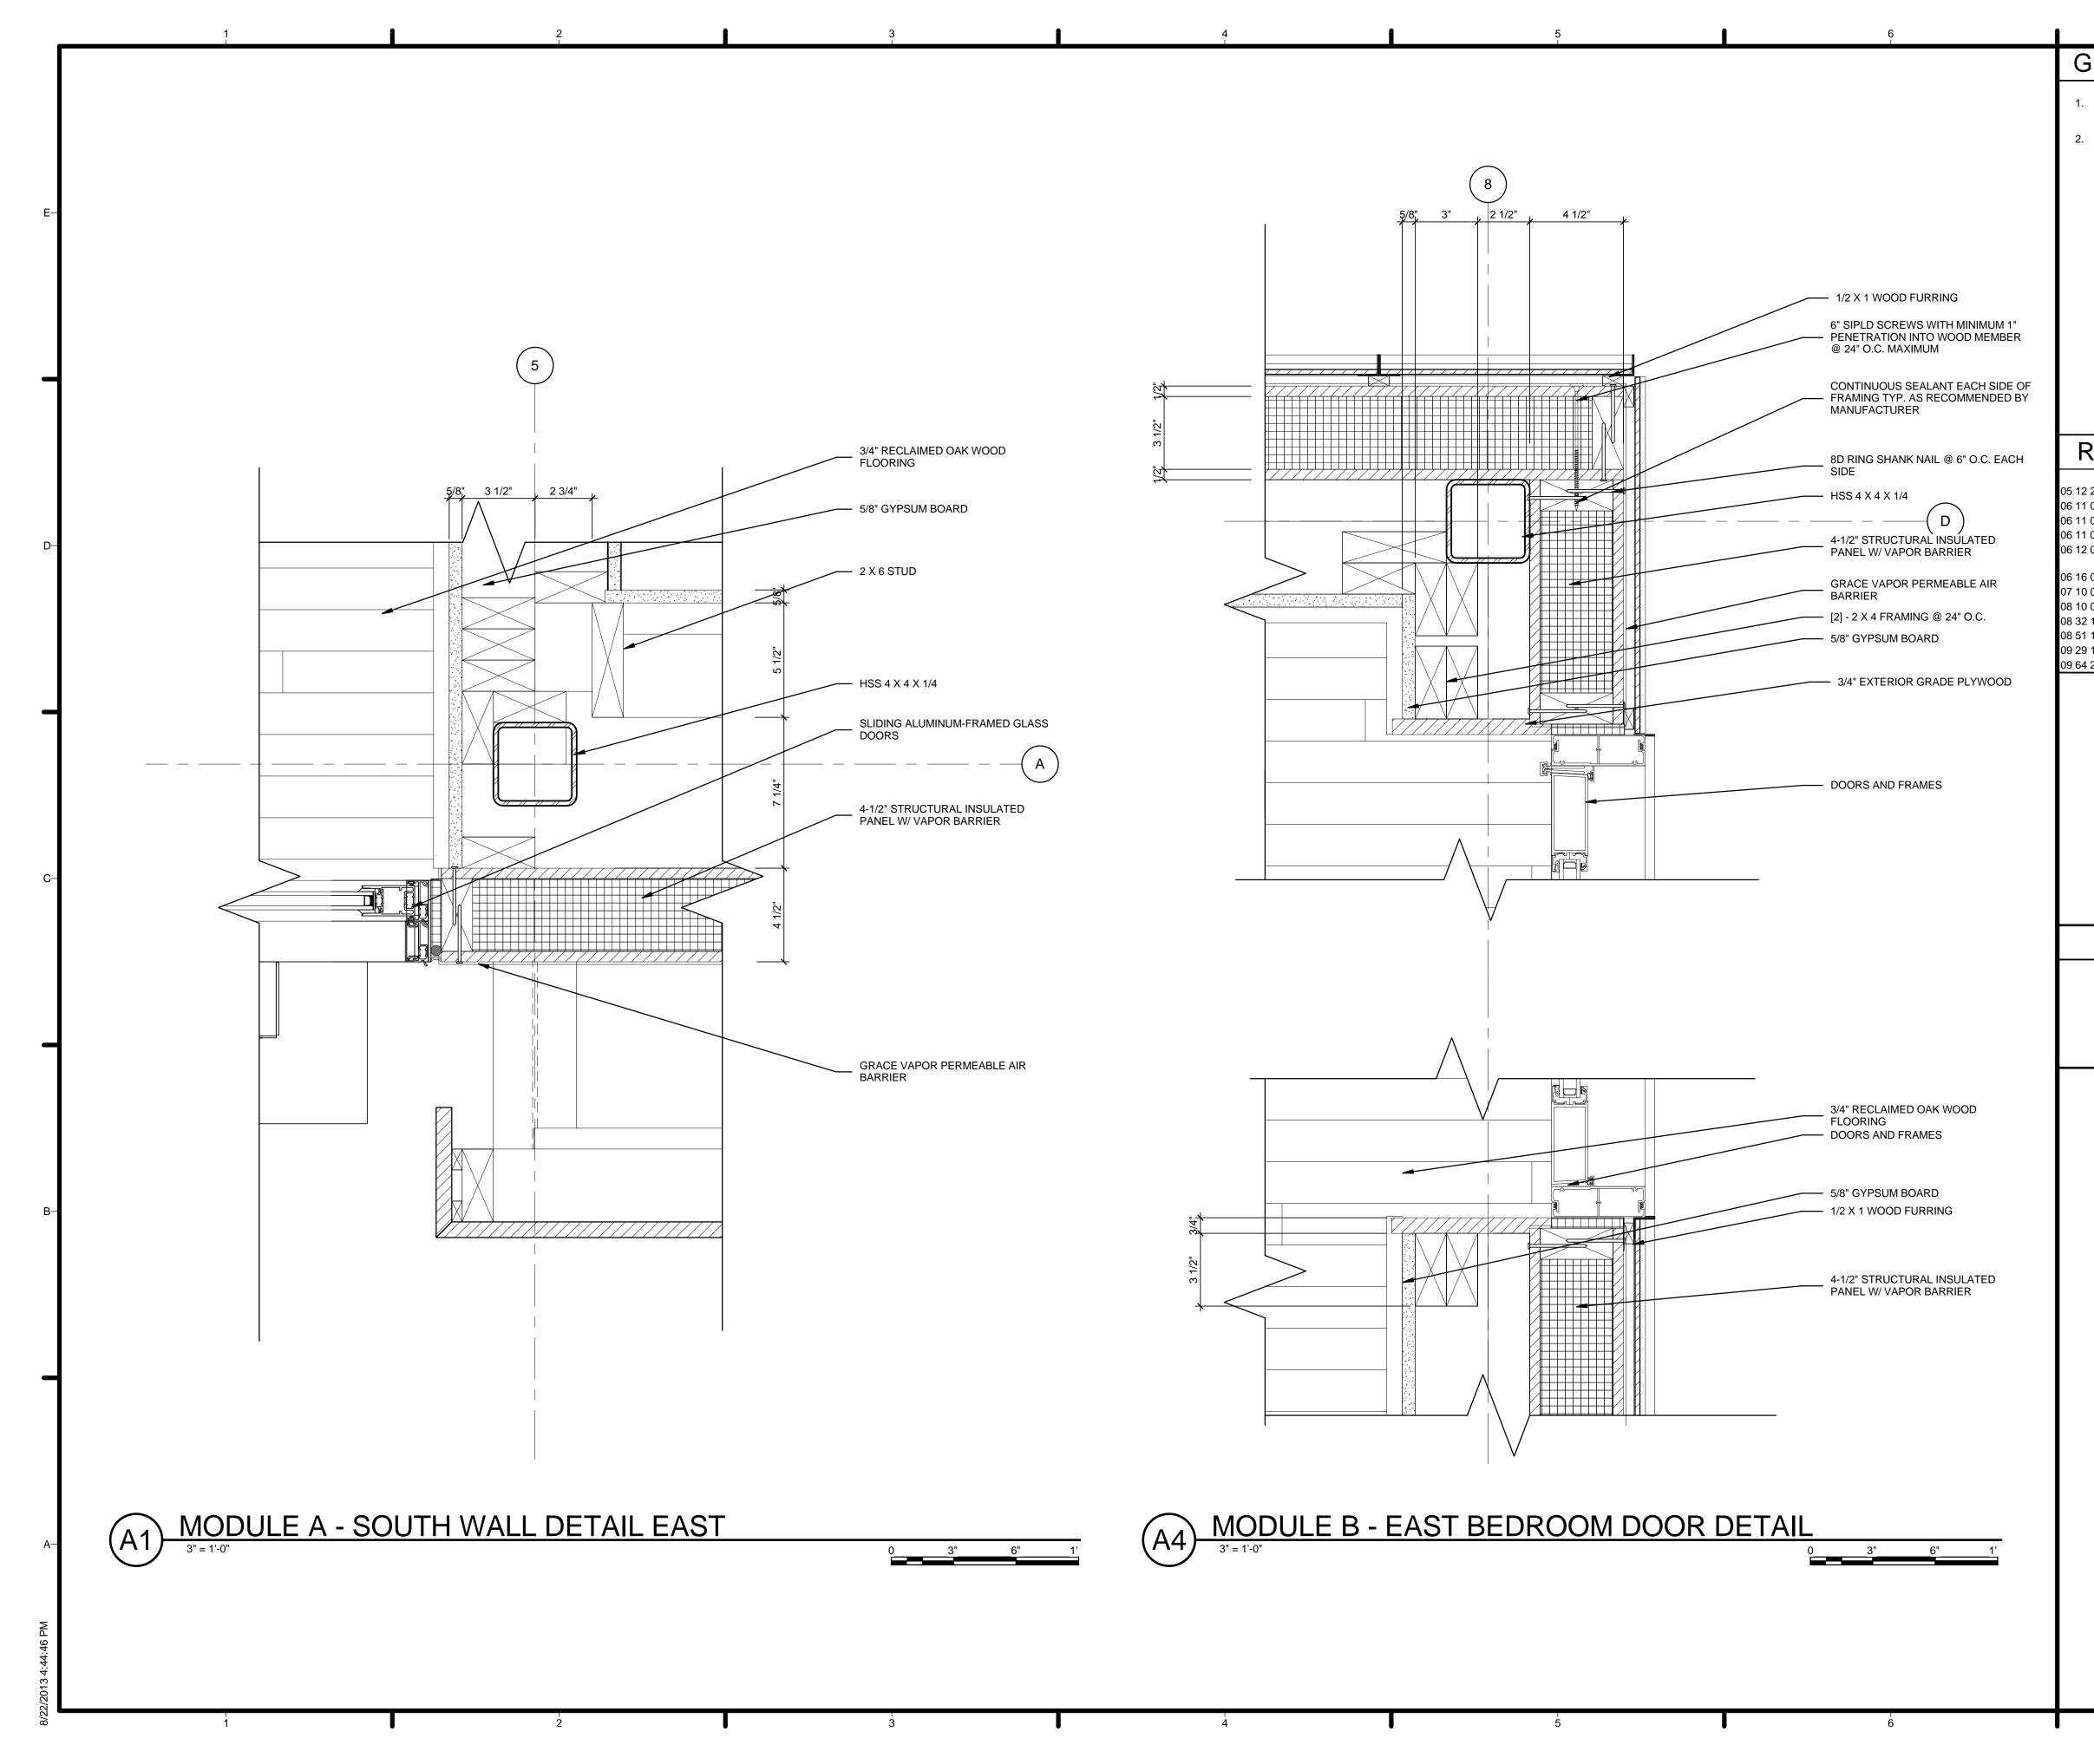




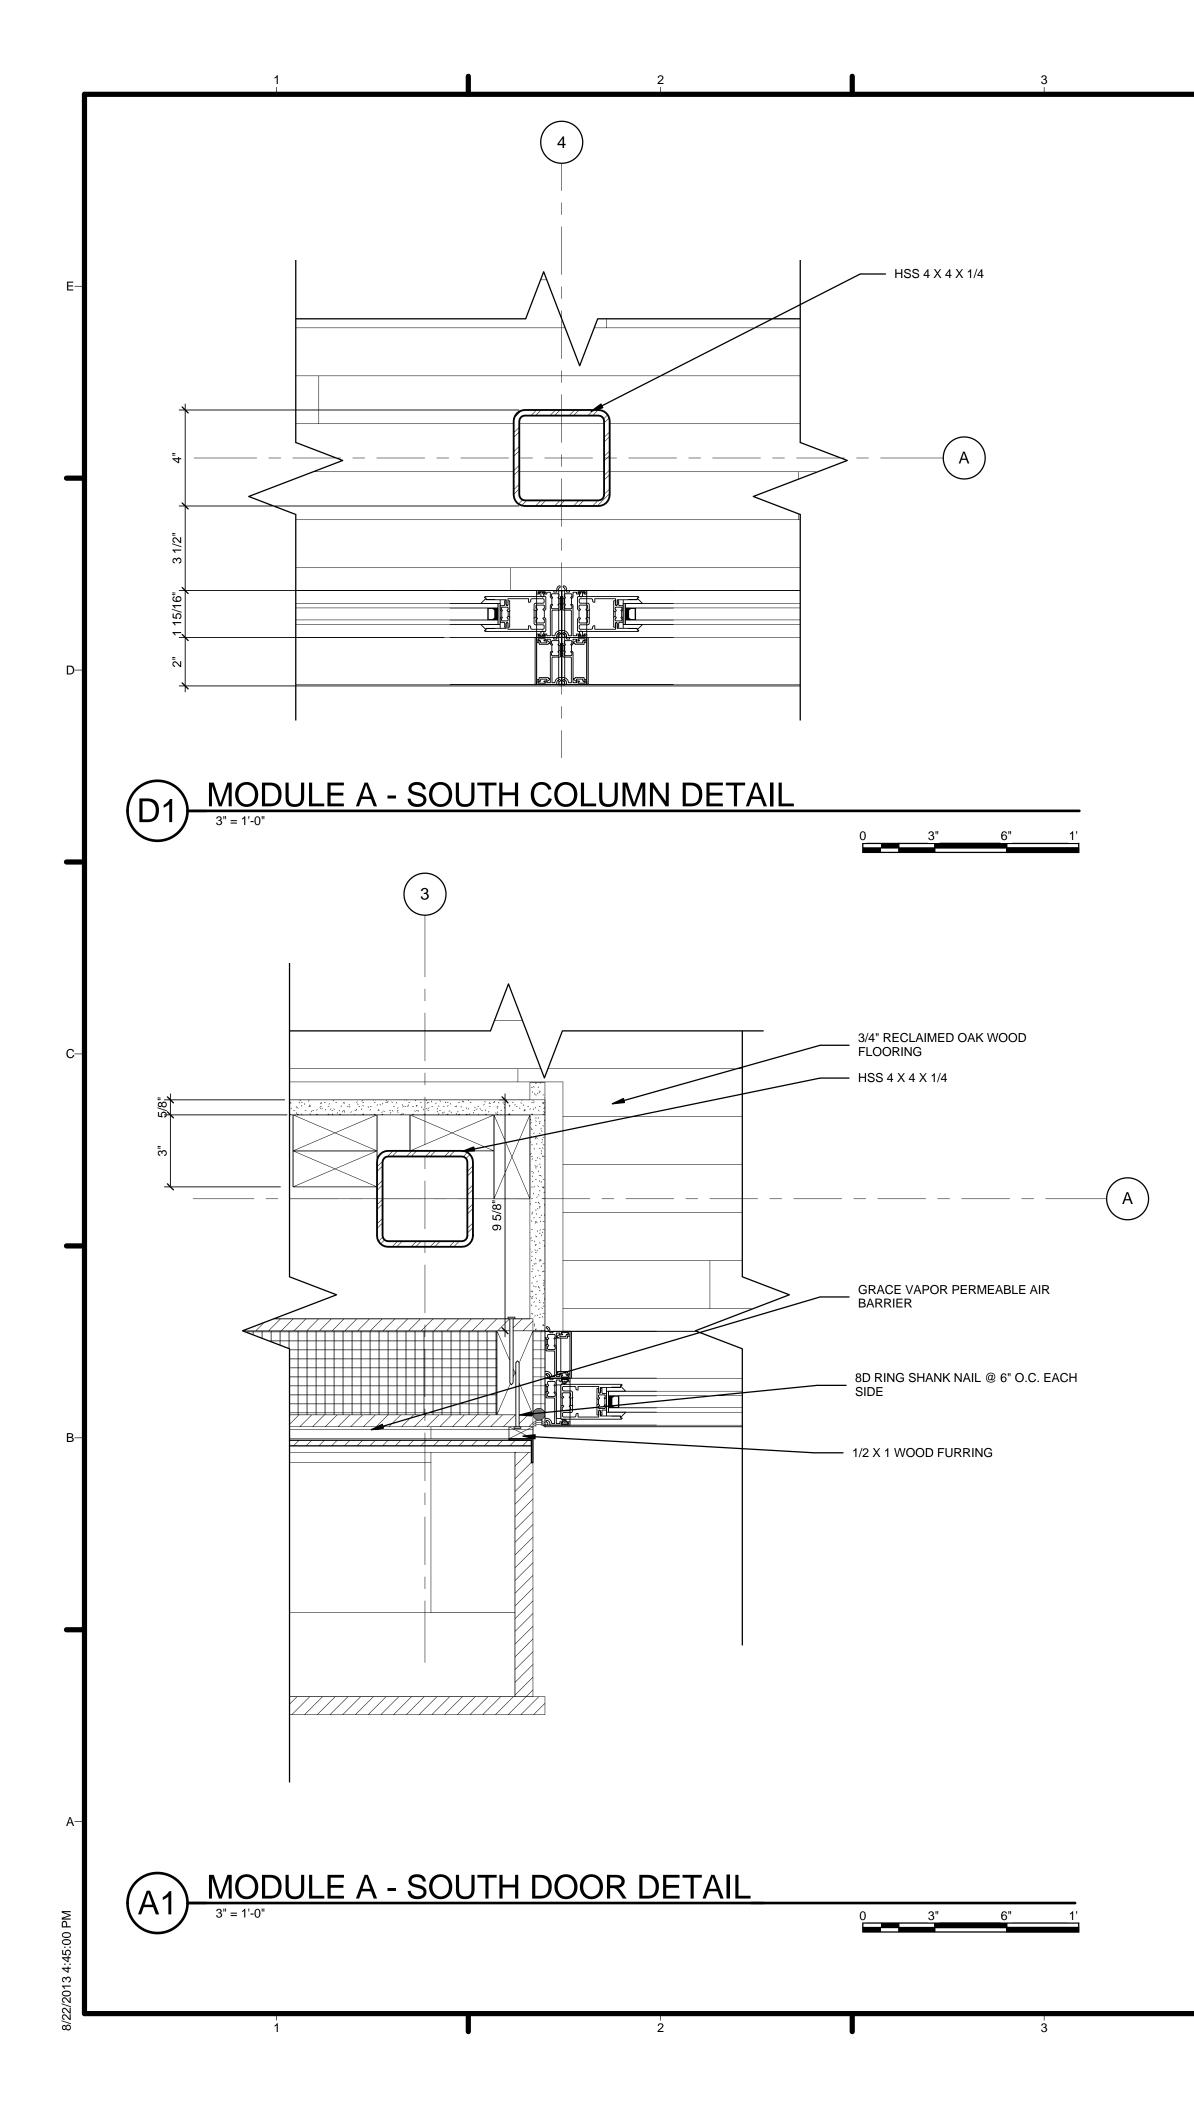
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09 64 29 3/4" RECLAIMED OAK WOOD FLOORING	W	ASHINGTON, DC 2 EL: 202.344.5513	20064
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01 6" SIPLD SCREWS WITH MINIMUM 1" PENETRATION INTO WOOD MEMBER @ 24"	0	SOLAR D WWW.SOLA	RTMENT OF ENERGY
 O.C. MAXIMUM 02 CONTINUOUS SEALANT EACH SIDE OF FRAMING TYP. AS RECOMMENDED BY MANUFACTURER 03 CONTINUOUS SEALANT AS RECOMMENDED BY MANUFACTURER 04 8D RING SHANK NAIL @ 6" O.C. EACH SIDE 15 1" MULL BAR 			R DECATHLON
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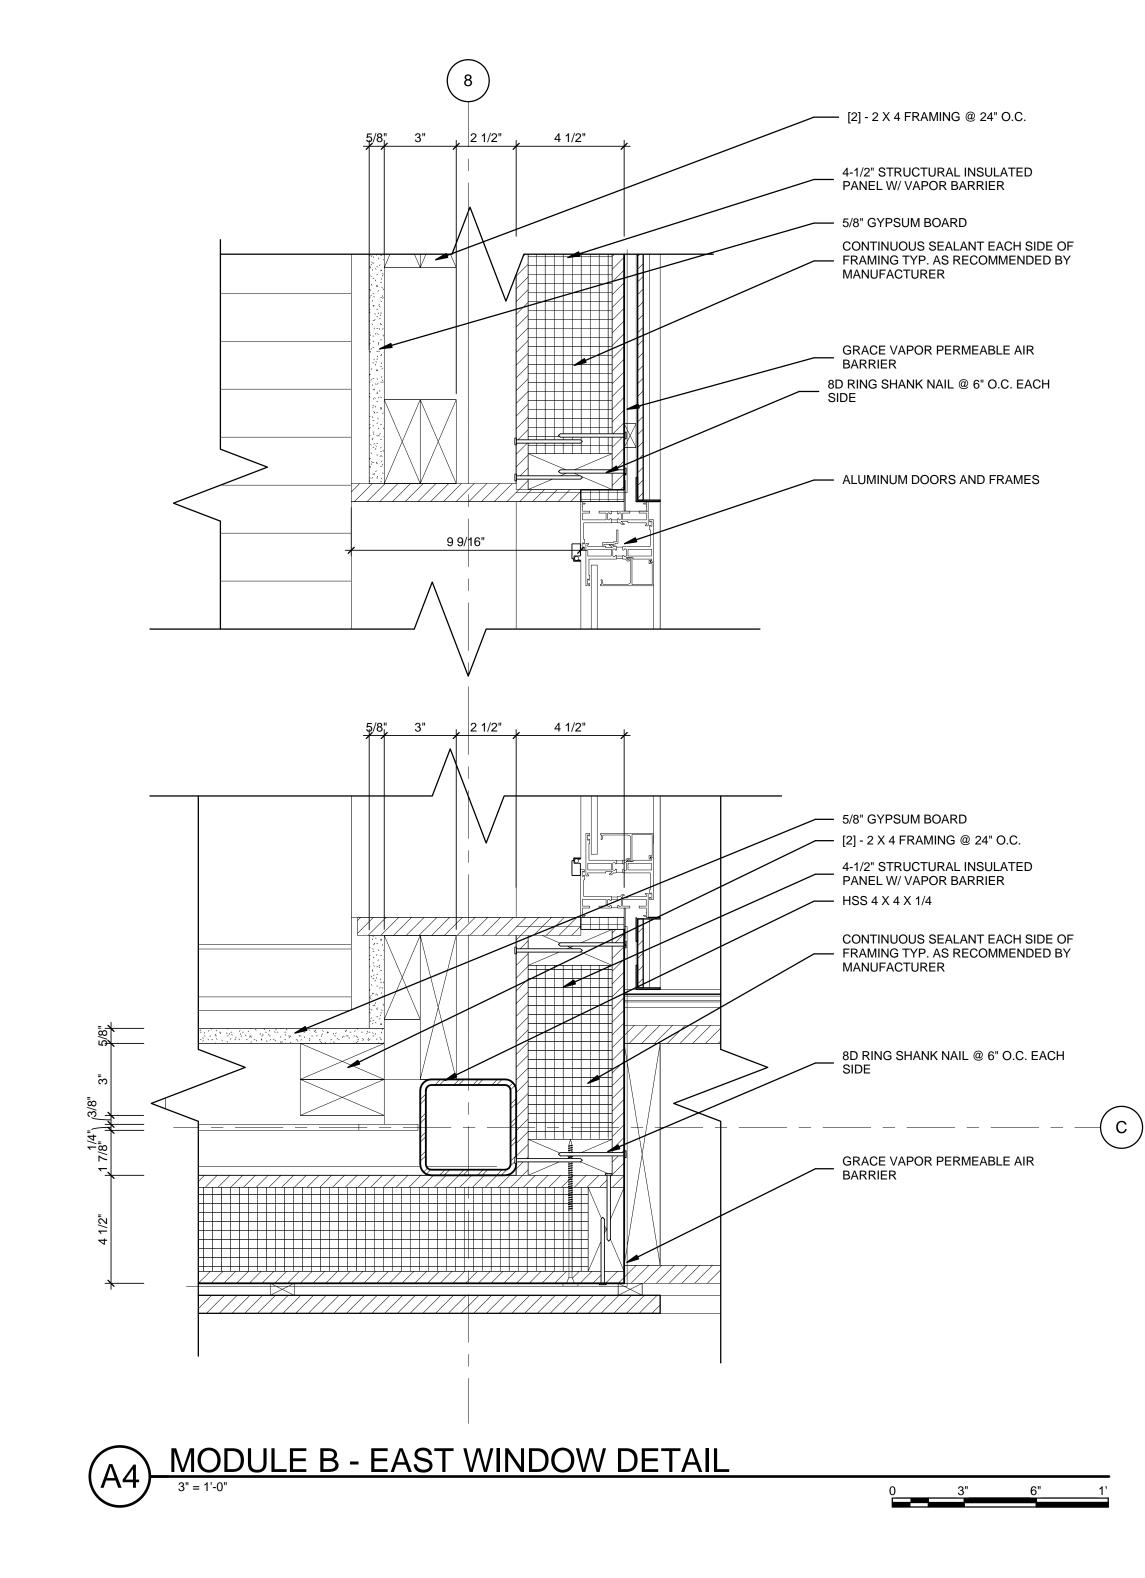


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	ADDRESS: THE CATHOLIC UNIVERSITY OF AMERIC
	SCHOOL OF ARCHITECTUR 620 MICHIGAN AVENUE, NE WASHINGTON, DC 2006
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06 11 00.F1 1/2 X 1 WOOD FURRING	WASHINGTON, DC 20036 TEL: 202.729.8220
06 12 00.A2 4-1/2" STRUCTURAL INSULATED PANEL W/ VAPOR BARRIER	MEP ENGINEER ARUP ENGINEERING 1120 CONNECTICUT
06 12 00.A3 6-1/2" STRUCTURAL INSULATED PANEL W/ VAPOR BARRIER	AVENUE, NW., SUITE 200 WASHINGTON, DC 20036
06 16 00.B33/4" EXTERIOR GRADE PLYWOOD07 10 01GRACE VAPOR PERMEABLE AIR BARRIER08 11 16ALLIMINI IM DOORS AND FRAMES	TEL: 202.729.8220 ARCHITECT OF RECORD
08 11 16ALUMINUM DOORS AND FRAMES08 51 13ALUMINUM WINDOWS09 29 10.A35/8" GYPSUM BOARD	WILLIAM JELEN, AIA 620 MICHIGAN AVE NE CROUIGH CENTER
09 29 10.A35/8" GYPSUM BOARD09 30 13FLORIDA TILES - 12X12 - OYSTER09 64 293/4" RECLAIMED OAK WOOD FLOORING	CROUGH CENTER WASHINGTON, DC 20064 TEL: 202.344.5513
	-C CLIENT
	U.S. DEPARTMENT OF ENERGY
SHEET KEYNOTES	SOLAR DECATHLON 2013 WWW.SOLARDECATHLON.GOV
01 6" SIPLD SCREWS WITH MINIMUM 1"	
PENETRATION INTO WOOD MEMBER @ 24" O.C. MAXIMUM	U.S. DEPARTMENT OF ENERGY
02 CONTINUOUS SEALANT EACH SIDE OF FRAMING TYP. AS RECOMMENDED BY MANUFACTURER	
048D RING SHANK NAIL @ 6" O.C. EACH SIDE151" MULL BAR	
471/2" CAULK JOINT AROUND DOOR FRAME99RECLAIMED CORRUGATED METAL	
	-B 4 2013.08.22 As-Built Submission
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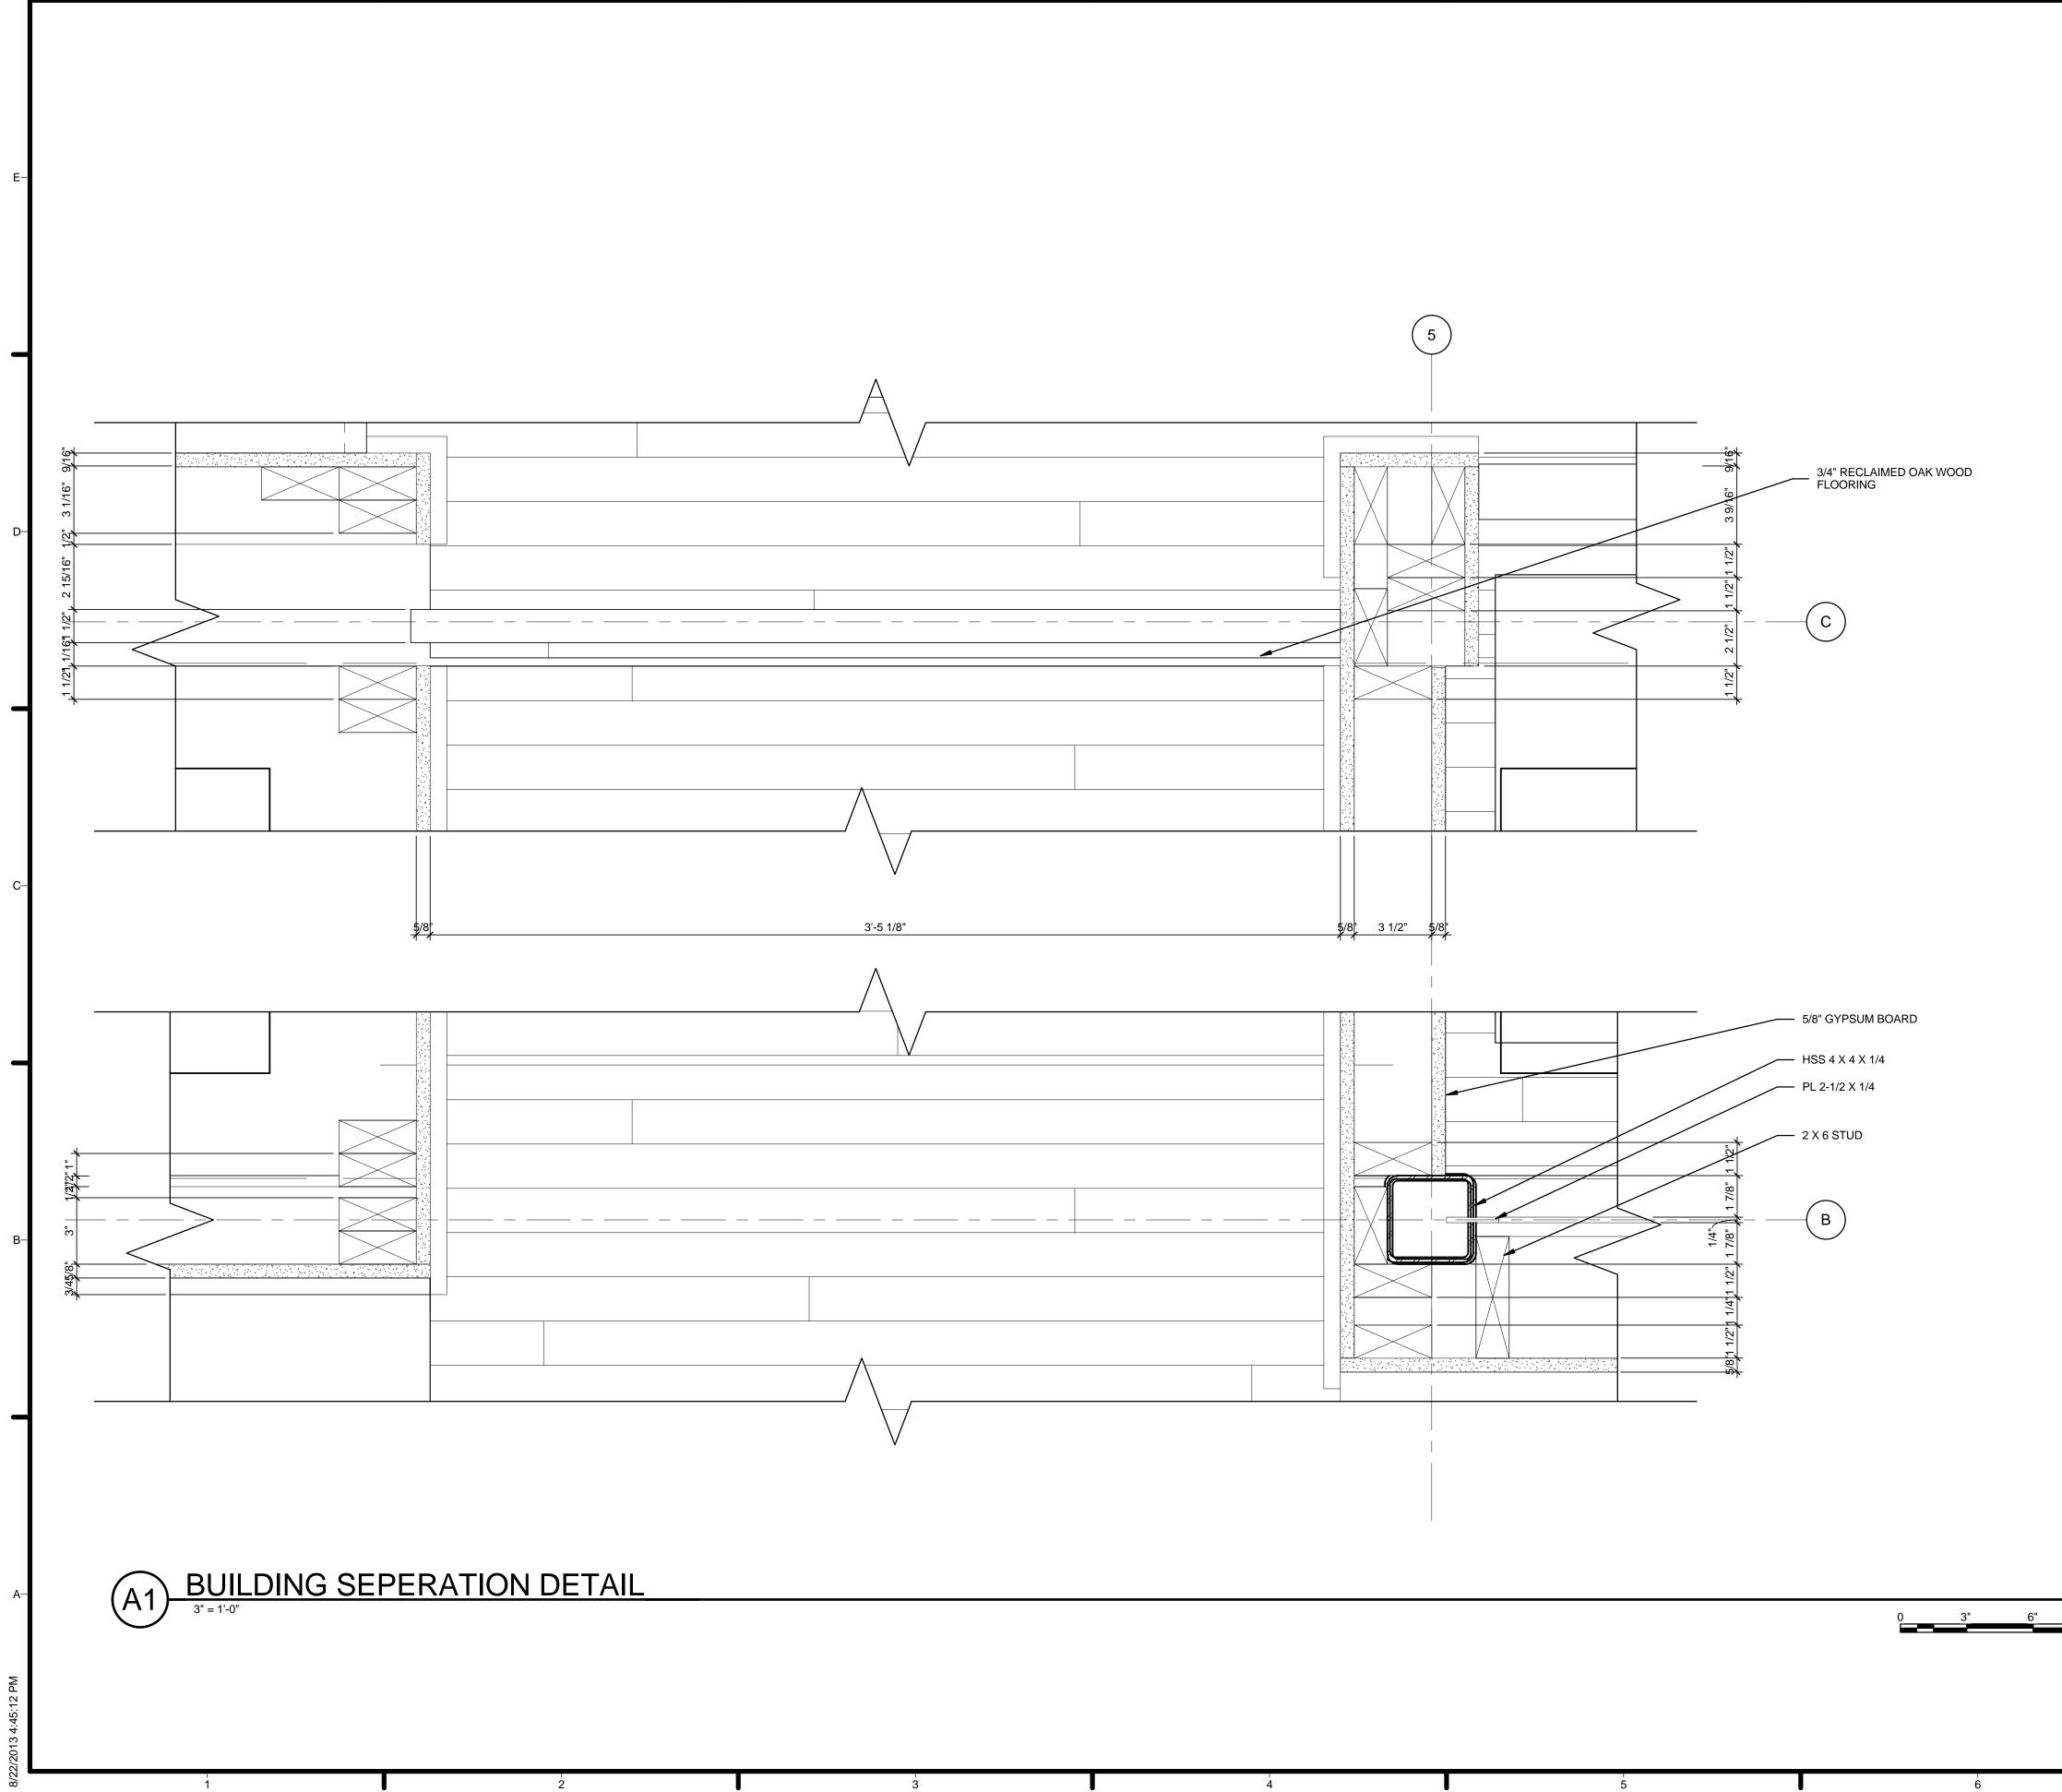


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 GENERAL SHEET NOTES 1. VERIFY ALL DIMENSIONS IN FIELD PRIOR TO FABRICATION AND INSTALLATION 2. SEE SHEET C-102 FOR MODULE IDENTITY 	-E	HARVEST CAPITOL
REFERENCE KEYNOTES		TEAM NAME: Team Capitol dc ADDRESS: THE CATHOLIC UNIVERSITY OF AMERICA SCHOOL OF ARCHITECTURE 620 MICHIGAN AVENUE, NE. WASHINGTON, DC 20064
 05 12 23.A7 HSS 4 X 4 X 1/4 06 11 00.A3 [2] - 2 X 4 FRAMING @ 24" O.C. 06 11 00.B1 2 X 6 STUD 06 11 00.F1 1/2 X 1 WOOD FURRING 06 12 00.A2 4-1/2" STRUCTURAL INSULATED PANEL W/ VAPOR BARRIER 06 16 00.B3 3/4" EXTERIOR GRADE PLYWOOD 07 10 01 GRACE VAPOR PERMEABLE AIR BARRIER 08 10 00 DOORS AND FRAMES 08 32 13 SLIDING ALUMINUM-FRAMED GLASS DOORS 08 51 13 ALUMINUM WINDOWS 09 29 10.A3 5/8" GYPSUM BOARD 09 64 29 3/4" RECLAIMED OAK WOOD FLOORING 	-D	STRUCTURAL ENGINEER BOB ALLISON, PE ARUP ENGINEERING 1120 CONNECTICUT AVENUE, NW., SUITE 200 WASHINGTON, DC 20036 TEL: 202.729.8220 MEP ENGINEER ARUP ENGINEERING 1120 CONNECTICUT AVENUE, NW., SUITE 200 WASHINGTON, DC 20036 TEL: 202.729.8220 ARCHITECT OF RECORD WILLIAM JELEN, AIA 620 MICHIGAN AVE NE CROUGH CENTER WASHINGTON, DC 20064 TEL: 202.344.5513
OI 6" SIPLD SCREWS WITH MINIMUM 1" PENETRATION INTO WOOD MEMBER @ 24"	_c	CLIENT U.S. DEPARTMENT OF ENERGY SOLAR DECATHLON 2013 WWW.SOLARDECATHLON.GOV
O.C. MAXIMUM 02 CONTINUOUS SEALANT EACH SIDE OF FRAMING TYP. AS RECOMMENDED BY MANUFACTURER 04 8D RING SHANK NAIL @ 6" O.C. EACH SIDE		SOLAR DECATHLON
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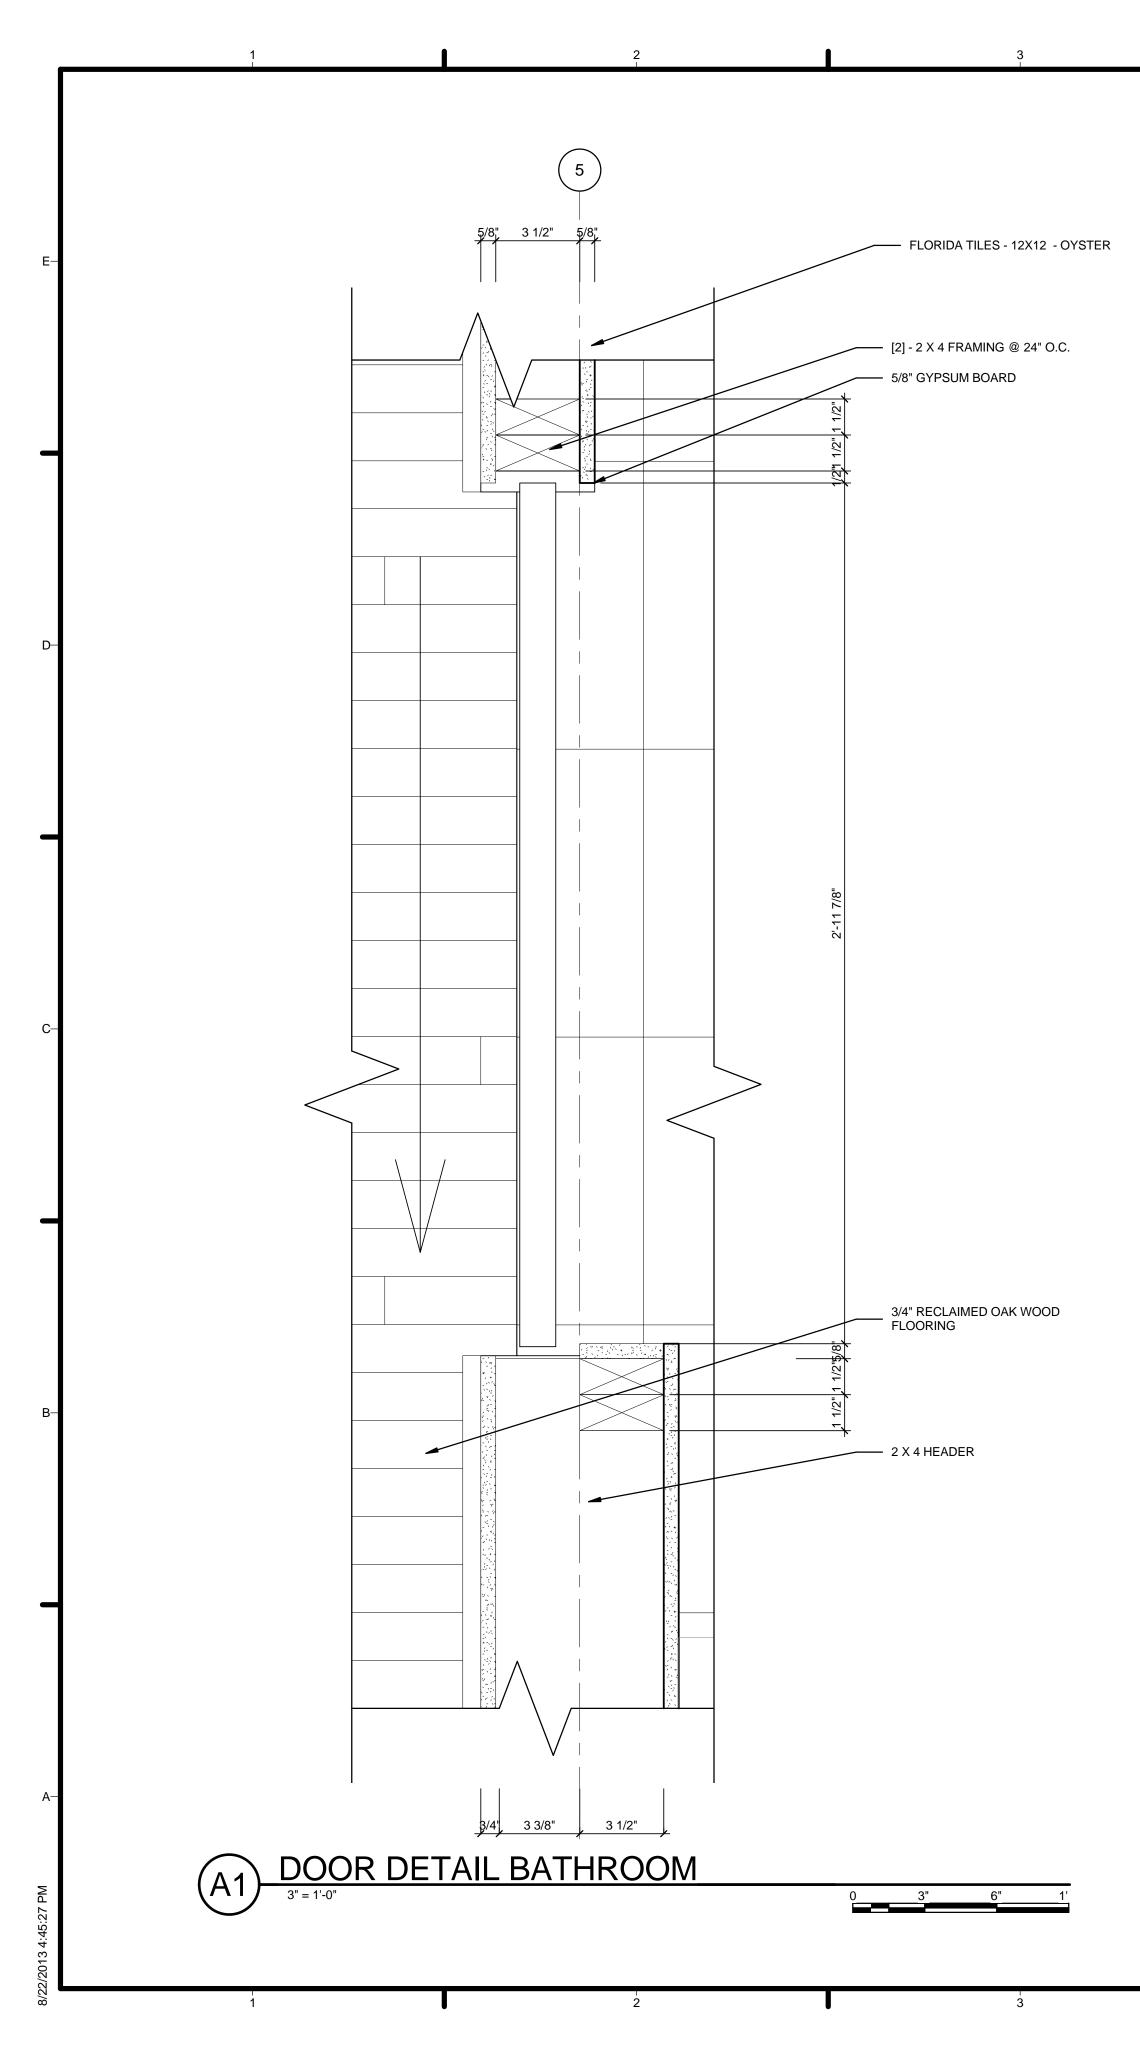




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REFERENCE KEYNOTES05 12 23.A7HSS 4 X 4 X 1/405 12 23.C1PL 2-1/2 X 1/406 11 00.A3[2] - 2 X 4 FRAMING @ 24" O.C.06 11 00.F11/2 X 1 WOOD FURRING06 12 00.A24-1/2" STRUCTURAL INSULATED PANEL W/ WAPOR BARRIER07 10 01GRACE VAPOR PERMEABLE AIR BARRIER08 11 16ALUMINUM DOORS AND FRAMES09 29 10.A35/8" GYPSUM BOARD09 64 293/4" RECLAIMED OAK WOOD FLOORING	WASHINGTON, DC 20064 STRUCTURAL ENGINEER BOB ALLISON, PE ARUP ENGINEERING 1120 CONNECTICUT AVENUE, NW., SUITE 200 WASHINGTON, DC 20036 TEL: 202.729.8220 MEP ENGINEER ARUP ENGINEERING 1120 CONNECTICUT AVENUE, NW., SUITE 200 WASHINGTON, DC 20036 TEL: 202.729.8220 ARCHITECT OF RECORD WILLIAM JELEN, AIA 620 MICHIGAN AVE NE CROUGH CENTER WASHINGTON, DC 20064 TEL: 202.344.5513
SHEET KEYNOTES 02 CONTINUOUS SEALANT EACH SIDE OF FRAMING TYP. AS RECOMMENDED BY MANUFACTURER 04 8D RING SHANK NAIL @ 6" O.C. EACH SIDE	-C CLIENT U.S. DEPARTMENT OF ENERGY SOLAR DECATHLON 2013 WWW.SOLARDECATHLON.GOV U.S. DEPARTMENT OF ENERGY SOLAR DECATHLON
	-B 4 2013.08.22 As-Built Submission 3 2013.02.04 100% CD Submission 2 2012.11.20 80% DD Revisions 1 2012.10.11 80% DD Submission MARK DATE DESCRIPTION LOT NUMBER: 115 DRAWN BY: TEAM CAPITOL DC CHECKED BY: TEAM CAPITOL DC COPYRIGHT: NONE: PROJECT IS PUBLIC DOMAIN
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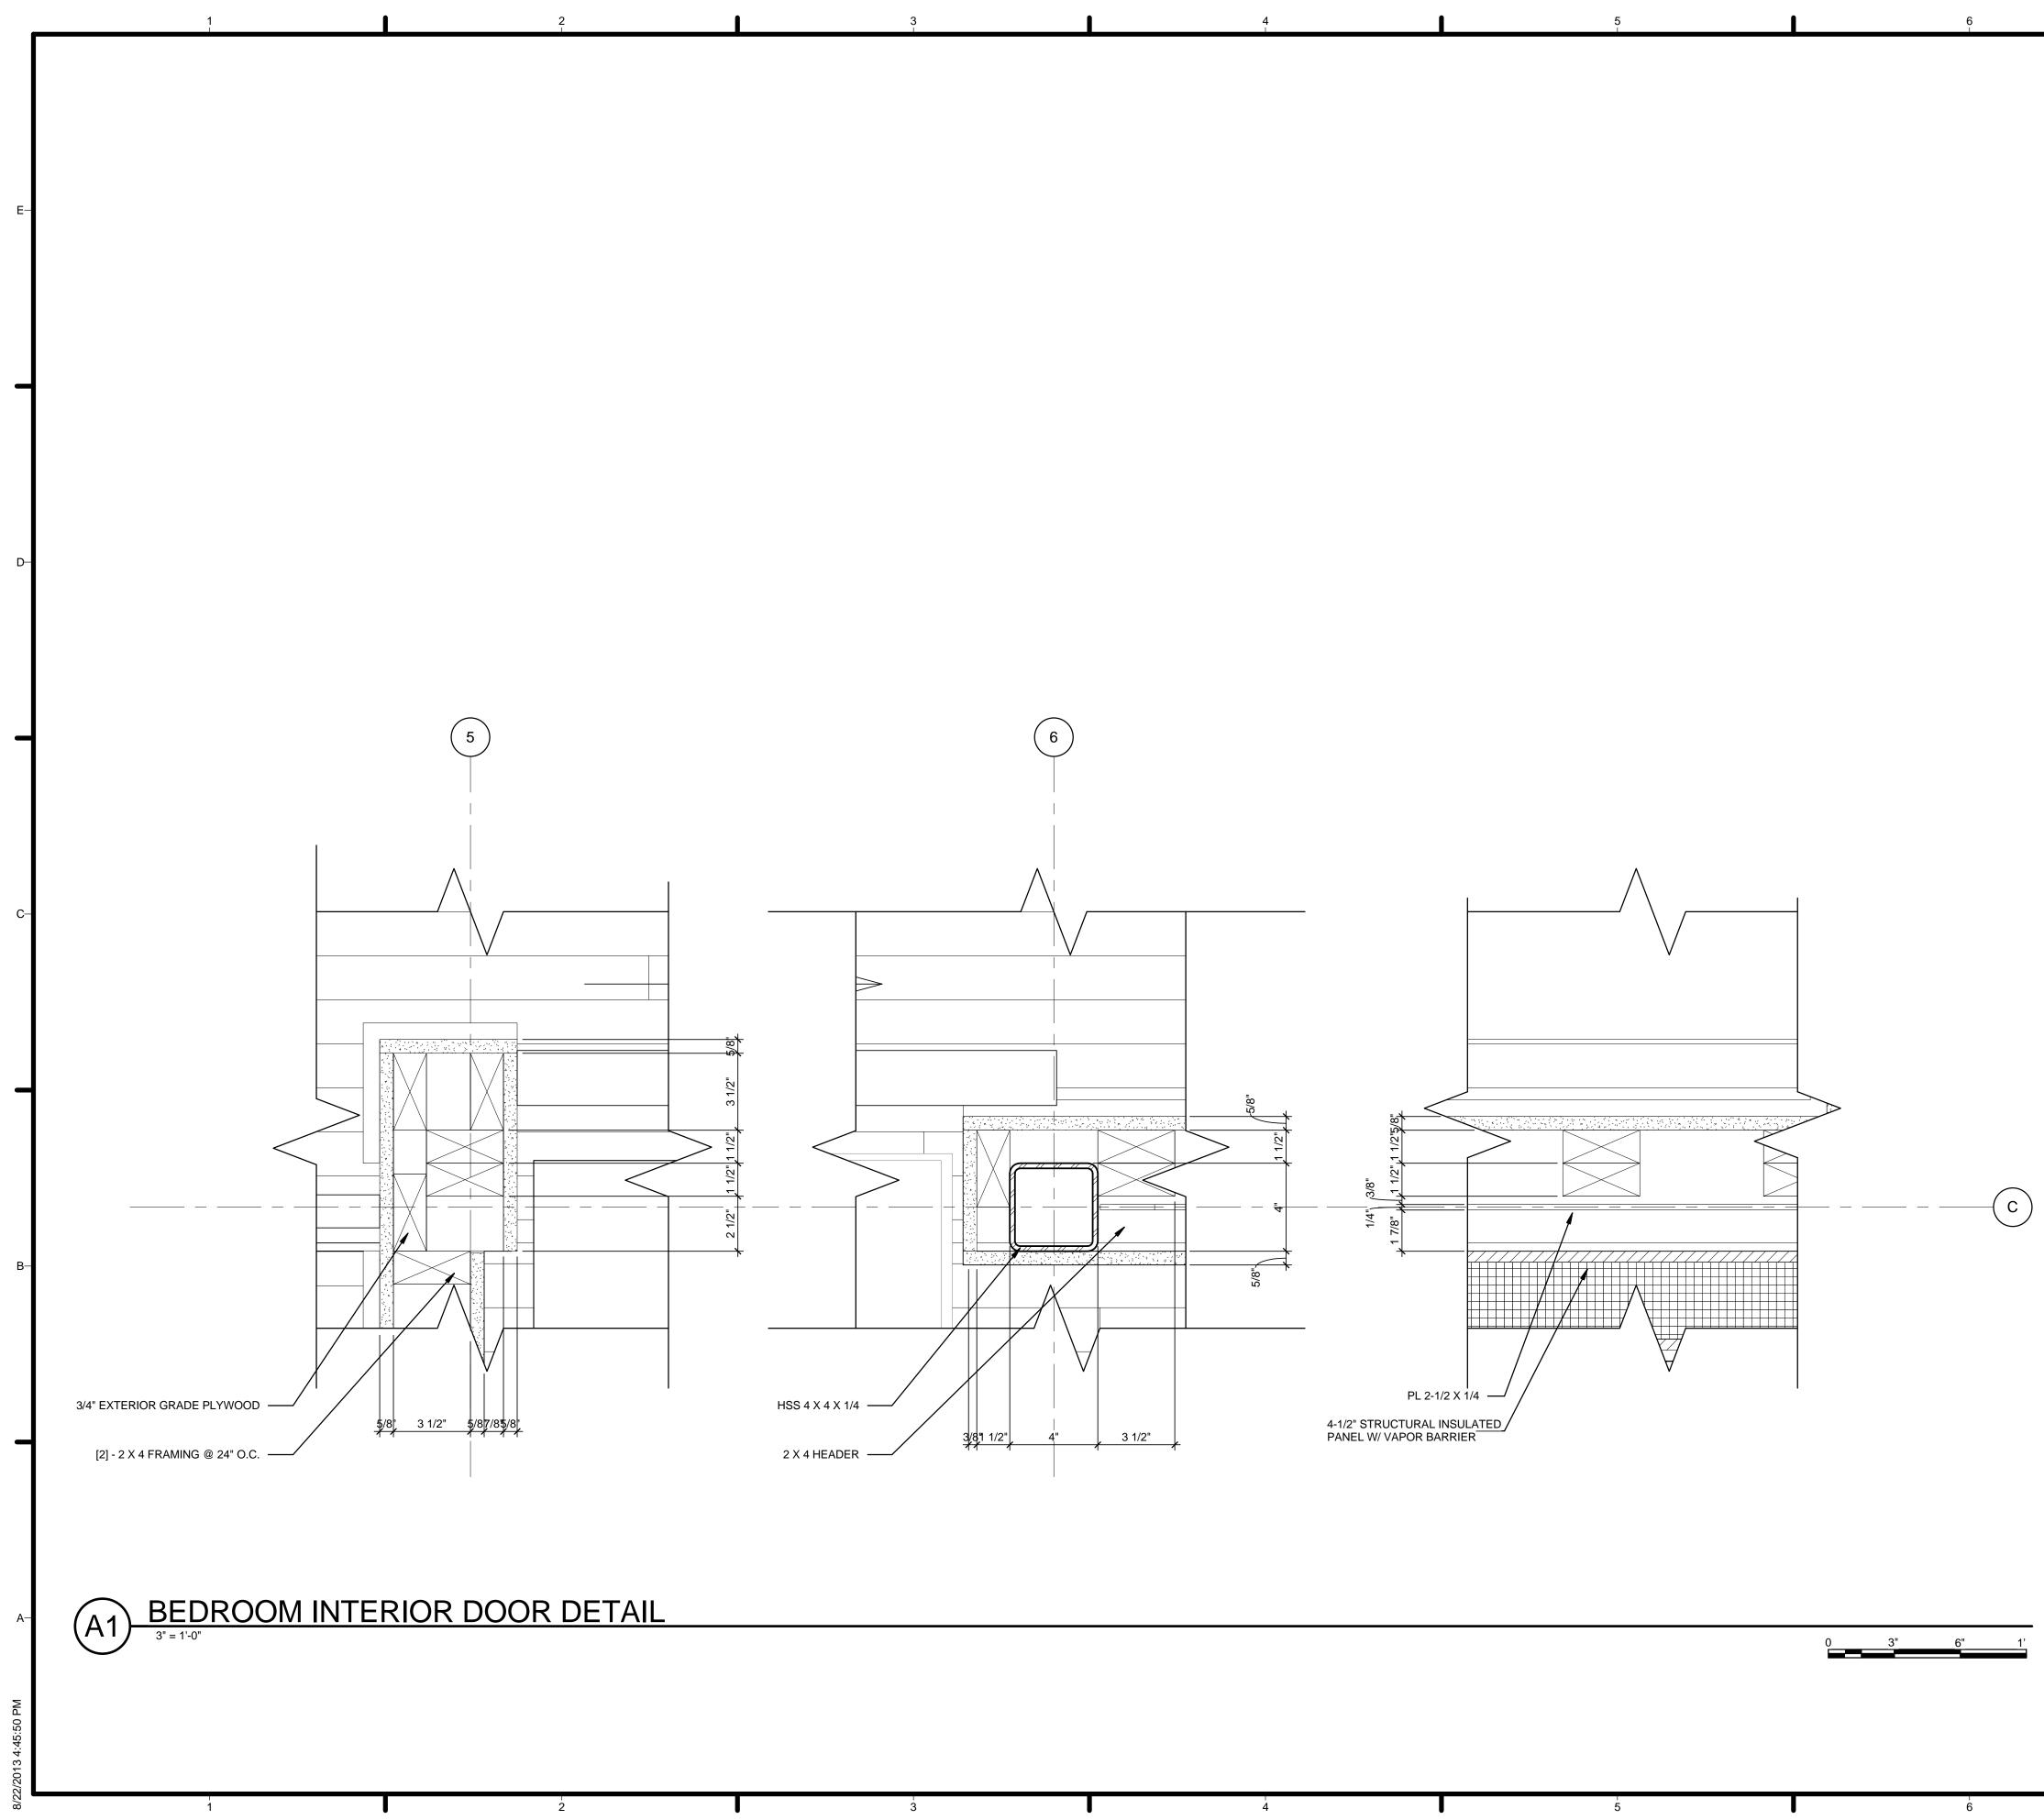
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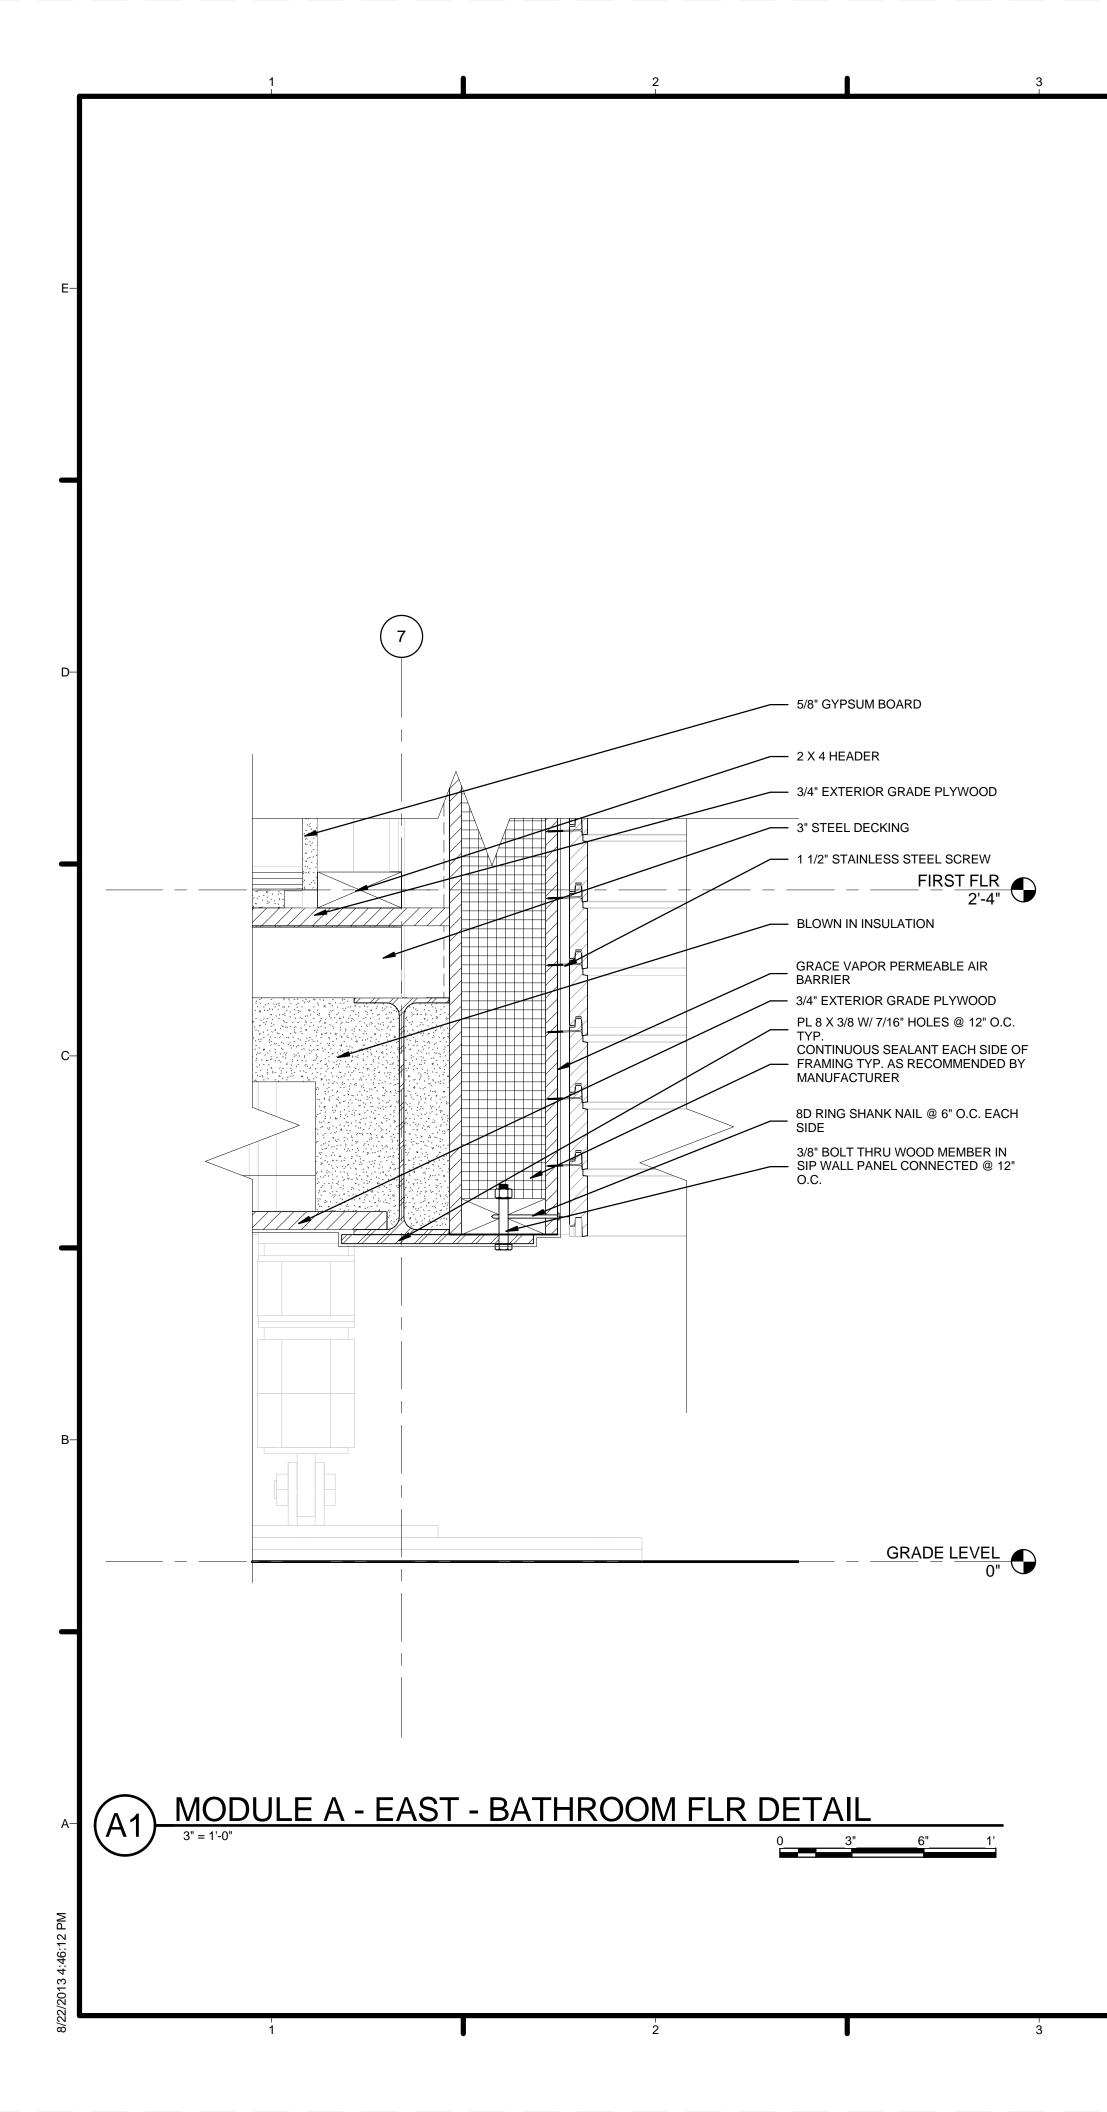
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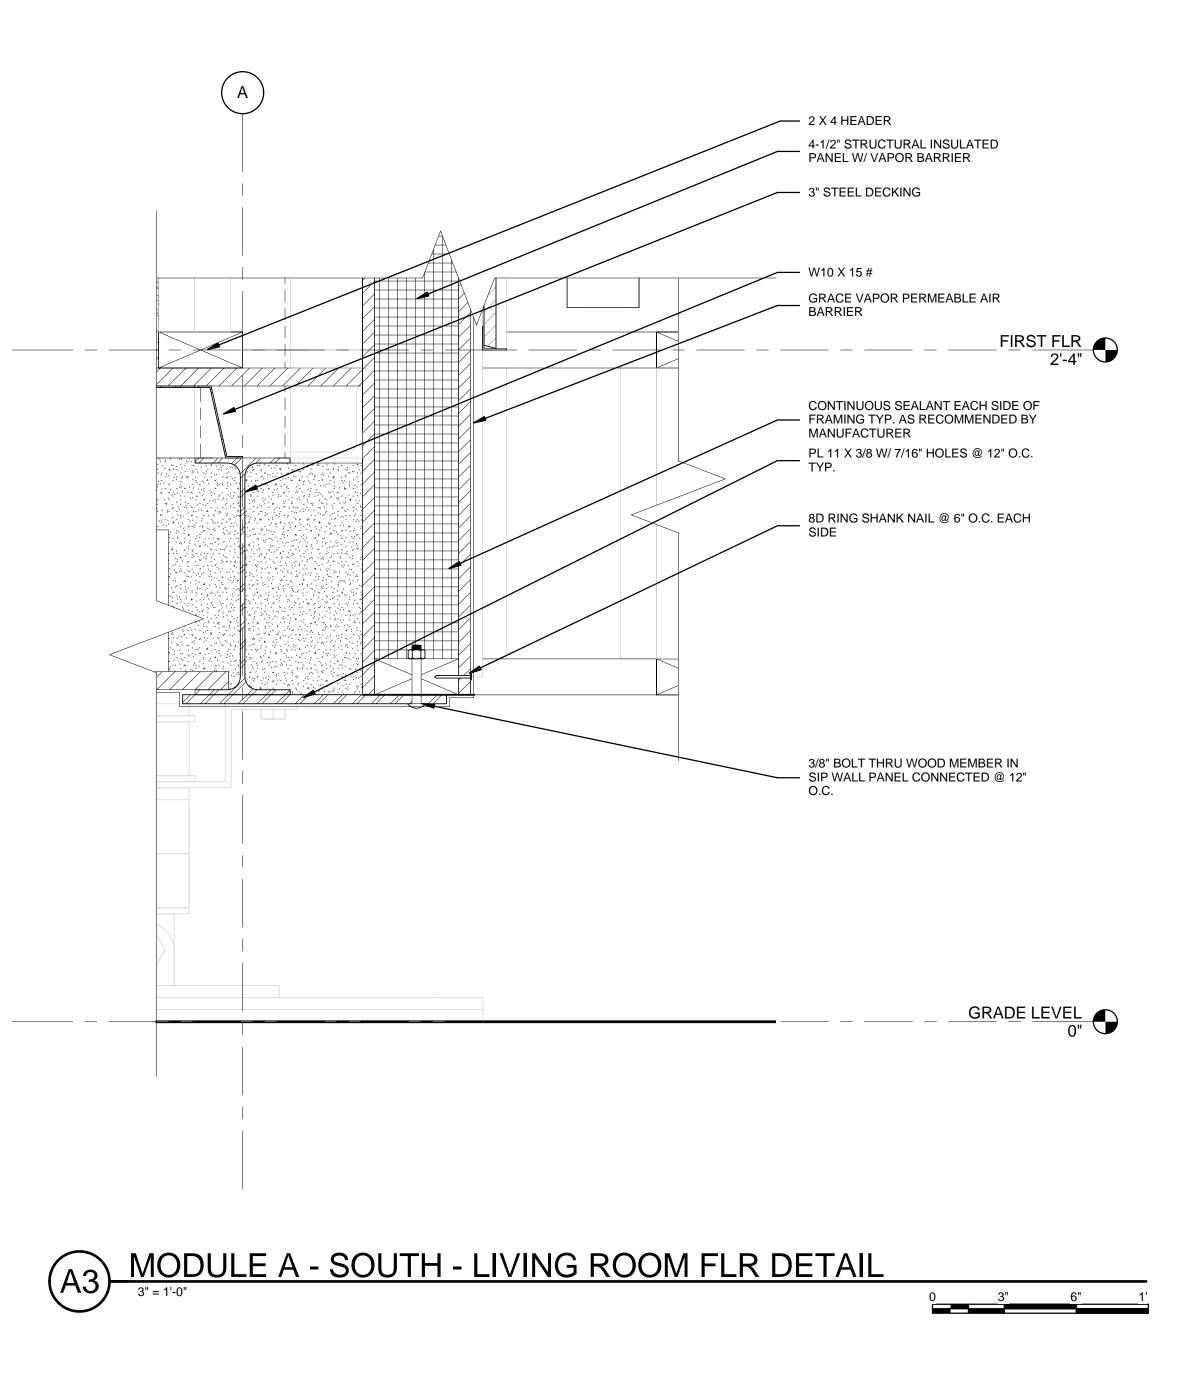
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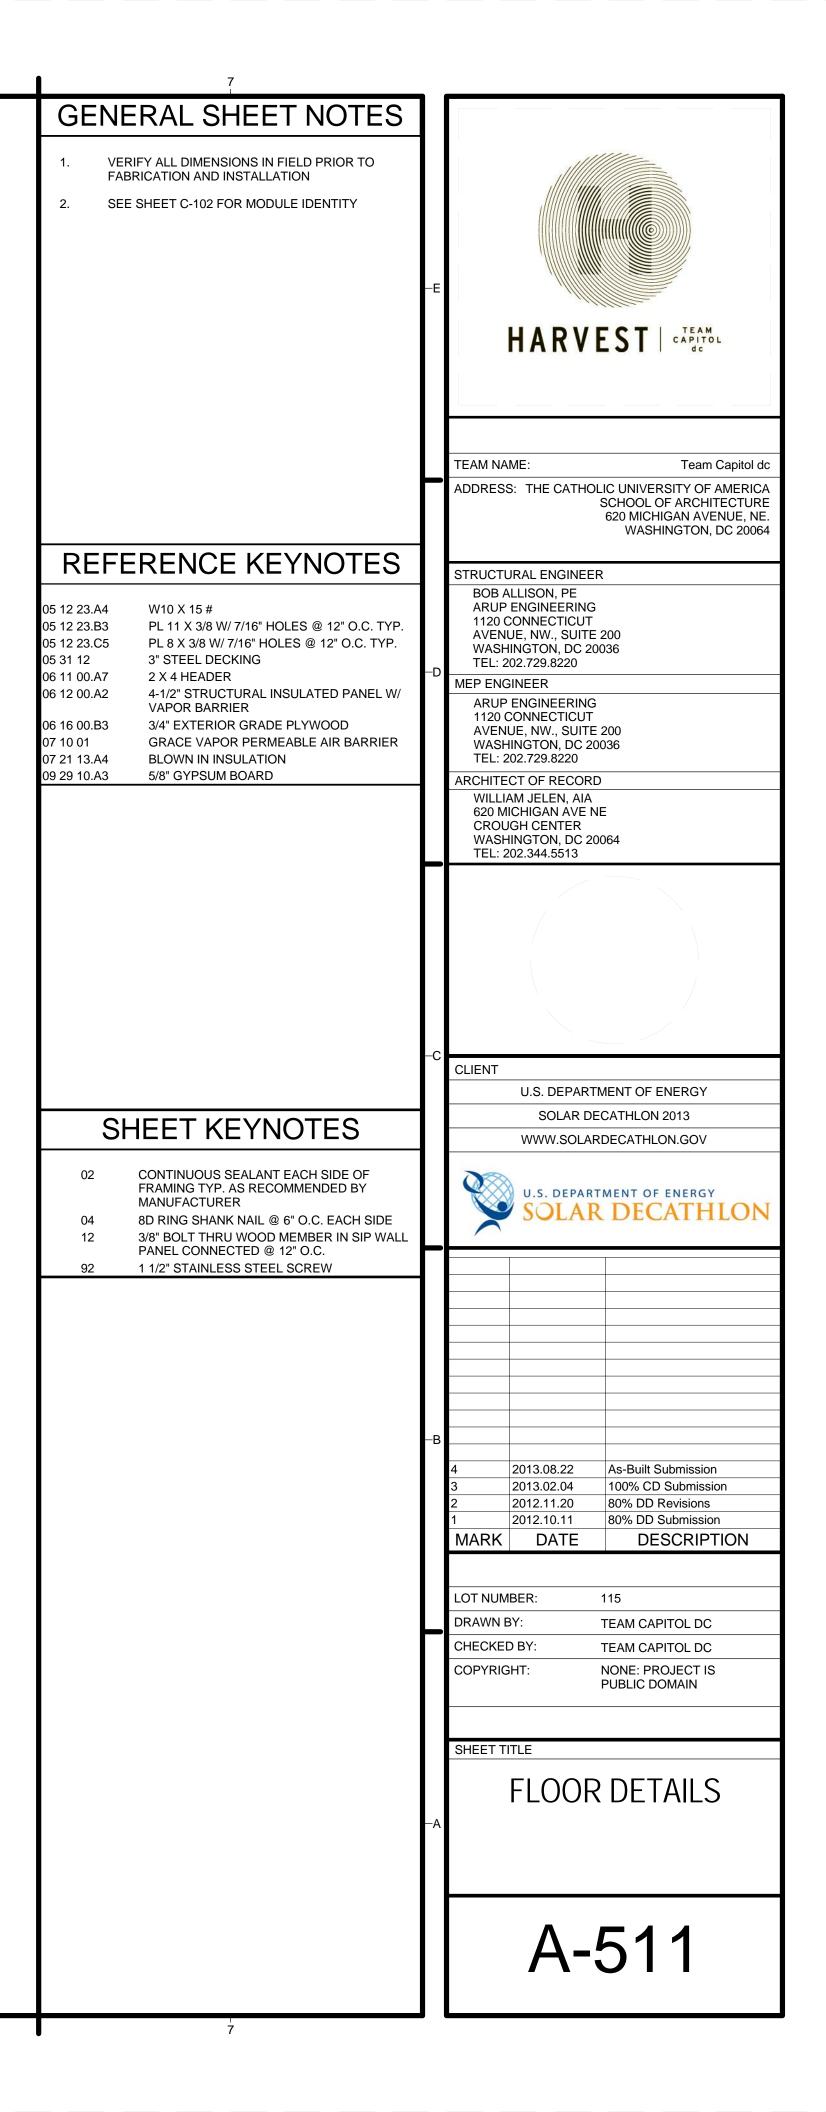
GENERAL SHEET NOTES	٦	
 VERIFY ALL DIMENSIONS IN FIELD PRIOR TO FABRICATION AND INSTALLATION SEE SHEET C-102 FOR MODULE IDENTITY 	E	HARVEST TEAM CAPITOL TEAM NAME: Team Capitol dc ADDRESS: THE CATHOLIC UNIVERSITY OF AMERICA SCHOOL OF ARCHITECTURE 620 MICHIGAN AVENUE, NE.
REFERENCE KEYNOTES		WASHINGTON, DC 20064
06 11 00.A3 [2] - 2 X 4 FRAMING @ 24" O.C. 06 11 00.A7 2 X 4 HEADER 09 29 10.A3 5/8" GYPSUM BOARD 09 30 13 FLORIDA TILES - 12X12 - OYSTER 09 64 29 3/4" RECLAIMED OAK WOOD FLOORING	D	MEP ENGINEER ARUP ENGINEERING 1120 CONNECTICUT AVENUE, NW., SUITE 200 WASHINGTON, DC 20036 TEL: 202.729.8220 ARCHITECT OF RECORD WILLIAM JELEN, AIA 620 MICHIGAN AVE NE
	c	CROUGH CENTER WASHINGTON, DC 20064 TEL: 202.344.5513
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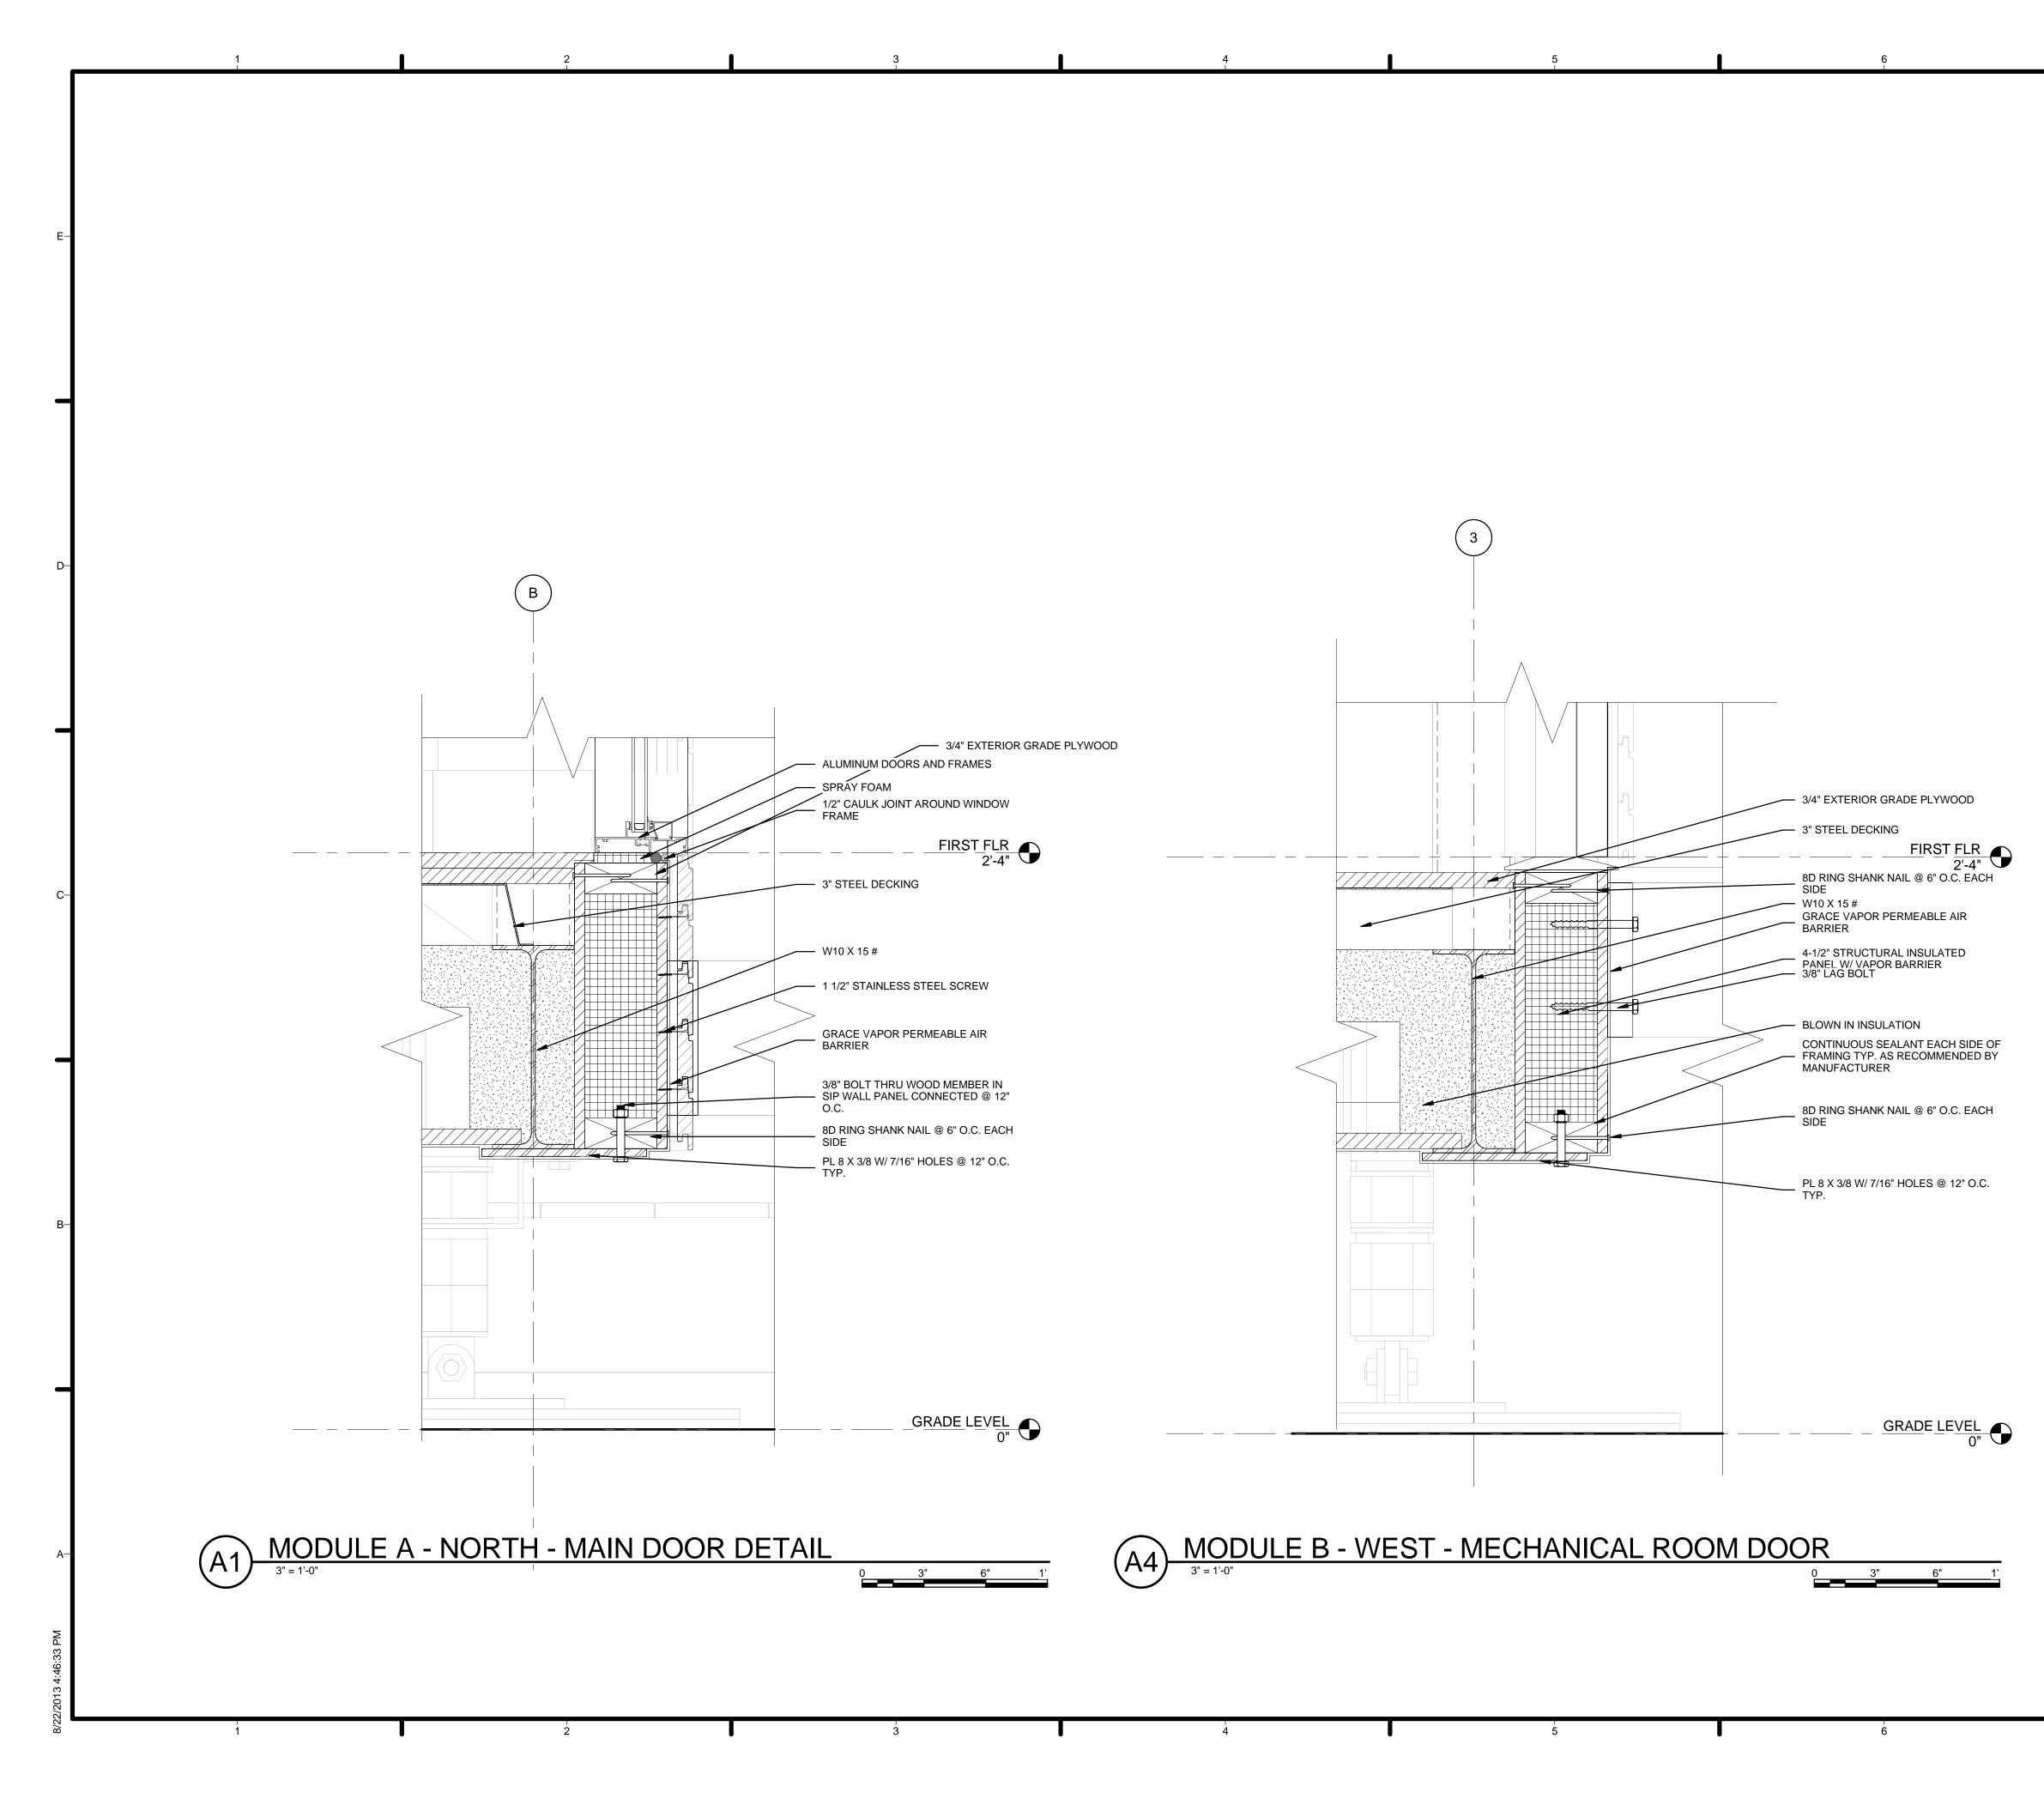


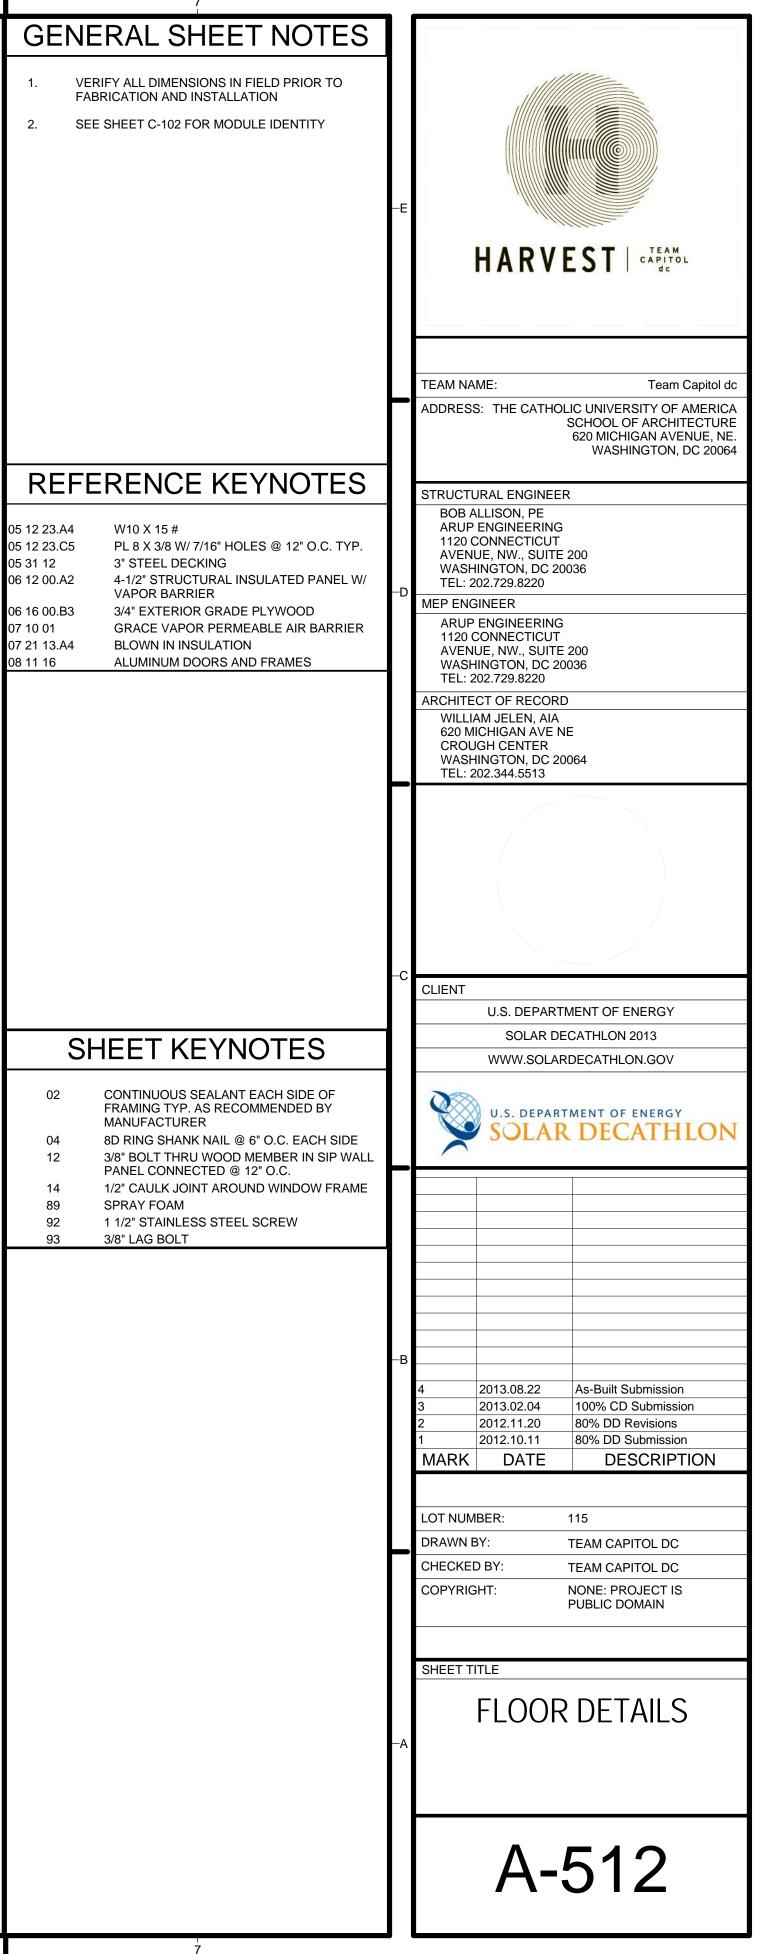
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REFERENCE KEYNOTES 05 12 23.A7 HSS 4 X 4 X 1/4 05 12 23.C1 PL 2-1/2 X 1/4 06 11 00.A3 [2] - 2 X 4 FRAMING @ 24" O.C. 06 11 00.A7 2 X 4 HEADER 06 12 00.A2 4-1/2" STRUCTURAL INSULATED PANEL W/ VAPOR BARRIER 06 16 00.B3 3/4" EXTERIOR GRADE PLYWOOD		STRUCTURAL ENGINEER BOB ALLISON, PE ARUP ENGINEERING 1120 CONNECTICUT AVENUE, NW., SUITE 200 WASHINGTON, DC 20036 TEL: 202.729.8220 MEP ENGINEER ARUP ENGINEERING 1120 CONNECTICUT AVENUE, NW., SUITE 200 WASHINGTON, DC 20036 TEL: 202.729.8220 ARCHITECT OF RECORD WILLIAM JELEN, AIA 620 MICHIGAN AVE NE CROUGH CENTER WASHINGTON, DC 20064 TEL: 202.445E42
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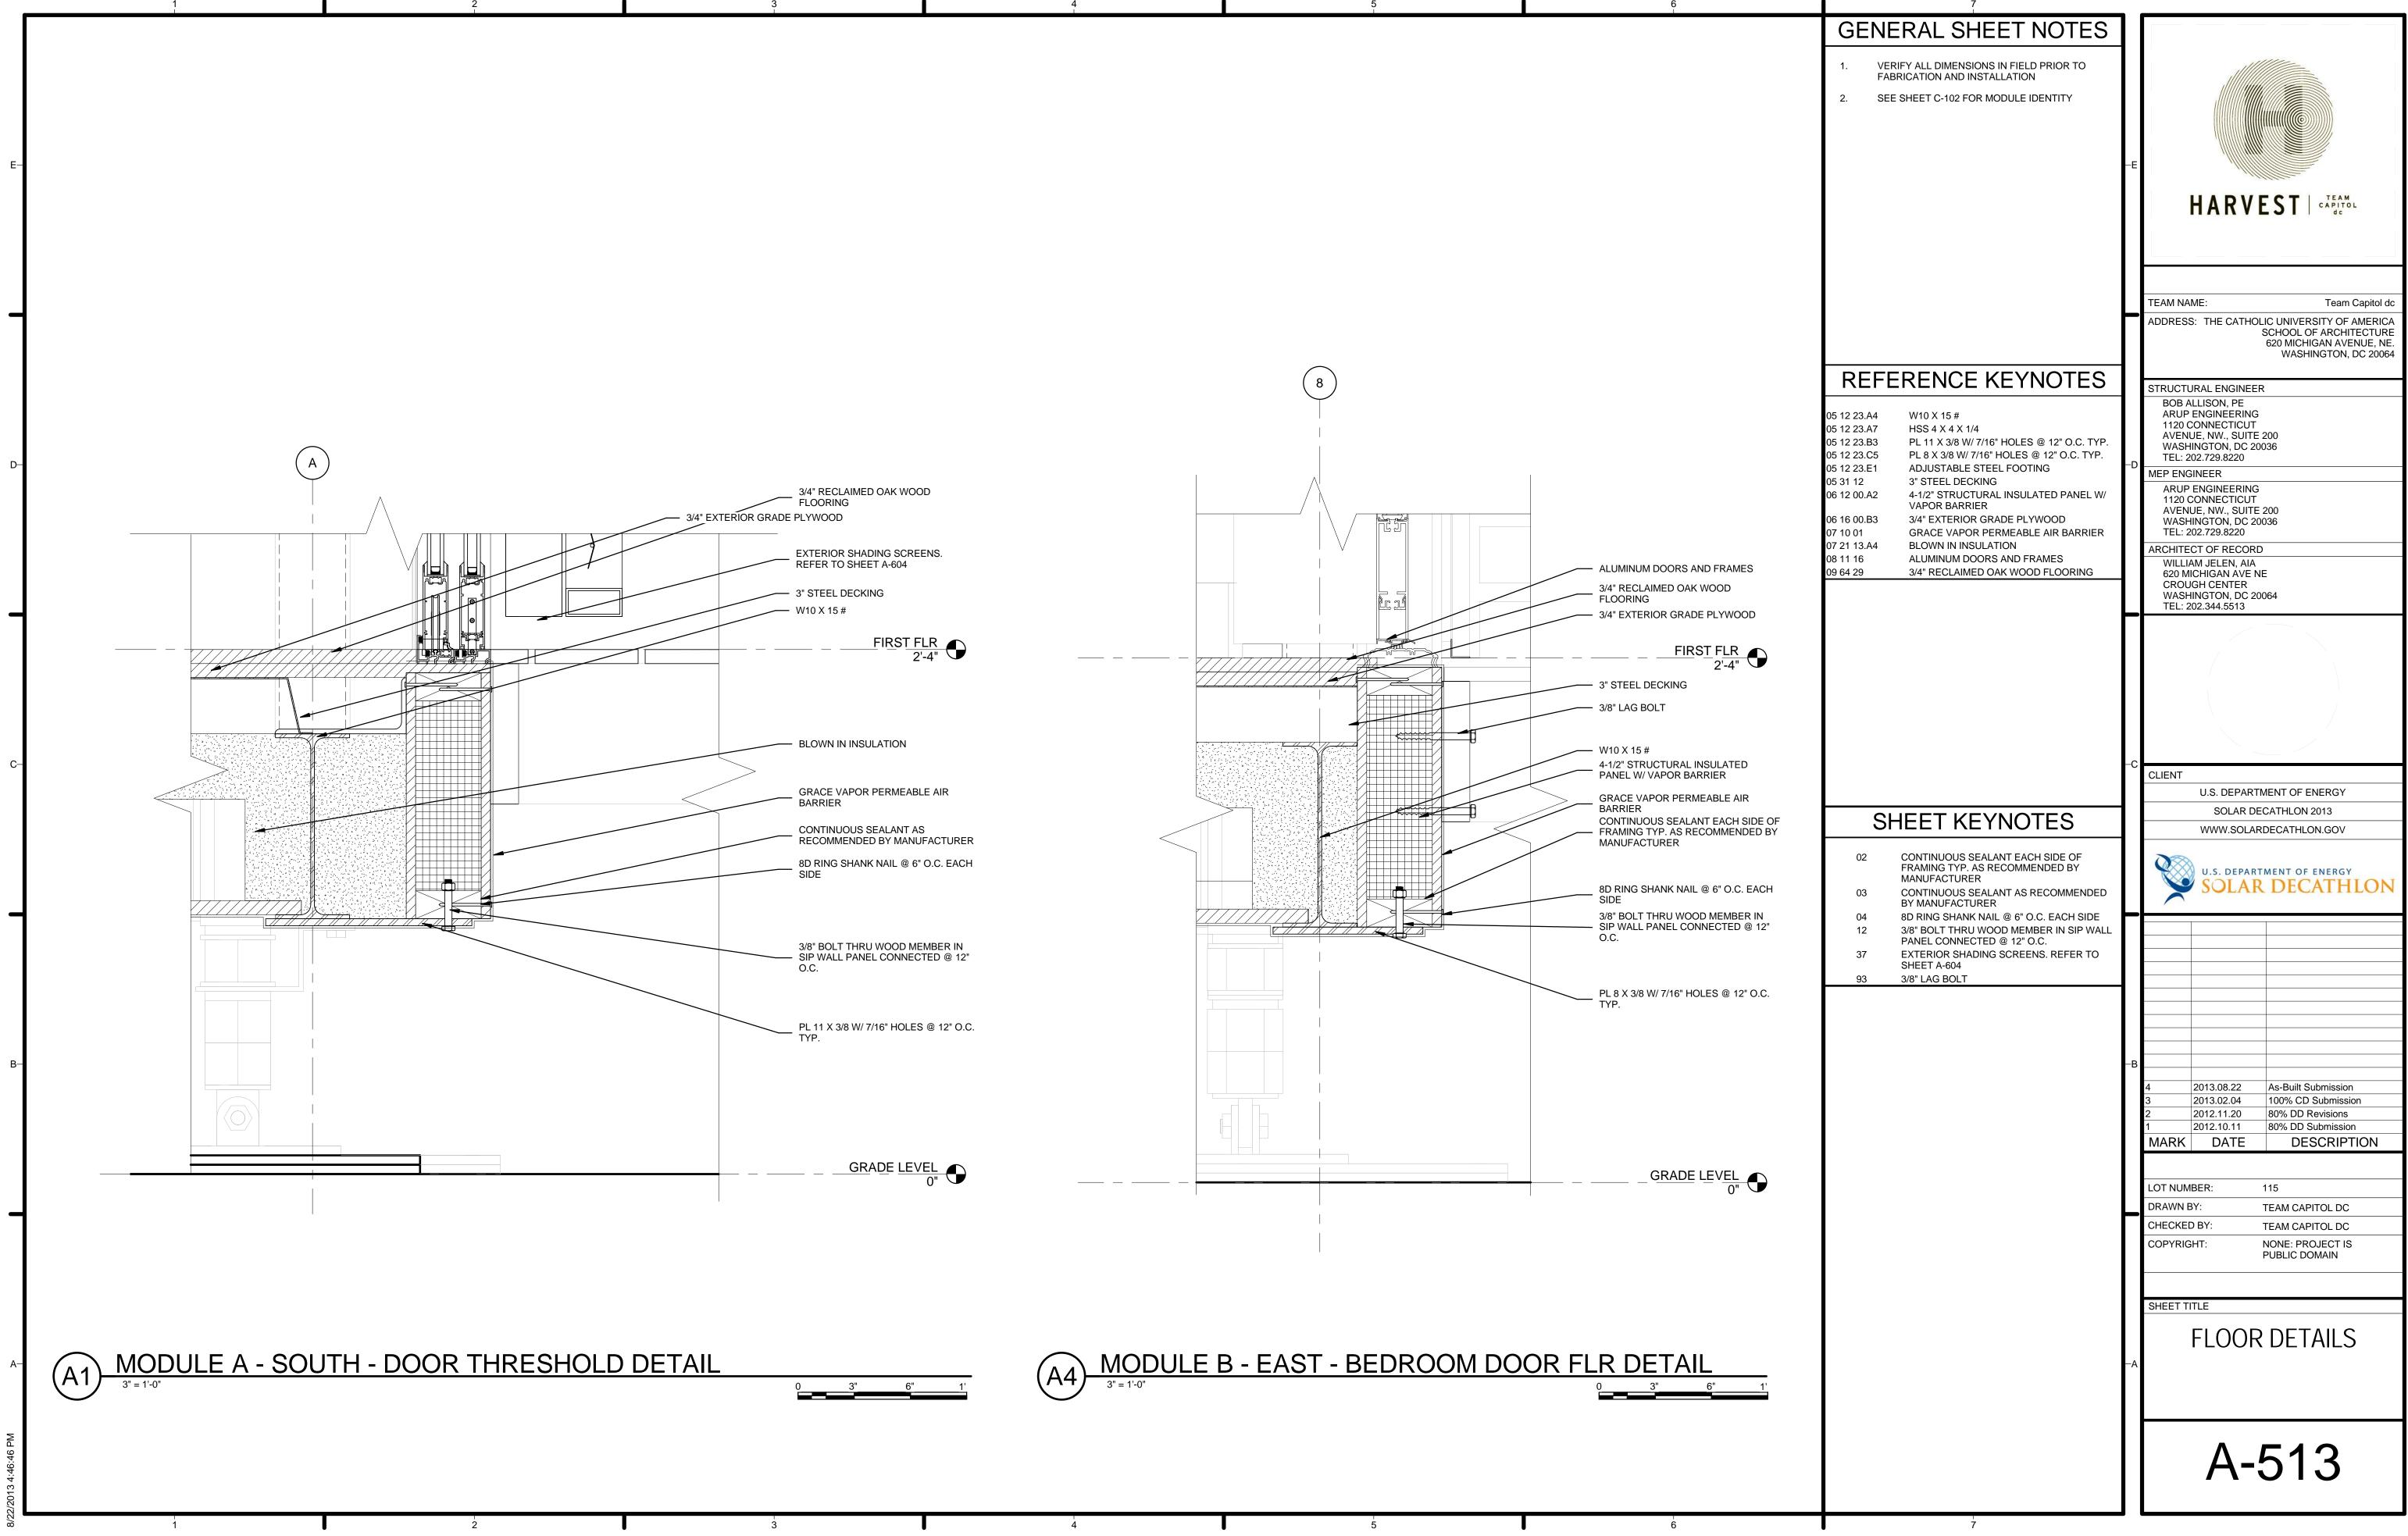


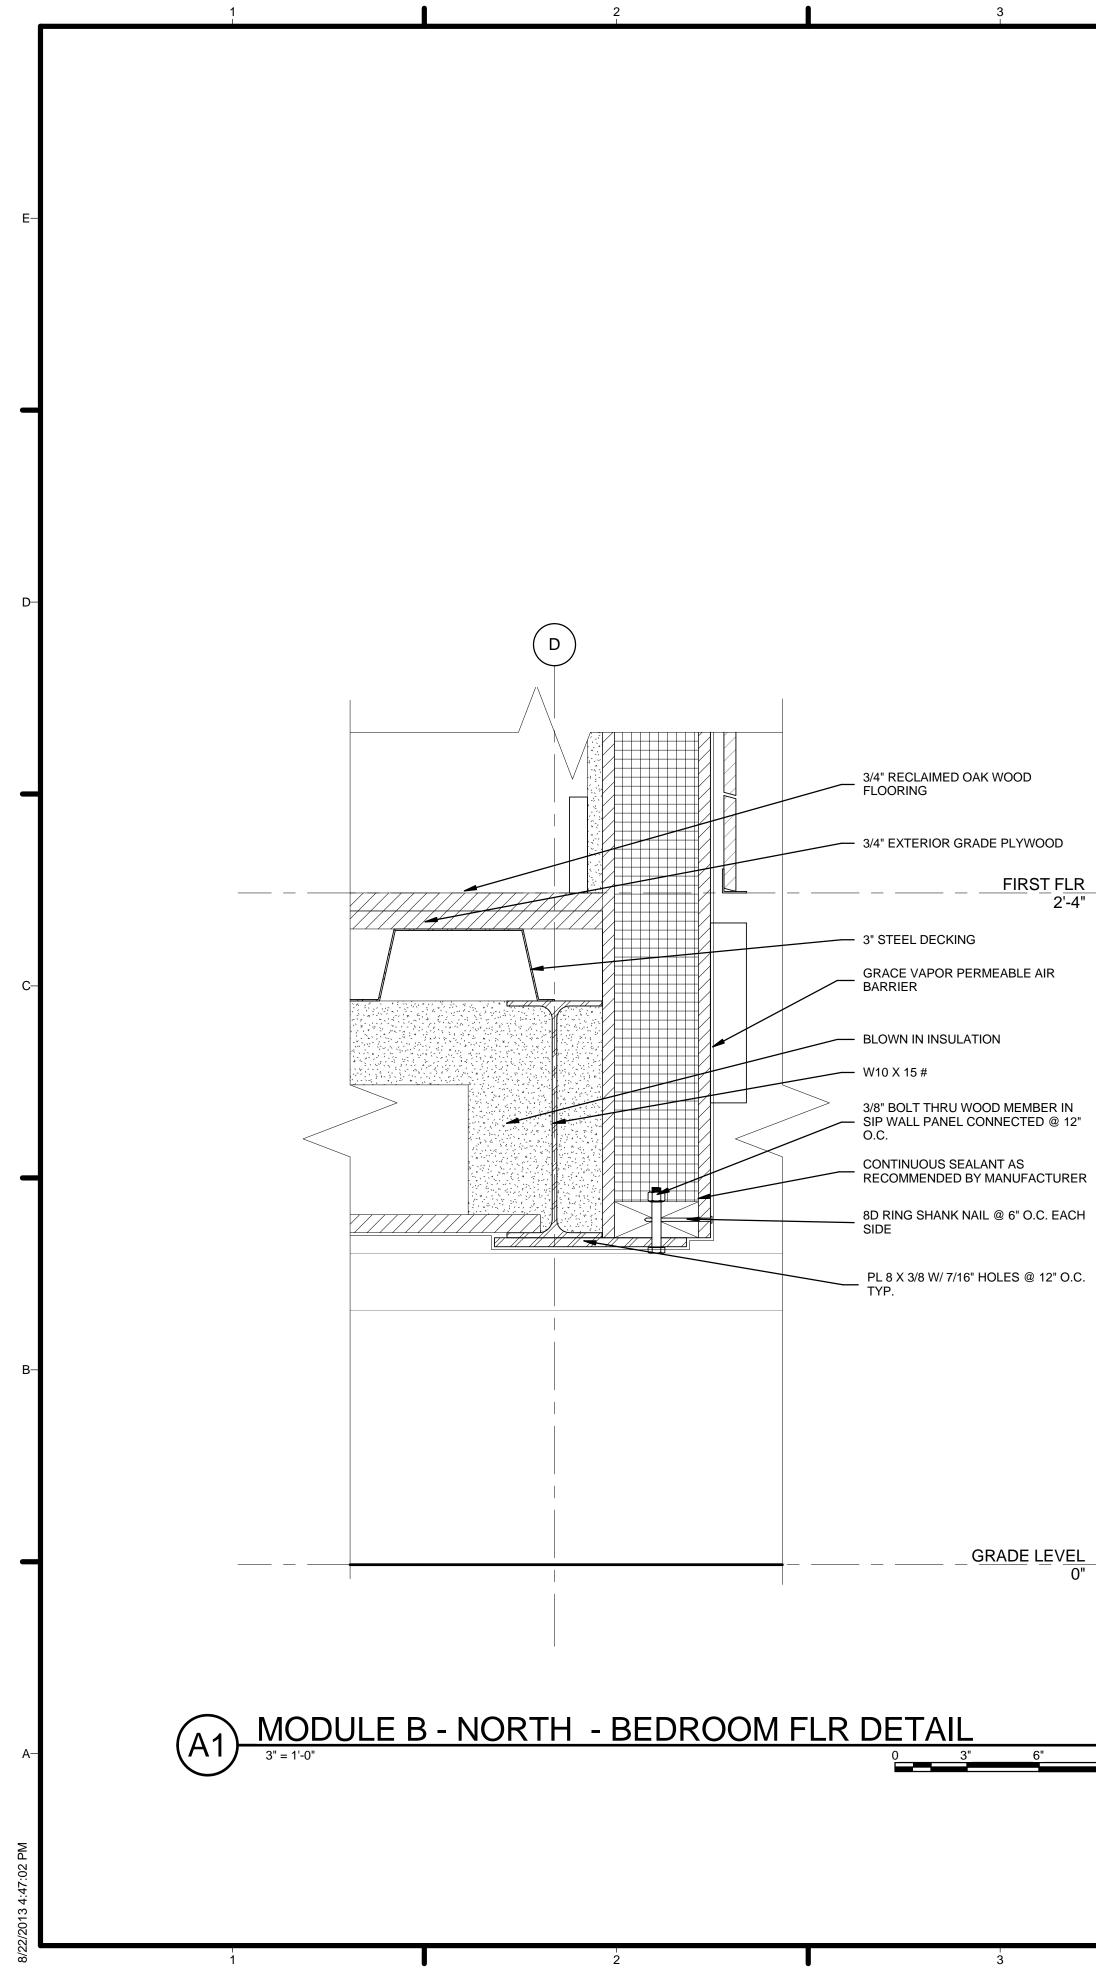




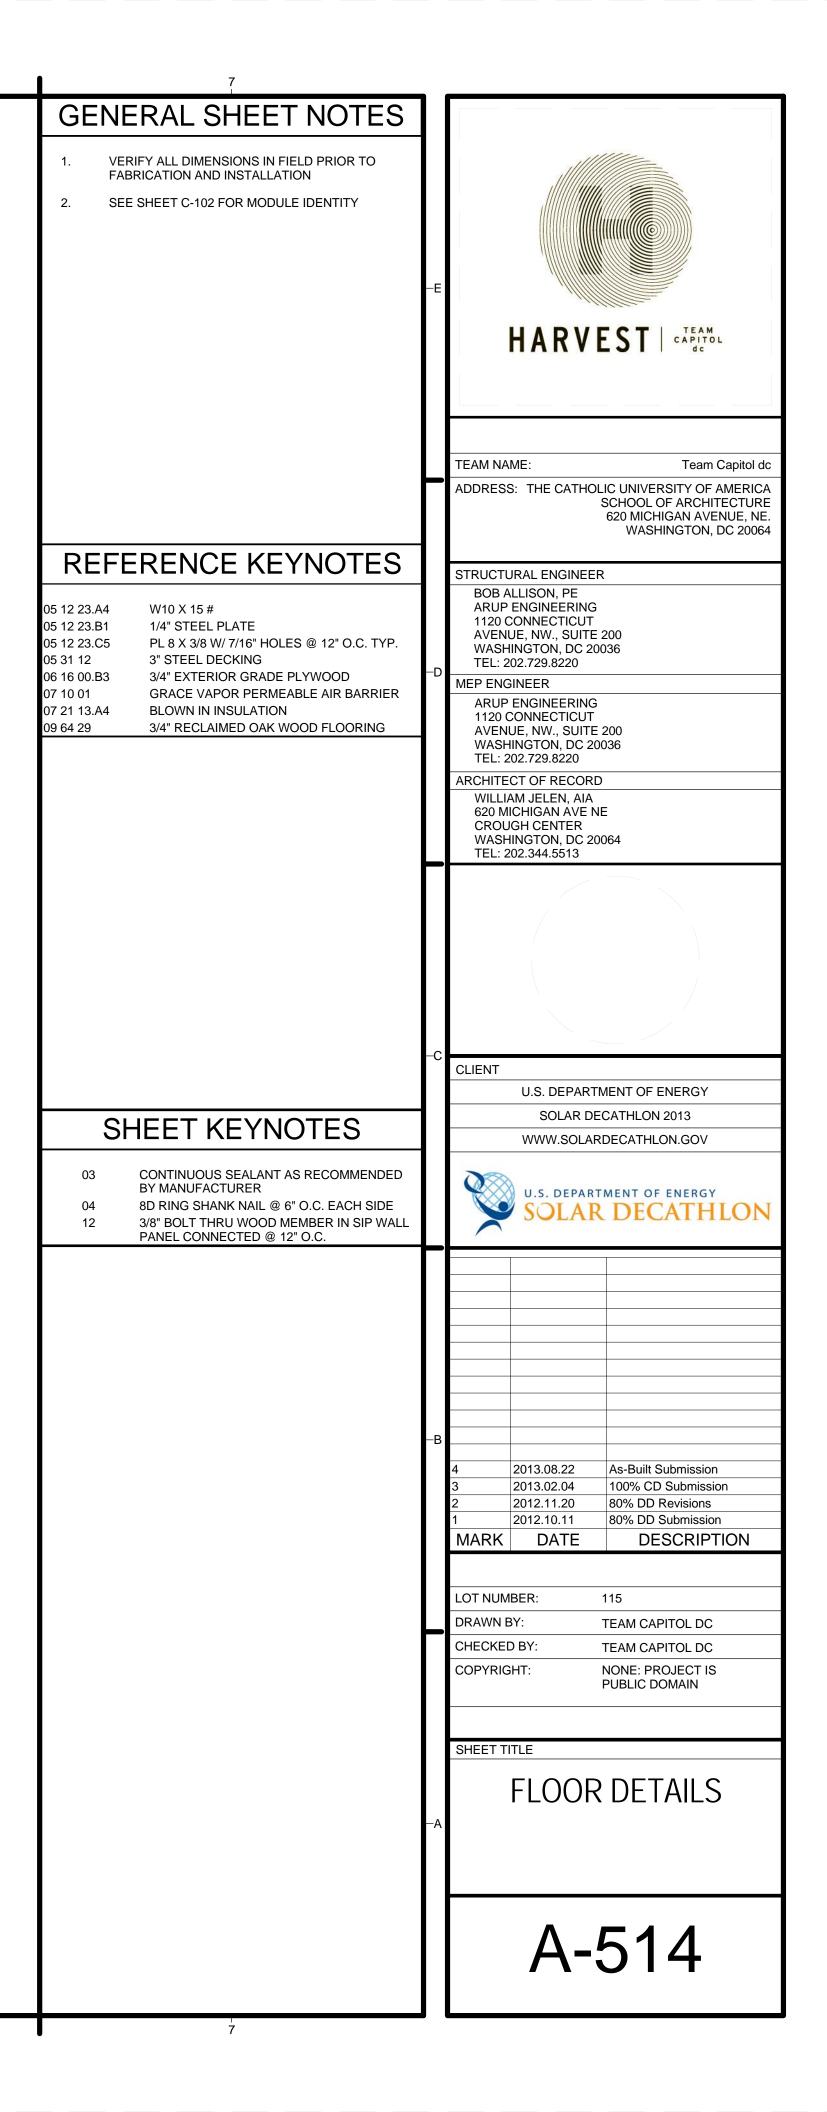


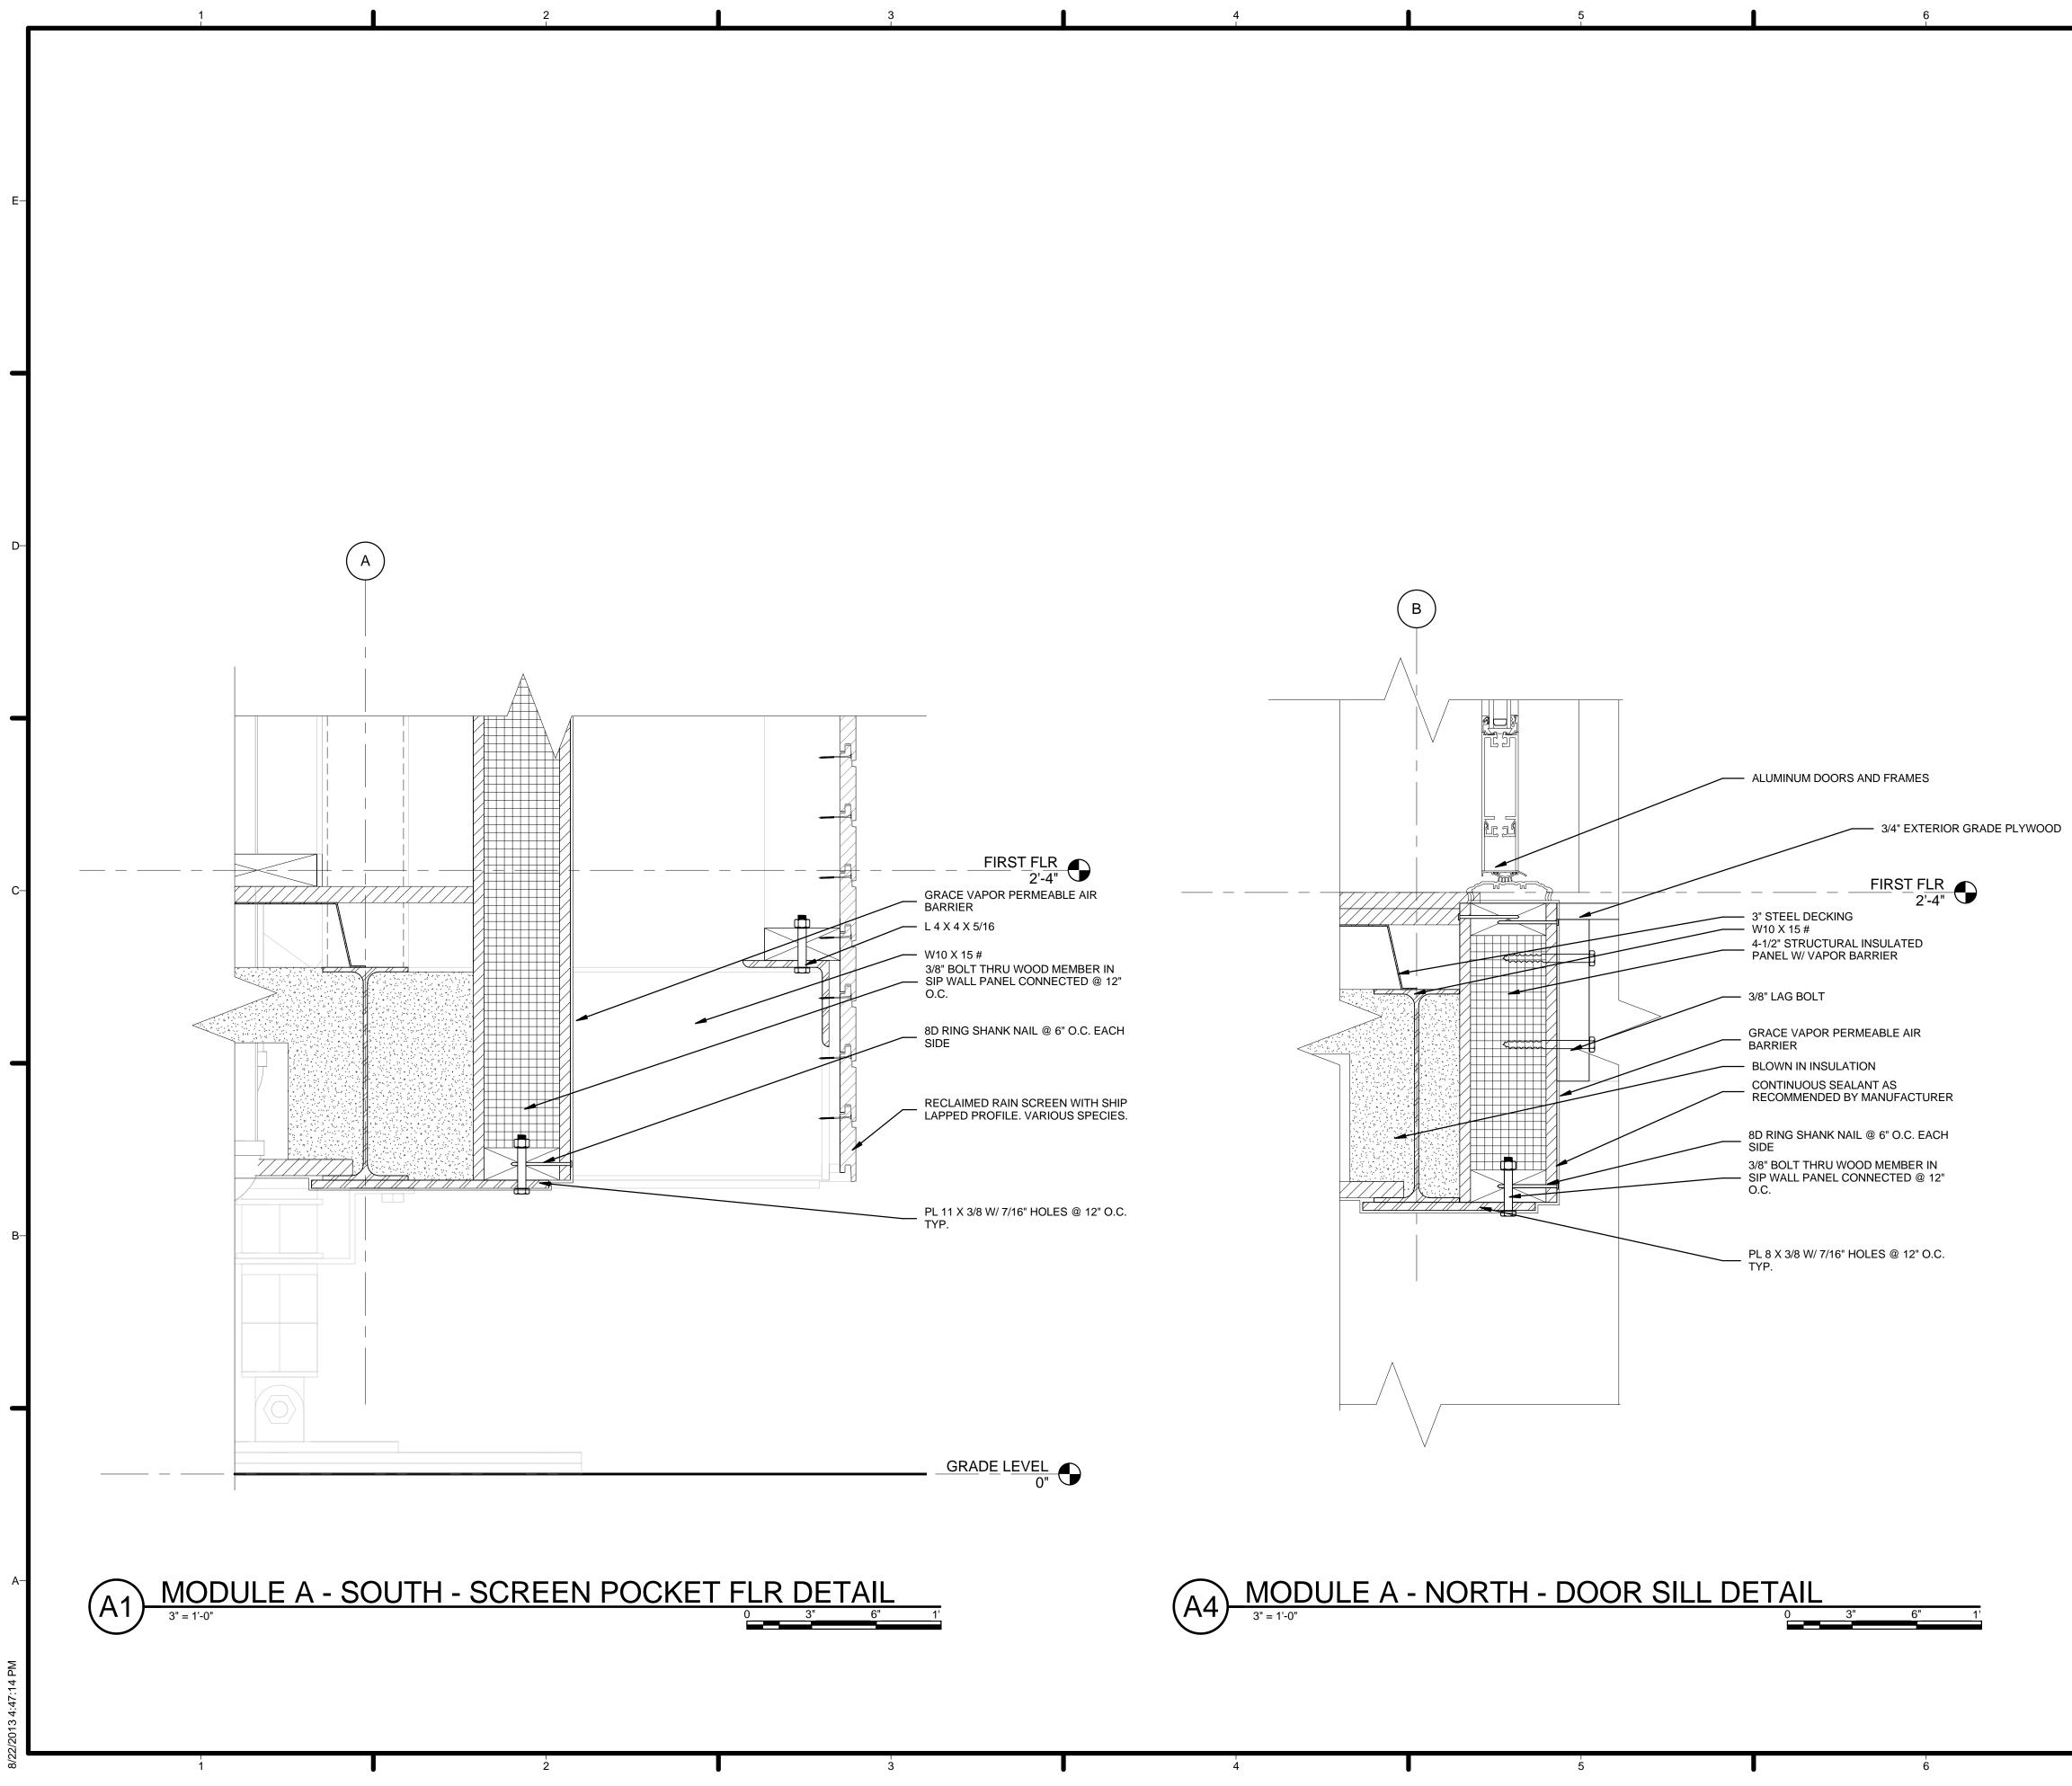




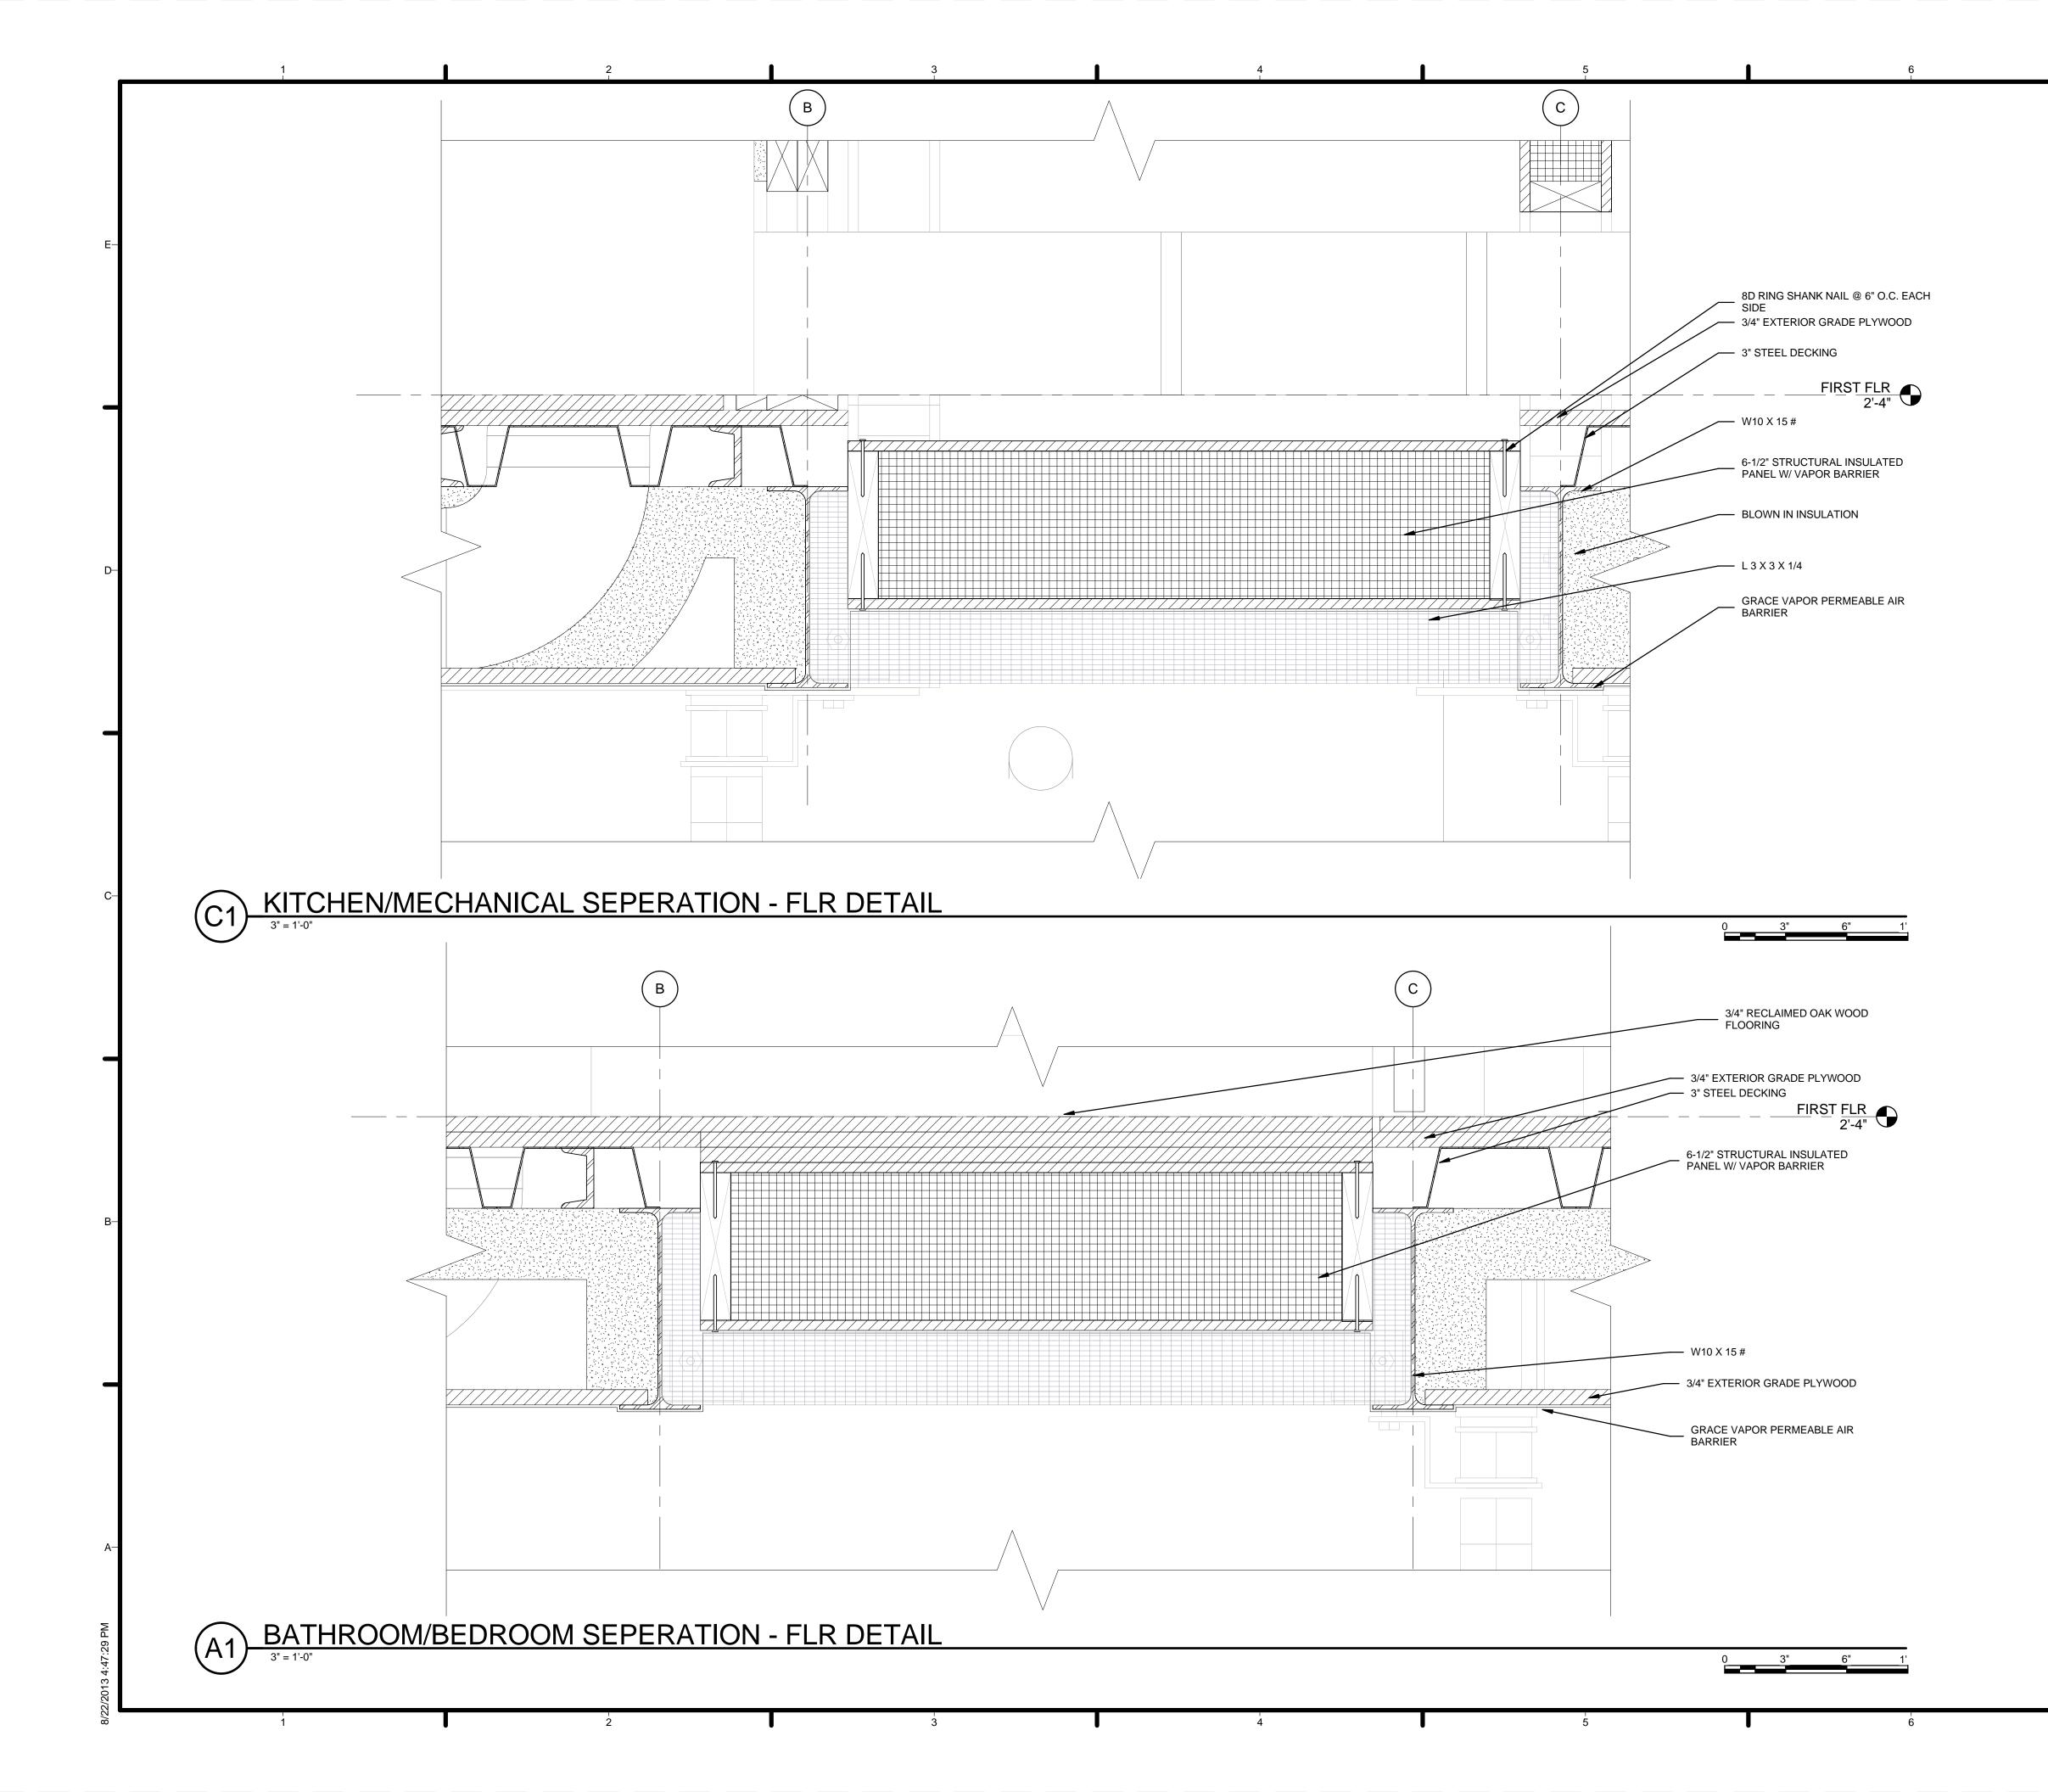


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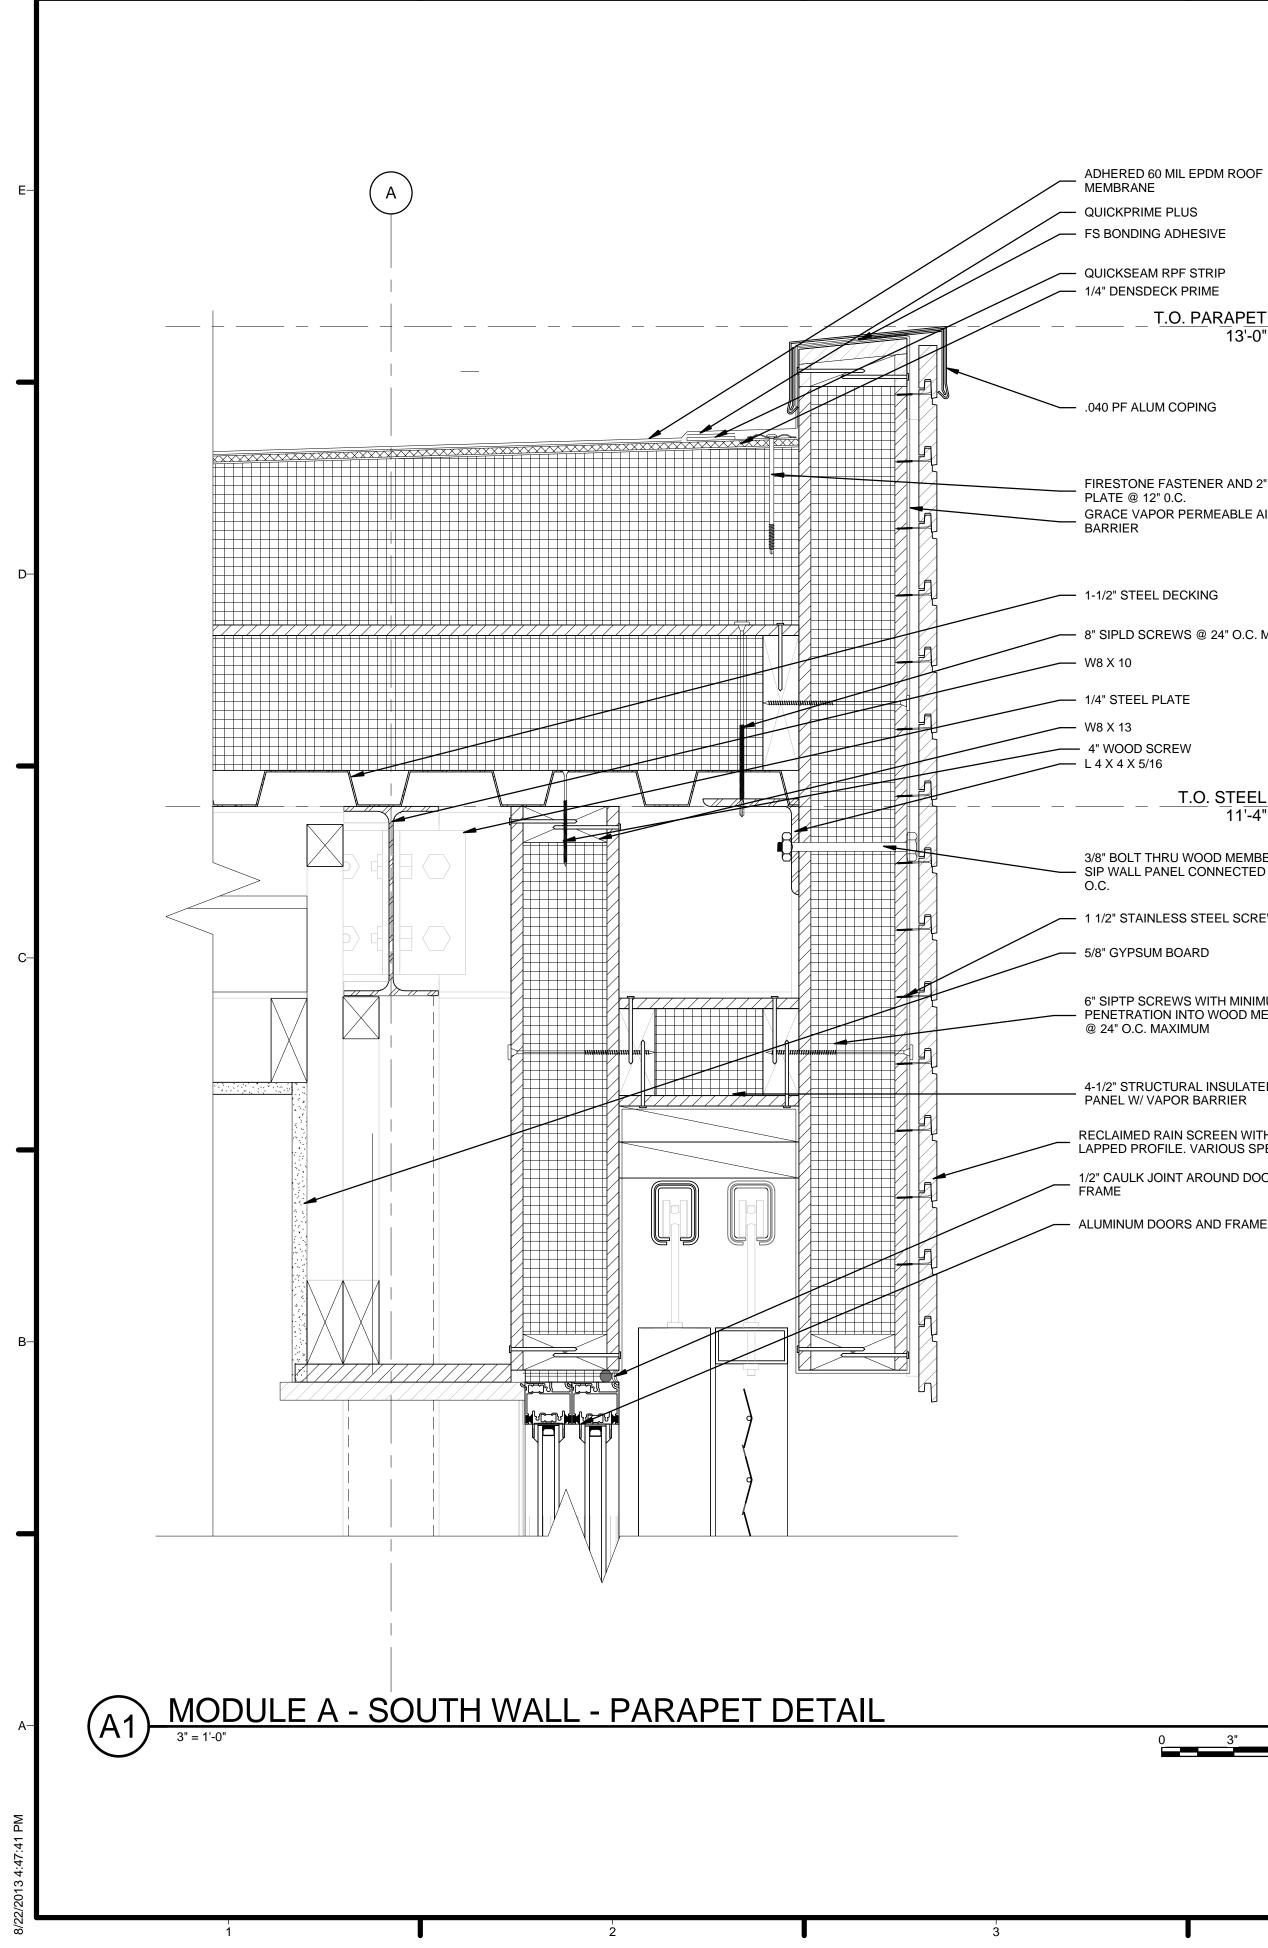




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GENERAL SHEET NOTES		
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	_	TEAM NAME: Team Capitol dc ADDRESS: THE CATHOLIC UNIVERSITY OF AMERICA SCHOOL OF ARCHITECTURE 620 MICHIGAN AVENUE, NE. WASHINGTON, DC 20064
REFERENCE KEYNOTES		STRUCTURAL ENGINEER
05 12 23.A4 W10 X 15 # 05 12 23.B3 PL 11 X 3/8 W/ 7/16" HOLES @ 12" O.C. TYP. 05 12 23.C2 L 4 X 4 X 5/16 05 12 23.C5 PL 8 X 3/8 W/ 7/16" HOLES @ 12" O.C. TYP. 05 12 23.E1 ADJUSTABLE STEEL FOOTING 05 31 12 3" STEEL DECKING 06 12 00.A2 4-1/2" STRUCTURAL INSULATED PANEL W/ VAPOR BARRIER 06 16 00.B3 3/4" EXTERIOR GRADE PLYWOOD 07 10 01 GRACE VAPOR PERMEABLE AIR BARRIER 07 21 13.A4 BLOWN IN INSULATION	—D	BOB ALLISON, PE ARUP ENGINEERING 1120 CONNECTICUT AVENUE, NW., SUITE 200 WASHINGTON, DC 20036 TEL: 202.729.8220 MEP ENGINEER ARUP ENGINEERING 1120 CONNECTICUT AVENUE, NW., SUITE 200 WASHINGTON, DC 20036 TEL: 202.729.8220
07 21 13.A4 BLOWN IN INSULATION 08 11 16 ALUMINUM DOORS AND FRAMES		ARCHITECT OF RECORD WILLIAM JELEN, AIA 620 MICHIGAN AVE NE CROUGH CENTER WASHINGTON, DC 20064 TEL: 202.344.5513
SHEET KEYNOTES	-c	CLIENT U.S. DEPARTMENT OF ENERGY SOLAR DECATHLON 2013 WWW.SOLARDECATHLON.GOV
 03 CONTINUOUS SEALANT AS RECOMMENDED BY MANUFACTURER 04 8D RING SHANK NAIL @ 6" O.C. EACH SIDE 12 3/8" BOLT THRU WOOD MEMBER IN SIP WALL PANEL CONNECTED @ 12" O.C. 93 3/8" LAG BOLT 94 DECLAMED DAIN SOREEN WITH SURPLANDED 		U.S. DEPARTMENT OF ENERGY SOLAR DECATHLON
94 RECLAIMED RAIN SCREEN WITH SHIP LAPPED PROFILE. VARIOUS SPECIES.		Image: Constraint of the second sec
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GENERAL SHEET NOTES]	
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		TEAM NAME: Team Capitol dc ADDRESS: THE CATHOLIC UNIVERSITY OF AMERICA SCHOOL OF ARCHITECTURE 620 MICHIGAN AVENUE, NE. WASHINGTON, DC 20064
REFERENCE KEYNOTES 05 12 23.A4 W10 X 15 # 05 12 23.B1 1/4" STEEL PLATE 05 12 23.C1 PL 2-1/2 X 1/4 05 12 23.C5 PL 8 X 3/8 W/ 7/16" HOLES @ 12" O.C. TYP. 05 12 23.C7 L 3 X 3 X 1/4	-D	STRUCTURAL ENGINEER BOB ALLISON, PE ARUP ENGINEERING 1120 CONNECTICUT AVENUE, NW., SUITE 200 WASHINGTON, DC 20036 TEL: 202.729.8220 MEP ENGINEER
05 31 12 3" STEEL DECKING 06 11 00.A7 2 X 4 HEADER 06 11 00.B1 2 X 6 STUD 06 11 00.B6 2 X 6 06 12 00.A3 6-1/2" STRUCTURAL INSULATED PANEL W/ VAPOR BARRIER 06 16 00.B3 3/4" EXTERIOR GRADE PLYWOOD 07 10 01 GRACE VAPOR PERMEABLE AIR BARRIER 07 21 13.A4 BLOWN IN INSULATION		ARUP ENGINEERING 1120 CONNECTICUT AVENUE, NW., SUITE 200 WASHINGTON, DC 20036 TEL: 202.729.8220 ARCHITECT OF RECORD WILLIAM JELEN, AIA 620 MICHIGAN AVE NE CROUGH CENTER
09 29 10.A3 5/8" GYPSUM BOARD 09 30 13 FLORIDA TILES - 12X12 - OYSTER 09 64 29 3/4" RECLAIMED OAK WOOD FLOORING		WASHINGTON, DC 20064 TEL: 202.344.5513
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O4 8D RING SHANK NAIL @ 6" O.C. EACH SIDE	-	SOLAR DECATHLON 2013 WWW.SOLARDECATHLON.GOV
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- QUICKPRIME PLUS FS BONDING ADHESIVE

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QUICKSEAM RPF STRIP

_____ _ <u>T.O. PARAPET</u> 13'-0"

- .040 PF ALUM COPING

FIRESTONE FASTENER AND 2" METAL PLATE @ 12" 0.C. GRACE VAPOR PERMEABLE AIR BARRIER

----- 1-1/2" STEEL DECKING

8" SIPLD SCREWS @ 24" O.C. MINIMUM

----- 1/4" STEEL PLATE

- 4" WOOD SCREW



3/8" BOLT THRU WOOD MEMBER IN - SIP WALL PANEL CONNECTED @ 12" O.C.

- 1 1/2" STAINLESS STEEL SCREW

— 5/8" GYPSUM BOARD

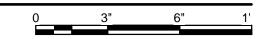
6" SIPTP SCREWS WITH MINIMUM 1" - PENETRATION INTO WOOD MEMBER @ 24" O.C. MAXIMUM

4-1/2" STRUCTURAL INSULATED PANEL W/ VAPOR BARRIER

RECLAIMED RAIN SCREEN WITH SHIP LAPPED PROFILE. VARIOUS SPECIES.

1/2" CAULK JOINT AROUND DOOR

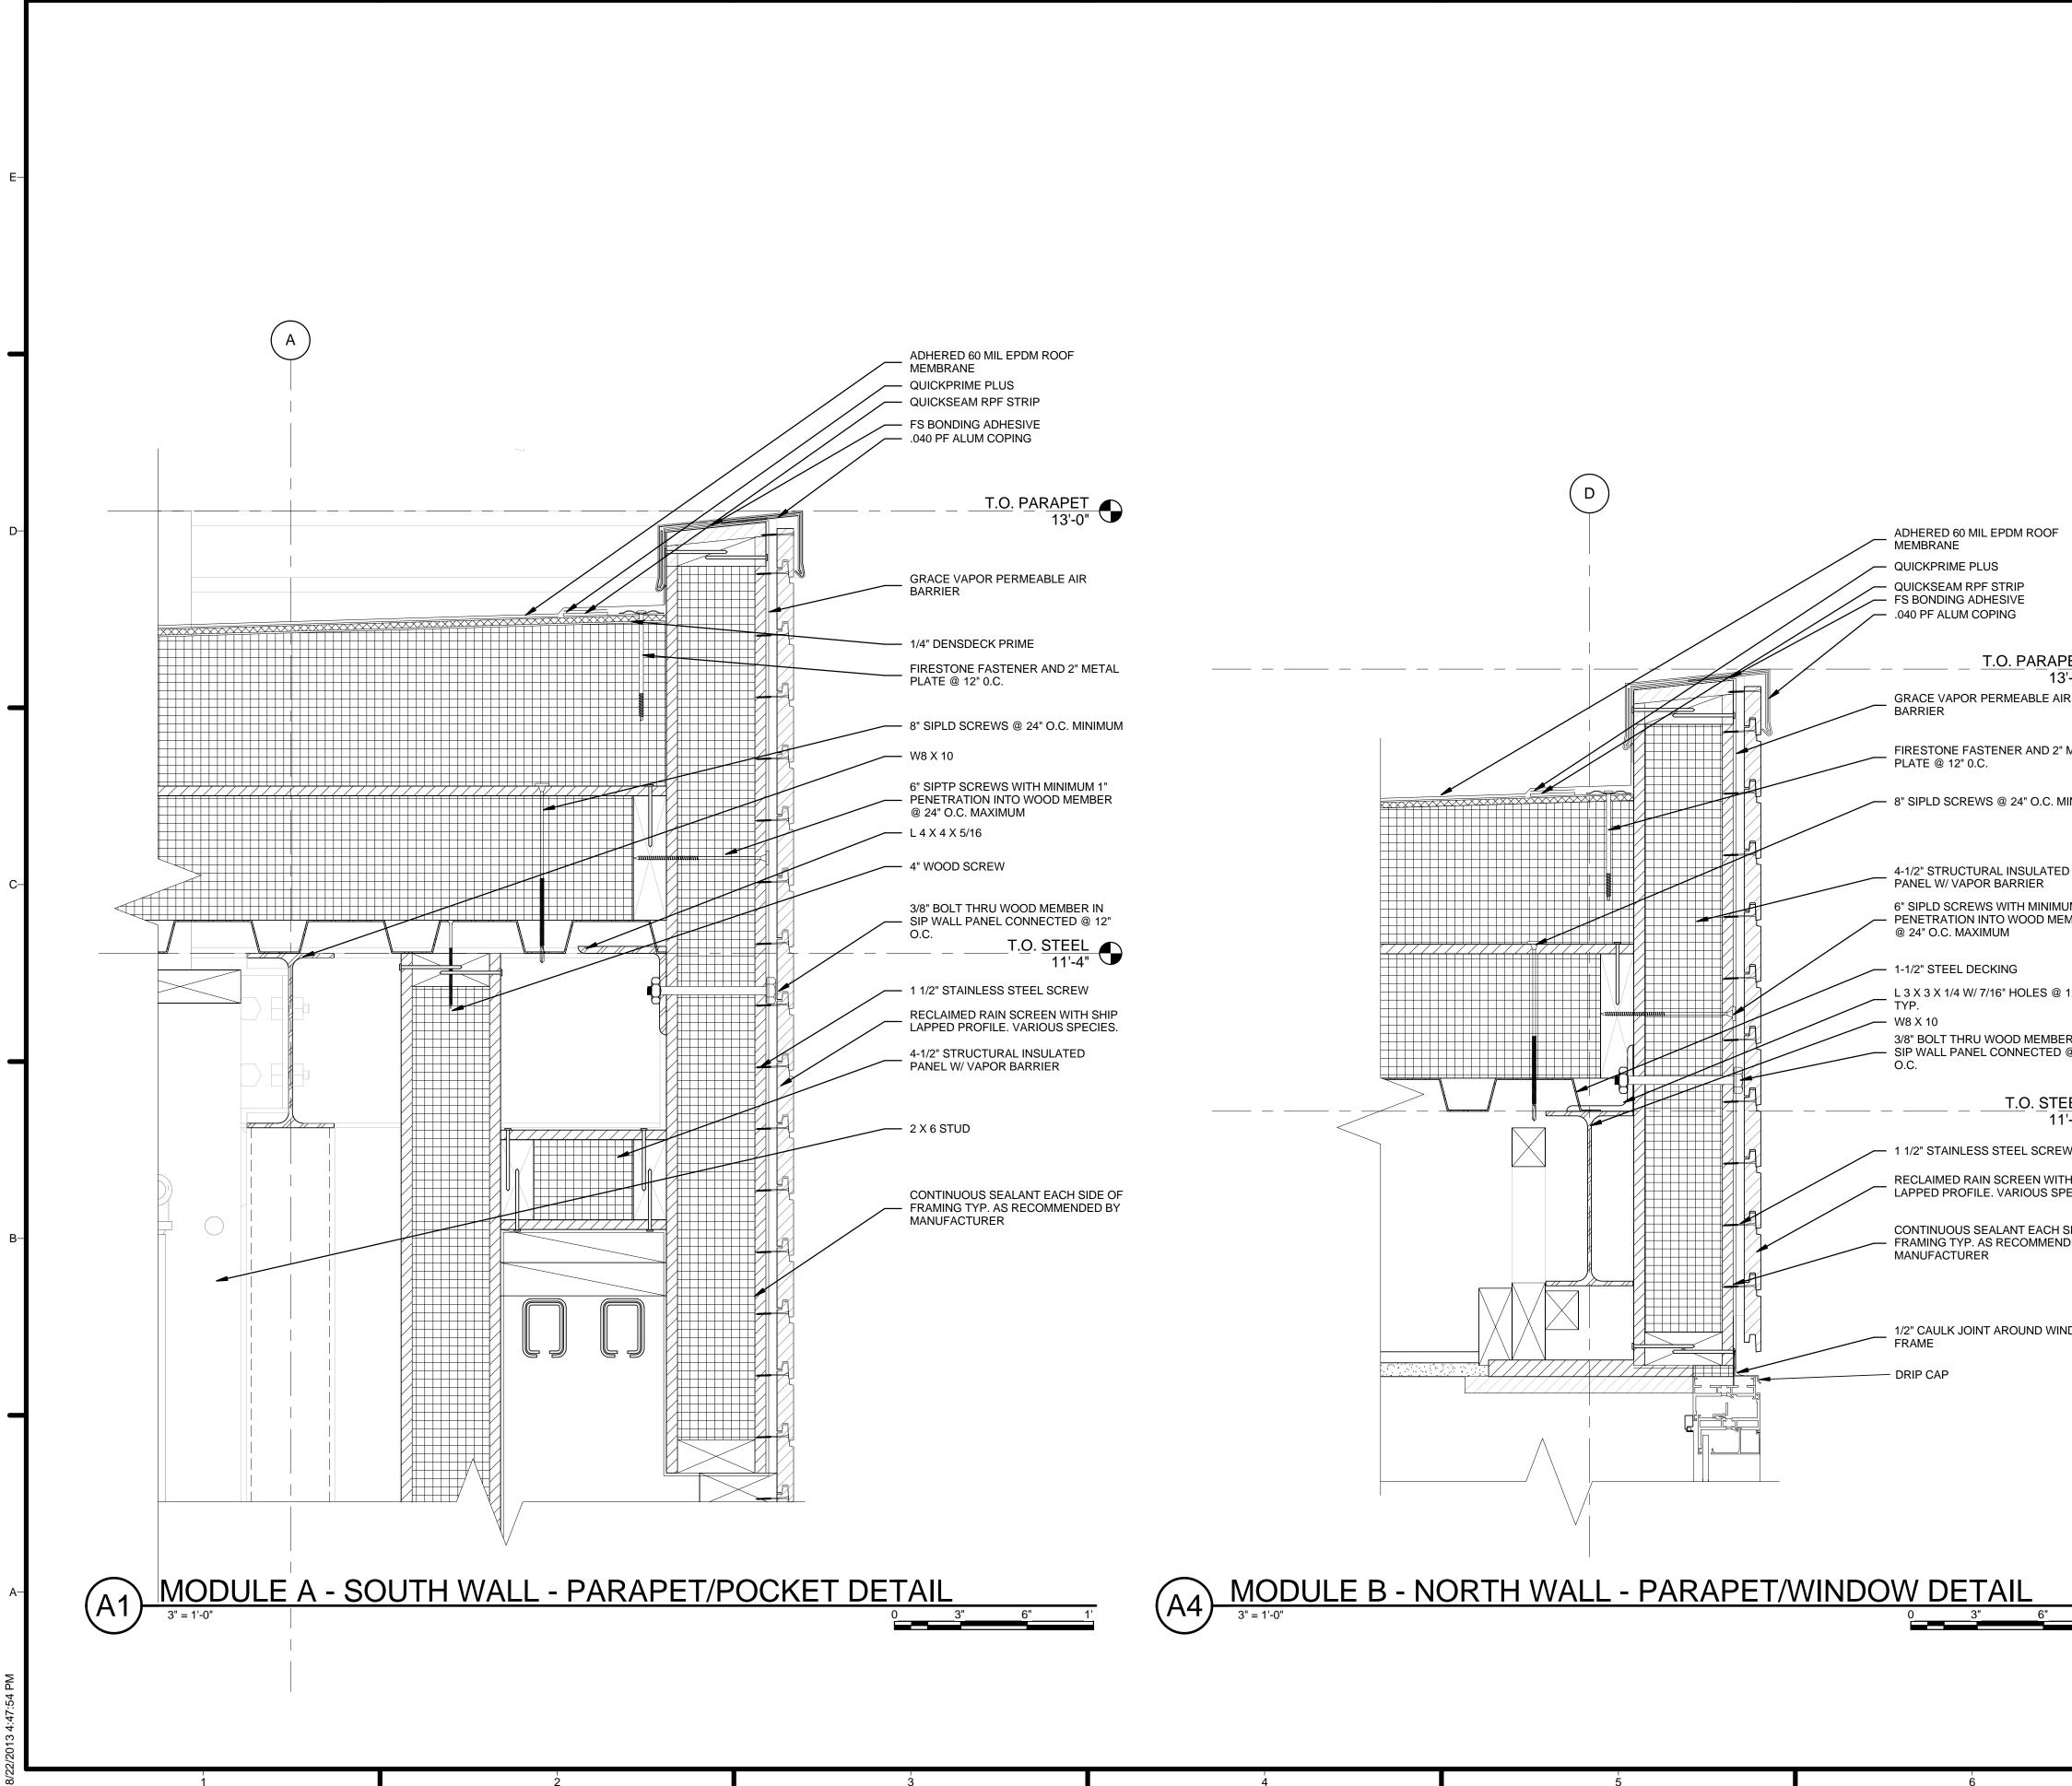
— ALUMINUM DOORS AND FRAMES



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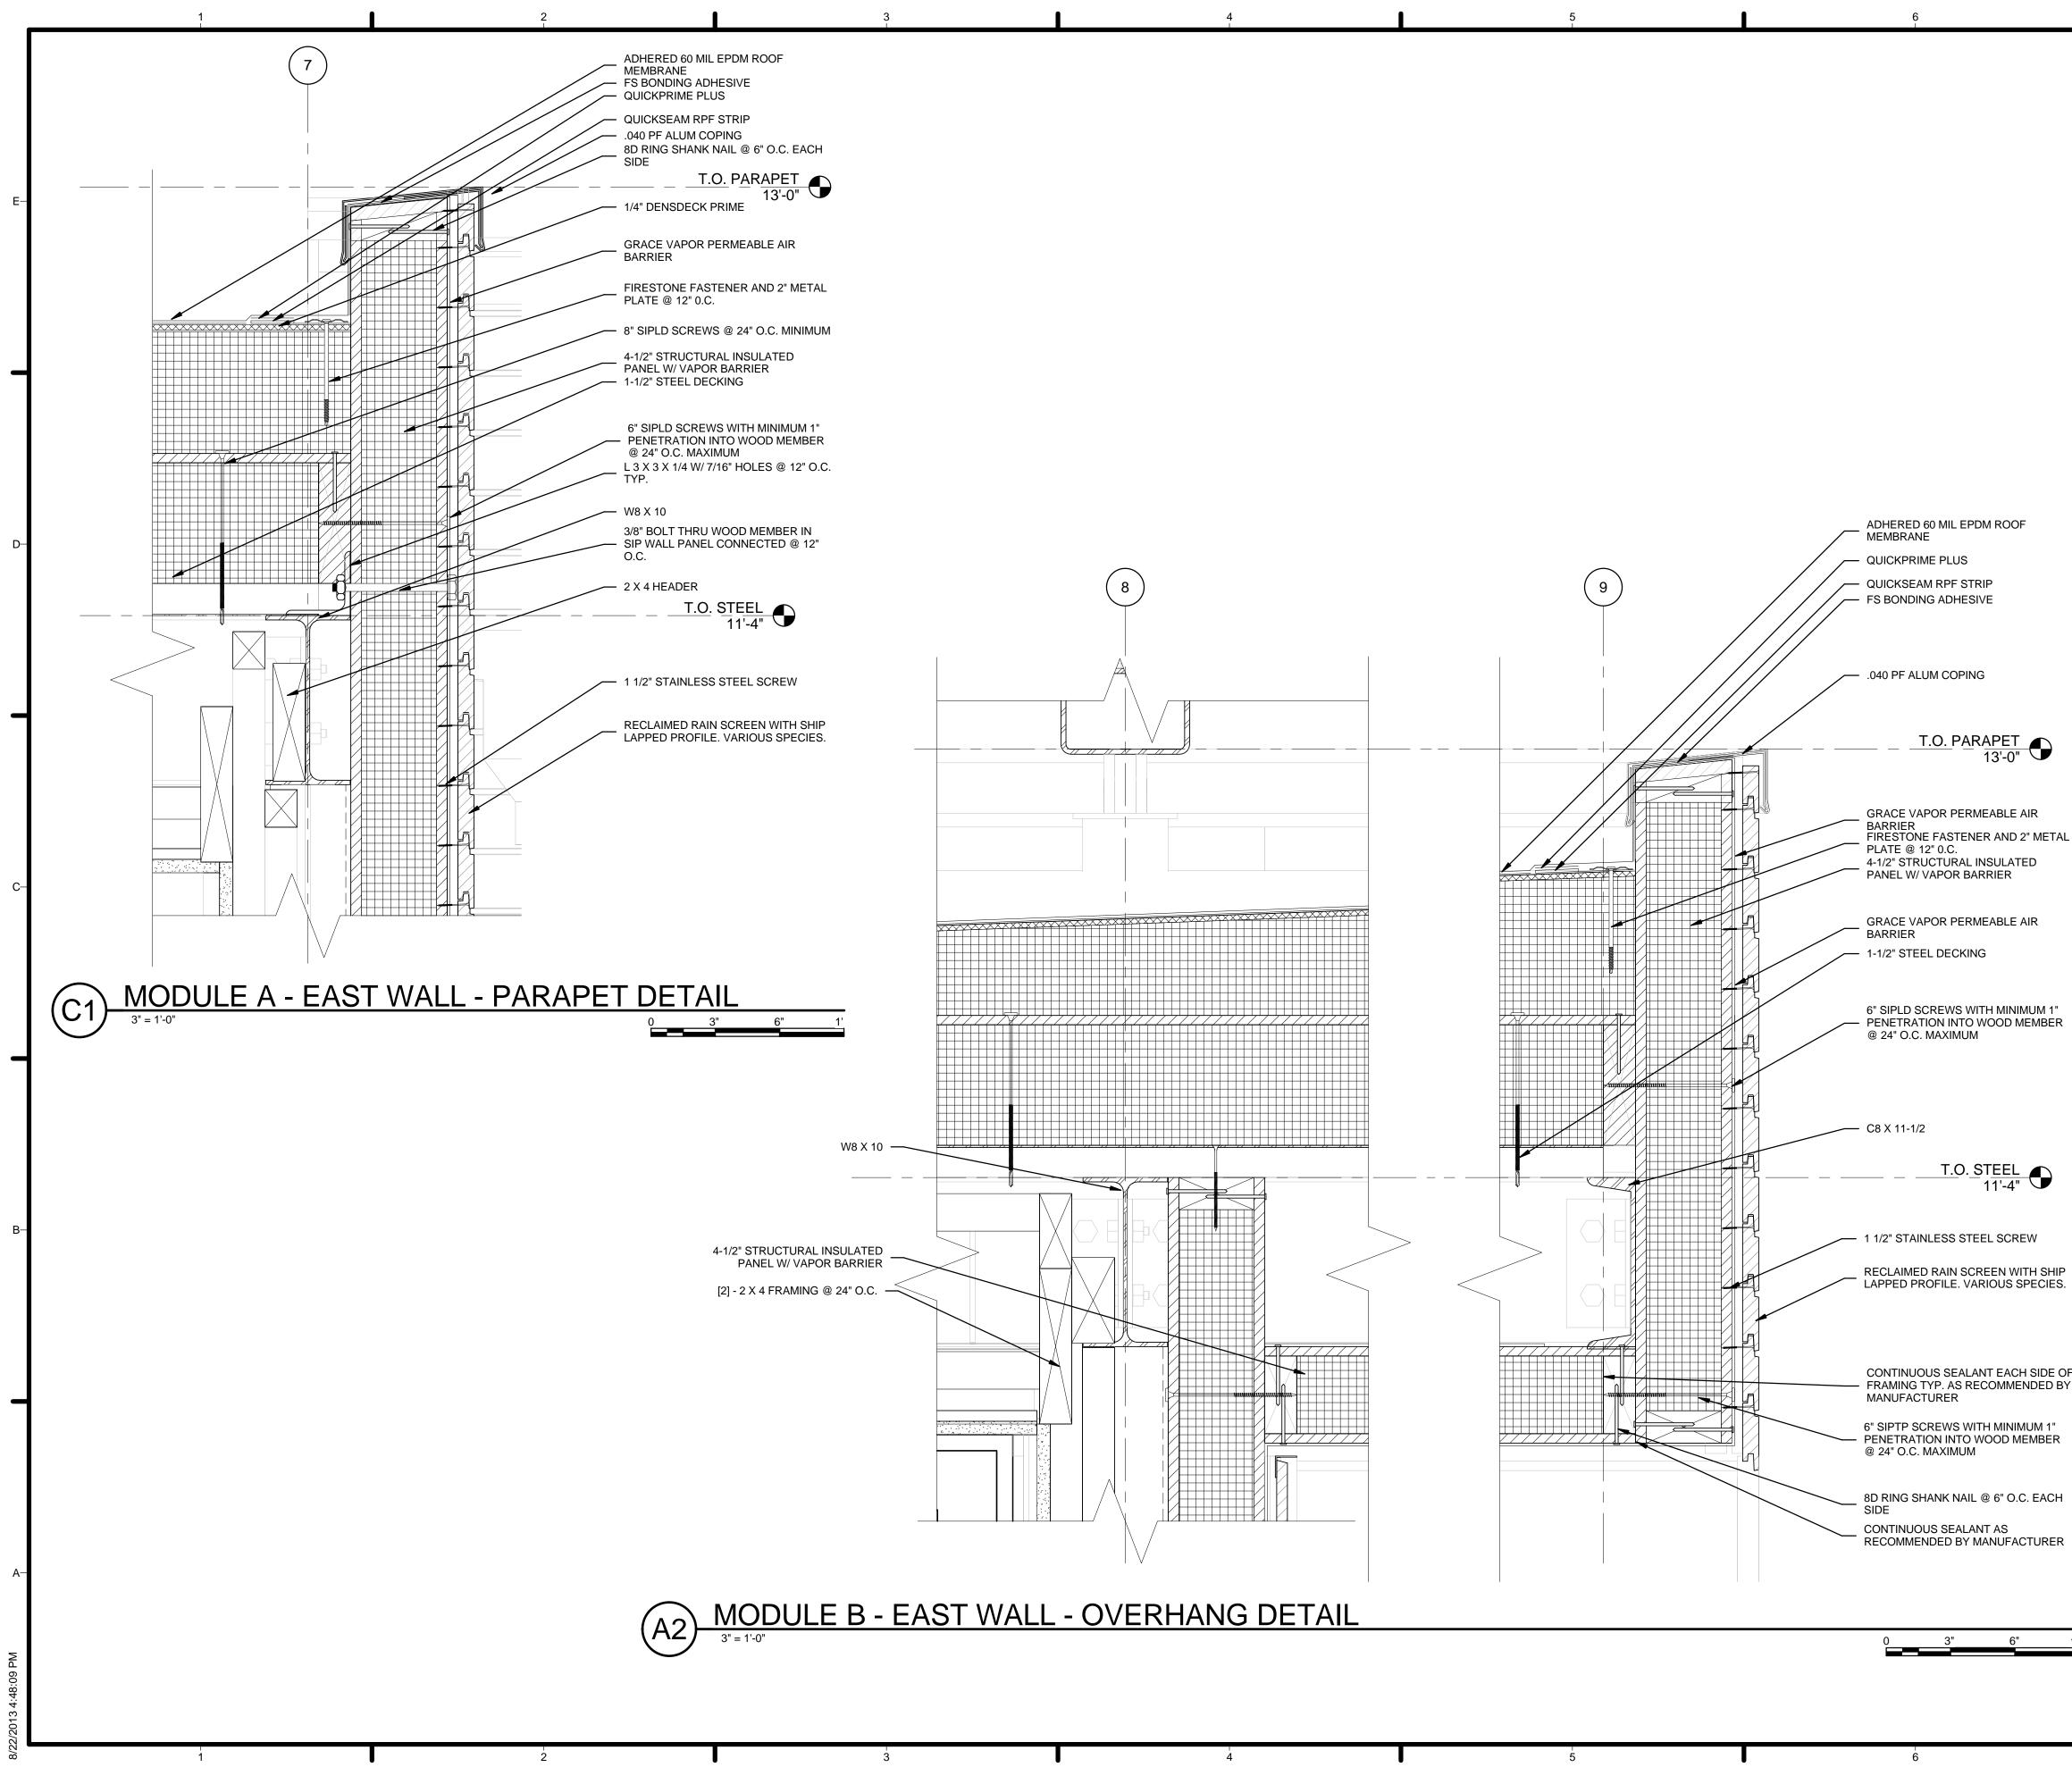
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				620 MICHIGAN AVENUE, NE WASHINGTON, DC 20064
REFERENCE KEYNOTES		-		R
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05 12 23.B1 1/4" STEEL PLATE 05 12 23.C2 L 4 X 4 X 5/16 05 31 23 1-1/2" STEEL DECKING	-D	WASH TEL: 2	UE, NW., SUITE HINGTON, DC 2 202.729.8220	
06 12 00.A2 4-1/2" STRUCTURAL INSULATED PANEL W/ VAPOR BARRIER			GINEER ENGINEERING CONNECTICUT	
07 10 01GRACE VAPOR PERMEABLE AIR BARRIER07 53 23ADHERED 60 MIL EPDM ROOF MEMBRANE07 53 24FS BONDING ADHESIVE		AVEN WASH	UE, NW., SUITI HINGTON, DC 2 202.729.8220	E 200
07 62 00.A5 .040 PF ALUM COPING 07 71 14 1/4" DENSDECK PRIME		ARCHITE	CT OF RECOR	
07 71 15QUICKSEAM RPF STRIP07 71 16QUICKPRIME PLUS07 71 17FIRESTONE FASTENER AND 2" METAL PLATE		620 M CROL WASH	IICHIGAN ÁVE I JGH CENTER HINGTON, DC 2	NE
@ 12" 0.C.08 11 16 ALUMINUM DOORS AND FRAMES	\mathbf{F}	TEL: 2	202.344.5513	
09 29 10.A3 5/8" GYPSUM BOARD				
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	-U	CLIENT	U.S. DEPAR	TMENT OF ENERGY
SHEET KEYNOTES				ECATHLON 2013 RDECATHLON.GOV
12 3/8" BOLT THRU WOOD MEMBER IN SIP WALL			\	
 PANEL CONNECTED @ 12" O.C. 47 1/2" CAULK JOINT AROUND DOOR FRAME 81 8" SIPLD SCREWS @ 24" O.C. MINIMUM 				R DECATHLON
82 6" SIPTP SCREWS WITH MINIMUM 1" PENETRATION INTO WOOD MEMBER @ 24" O.C. MAXIMUM	┝			
84 4" WOOD SCREW92 1 1/2" STAINLESS STEEL SCREW				
94 RECLAIMED RAIN SCREEN WITH SHIP LAPPED PROFILE. VARIOUS SPECIES.				
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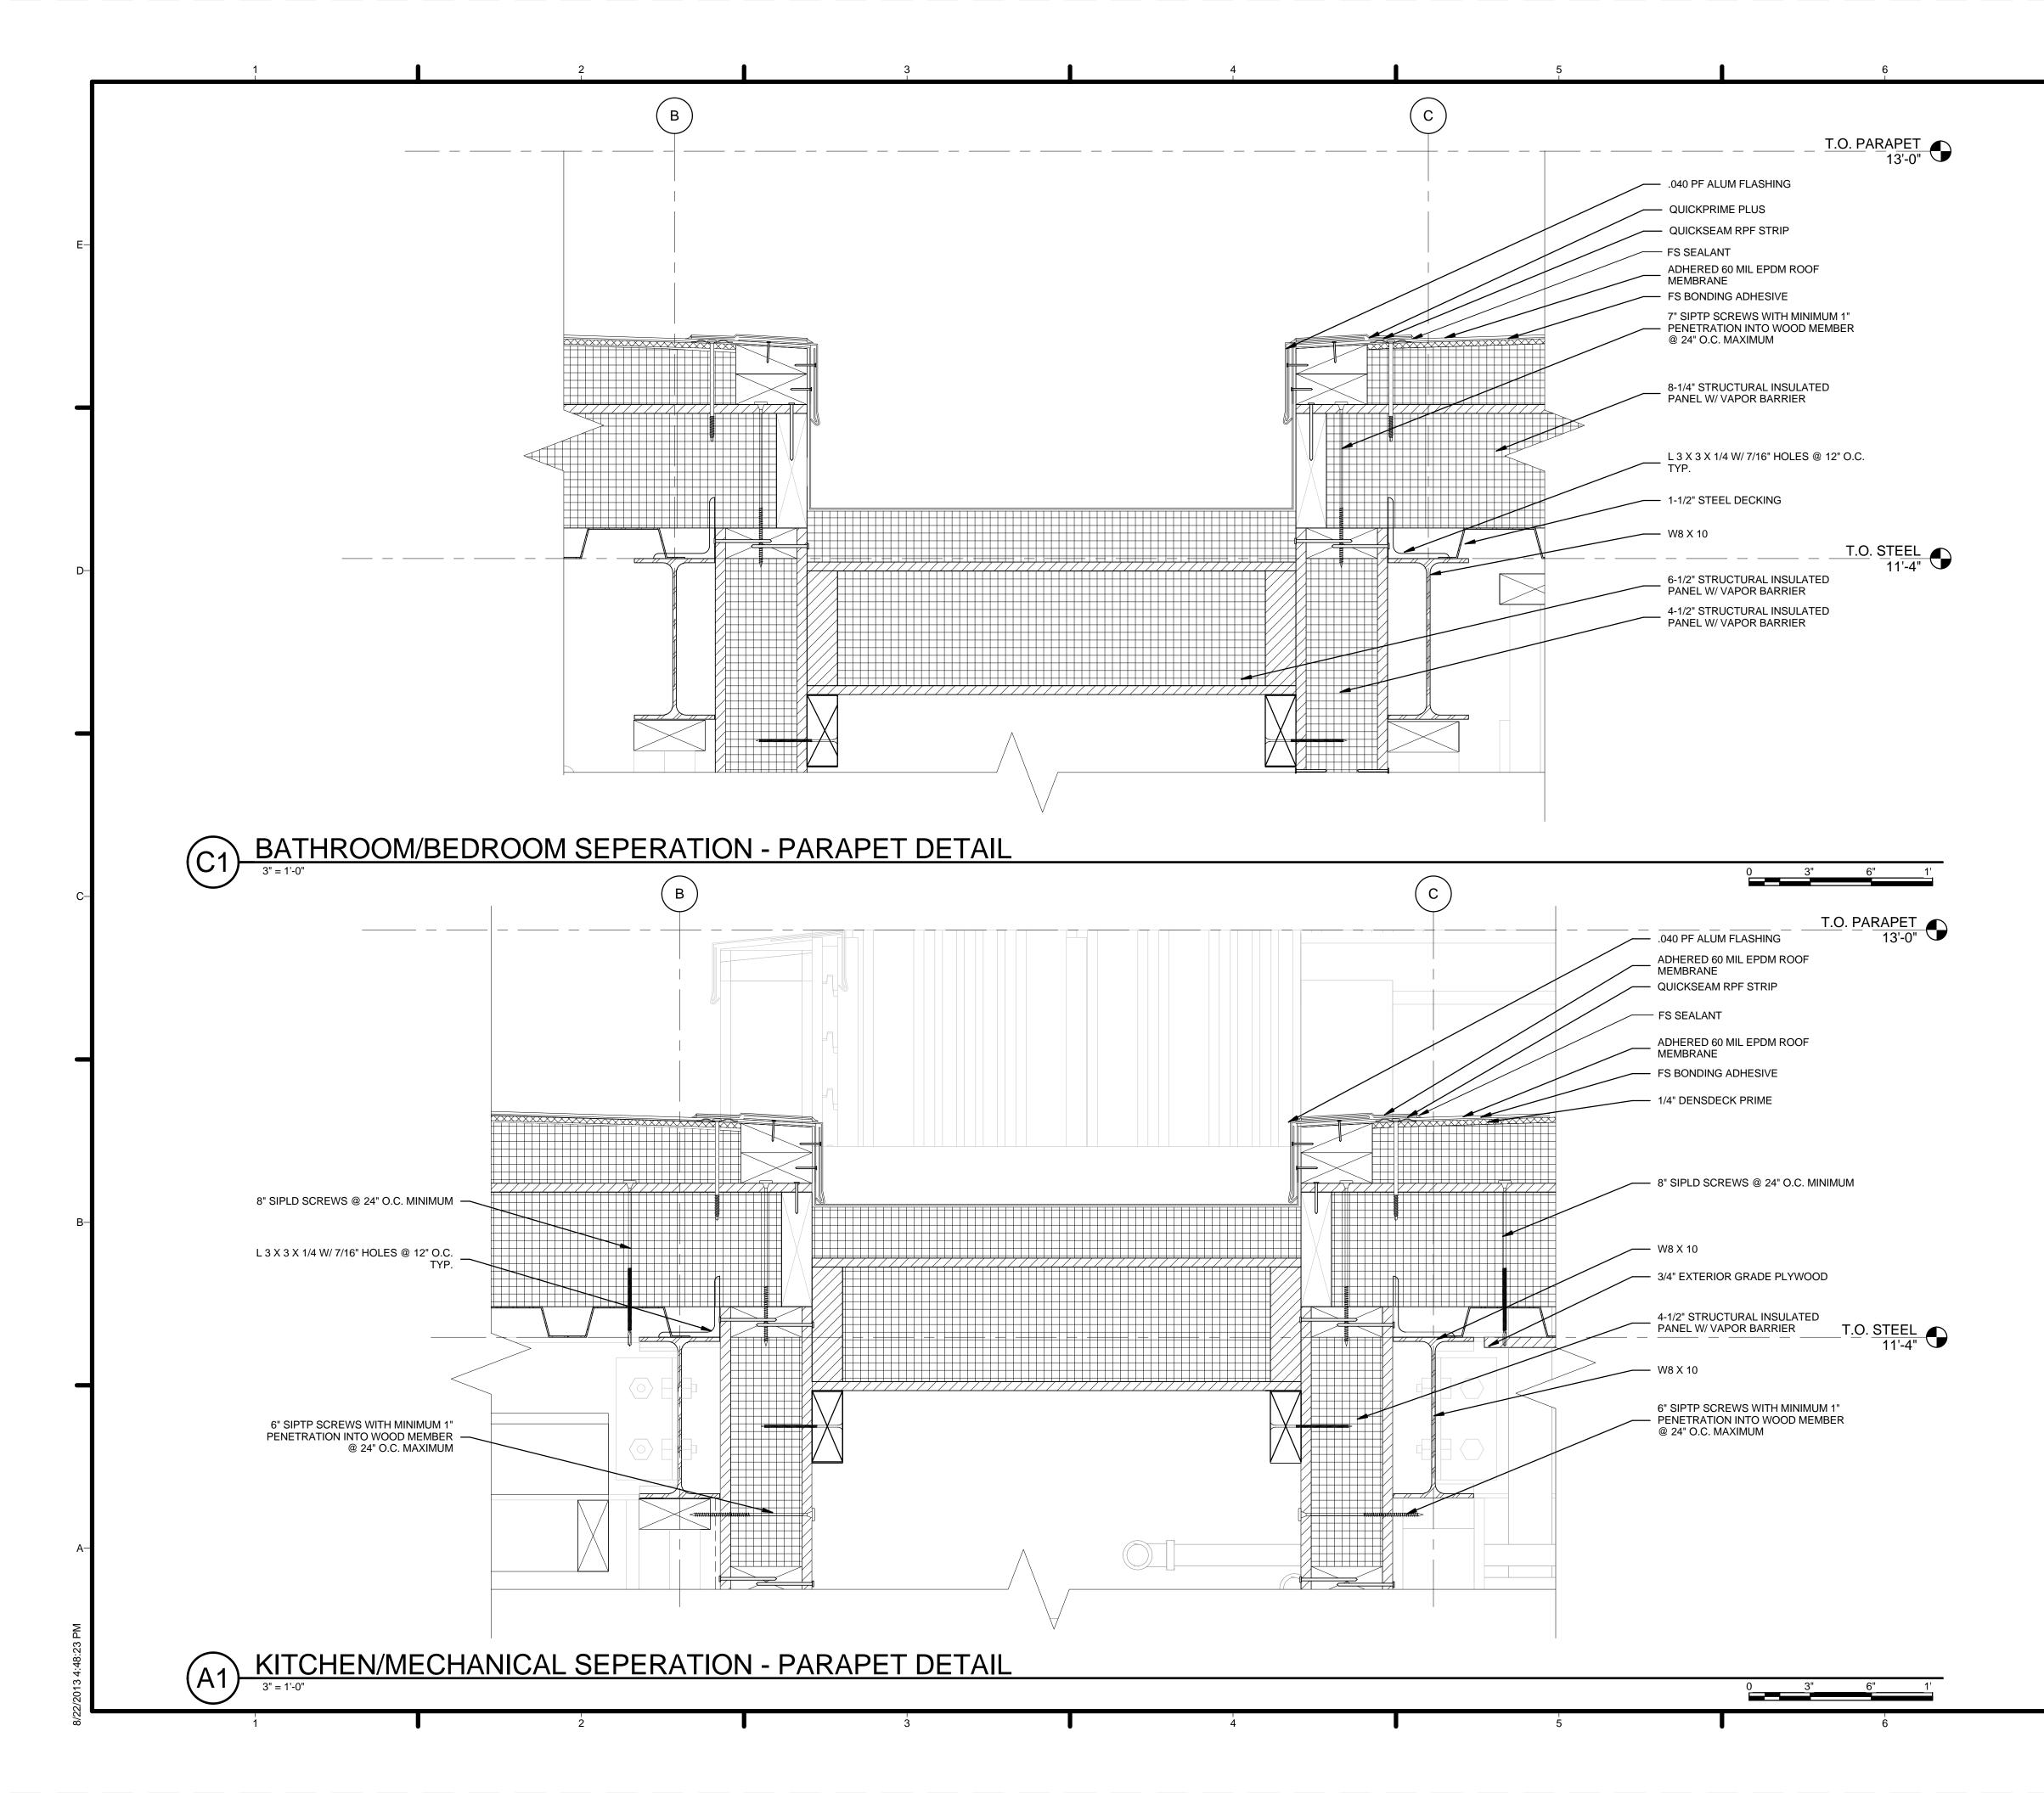
QUICKSEAM RPF STRIP FS BONDING ADHESIVE - .040 PF ALUM COPING GRACE VAPOR PERMEABLE AIR FIRESTONE FASTENER AND 2" METAL PLATE @ 12" 0.C. 8" SIPLD SCREWS @ 24" O.C. MINIMUM 4-1/2" STRUCTURAL INSULATED PANEL W/ VAPOR BARRIER 6" SIPLD SCREWS WITH MINIMUM 1" - PENETRATION INTO WOOD MEMBER @ 24" O.C. MAXIMUM - 1-1/2" STEEL DECKING L 3 X 3 X 1/4 W/ 7/16" HOLES @ 12" O.C. 3/8" BOLT THRU WOOD MEMBER IN - SIP WALL PANEL CONNECTED @ 12" <u>T.O. STEEL</u> 11'-4" - 1 1/2" STAINLESS STEEL SCREW RECLAIMED RAIN SCREEN WITH SHIP LAPPED PROFILE. VARIOUS SPECIES. CONTINUOUS SEALANT EACH SIDE OF - FRAMING TYP. AS RECOMMENDED BY 1/2" CAULK JOINT AROUND WINDOW

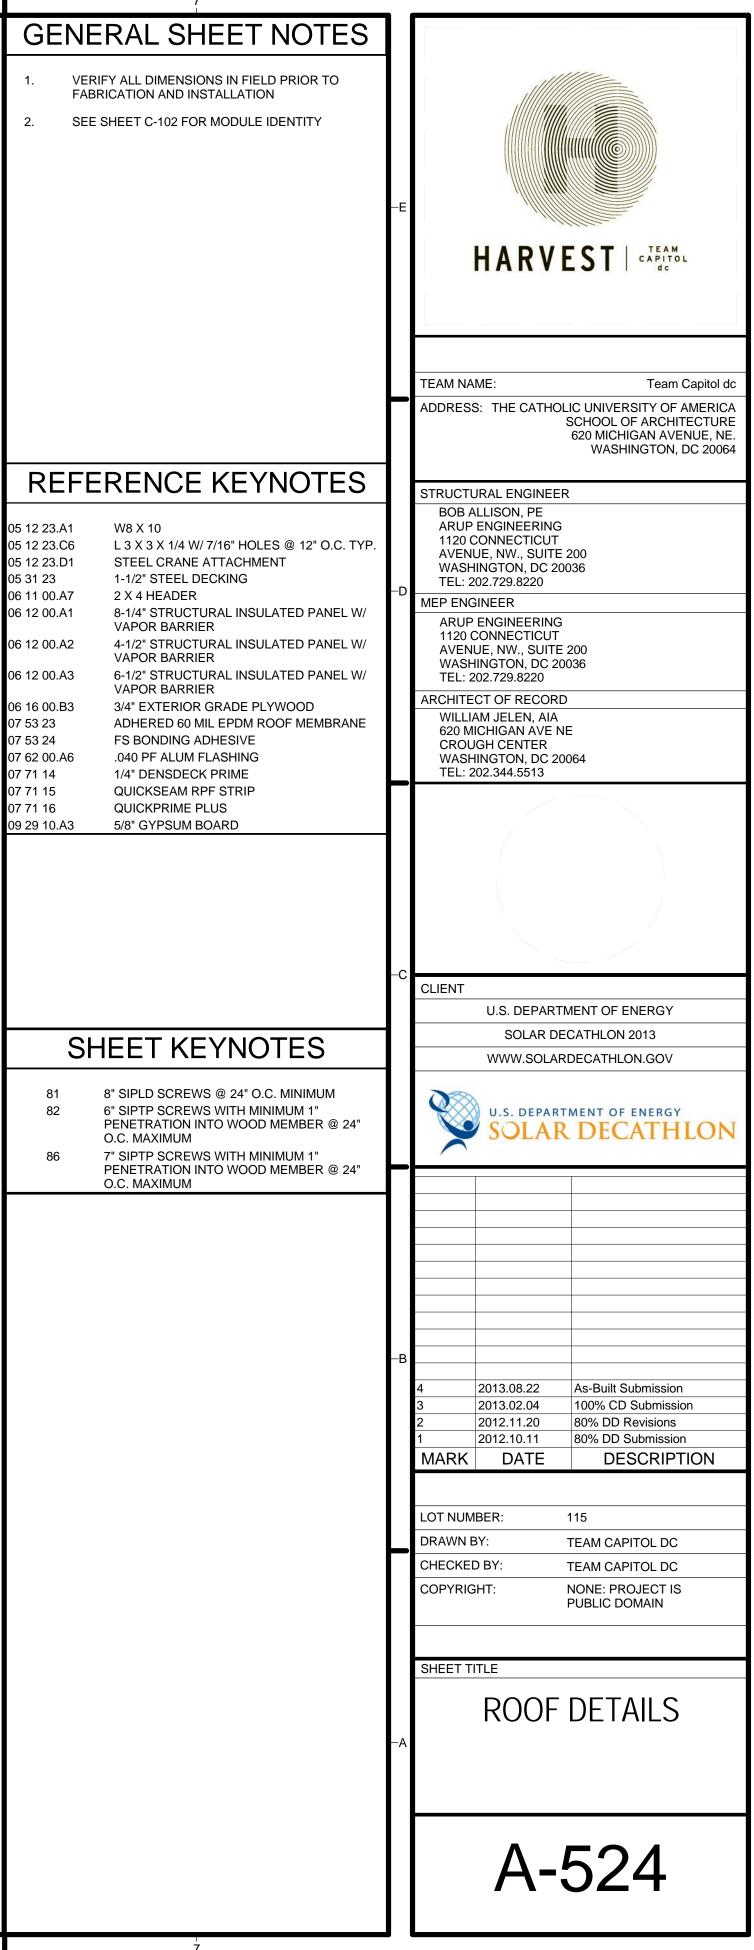
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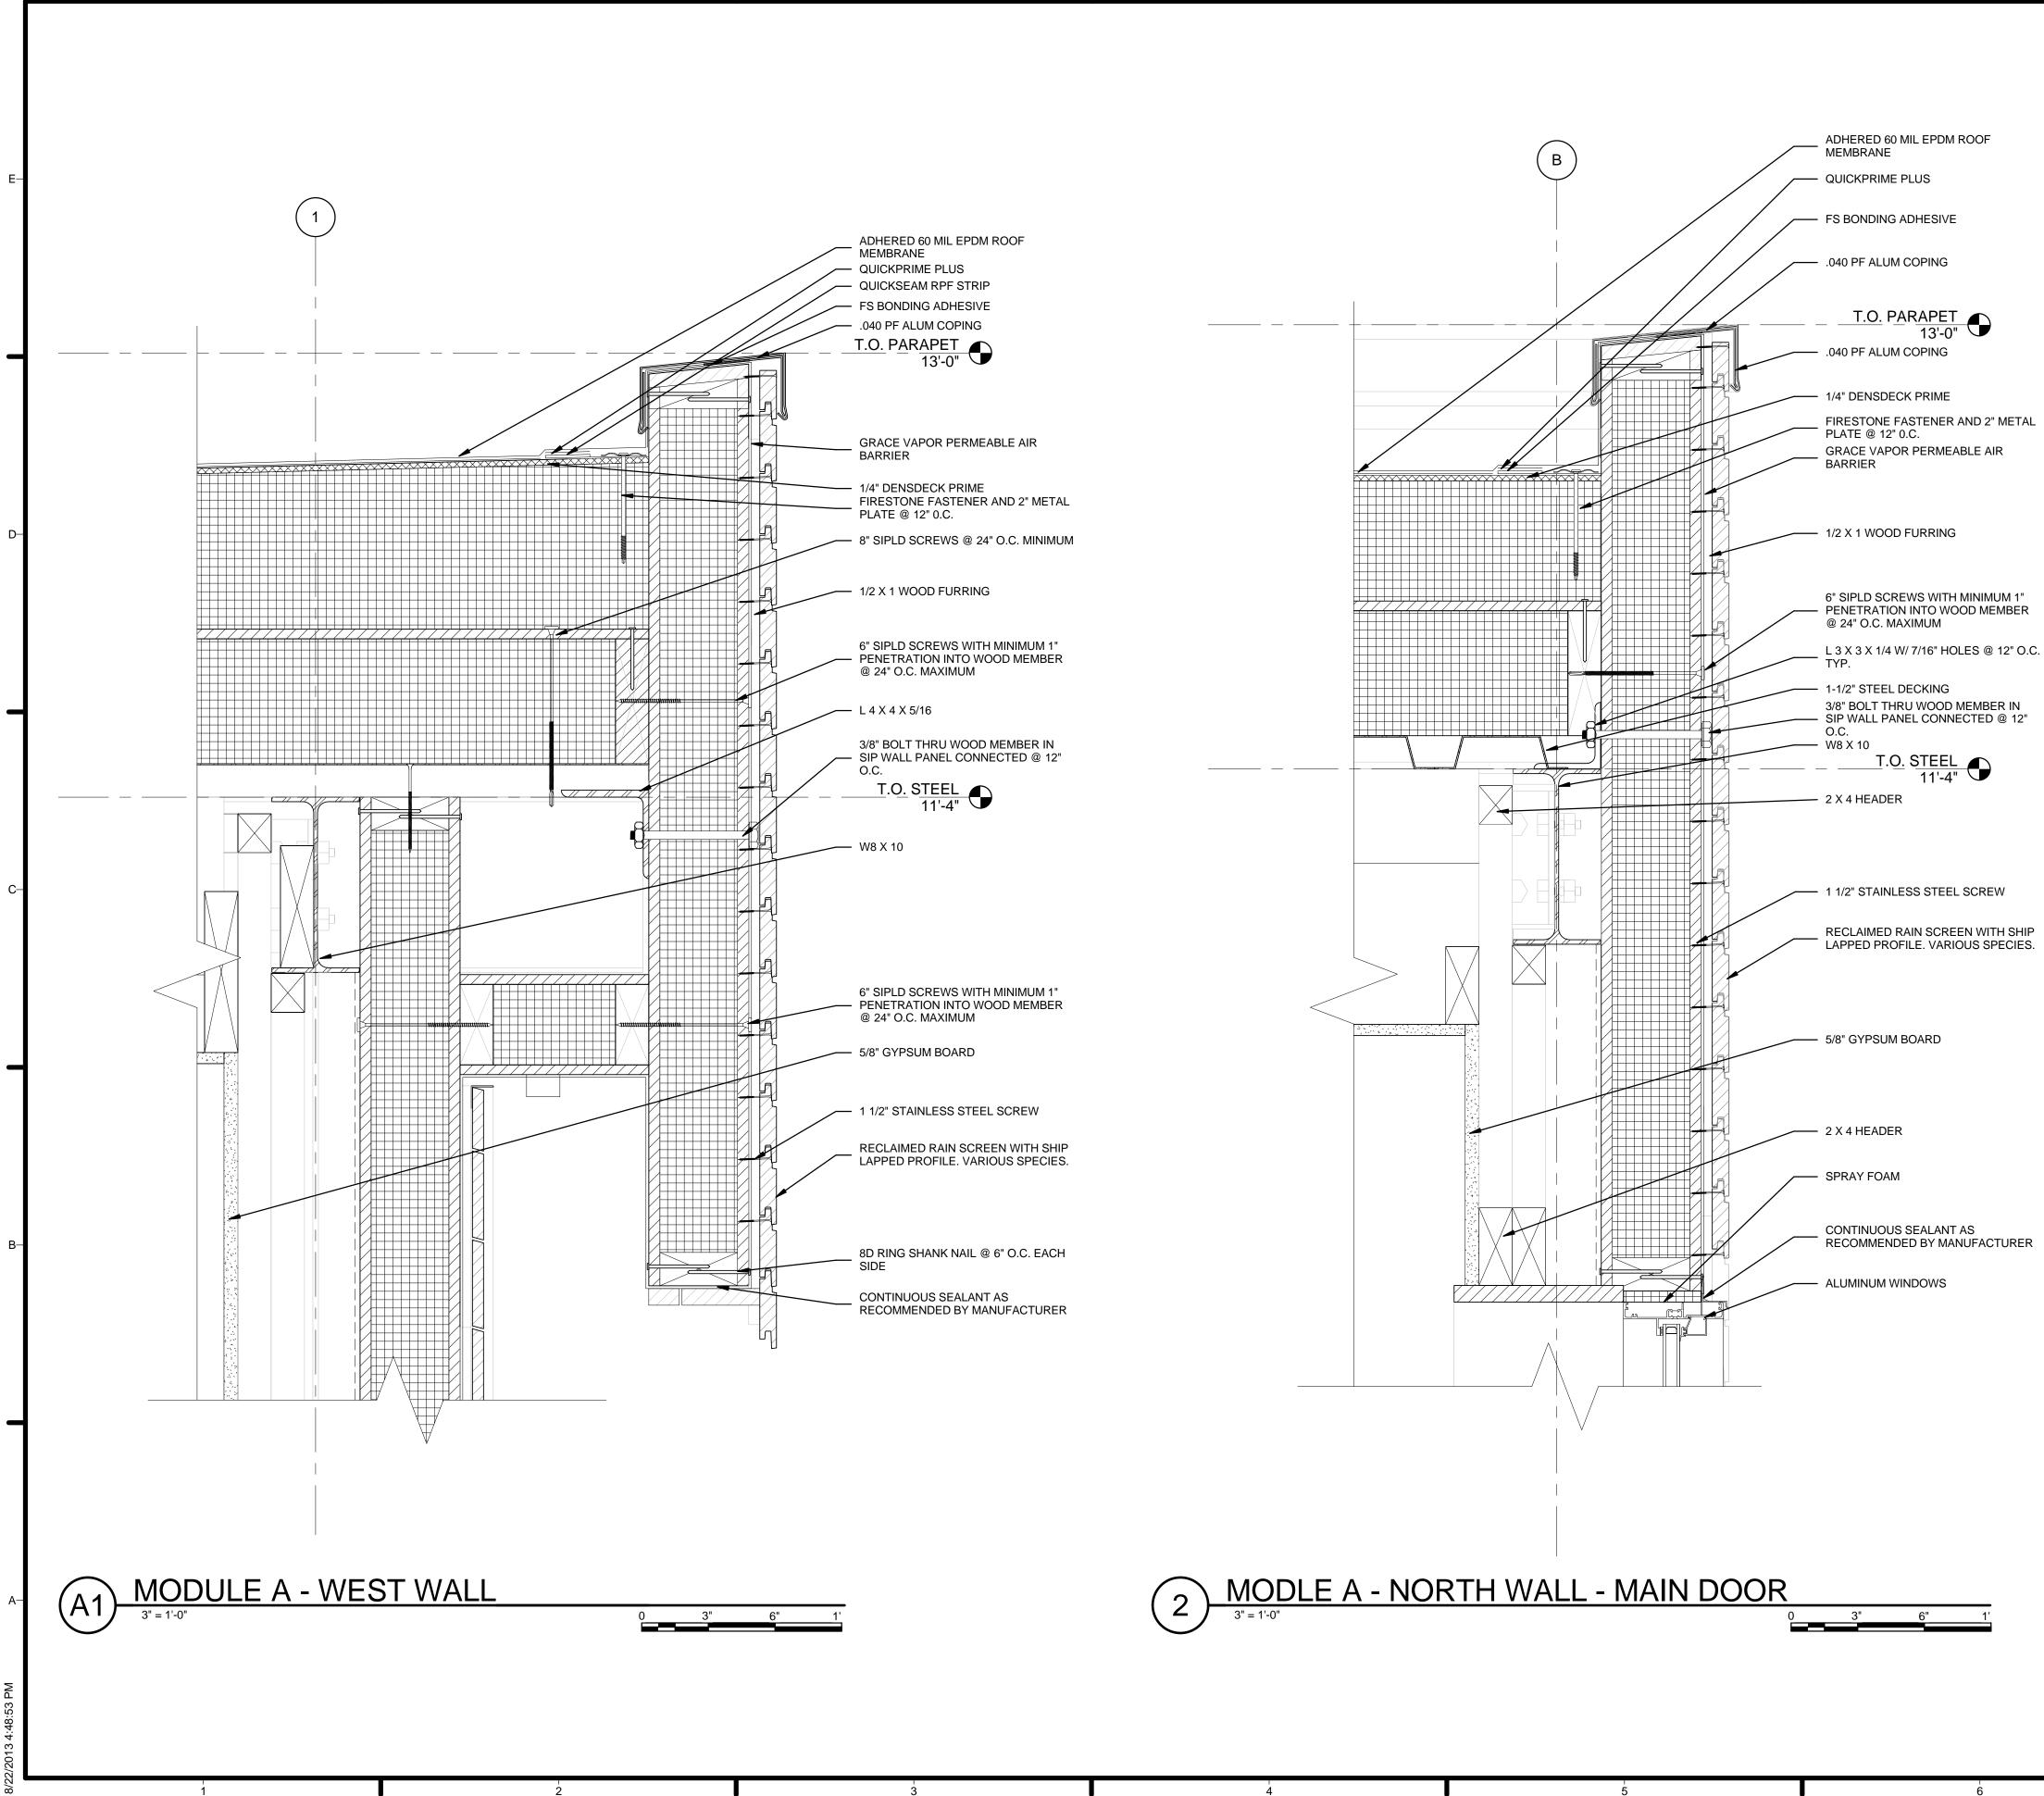
GENERAL SHEET NOTES	
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	TEAM NAME: Team Capitol dc ADDRESS: THE CATHOLIC UNIVERSITY OF AMERICA SCHOOL OF ARCHITECTURE
	620 MICHIGAN AVENUE, NE. WASHINGTON, DC 20064
REFERENCE KEYNOTES05 12 23.A1W8 X 1005 12 23.C2L 4 X 4 X 5/1605 12 23.C6L 3 X 3 X 1/4 W/ 7/16" HOLES @ 12" O.C. TYP.05 31 231-1/2" STEEL DECKING06 11 00.B12 X 6 STUD06 12 00.A24-1/2" STRUCTURAL INSULATED PANEL W/ VAPOR BARRIER07 10 01GRACE VAPOR PERMEABLE AIR BARRIER07 53 23ADHERED 60 MIL EPDM ROOF MEMBRANE07 53 24FS BONDING ADHESIVE07 62 00.A5.040 PF ALUM COPING07 71 141/4" DENSDECK PRIME07 71 15QUICKSEAM RPF STRIP07 71 16QUICKPRIME PLUS07 71 17FIRESTONE FASTENER AND 2" METAL PLATE	STRUCTURAL ENGINEERBOB ALLISON, PE ARUP ENGINEERING 1120 CONNECTICUT AVENUE, NW., SUITE 200 WASHINGTON, DC 20036 TEL: 202.729.8220MEP ENGINEER ARUP ENGINEERING 1120 CONNECTICUT AVENUE, NW., SUITE 200 WASHINGTON, DC 20036
SHEET KEEYNOTES 01 6" SIPLD SCREWS WITH MINIMUM 1" PENETRATION INTO WOOD MEMBER @ 24" O.C. MAXIMUM 02 CONTINUOUS SEALANT EACH SIDE OF FRAMING TYP. AS RECOMMENDED BY MANUFACTURER 12 3/8" BOLT THRU WOOD MEMBER IN SIP WALL PANEL CONNECTED @ 12" O.C. 14 1/2" CAULK JOINT AROUND WINDOW FRAME 81 8" SIPLD SCREWS @ 24" O.C. MINIMUM 82 6" SIPTP SCREWS WITH MINIMUM 1" PENETRATION INTO WOOD MEMBER @ 24" O.C. MAXIMUM 84 4" WOOD SCREW 92 1 1/2" STAINLESS STEEL SCREW 94 RECLAIMED RAIN SCREEN WITH SHIP LAPPED PROFILE. VARIOUS SPECIES.	-B 4 2013.08.22 As-Built Submission 3 2013.02.04 100% CD Submission 4 4 2013.08.22 As-Built Submission 3 2013.02.04 100% CD Submission CD SUBM
	DRAWN BY: TEAM CAPITOL DC CHECKED BY: TEAM CAPITOL DC COPYRIGHT: NONE: PROJECT IS PUBLIC DOMAIN SHEET TITLE ROOF DETAILS



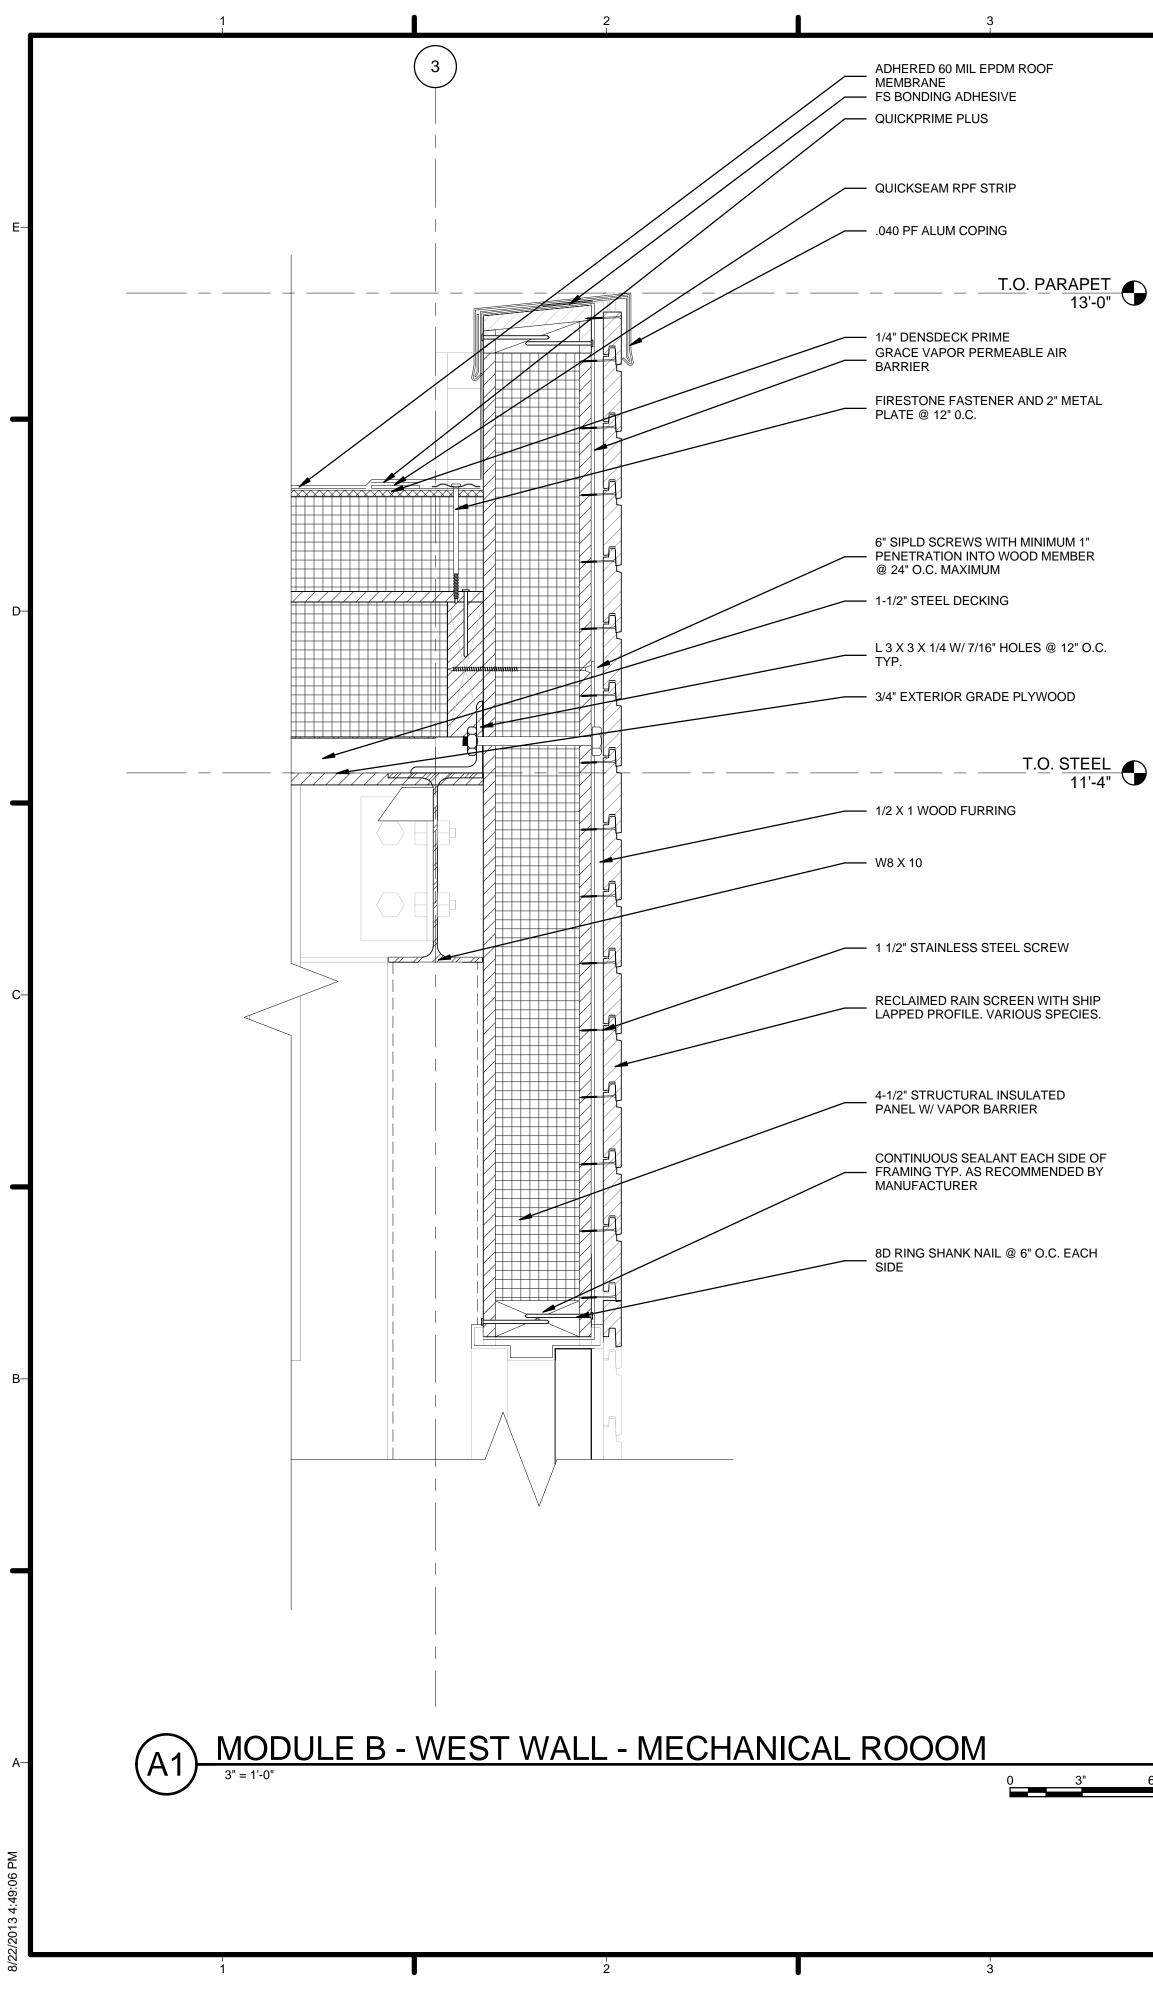
	GENERAL SHEET NOTES		
	 VERIFY ALL DIMENSIONS IN FIELD PRIOR TO FABRICATION AND INSTALLATION SEE SHEET C-102 FOR MODULE IDENTITY 	μ	TEAM NAME: Team Capitol dc TEAM NAME: Team Capitol dc ADDRESS: THE CATHOLIC UNIVERSITY OF AMERICA
			SCHOOL OF ARCHITECTURE 620 MICHIGAN AVENUE, NE. WASHINGTON, DC 20064
	REFERENCE KEYNOTES05 12 23.A1W8 X 1005 12 23.C6L 3 X 3 X 1/4 W/ 7/16" HOLES @ 12" O.C. TYP.05 12 23.F1C8 X 11-1/205 31 231-1/2" STEEL DECKING06 11 00.A3[2] - 2 X 4 FRAMING @ 24" O.C.06 11 00.A72 X 4 HEADER06 12 00.A24-1/2" STRUCTURAL INSULATED PANEL W/ VAPOR BARRIER07 10 01GRACE VAPOR PERMEABLE AIR BARRIER07 53 23ADHERED 60 MIL EPDM ROOF MEMBRANE07 53 24FS BONDING ADHESIVE07 62 00.A5.040 PF ALUM COPING07 71 141/4" DENSDECK PRIME07 71 15QUICKSEAM RPF STRIP07 71 16QUICKPRIME PLUS07 71 17FIRESTONE FASTENER AND 2" METAL PLATE@ 12" 0.C.	-D	STRUCTURAL ENGINEER BOB ALLISON, PE ARUP ENGINEERING 1120 CONNECTICUT AVENUE, NW., SUITE 200 WASHINGTON, DC 20036 TEL: 202.729.8220 MEP ENGINEER ARUP ENGINEERING 1120 CONNECTICUT AVENUE, NW., SUITE 200 WASHINGTON, DC 20036 TEL: 202.729.8220 ARCHITECT OF RECORD WILLIAM JELEN, AIA 620 MICHIGAN AVE NE CROUGH CENTER WASHINGTON, DC 20064 TEL: 202.344.5513
	SHEET KEYNOTES	-c	CLIENT U.S. DEPARTMENT OF ENERGY SOLAR DECATHLON 2013 WWW.SOLARDECATHLON.GOV
	 6" SIPLD SCREWS WITH MINIMUM 1" PENETRATION INTO WOOD MEMBER @ 24" O.C. MAXIMUM CONTINUOUS SEALANT EACH SIDE OF FRAMING TYP. AS RECOMMENDED BY 		U.S. DEPARTMENT OF ENERGY SOLAR DECATHLON
	 MANUFACTURER 03 CONTINUOUS SEALANT AS RECOMMENDED BY MANUFACTURER 04 8D RING SHANK NAIL @ 6" O.C. EACH SIDE 12 3/8" BOLT THRU WOOD MEMBER IN SIP WALL PANEL CONNECTED @ 12" O.C. 81 8" SIPLD SCREWS @ 24" O.C. MINIMUM 82 6" SIPTP SCREWS WITH MINIMUM 1" PENETRATION INTO WOOD MEMBER @ 24" O.C. MAXIMUM 92 1 1/2" STAINLESS STEEL SCREW 94 RECLAIMED RAIN SCREEN WITH SHIP LAPPED PROFILE. VARIOUS SPECIES. 	—В	
	PROFILE. VARIOUS SPECIES.	—в	4 2013.08.22 As-Built Submission 3 2013.02.04 100% CD Submission 2 2012.11.20 80% DD Revisions 1 2012.10.11 80% DD Submission MARK DATE DESCRIPTION
F,			LOT NUMBER: 115 DRAWN BY: TEAM CAPITOL DC CHECKED BY: TEAM CAPITOL DC COPYRIGHT: NONE: PROJECT IS PUBLIC DOMAIN
_		—A	SHEET TITLE ROOF DETAILS
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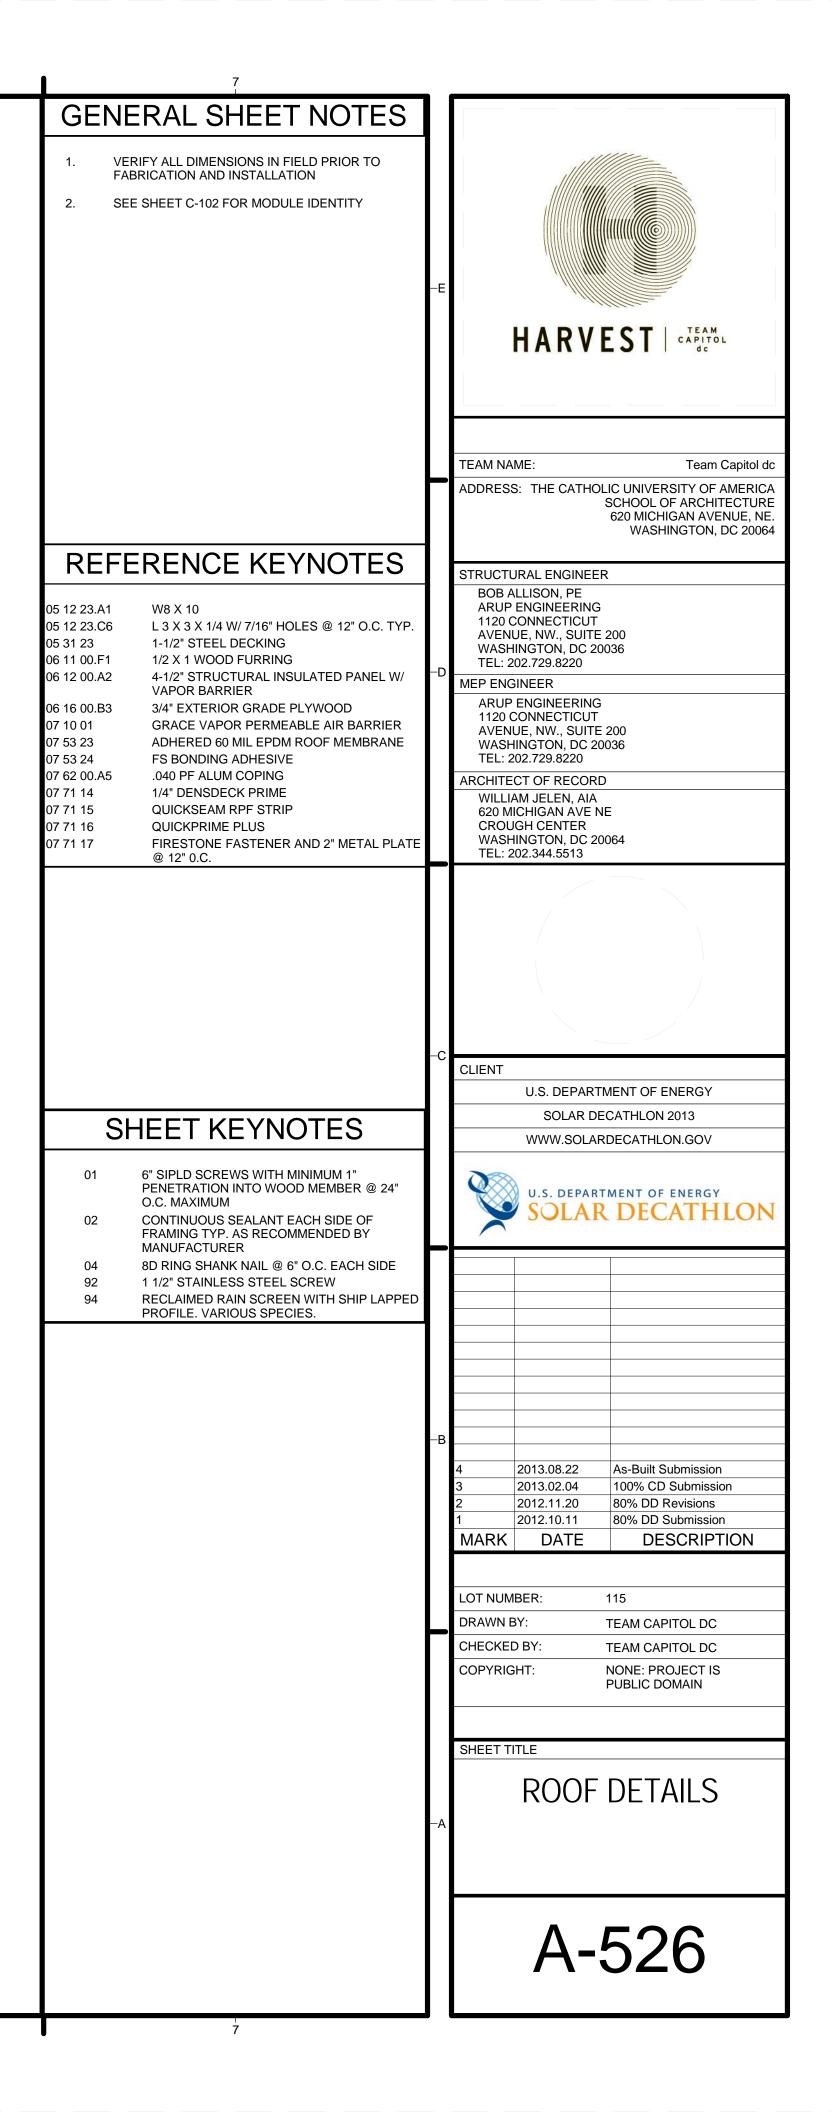


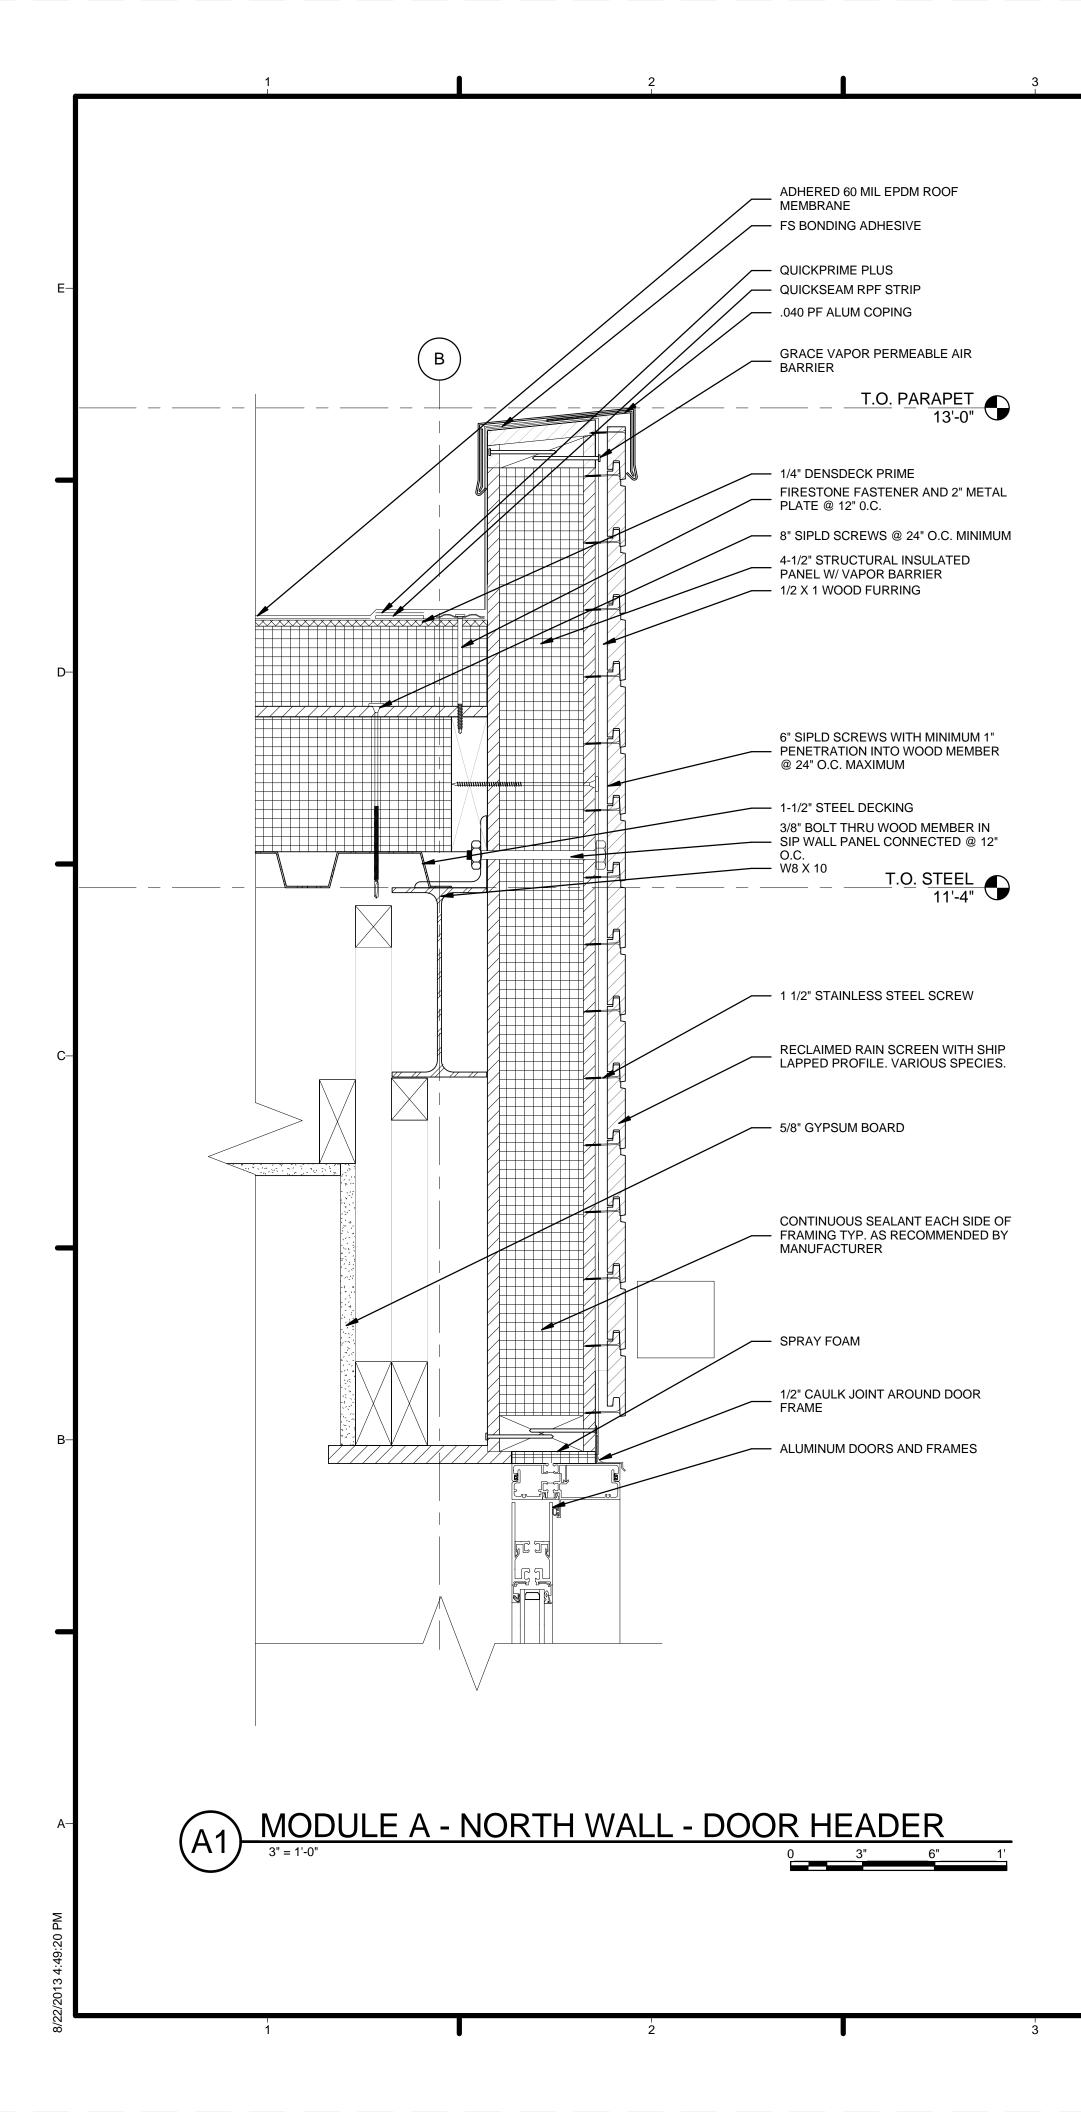
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 VERIFY ALL DIMENSIONS IN FIELD PRIOR TO FABRICATION AND INSTALLATION SEE SHEET C-102 FOR MODULE IDENTITY 	-E	HARVEST SC
D5 12 23.A1 W8 X 10 05 12 23.C2 L 4 X 4 X 5/16 05 12 23.C2 L 4 X 4 X 5/16 05 12 23.C6 L 3 X 3 X 1/4 W/ 7/16" HOLES @ 12" O.C. TYP. 05 31 23 1-1/2" STEEL DECKING 06 11 00.A7 2 X 4 HEADER 06 11 00.F1 1/2 X 1 WOOD FURRING 07 10 01 GRACE VAPOR PERMEABLE AIR BARRIER 07 53 23 ADHERED 60 MIL EPDM ROOF MEMBRANE 07 53 24 FS BONDING ADHESIVE 07 62 00.A5 .040 PF ALUM COPING	——————————————————————————————————————	TEAM NAME: Team Capitol dc ADDRESS: THE CATHOLIC UNIVERSITY OF AMERICA SCHOOL OF ARCHITECTURE 620 MICHIGAN AVENUE, NE. WASHINGTON, DC 20064 STRUCTURAL ENGINEER BOB ALLISON, PE ARUP ENGINEERING 1120 CONNECTICUT AVENUE, NW., SUITE 200 WASHINGTON, DC 20036 TEL: 202.729.8220 MEP ENGINEERING 1120 CONNECTICUT AVENUE, NW., SUITE 200 WASHINGTON, DC 20036 TEL: 202.729.8220
07 71 14 1/4" DENSDECK PRIME 07 71 15 QUICKSEAM RPF STRIP 07 71 16 QUICKPRIME PLUS 07 71 17 FIRESTONE FASTENER AND 2" METAL PLATE @ 12" 0.C. 08 51 13 ALUMINUM WINDOWS 09 29 10.A3 5/8" GYPSUM BOARD		ARCHITECT OF RECORD WILLIAM JELEN, AIA 620 MICHIGAN AVE NE CROUGH CENTER WASHINGTON, DC 20064 TEL: 202.344.5513
01 6" SIPLD SCREWS WITH MINIMUM 1" PENETRATION INTO WOOD MEMBER @ 24" O.C. MAXIMUM 03 CONTINUOUS SEALANT AS RECOMMENDED BY MANUFACTURER 04 8D RING SHANK NAIL @ 6" O.C. EACH SIDE 12 3/8" BOLT THRU WOOD MEMBER IN SIP WALL PANEL CONNECTED @ 12" O.C. 81 8" SIPLD SCREWS @ 24" O.C. MINIMUM 89 SPRAY FOAM	C	CLIENT U.S. DEPARTMENT OF ENERGY SOLAR DECATHLON 2013 WWW.SOLARDECATHLON.GOV U.S. DEPARTMENT OF ENERGY SOLAR DECATHLON
92 1 1/2" STAINLESS STEEL SCREW 94 RECLAIMED RAIN SCREEN WITH SHIP LAPPED PROFILE. VARIOUS SPECIES.		4 2013.08.22 As-Built Submission 3 2013.02.04 100% CD Submission 2 2012.11.20 80% DD Revisions 1 2012.10.11 80% DD Submission MARK DATE DESCRIPTION
		LOT NUMBER: 115 DRAWN BY: TEAM CAPITOL DC CHECKED BY: TEAM CAPITOL DC COPYRIGHT: NONE: PROJECT IS PUBLIC DOMAIN SHEET TITLE ROOF DETAILS
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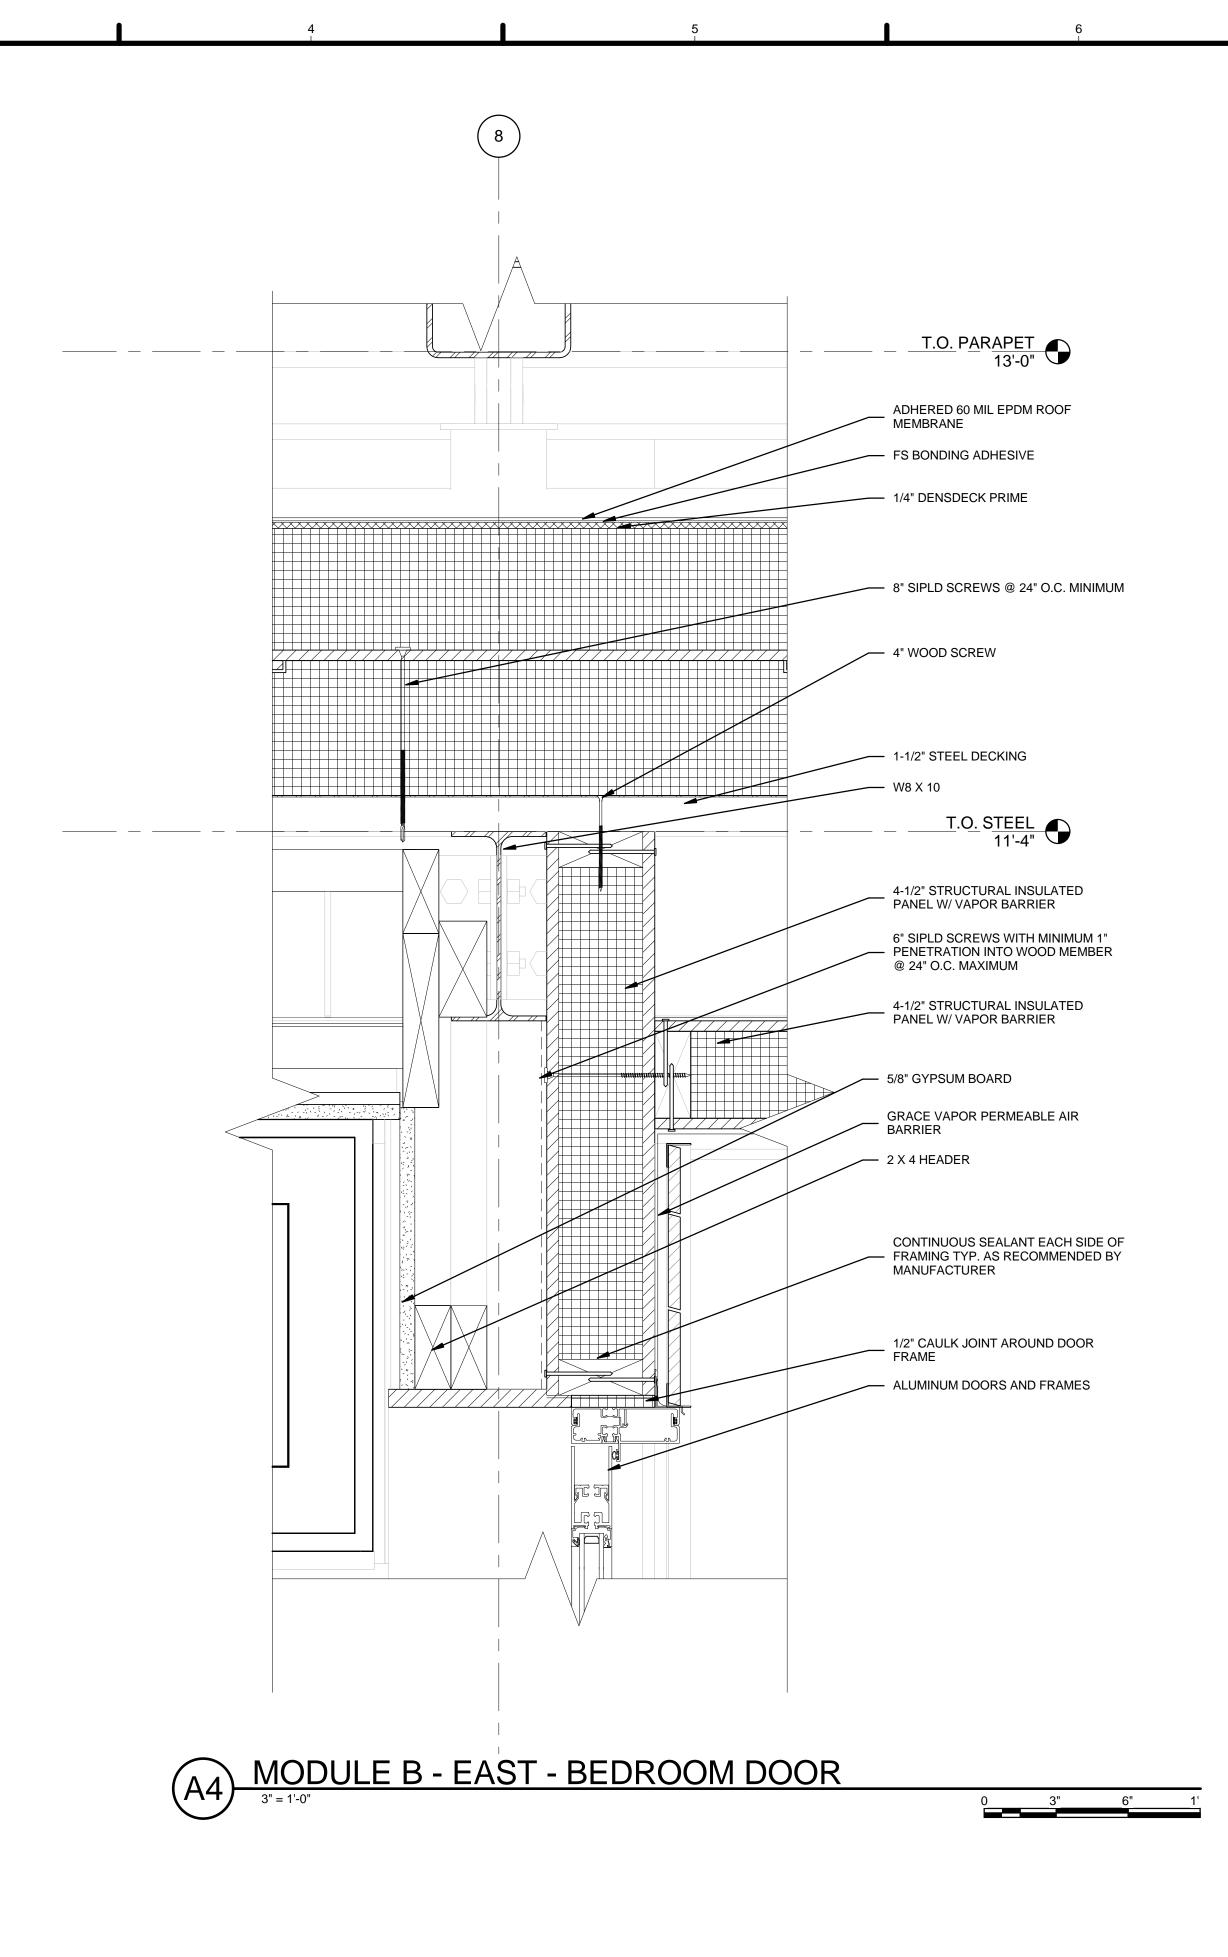


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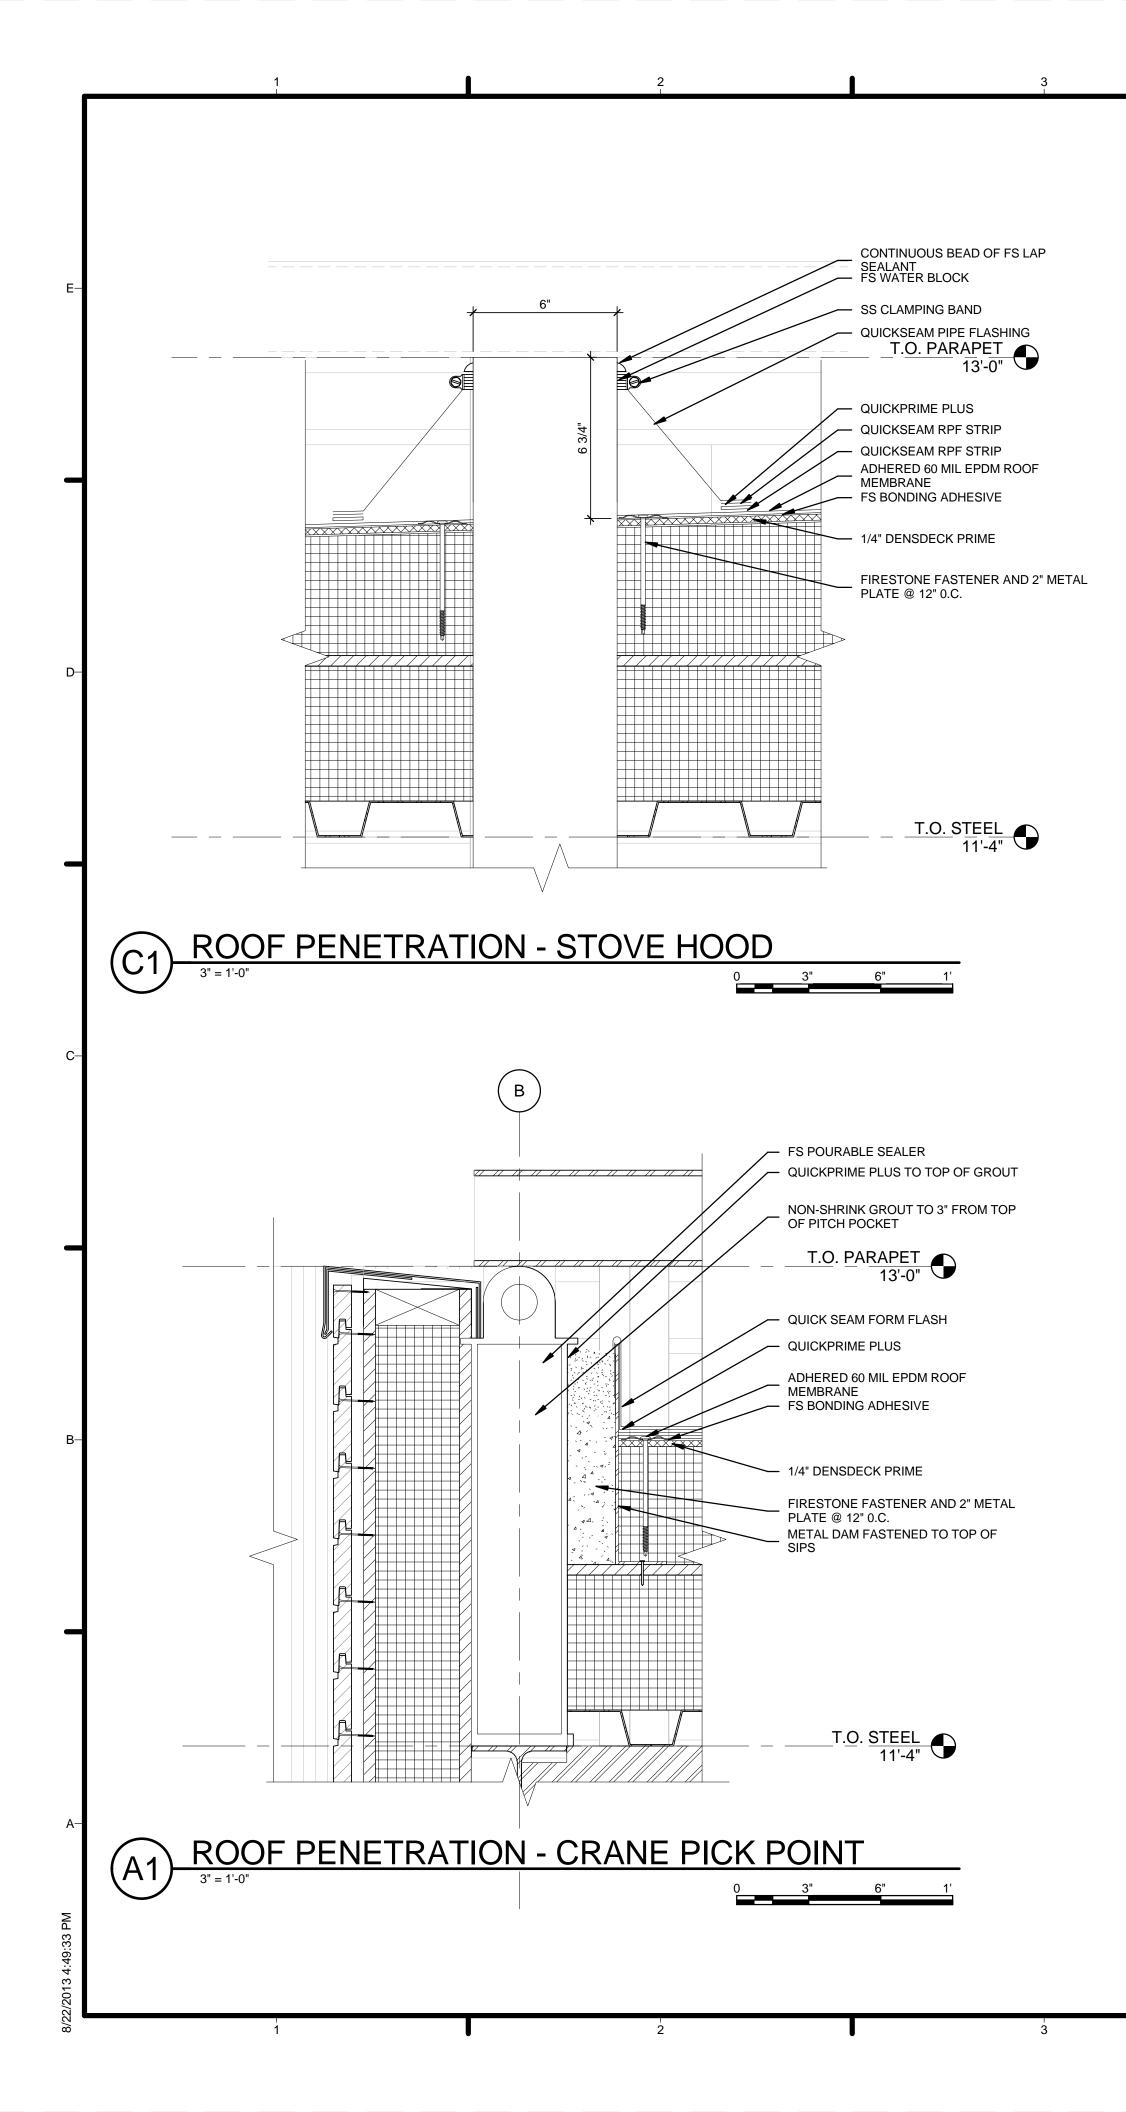


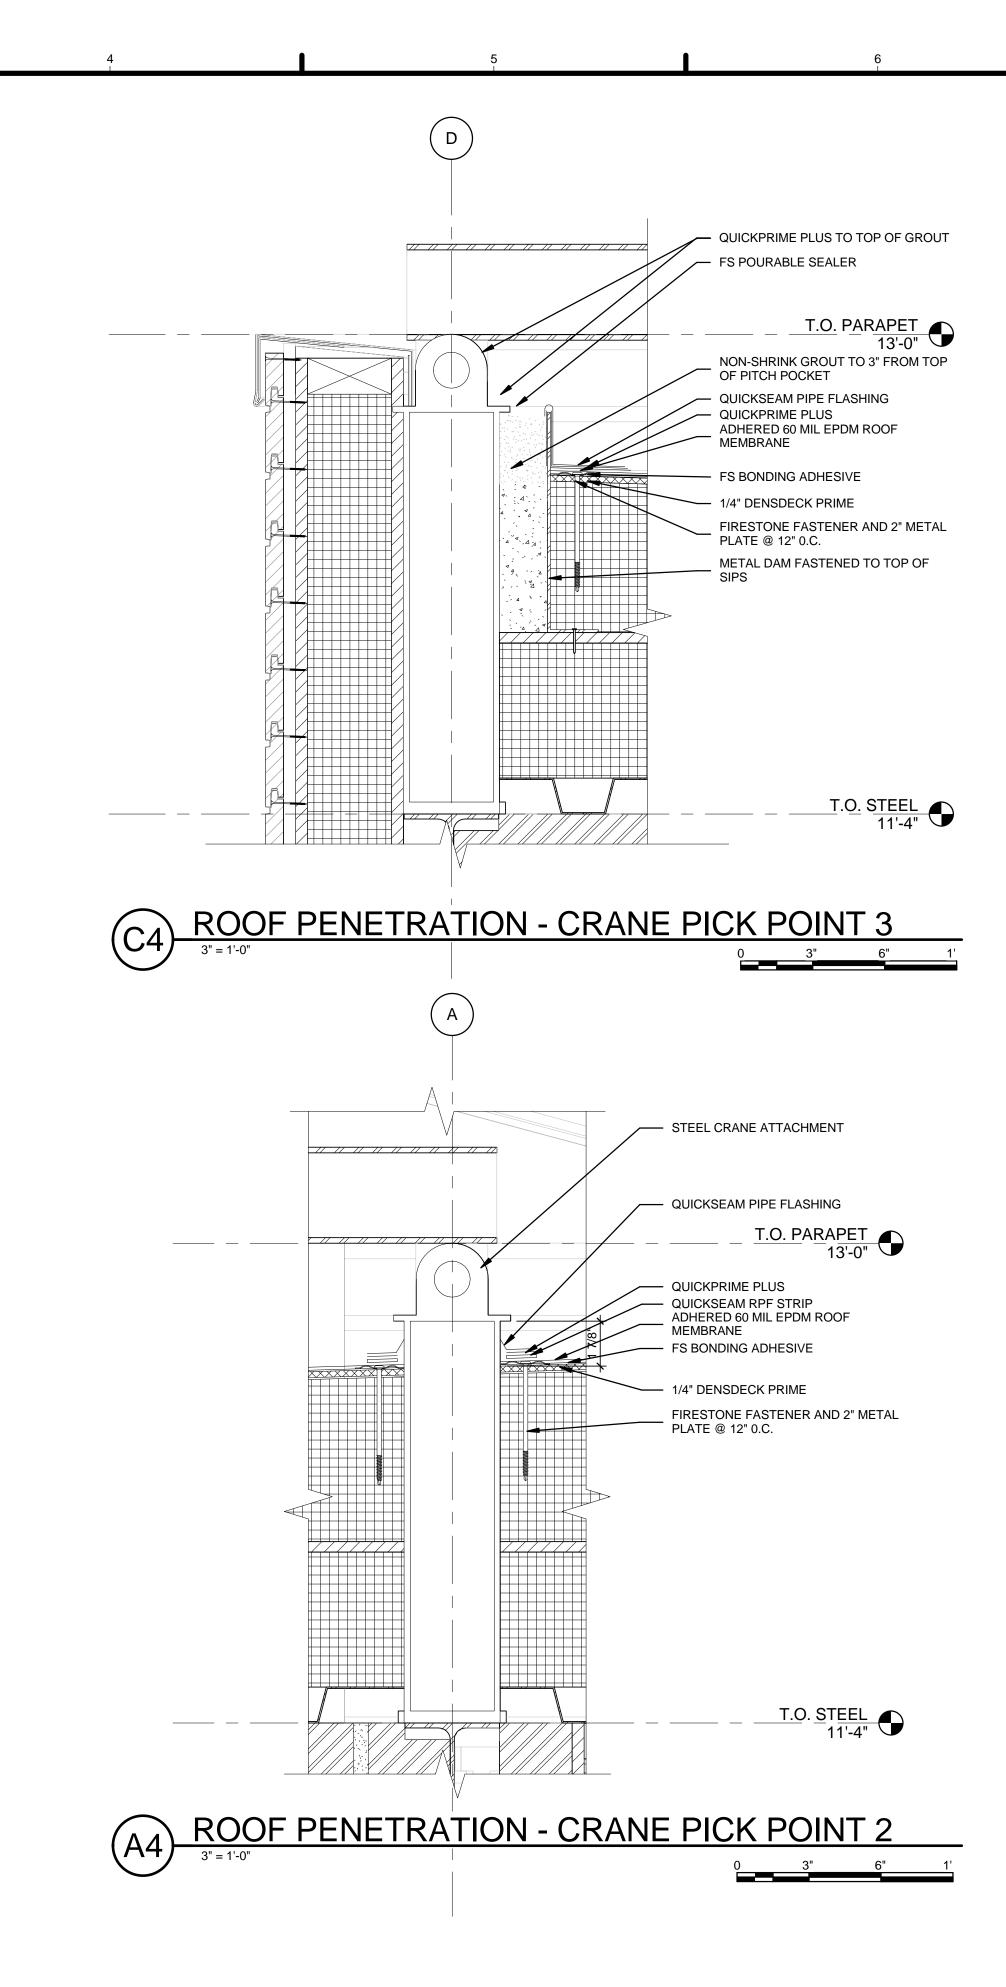




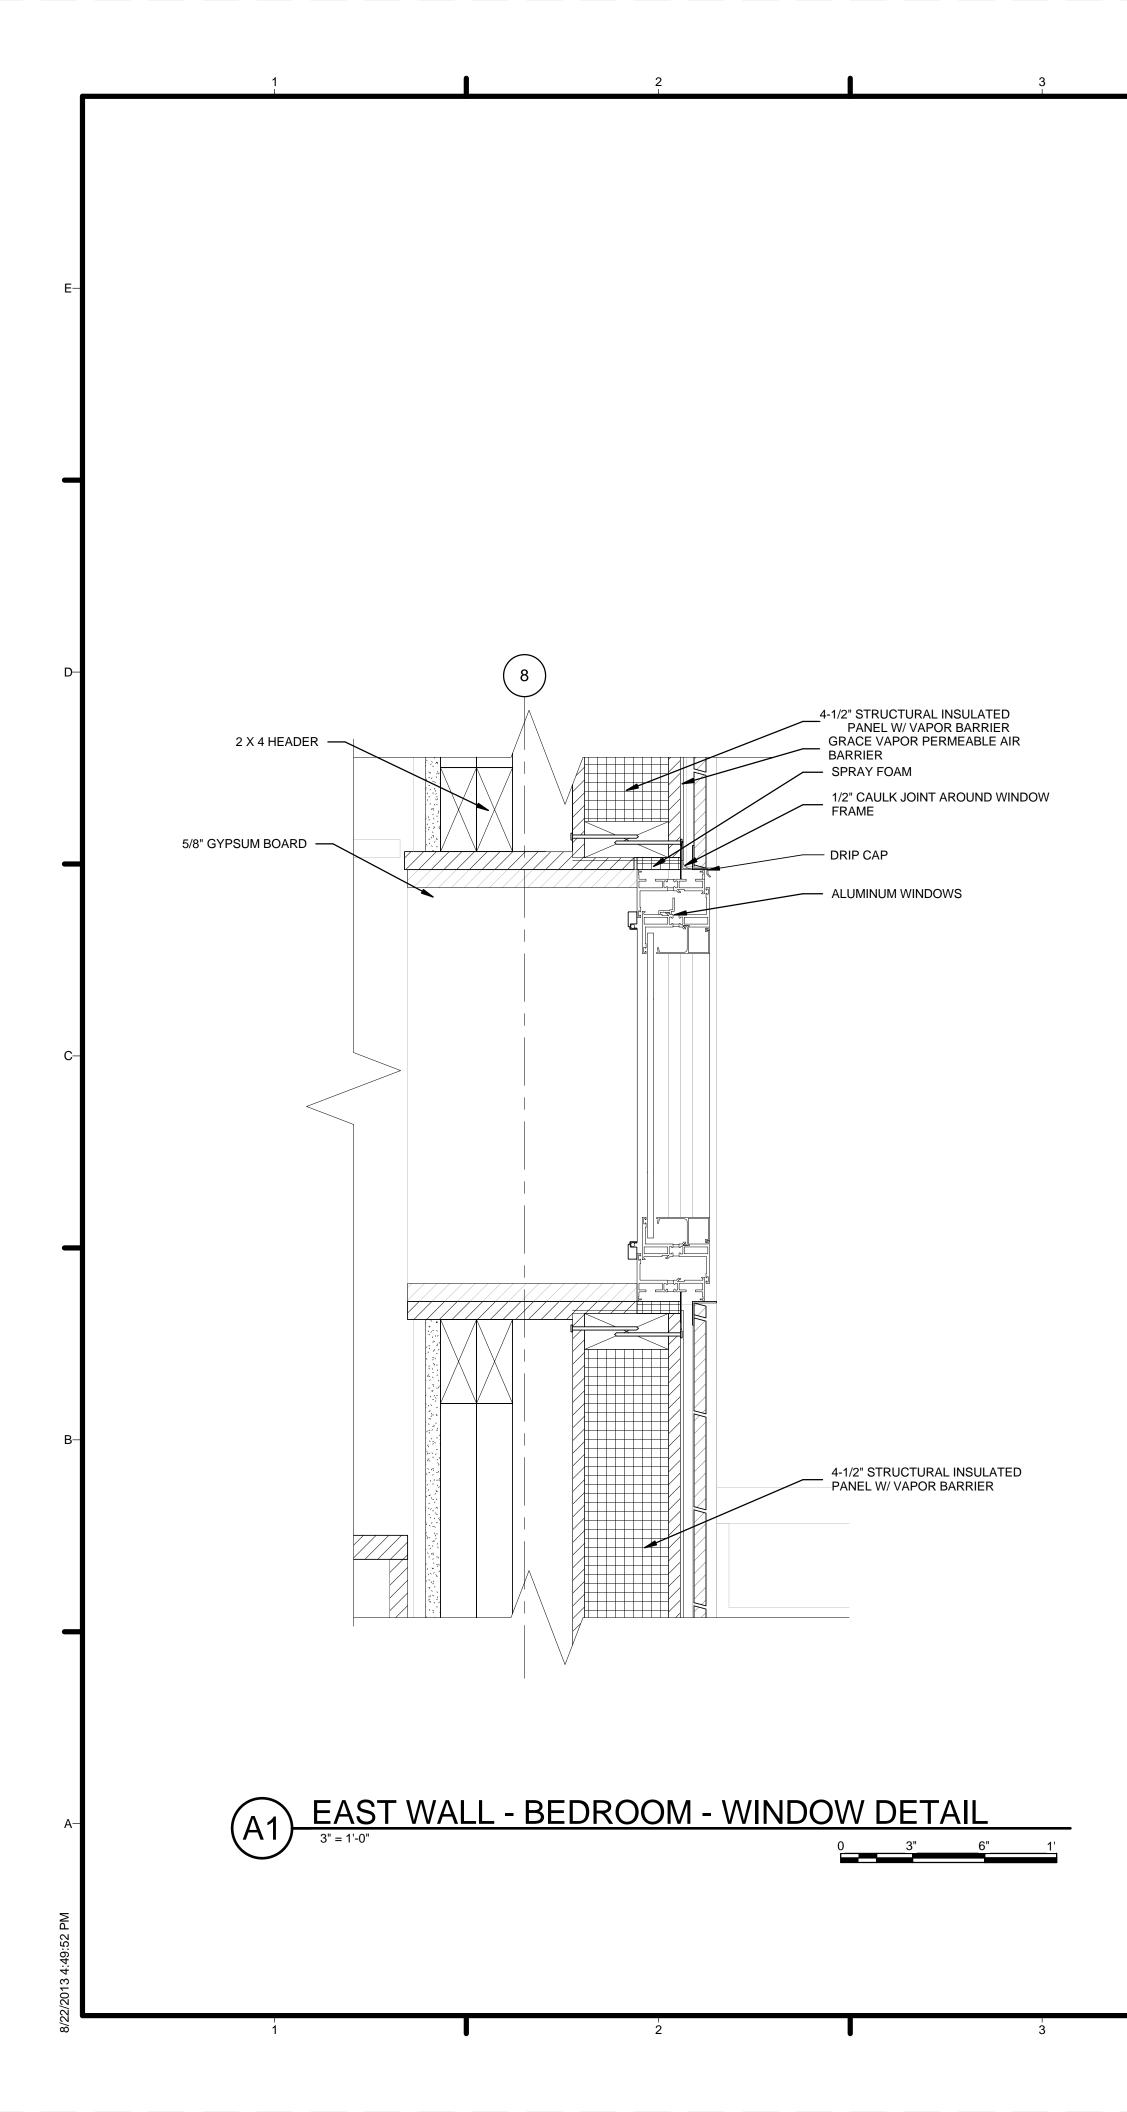
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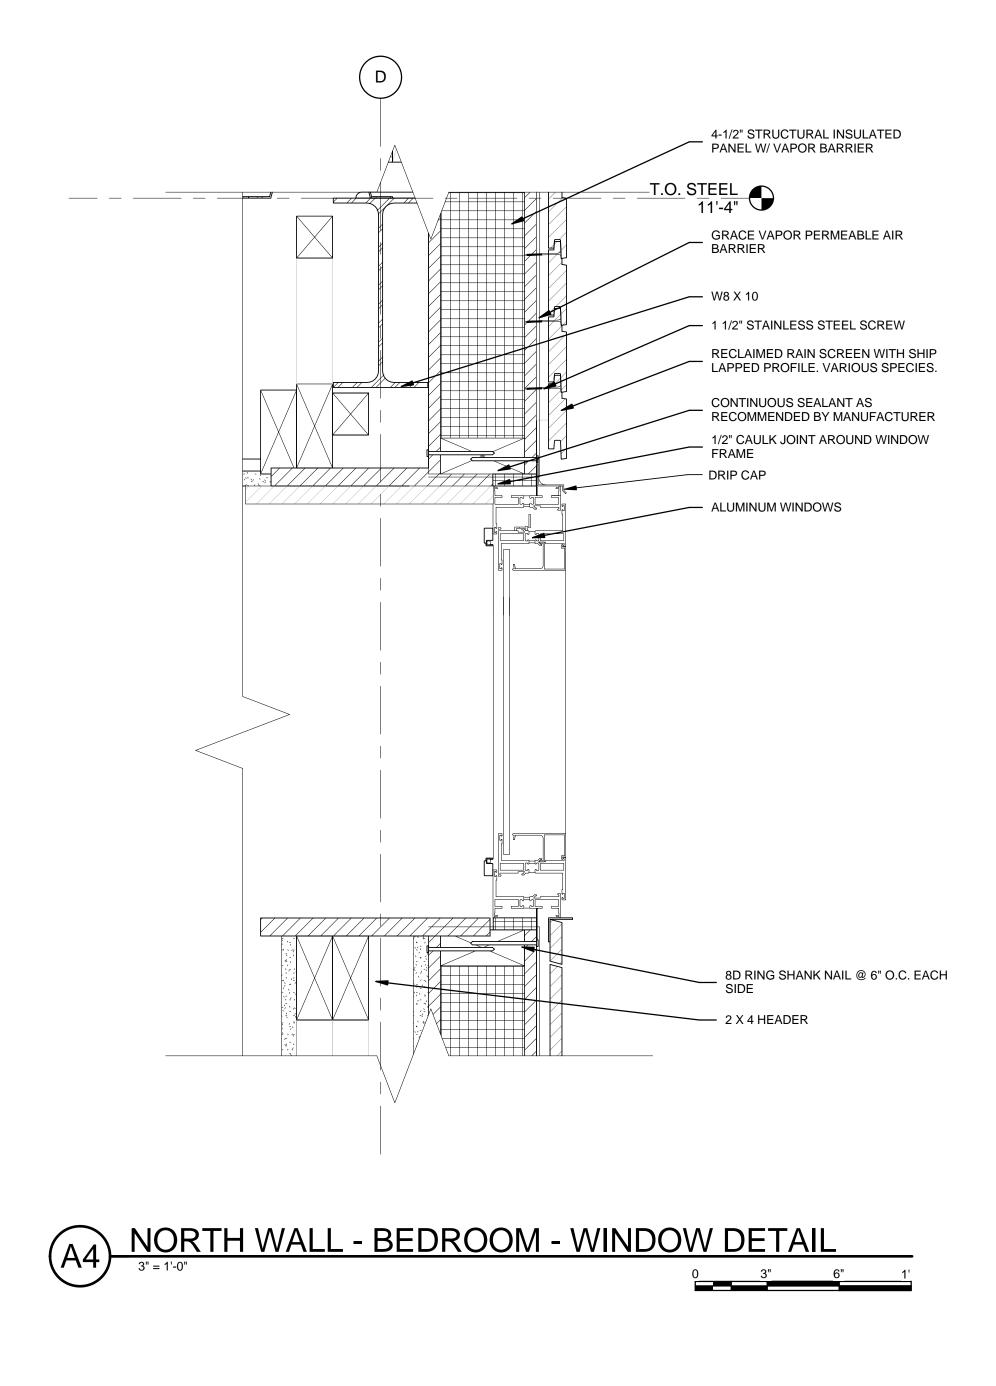
GENERAL SHEET NOTES	1			
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	L	TEAM N	AME:	Team Capitol do
		ADDRES	SS: THE CATHO	DLIC UNIVERSITY OF AMERICA SCHOOL OF ARCHITECTURE 620 MICHIGAN AVENUE, NE.
REFERENCE KEYNOTES				WASHINGTON, DC 20064
		BOB	URAL ENGINEE ALLISON, PE	
05 12 23.A1 W8 X 10 05 31 23 1-1/2" STEEL DECKING 06 11 00.A3 [2] - 2 X 4 FRAMING @ 24" O.C.		1120	P ENGINEERING CONNECTICUT NUE, NW., SUITE	
06 11 00.A3 [2] 2 X 4 HEADER 06 11 00.F1 1/2 X 1 WOOD FURRING	-D	-	HINGTON, DC 2 202.729.8220	0036
06 12 00.A2 4-1/2" STRUCTURAL INSULATED PANEL W/ VAPOR BARRIER		ARU	P ENGINEERING	
07 10 01GRACE VAPOR PERMEABLE AIR BARRIER07 53 23ADHERED 60 MIL EPDM ROOF MEMBRANE07 53 24FS BONDING ADHESIVE		AVEN WAS	NUE, NW., SUITI HINGTON, DC 2 202.729.8220	E 200
07 62 00.A5 .040 PF ALUM COPING 07 71 14 1/4" DENSDECK PRIME		ARCHIT	ECT OF RECOR IAM JELEN, AIA	
07 71 15QUICKSEAM RPF STRIP07 71 16QUICKPRIME PLUS07 71 17FIRESTONE FASTENER AND 2" METAL PLATE		620 N CRO	MICHIGAN AVE UGH CENTER HINGTON, DC 2	NE
@ 12" 0.C.08 11 16 ALUMINUM DOORS AND FRAMES	┝		202.344.5513	
09 29 10.A3 5/8" GYPSUM BOARD				
	–C	CLIENT		
SHEET KEYNOTES				TMENT OF ENERGY ECATHLON 2013
			WWW.SOLA	RDECATHLON.GOV
01 6" SIPLD SCREWS WITH MINIMUM 1" PENETRATION INTO WOOD MEMBER @ 24" O.C. MAXIMUM			VV	RTMENT OF ENERGY
02 CONTINUOUS SEALANT EACH SIDE OF FRAMING TYP. AS RECOMMENDED BY MANUFACTURER			JULA	K DECATILON
12 3/8" BOLT THRU WOOD MEMBER IN SIP WALL PANEL CONNECTED @ 12" O.C.				
 47 1/2" CAULK JOINT AROUND DOOR FRAME 81 8" SIPLD SCREWS @ 24" O.C. MINIMUM 84 4" WOOD SCREW 				
 84 4 WOOD SCREW 89 SPRAY FOAM 92 1 1/2" STAINLESS STEEL SCREW 				
94 RECLAIMED RAIN SCREEN WITH SHIP LAPPED PROFILE. VARIOUS SPECIES.				
	-В			
		4 3	2013.08.22 2013.02.04	As-Built Submission 100% CD Submission
		2 1	2012.11.20 2012.10.11	80% DD Revisions 80% DD Submission
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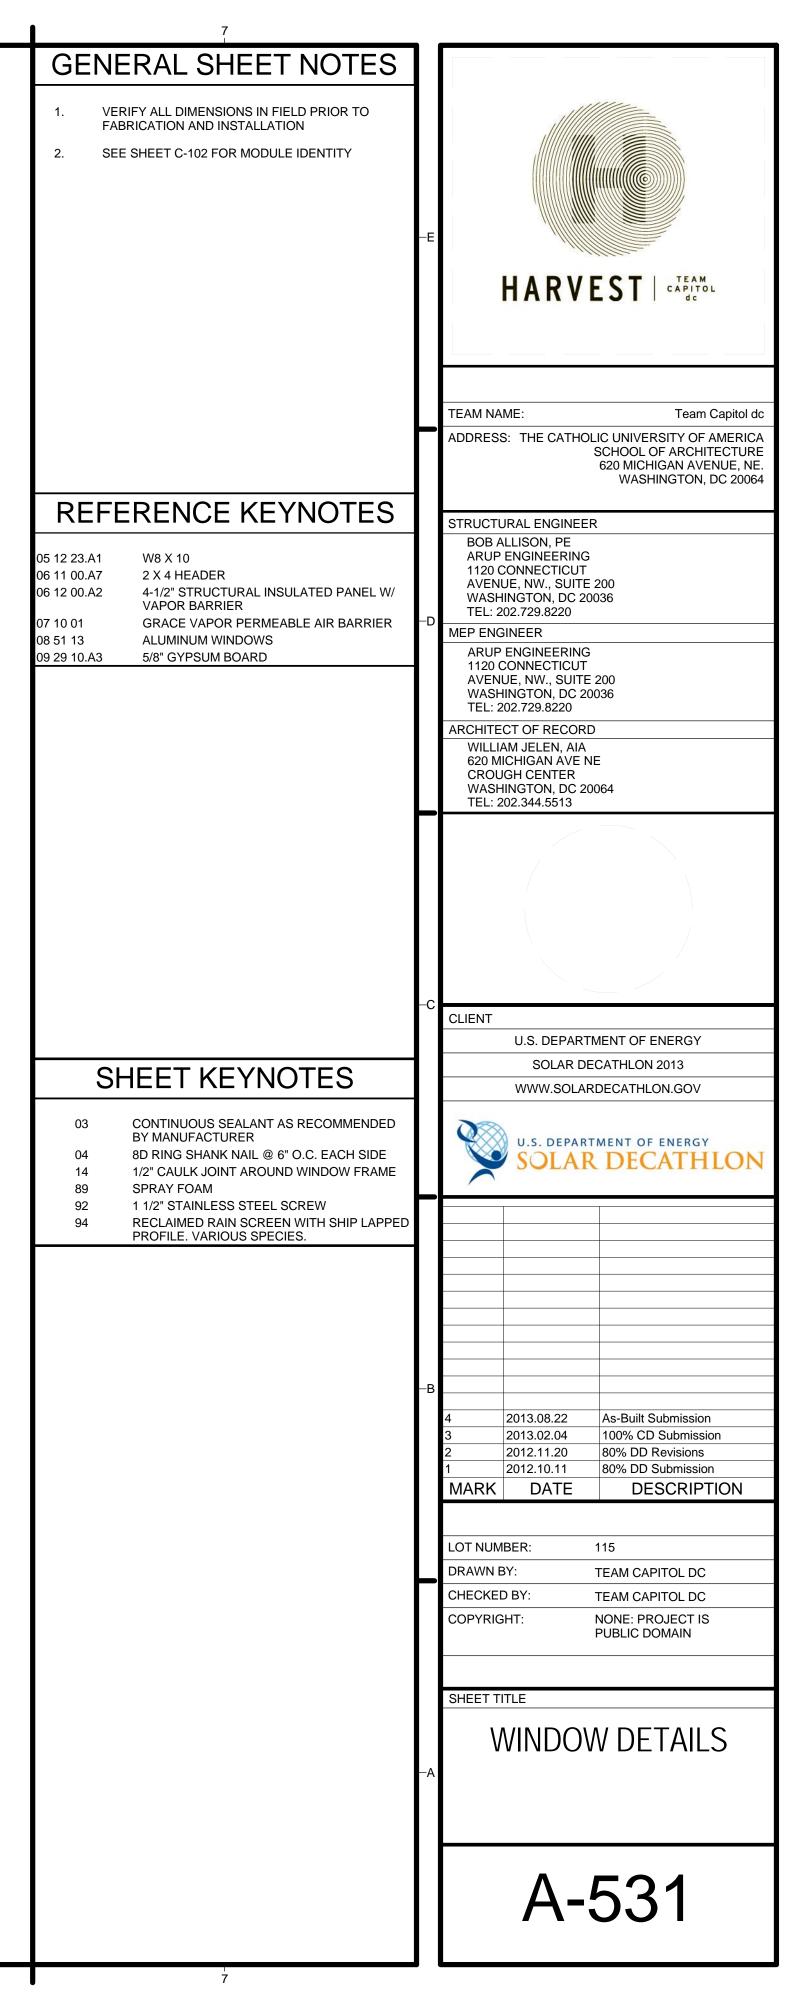


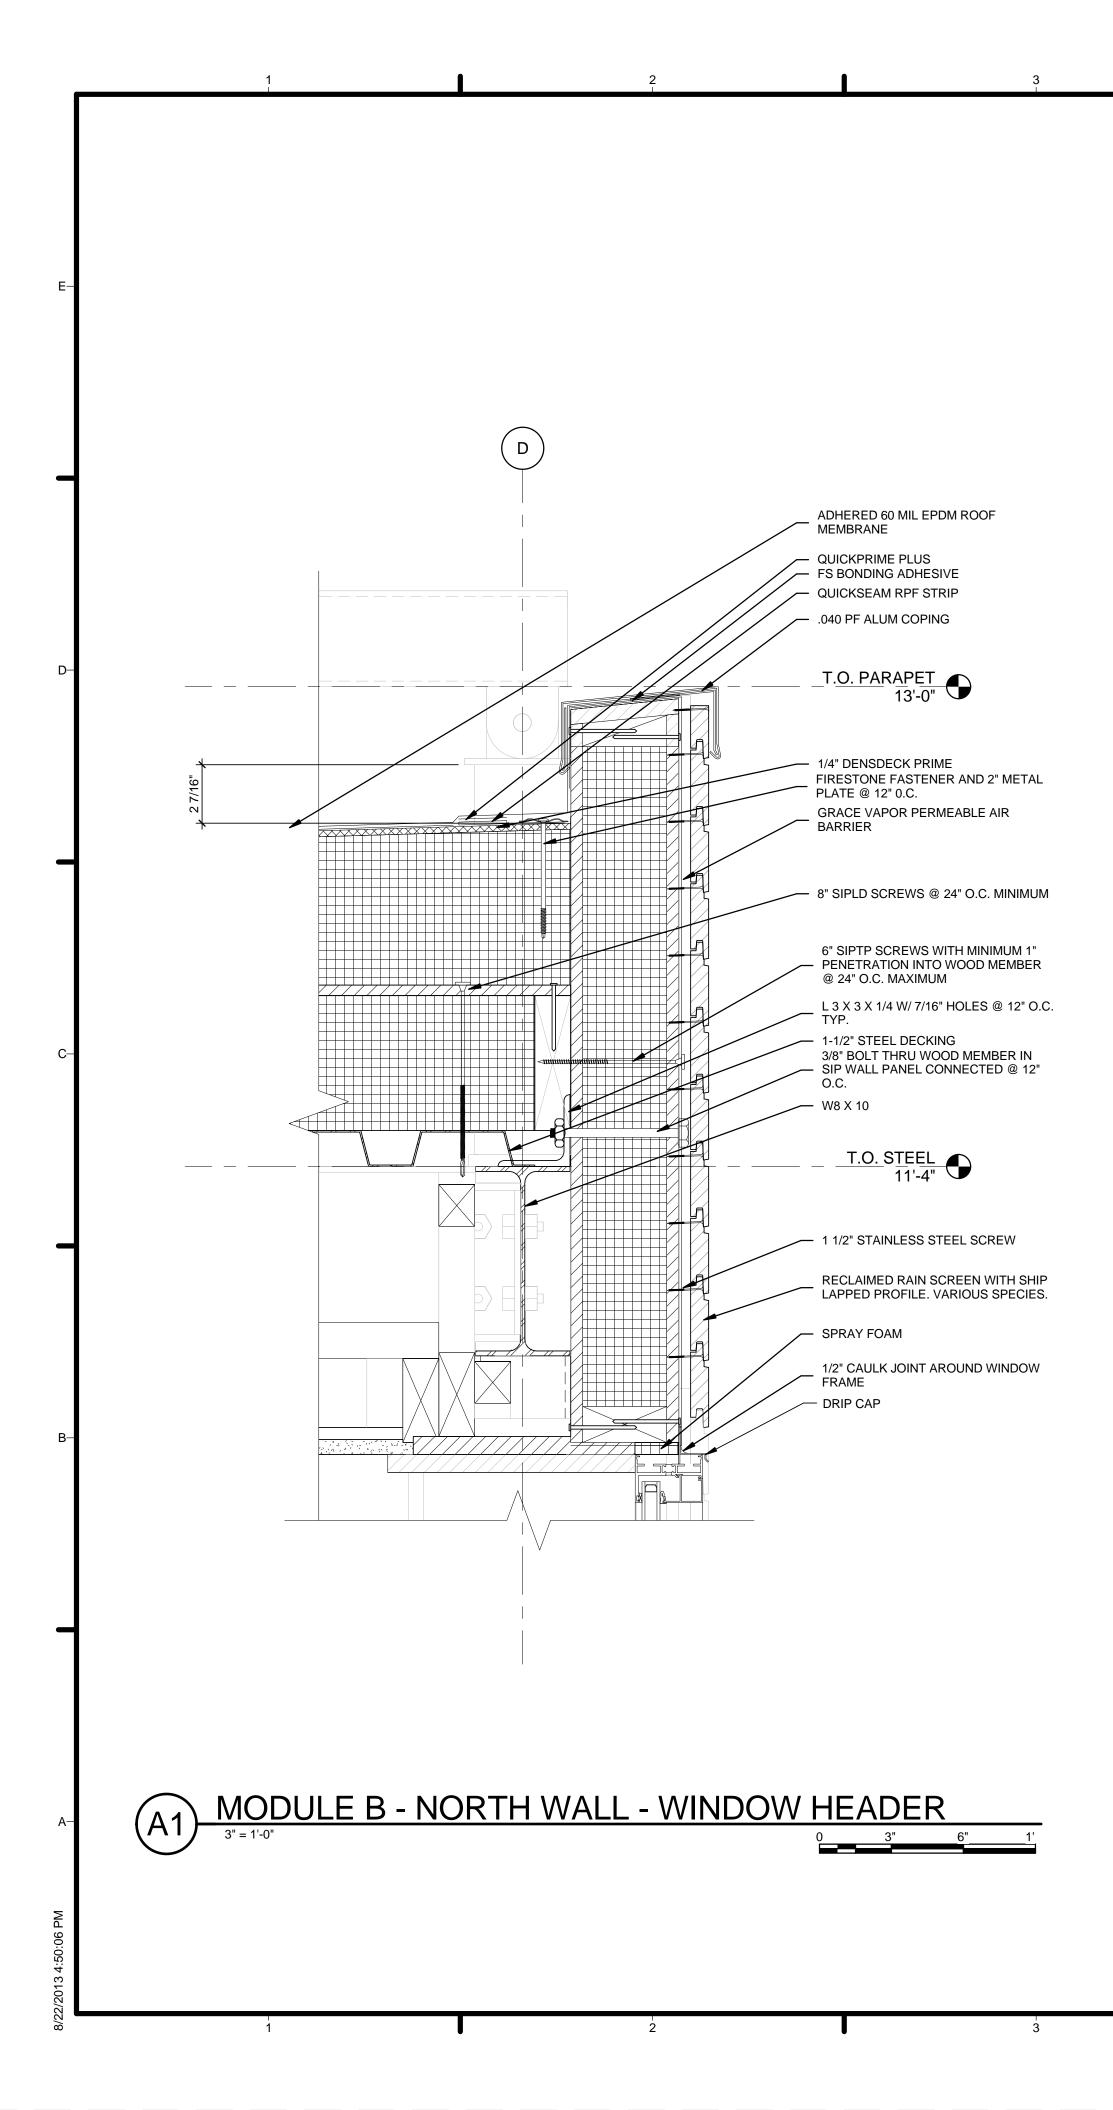


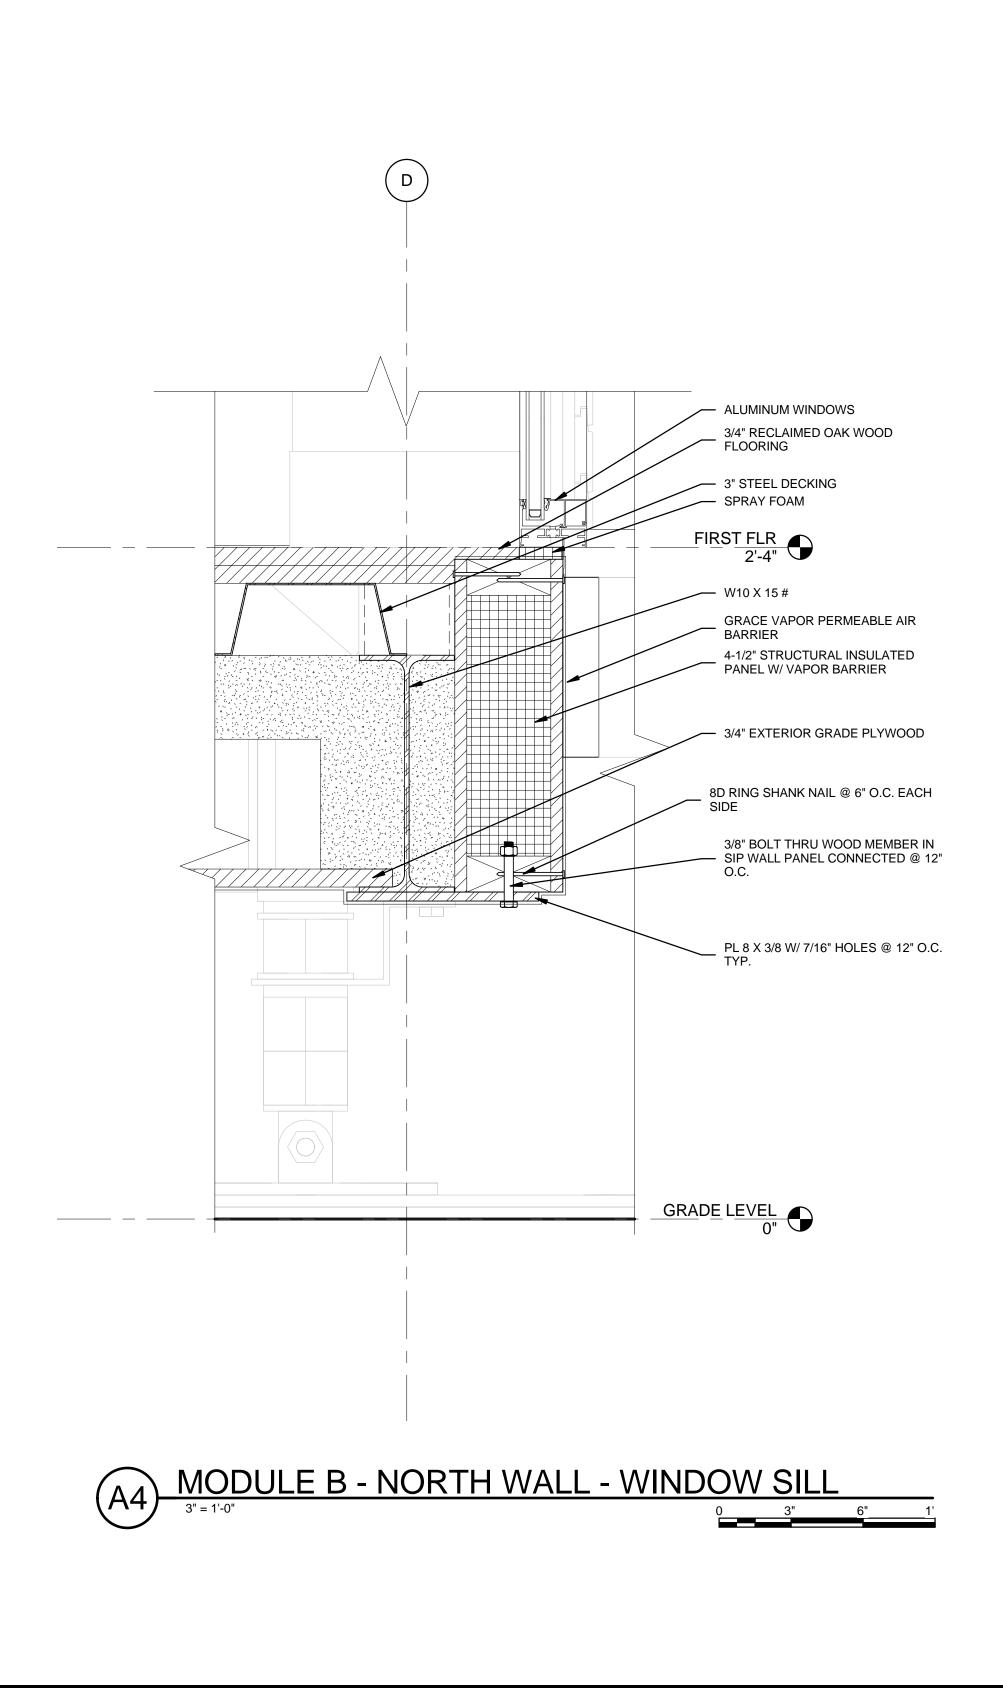
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 VERIFY ALL DIMENSIONS IN FIELD PRIOR TO FABRICATION AND INSTALLATION SEE SHEET C-102 FOR MODULE IDENTITY 	HARVEST CAPITOL
REFERENCE KEYNOTES 05 12 23.D1 STEEL CRANE ATTACHMENT 07 53 23 ADHERED 60 MIL EPDM ROOF MEMBRANE 07 53 23 ADHERED 60 MIL EPDM ROOF MEMBRANE 07 53 24 FS BONDING ADHESIVE 07 53 26 FS POURABLE SEALER 07 62 00.A7 METAL DAM FASTENED TO TOP OF SIPS 07 71 14 1/4" DENSDECK PRIME 07 71 15 QUICKSEAM RPF STRIP 07 71 16 QUICKSEAM PIPE FLASHING 07 71 17 FIRESTONE FASTENER AND 2" METAL PLATE @ 12" 0.C. 07 71 19 07 71 19 QUICKSEAM PIPE FLASHING 07 71 20 CONTINUOUS BEAD OF FS LAP SEALANT 07 71 21 SS CLAMPING BAND 07 71 22 FS WATER BLOCK 07 71 23 QUICK SEAM FORUT TO 3" FROM TOP OF PITCH POCKET 07 71 25 QUICK SEAM FORM FLASH	TEAM NAME: Team Capitol do ADDRESS: THE CATHOLIC UNIVERSITY OF AMERICA SCHOOL OF ARCHITECTURE 620 MICHIGAN AVENUE, NE, WASHINGTON, DC 20064 STRUCTURAL ENGINEER BOB ALLISON, PE ARUP ENGINEERING 1120 CONNECTICUT AVENUE, NW., SUITE 200 WASHINGTON, DC 20036 TEL: 202.729.8220 MEP ENGINEER ARUP ENGINEERING 1120 CONNECTICUT AVENUE, NW., SUITE 200 WASHINGTON, DC 20036 TEL: 202.729.8220 MEP ENGINEER ARUP ENGINEERRING 1120 CONNECTICUT AVENUE, NW., SUITE 200 WASHINGTON, DC 20036 TEL: 202.729.8220 ARCHITECT OF RECORD WILLIAM JELEN, AIA 620 MICHIGAN AVE NE CROUGH CENTER WASHINGTON, DC 20064 TEL: 202.344.5513
SHEET KEYNOTES	-C CLIENT U.S. DEPARTMENT OF ENERGY SOLAR DECATHLON 2013 WWW.SOLARDECATHLON.GOV U.S. DEPARTMENT OF ENERGY SOLAR DECATHLON
	-B -B 4 2013.08.22 As-Built Submission MARK DATE DESCRIPTION LOT NUMBER: 115 DRAWN BY: TEAM CAPITOL DC CHECKED BY: TEAM CAPITOL DC CHECKED BY: TEAM CAPITOL DC COPYRIGHT: NONE: PROJECT IS PUBLIC DOMAIN
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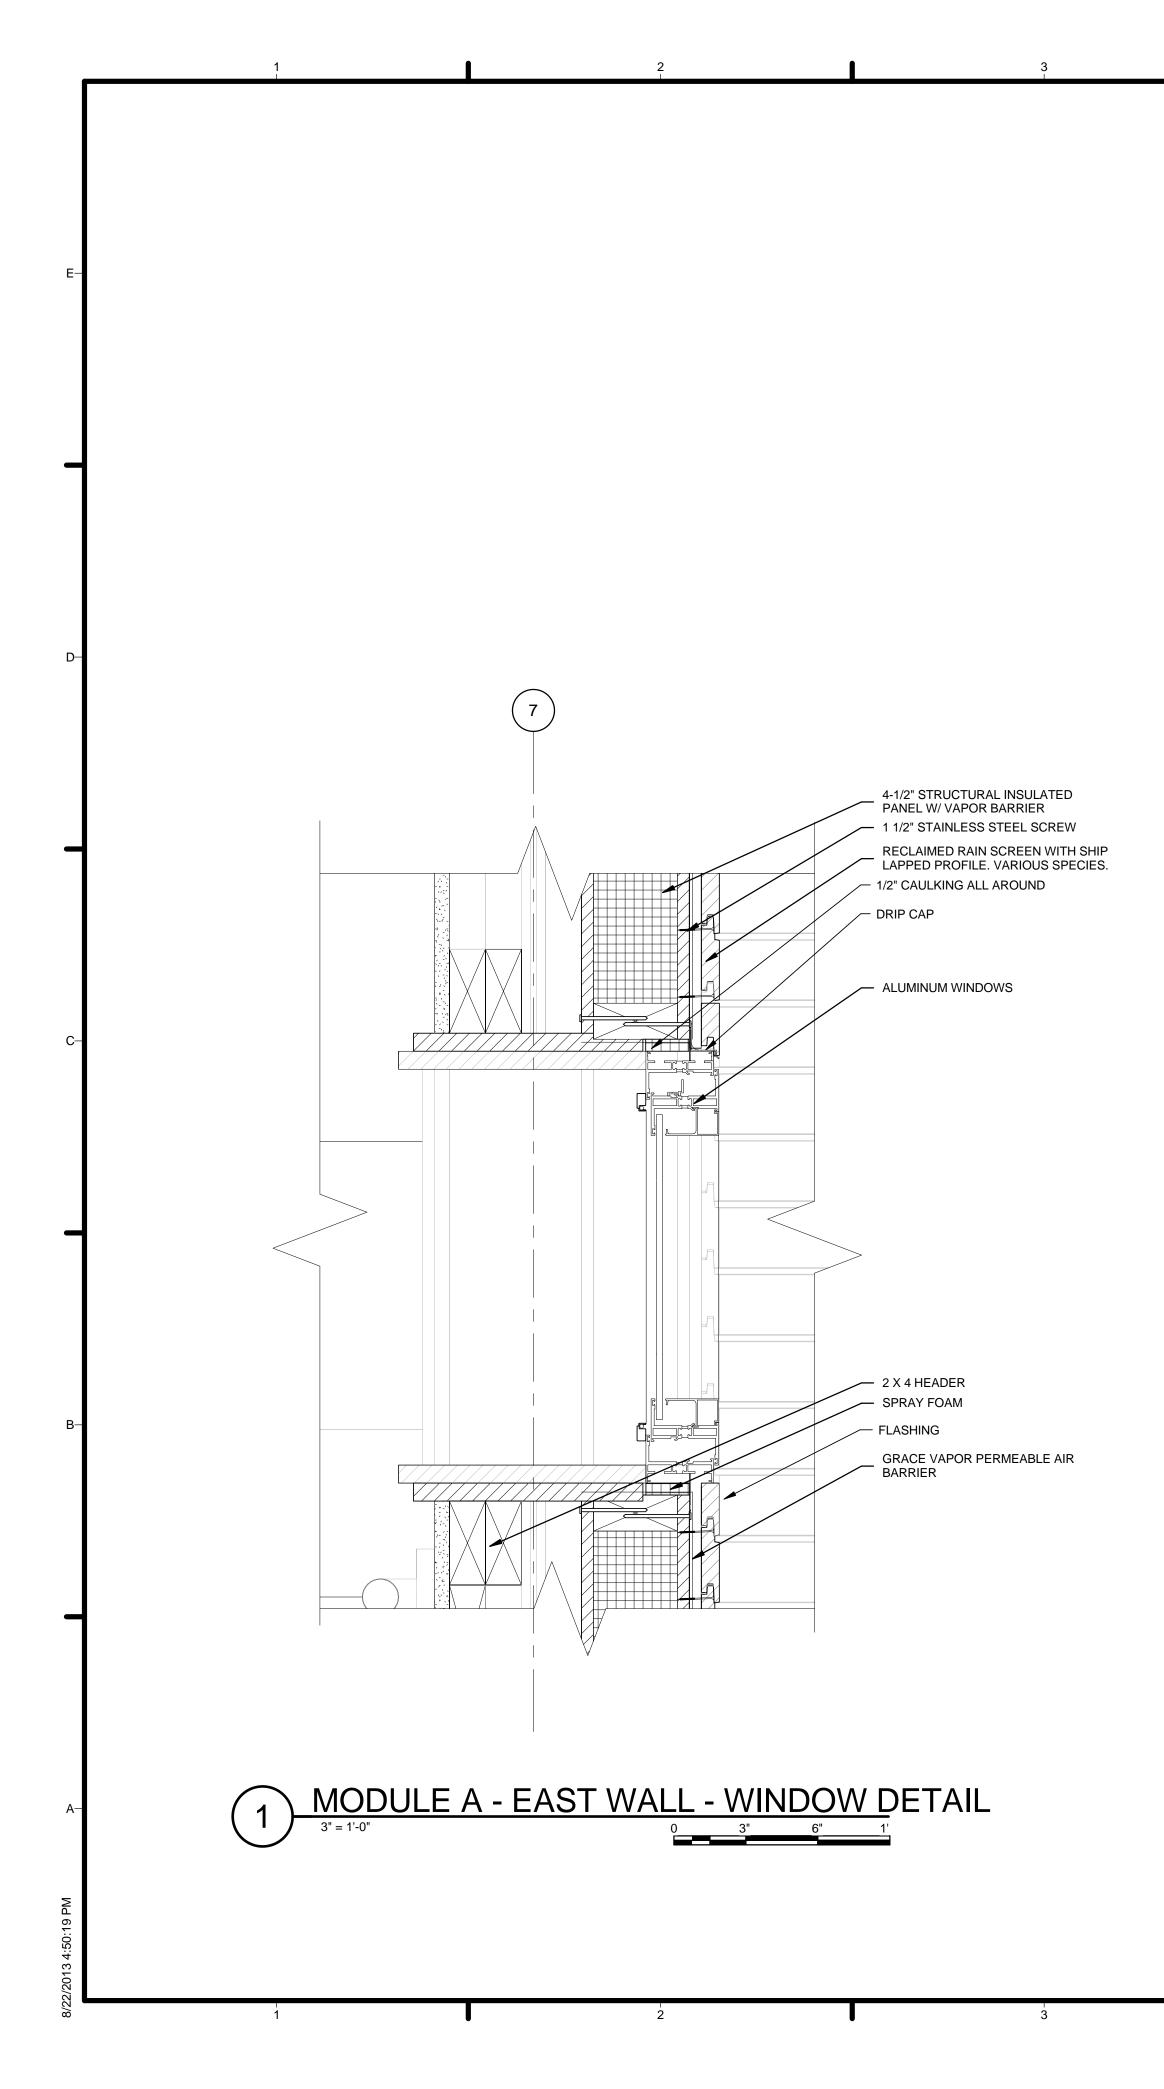






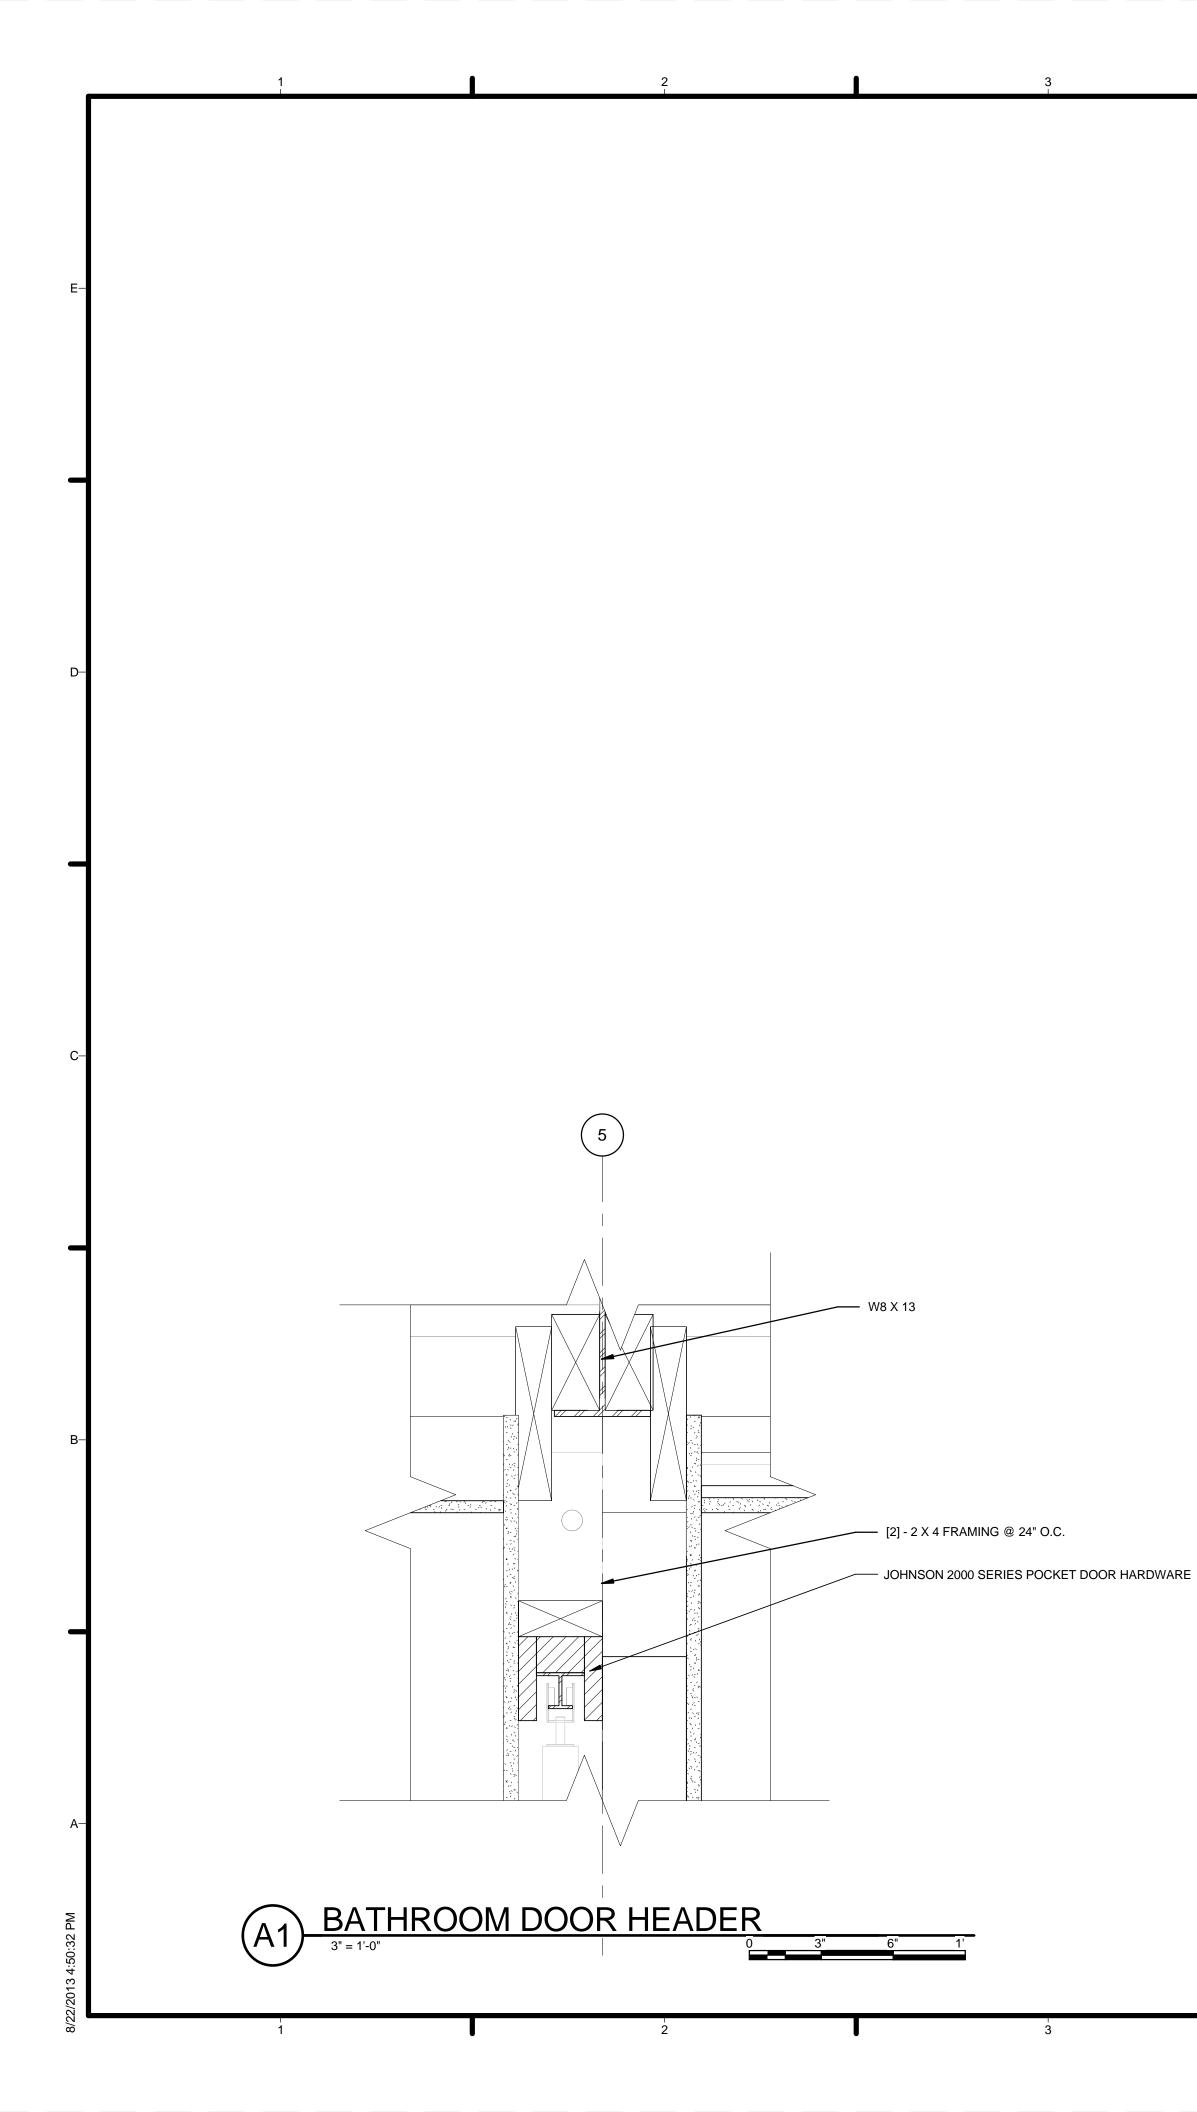


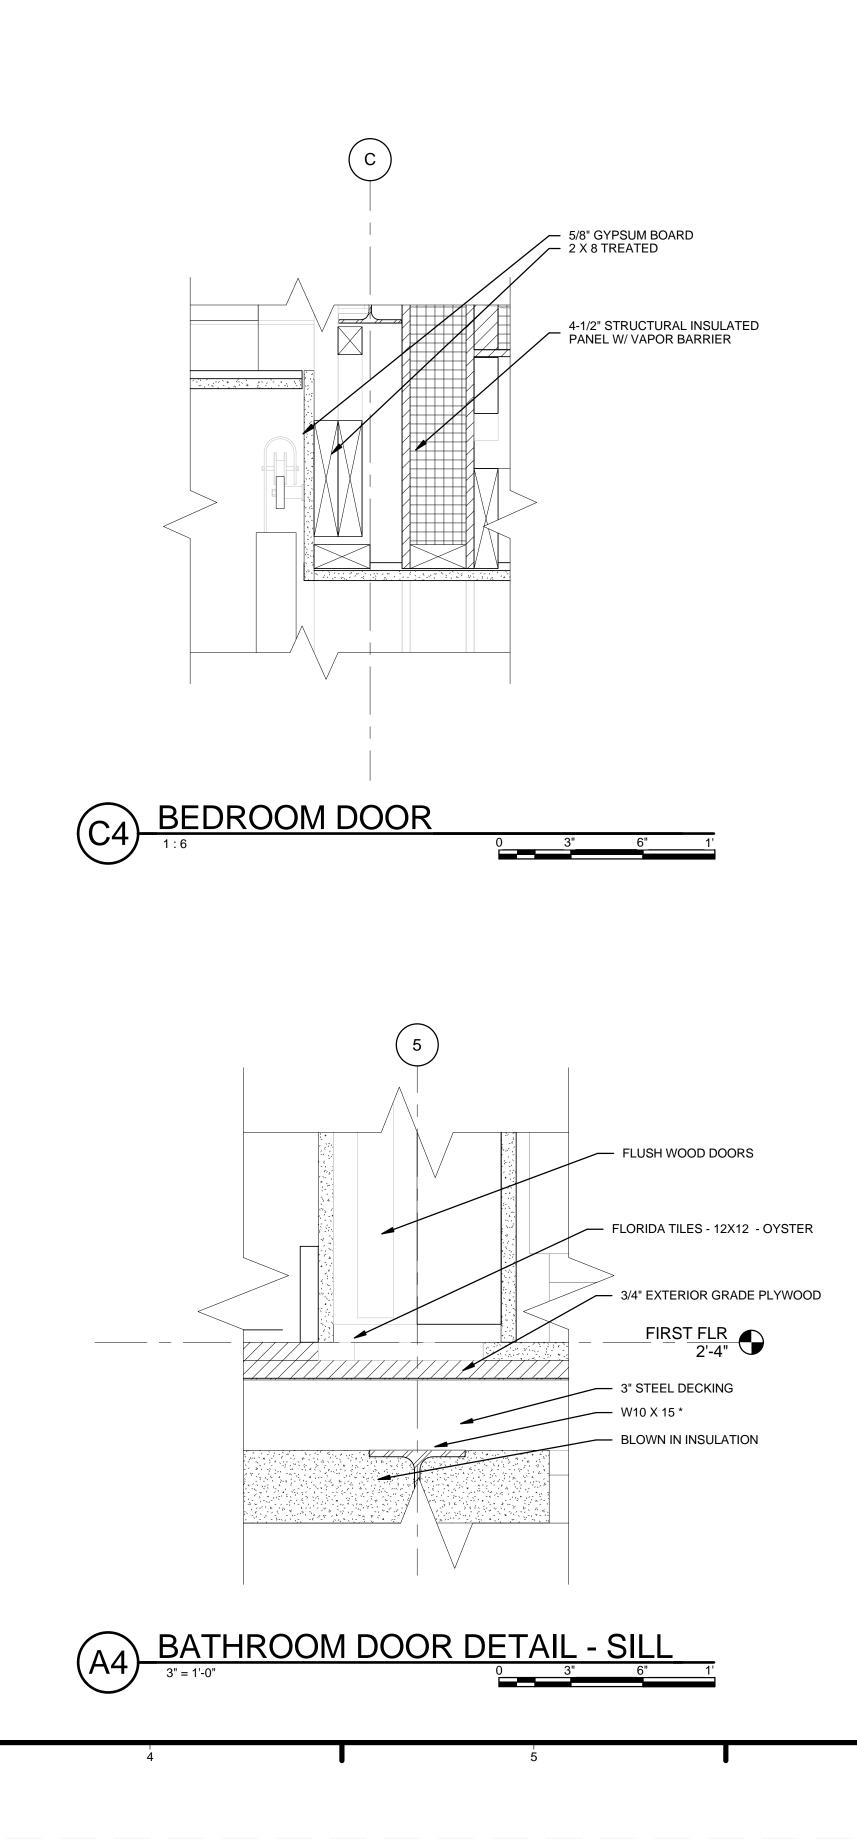
7 GENERAL SHEET NOTES		
 VERIFY ALL DIMENSIONS IN FIELD PRIOR TO FABRICATION AND INSTALLATION SEE SHEET C-102 FOR MODULE IDENTITY 	—E	
REFERENCE KEYNOTES 05 12 23.A1 W8 X 10 05 12 23.A1 W10 X 15 # 05 12 23.C5 PL 8 X 3/8 W/ 7/16" HOLES @ 12" O.C. TYP. 05 12 23.C6 L 3 X 3 X 1/4 W/ 7/16" HOLES @ 12" O.C. TYP. 05 12 23.C6 L 3 X 3 X 1/4 W/ 7/16" HOLES @ 12" O.C. TYP. 05 31 12 3" STEEL DECKING 06 12 00.A2 4-1/2" STRUCTURAL INSULATED PANEL W/ VAPOR BARRIER 06 16 00.B3 3/4" EXTERIOR GRADE PLYWOOD 07 10 01 GRACE VAPOR PERMEABLE AIR BARRIER 07 53 23 ADHERED 60 MIL EPDM ROOF MEMBRANE 07 53 24 FS BONDING ADHESIVE 07 62 00.A5 .040 PF ALUM COPING	-D	MEP ENGINEER ARUP ENGINEERING 1120 CONNECTICUT AVENUE, NW., SUITE 200 WASHINGTON, DC 20036 TEL: 202.729.8220 ARCHITECT OF RECORD WILLIAM JELEN, AIA 620 MICHIGAN AVE NE
07 71 14 1/4" DENSDECK PRIME 07 71 15 QUICKSEAM RPF STRIP 07 71 16 QUICKPRIME PLUS 07 71 17 FIRESTONE FASTENER AND 2" METAL PLATE @ 12" 0.C. 08 51 13 ALUMINUM WINDOWS 09 64 29 3/4" RECLAIMED OAK WOOD FLOORING SHEET KEYNOTES 04 8D RING SHANK NAIL @ 6" O.C. EACH SIDE 12 3/8" BOLT THRU WOOD MEMBER IN SIP WALL PANEL CONNECTED @ 12" O.C. 14 1/2" CAULK JOINT AROUND WINDOW FRAME	Υ Υ	CROUGH CENTER WASHINGTON, DC 20064 TEL: 202.344.5513 CLIENT U.S. DEPARTMENT OF ENERGY SOLAR DECATHLON 2013 WWW.SOLARDECATHLON.GOV
 81 8" SIPLD SCREWS @ 24" O.C. MINIMUM 82 6" SIPTP SCREWS WITH MINIMUM 1" PENETRATION INTO WOOD MEMBER @ 24" O.C. MAXIMUM 89 SPRAY FOAM 92 1 1/2" STAINLESS STEEL SCREW 94 RECLAIMED RAIN SCREEN WITH SHIP LAPPED PROFILE. VARIOUS SPECIES. 		4 2013.08.22 As-Built Submission 3 2013.02.04 100% CD Submission 2 2012.11.20 80% DD Revisions 1 2012.10.11 80% DD Submission MARK DATE DESCRIPTION LOT NUMBER: 115 DRAWN BY: TEAM CAPITOL DC CHECKED BY: TEAM CAPITOL DC COPYRIGHT: NONE: PROJECT IS PUBLIC DOMAIN SHEET TITLE
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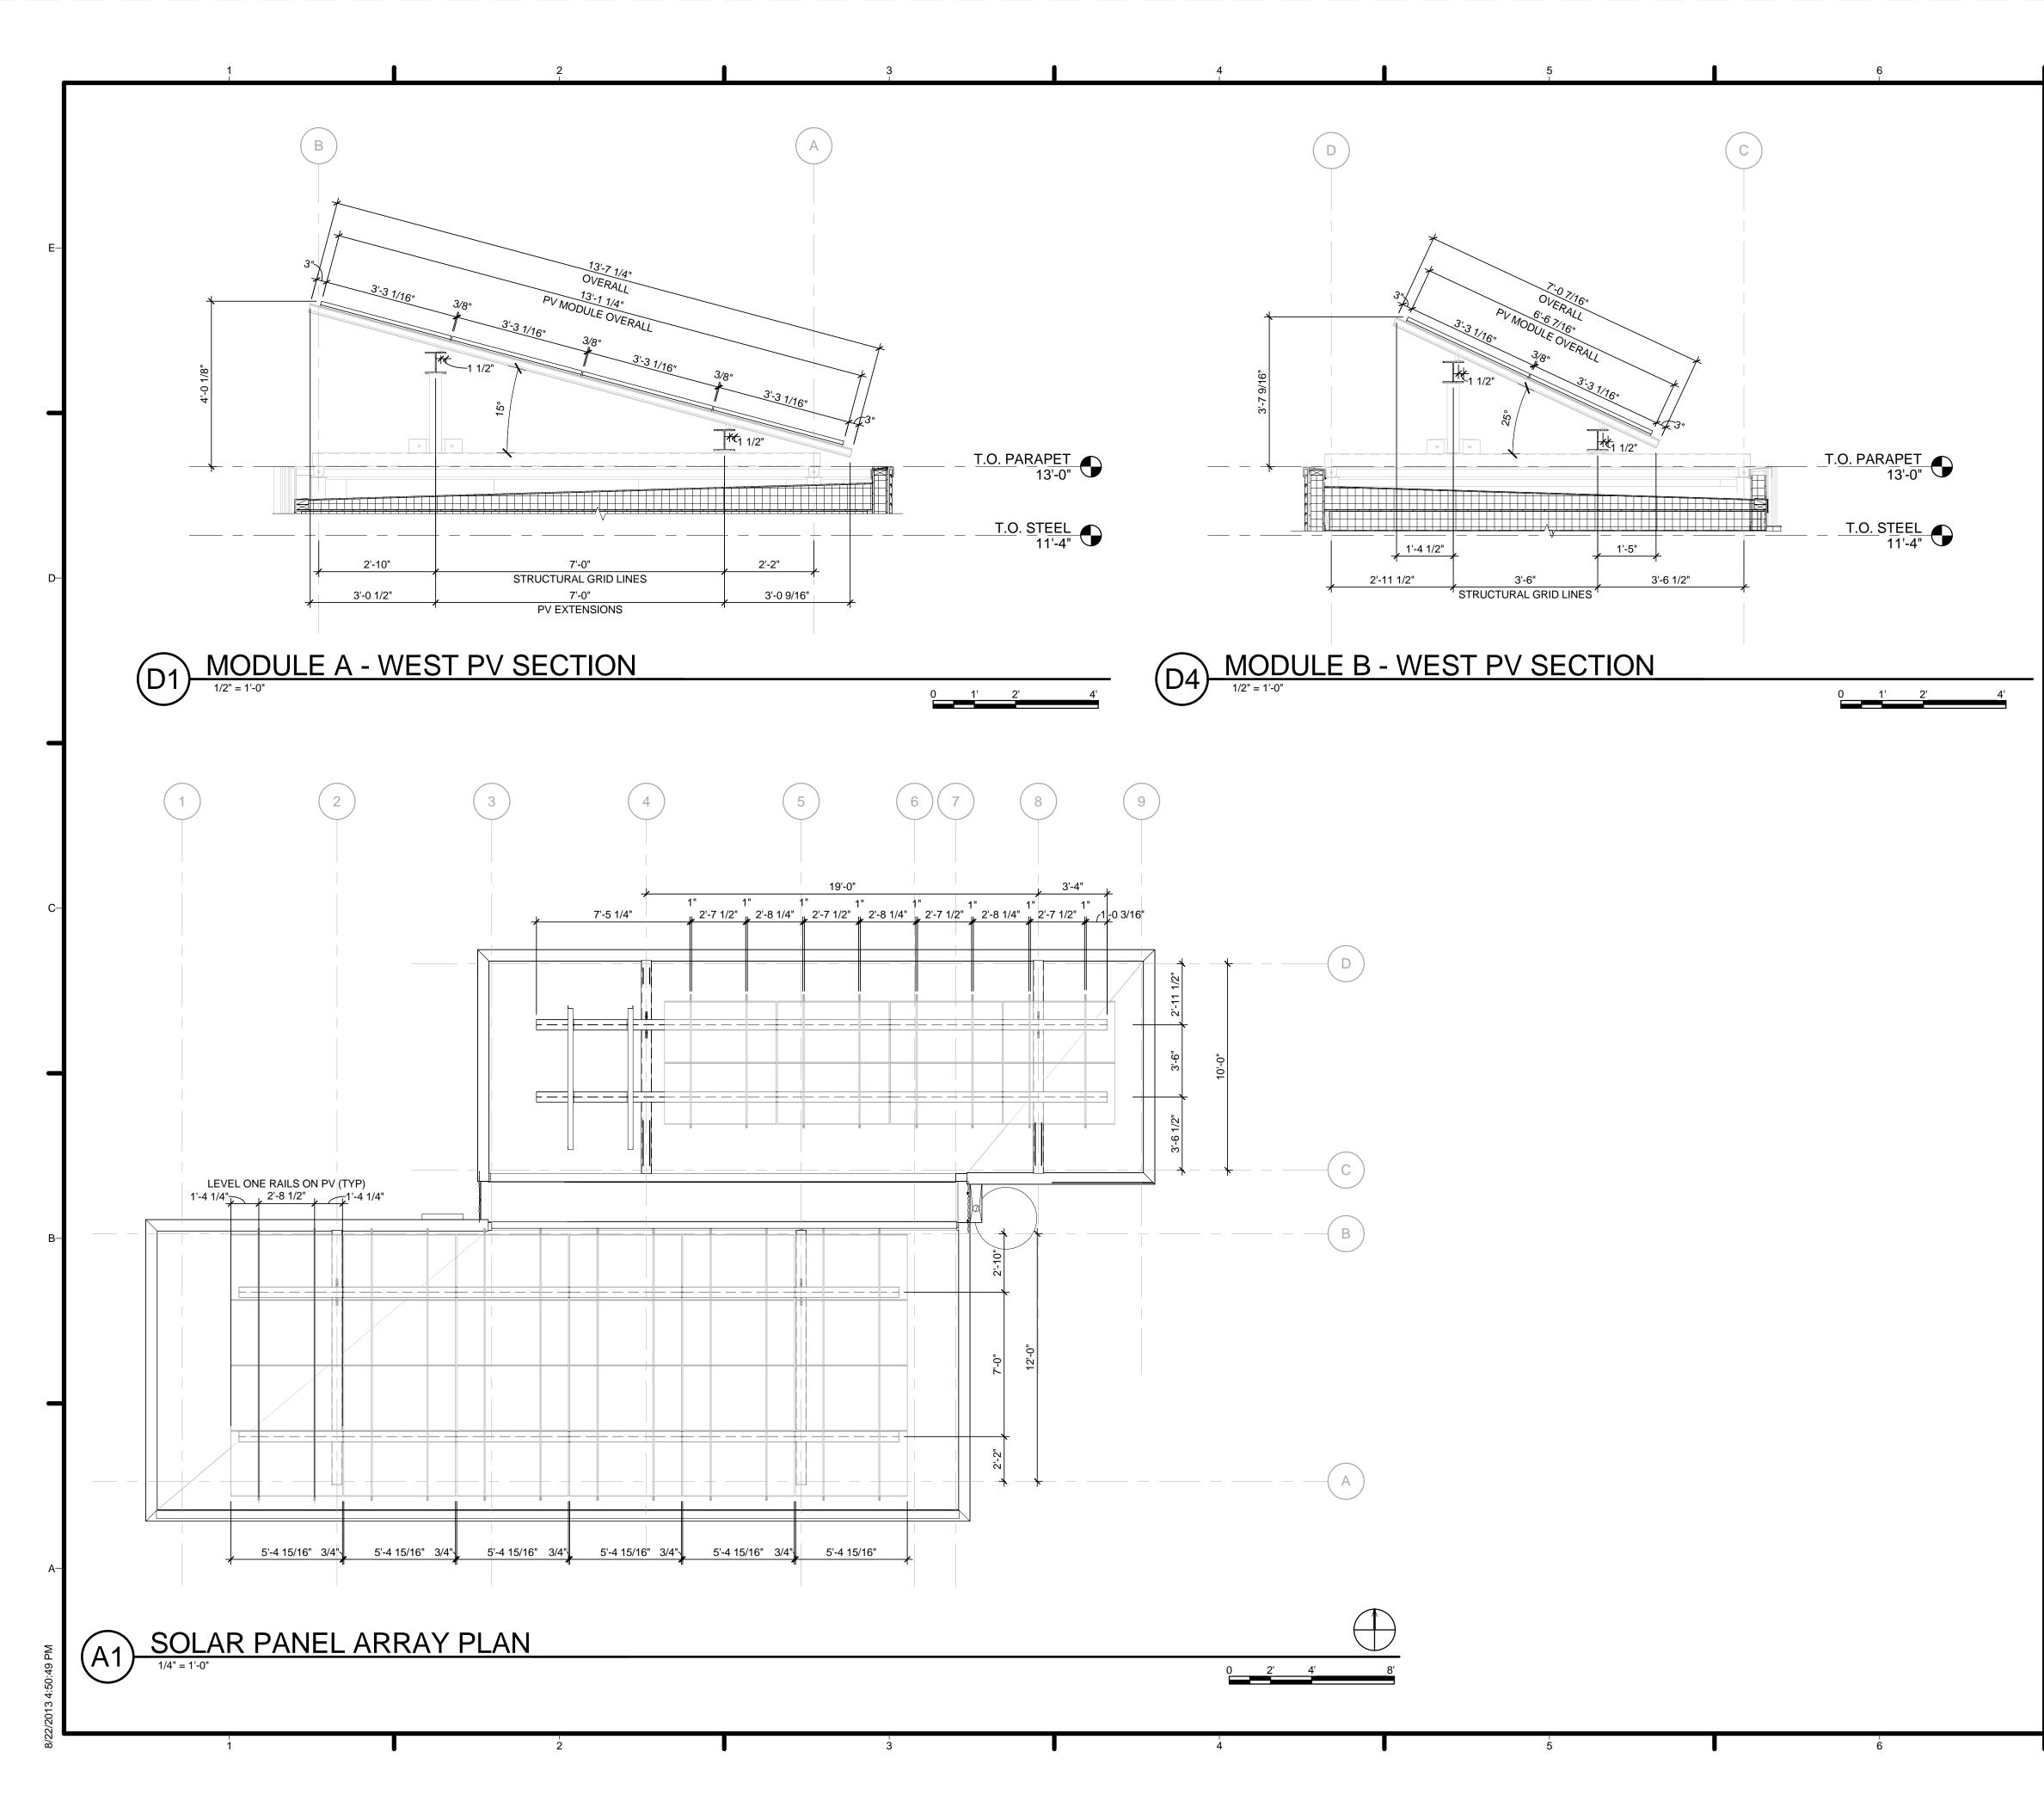
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	TEAM NAME:
REFERENCE KEYNOTES 06 11 00.A7 2 X 4 HEADER 06 12 00.A2 4-1/2" STRUCTURAL INSULATED PANEL W/ VAPOR BARRIER 07 10 01 GRACE VAPOR PERMEABLE AIR BARRIER 08 51 13 ALLIMINUM WINDOW(S)	ADDRESS: THE CATHOLIC UNIVERSITY OF AMERICA SCHOOL OF ARCHITECTURE 620 MICHIGAN AVENUE, NE. WASHINGTON, DC 20064 STRUCTURAL ENGINEER BOB ALLISON, PE ARUP ENGINEERING 1120 CONNECTICUT AVENUE, NW., SUITE 200 WASHINGTON, DC 20036 TEL: 202.729.8220 MEP ENGINEER
	ARUP ENGINEERING 1120 CONNECTICUT AVENUE, NW., SUITE 200 WASHINGTON, DC 20036 TEL: 202.729.8220 ARCHITECT OF RECORD WILLIAM JELEN, AIA 620 MICHIGAN AVE NE CROUGH CENTER WASHINGTON, DC 20064 TEL: 202.344.5513
	CLIENT U.S. DEPARTMENT OF ENERGY SOLAR DECATHLON 2013
89 SPRAY FOAM 92 1 1/2" STAINLESS STEEL SCREW 94 RECLAIMED RAIN SCREEN WITH SHIP LAPPED PROFILE. VARIOUS SPECIES.	WWW.SOLARDECATHLON.GOV
	3 2013.02.04 100% CD Submission 2 2012.11.20 80% DD Revisions 1 2012.10.11 80% DD Submission MARK DATE DESCRIPTION LOT NUMBER: 115 DRAWN BY: TEAM CAPITOL DC
	CHECKED BY: TEAM CAPITOL DC COPYRIGHT: NONE: PROJECT IS PUBLIC DOMAIN SHEET TITLE WINDOW DETAILS
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 GENERAL SHEET NOTES 1. VERIFY ALL DIMENSIONS IN FIELD PRIOR TO FABRICATION AND INSTALLATION 2. SEE SHEET C-102 FOR MODULE IDENTITY 		
D5 12 23.A2 W8 X 13 05 12 23.A5 W10 X 15 * 05 31 12 3" STEEL DECKING 06 11 00.A3 [2] - 2 X 4 FRAMING @ 24" O.C. 06 11 00.C4 2 X 8 TREATED 06 12 00.A2 4-1/2" STRUCTURAL INSULATED PANEL W/ VAPOR BARRIER 06 16 00.B3 3/4" EXTERIOR GRADE PLYWOOD 07 21 13.A4 BLOWN IN INSULATION 08 14 16 FLUSH WOOD DOORS 09 29 10.A3 5/8" GYPSUM BOARD 09 30 13 FLORIDA TILES - 12X12 - OYSTER		MEP ENGINEER ARUP ENGINEERING 1120 CONNECTICUT AVENUE, NW., SUITE 200 WASHINGTON, DC 20036 TEL: 202.729.8220 ARCHITECT OF RECORD WILLIAM JELEN, AIA 620 MICHIGAN AVE NE CROUGH CENTER WASHINGTON, DC 20064
SHEET KEYNOTES	C	CLIENT U.S. DEPARTMENT OF ENERGY SOLAR DECATHLON 2013 WWW.SOLARDECATHLON.GOV
	-В	A 2013.08.22 As-Built Submission 2 2013.02.04 100% CD Submission 2 2012.11.20 80% DD Revisions 1 2012.10.11 80% DD Submission MARK DATE DESCRIPTION LOT NUMBER: 115 DRAWN BY: TEAM CAPITOL DC CHECKED BY: TEAM CAPITOL DC CHECKED BY: TEAM CAPITOL DC COPYRIGHT: NONE: PROJECT IS PUBLIC DOMAIN
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GENERAL SHEET NOTES	1	
 VERIFY ALL DIMENSIONS IN FIELD PRIOR TO FABRICATION AND INSTALLATION SEE STRUCTURAL DRAWINGS FOR STEEL SUPPORT SYSTEM 	E	HARVEST CAPITOL
REFERENCE KEYNOTES		TEAM NAME: Team Capitol dc ADDRESS: THE CATHOLIC UNIVERSITY OF AMERICA SCHOOL OF ARCHITECTURE 620 MICHIGAN AVENUE, NE. WASHINGTON, DC 20064 STRUCTURAL ENGINEER
	-D	BOB ALLISON, PE ARUP ENGINEERING 1120 CONNECTICUT AVENUE, NW., SUITE 200 WASHINGTON, DC 20036 TEL: 202.729.8220 MEP ENGINEER ARUP ENGINEERING 1120 CONNECTICUT AVENUE, NW., SUITE 200 WASHINGTON, DC 20036
		TEL: 202.729.8220 ARCHITECT OF RECORD WILLIAM JELEN, AIA 620 MICHIGAN AVE NE CROUGH CENTER WASHINGTON, DC 20064 TEL: 202.344.5513
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SHEET KEYNOTES		U.S. DEPARTMENT OF ENERGY SOLAR DECATHLON 2013 WWW.SOLARDECATHLON.GOV
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	-В	4 2013.08.22 As-Built Submission 3 2013.02.04 100% CD Submission 2 2012.11.20 80% DD Revisions 1 2012.10.11 80% DD Submission MARK DATE DESCRIPTION
		LOT NUMBER: 115 DRAWN BY: TEAM CAPITOL DC CHECKED BY: TEAM CAPITOL DC COPYRIGHT: NONE: PROJECT IS PUBLIC DOMAIN
	—A	SHEET TITLE PV MOUNTING DETAILS
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			FLOOR SC	CHEDULE			
MARK	MA	NUFACTURER	DE	ESCRIPTION	COMME	NTS Area	
INT		RECLAIMED	2" F	RECLAIMED OAK	BEDROOM	191 SF	
INT		RECLAIMED	2" F	RECLAIMED OAK	LIVING ROOM/KITC	HEN 364 SF	
INT		MOSA TILES	WH	ITE/BEIGE TILES	BATHROOM	48 SF	
INT: 3					•	603 SF	
Grand total: 3						603 SF	
				ROC	OM FINISH SCHE	EDULE	
	ROOM			FINISH			
ROOM NO	NAME	FLOOR	BASE	WALL		CEILING	
101	MECHANICAL	EXPOSED	EXPOSED	EXPOSE	D	EXPOSED	E
102	BEDROOM	RECLAMIED OAK	4" WIDE BY 3/4" BASE PLATE	SHERWIN WILLIAMS (GYB	BD. EXTRA WHITE)	SHERWIN WILLIAMS PAINTED BD., EXTRA WHITE	GYP 8

2

		Wall S	schedule			
Mark	Туре	Fire Rating Structural Usage	Description	Family	Comments	Type Mark
	SD - Ext - 2x4 Cavity	Non-bearing		Basic Wall	BEDROOM OVERHANG	
	SD - Ext - Door Cavity	Non-bearing		Basic Wall	SOUTH CAVITY	
	SD - Ext - Sip 4.5"	Non-bearing		Basic Wall	MECHANICAL ROOM	
	SD - Ext - Sip 4.5"/2X4 Mech	Non-bearing		Basic Wall	MECHANICAL ROOM	
	SD - Ext - SIP - Parapet	Non-bearing		Basic Wall	PARAPET	
	SD - Ext - SIP/2x4	Non-bearing		Basic Wall	BEDROOM/MAIN	
	SD - Ext - SIP/2x4 - 7" Air	Non-bearing		Basic Wall	MAIN SOUTH	
	SD - Ext - SIP/2x4 Bedroom Seperation	Non-bearing		Basic Wall	BEDROOM/MAIN	
	SD - Ext - SIP/2x6	Non-bearing		Basic Wall	MAIN SOUTH	
	SD - Int - 2x4	Non-bearing		Basic Wall	BATHROOM	E

LIVING

KITCHEN

BATHROOM

SHOWER

103

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105

105.A

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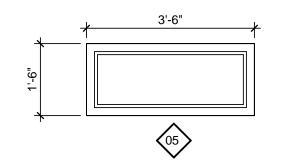
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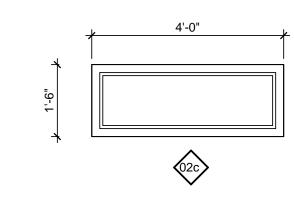
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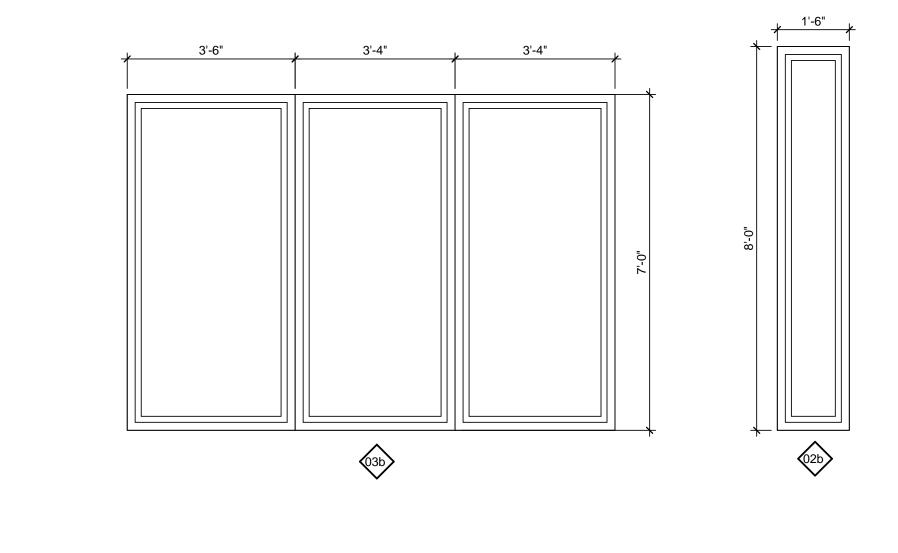
		ROOM FINISH SCHE	DULE			
		CEILING				
FLOOR	BASE	WALL	CEILING	HEIGHT	COMMENTS	Area
EXPOSED	EXPOSED	EXPOSED	EXPOSED	EXPOSED		67 SF
RECLAMIED OAK	4" WIDE BY 3/4" BASE PLATE	SHERWIN WILLIAMS (GYB BD. EXTRA WHITE)	SHERWIN WILLIAMS PAINTED GYP BD., EXTRA WHITE	8'-0"		163 SF
RECLAMIED OAK	4" WIDE BY 3/4" BASE PLATE	SHERWIN WILLIAMS (GYB BD. EXTRA WHITE)	SHERWIN WILLIAMS PAINTED GYP BD., EXTRA WHITE	8'-0"		160 SF
RECLAMIED OAK	4" WIDE BY 3/4" BASE PLATE	SHERWIN WILLIAMS (GYB BD. EXTRA WHITE)	SHERWIN WILLIAMS PAINTED GYP BD., EXTRA WHITE	8'-0"		204 SF
FLORIDA TILES	4" WIDE BY 3/4" BASE PLATE	KEYSTONE PROGETTO CASA, OYSTER)	SHERWIN WILLIAMS PAINTED GYP BD., EXTRA WHITE	8'-0"		47 SF
FLORDIA TILES	N/A	KEYSTONE PROGETTO CASA, OYSTER)	SHERWIN WILLIAMS PAINTED GYP BD., EXTRA WHITE	7'-0"		23 SF

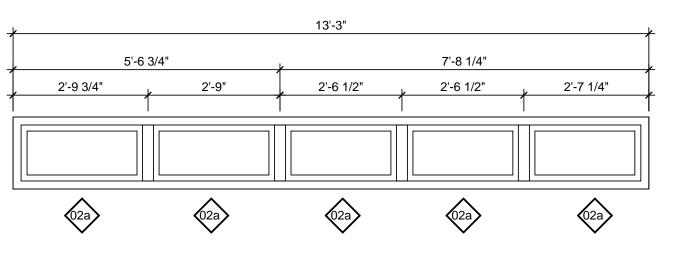
GENERAL SHEET NOTES	3
	-E
	HARVEST
REFERENCE KEYNOTES	TEAM NAME: Team Capitol dc ADDRESS: THE CATHOLIC UNIVERSITY OF AMERICA SCHOOL OF ARCHITECTURE 620 MICHIGAN AVENUE, NE. WASHINGTON, DC 20064
	BOB ALLISON, PE ARUP ENGINEERING 1120 CONNECTICUT AVENUE, NW., SUITE 200 WASHINGTON, DC 20036 TEL: 202.729.8220
	MEP ENGINEER ARUP ENGINEERING 1120 CONNECTICUT AVENUE, NW., SUITE 200 WASHINGTON, DC 20036 TEL: 202.729.8220 ARCHITECT OF RECORD WILLIAM JELEN, AIA
	620 MICHIGAN AVE NE CROUGH CENTER WASHINGTON, DC 20064 TEL: 202.344.5513
SHEET KEYNOTES	-C CLIENT U.S. DEPARTMENT OF ENERGY SOLAR DECATHLON 2013 WWW.SOLARDECATHLON.GOV
	U.S. DEPARTMENT OF ENERGY SOLAR DECATHLON
	Image:
	B A 2013.08.22 As-Built Submission 3 2013.02.04 100% CD Submission 2 2012.11.20 80% DD Revisions 1 2012.10.11 80% DD Submission MARK DATE DESCRIPTION
	LOT NUMBER: 115 DRAWN BY: TEAM CAPITOL DC CHECKED BY: TEAM CAPITOL DC
	COPYRIGHT: NONE: PROJECT IS PUBLIC DOMAIN SHEET TITLE SCHEDULES
	A-601

									WINDOW S	CHEDULE							
		ROUGH OPENING	ROUGH OPENING						DETAIL	DETAIL	DETAIL	GLAZING	GLAZING				
					MANUFAC							THICKNES				HEAD	
MARK	COUNT	WIDTH	HEIGHT	TYPE	TURER	MODEL	MATERIAL	FINISH	HEAD	JAMB	SILL	S	TYPE	U VALUE	SHGC	HEIGHT	COMMENTS
02a	1	13'-3"	1'-6"	WW 5 LITE WINDOW	WESTERN	SERIES 700	ALUMINUM	BRONZE ANODIZED	A-531	A-503/A-504	A-531	1/8"	INSULATED LOW E, SOLARBAN . 70, ARGON GAS FILLED .	45	.18	8'-0"	
02b	1	1'-6"	8'-0"	WW SINGLE FIXED WINDOW	WESTERN	SERIES 700	ALUMINUM	BRONZE ANODIZED	A-532	A-503	A-532	1/8"	INSULATED LOW E, SOLARBAN . 70, ARGON GAS FILLED .	33	.24	8'-0"	
02c	1	4'-0"	1'-6"	WW SINGLE AWNING WINDOW	WESTERN	SERIES 700	ALUMINUM	BRONZE ANODIZED	A-531	A-505	A-531	1/8"	INSULATED LOW E, SOLARBAN . 70, ARGON GAS FILLED	45	.18	4'-10 3/4"	
03a	1	3'-6"	7'-0"	WW SINGLE FIXED WINDOW	WESTERN	SERIES 700	ALUMINUM	BRONZE ANODIZED	A-525	A-502	A-512	1/8"	INSULATED LOW E, SOLARBAN . 70, ARGON GAS FILLED	33	.24	7'-0"	
03b	2	3'-4"	7'-0"	WW SINGLE FIXED WINDOW	WESTERN	SERIES 600	ALUMINUM	BRONZE ANODIZED	A-525	A-502	A-512	1/8"	INSULATED LOW E, SOLARBAN . 70, ARGON GAS FILLED	33	.24	7'-0"	
05	2	3'-6"	1'-6"	WW SINGLE AWNING WINDOW	WESTERN	SERIES 700	ALUMINUM	BRONZE ANODIZED	A-533	A-505	A-533	1/8"	INSULATED LOW E, SOLARBAN . 70, ARGON GAS FILLED	45	.18	4'-10 3/4"	



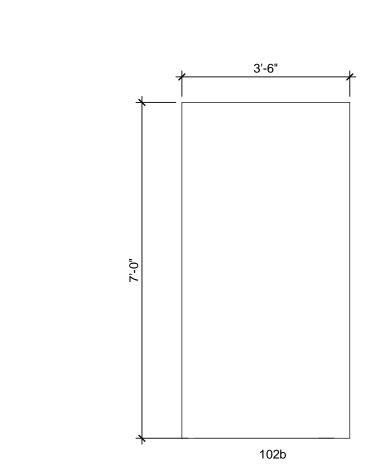


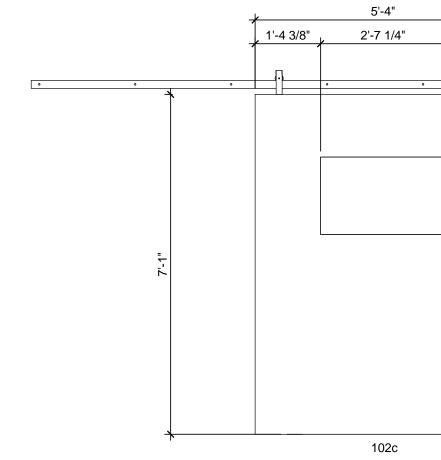


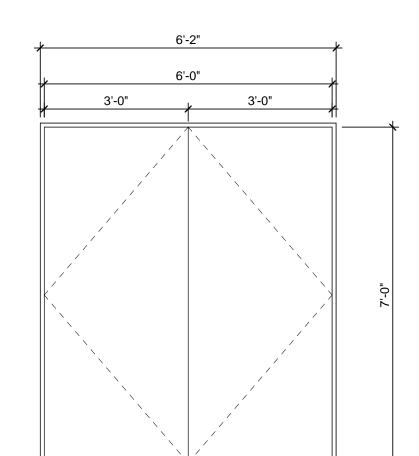


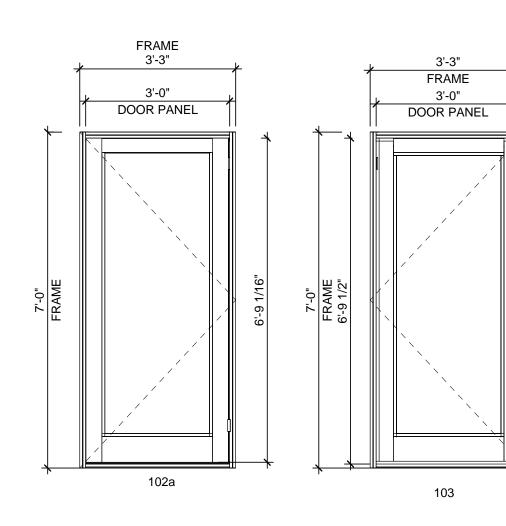
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 VERIFY ALL DIMENSIONS IN FIELD PRIOR TO FABRICATION AND INSTALLATION SEE S-101 FOR FOOTING PLAN 		
	E	HARVEST
		TEAM NAME: Team Capitol dc ADDRESS: THE CATHOLIC UNIVERSITY OF AMERICA SCHOOL OF ARCHITECTURE 620 MICHIGAN AVENUE, NE. WASHINGTON, DC 20064
REFERENCE KEYNOTES	-D	STRUCTURAL ENGINEER BOB ALLISON, PE ARUP ENGINEERING 1120 CONNECTICUT AVENUE, NW., SUITE 200 WASHINGTON, DC 20036 TEL: 202.729.8220 MEP ENGINEER
		ARUP ENGINEERING 1120 CONNECTICUT AVENUE, NW., SUITE 200 WASHINGTON, DC 20036 TEL: 202.729.8220 ARCHITECT OF RECORD WILLIAM JELEN, AIA 620 MICHIGAN AVE NE CROUGH CENTER WASHINGTON, DC 20064
		TEL: 202.344.5513
	-C	CLIENT U.S. DEPARTMENT OF ENERGY SOLAR DECATHLON 2013
SHEET KEYNOTES		U.S. DEPARTMENT OF ENERGY SOLAR DECATHLON
		Image:
	—В	4 2013.08.22 As-Built Submission 3 2013.02.04 100% CD Submission 2 2012.11.20 80% DD Revisions 1 2012.10.11 80% DD Submission MARK DATE DESCRIPTION
		LOT NUMBER:115DRAWN BY:TEAM CAPITOL DCCHECKED BY:TEAM CAPITOL DCCOPYRIGHT:NONE: PROJECT IS PUBLIC DOMAIN
	—A	SHEET TITLE WINDOW SCHEDULE
7		A-602

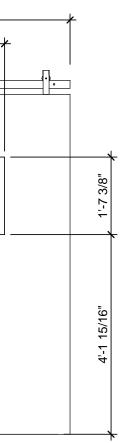
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			1			DOOR SCHEDU				1		1				1. VERIFY ALL DIMENSI FABRICATION AND IN
					FRAME		DETAILS C	DETAILS	DETAILS				FINISH	FINISH	FINISH	
MARK Count	DR TYPE	DR SIZE	MANUFACTURER	MODEL	TYPE	RATING	HEAD	JAMB	SILL	DESCRIPTION	U-VALUE	SH GC	DOOR	FRAME	COMPONENTS	2. SEE S-101 FOR FOOT
101 1	101	72"W x 84"H	CECO	01 18 CRS 60 70 F	STEEL		A-526	A-503	A-512	FLUSH DOUBLE DOOR, 16 GAUGE STEEL	.41	-	SHERWIN WILLIAMS LIME RICKEY	BRONZE ANODIZED	STAINLESS STEEL	
102a 1	102a	39"W x 84"H	WESTERN	SERIES 900	ALUMINUM		A-528	A-504	A-513	INSULATED LOW E, SOLARBAN 70, ARGON GAS FILL	.53	.18	BRONZE ANODIZED	BRONZE ANODIZED	BRONZE ANODIZED	
102b 1	102b	42"W x 84"H	TW PERRY	NA	NA	P P	A-541 SIM	A-507 SIM	A-541 SIM	FLUSH SOLID CORE BIRCH DOOR	N/A	N/A	SHERWIN WILLIAMS EXTRA WHITE	N/A	N/A	
102c 1	108	60"W x 84"H	FABRICATED	FABRICATED	NONE		A-541	NA	NA	FABRICATED	N/A	N/A	SHERWIN WILLIAMS EXTRA WHITE	N/A	N/A	
103 1	103	36"W x 84"H	WESTERN	SERIES 900	ALUMINUM		A-528	A-502	A-515	INSULATED LOW E, SOLARBAN 70, ARGON GAS FILL	.53	.18	BRONZE ANODIZED	BRONZE ANODIZED	BRONZE ANODIZED	
104 1	104	85"W x 84"H	WESTERN	SERIES 600	ALUMINUM		A-521 A	A-505/A-504	A-513	INSULATED LOW E, SOLARBAN 70, ARGON GAS FILL	.41	.23	BRONZE ANODIZED	BRONZE ANODIZED	BRONZE ANODIZED	
104 1	104	85"W x 84"H	WESTERN	SERIES 600	ALUMINUM	A	A-521 SIM A	A-505/A-504	A-513 SIM	INSULATED LOW E, SOLARBAN 70, ARGON GAS FILL	.41	.23	BRONZE ANODIZED	BRONZE ANODIZED	BRONZE ANODIZED	
105 1	105	36"W x 84"H	TW PERRY	NA	NA		A-541	A-507	A-541	FLUSH SOLID CORE BIRCH DOOR	N/A	N/A	SHERWIN WILLIAMS EXTRA WHITE	N/A	N/A	

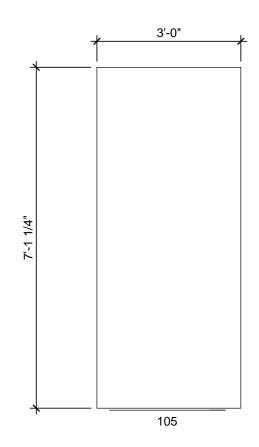


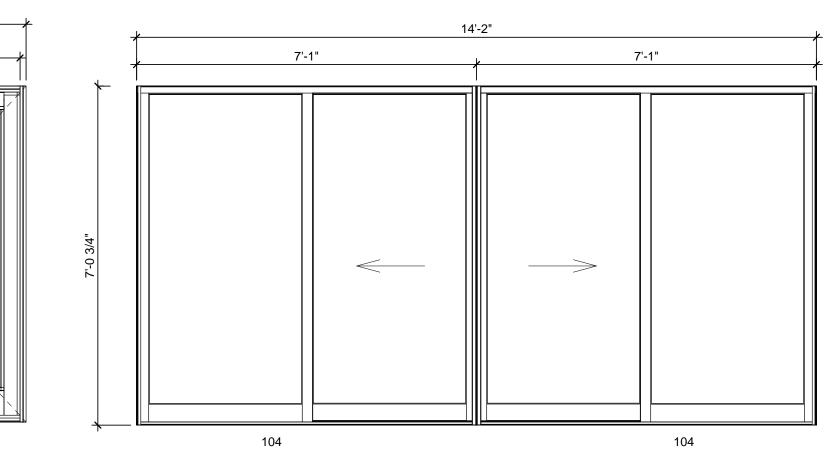




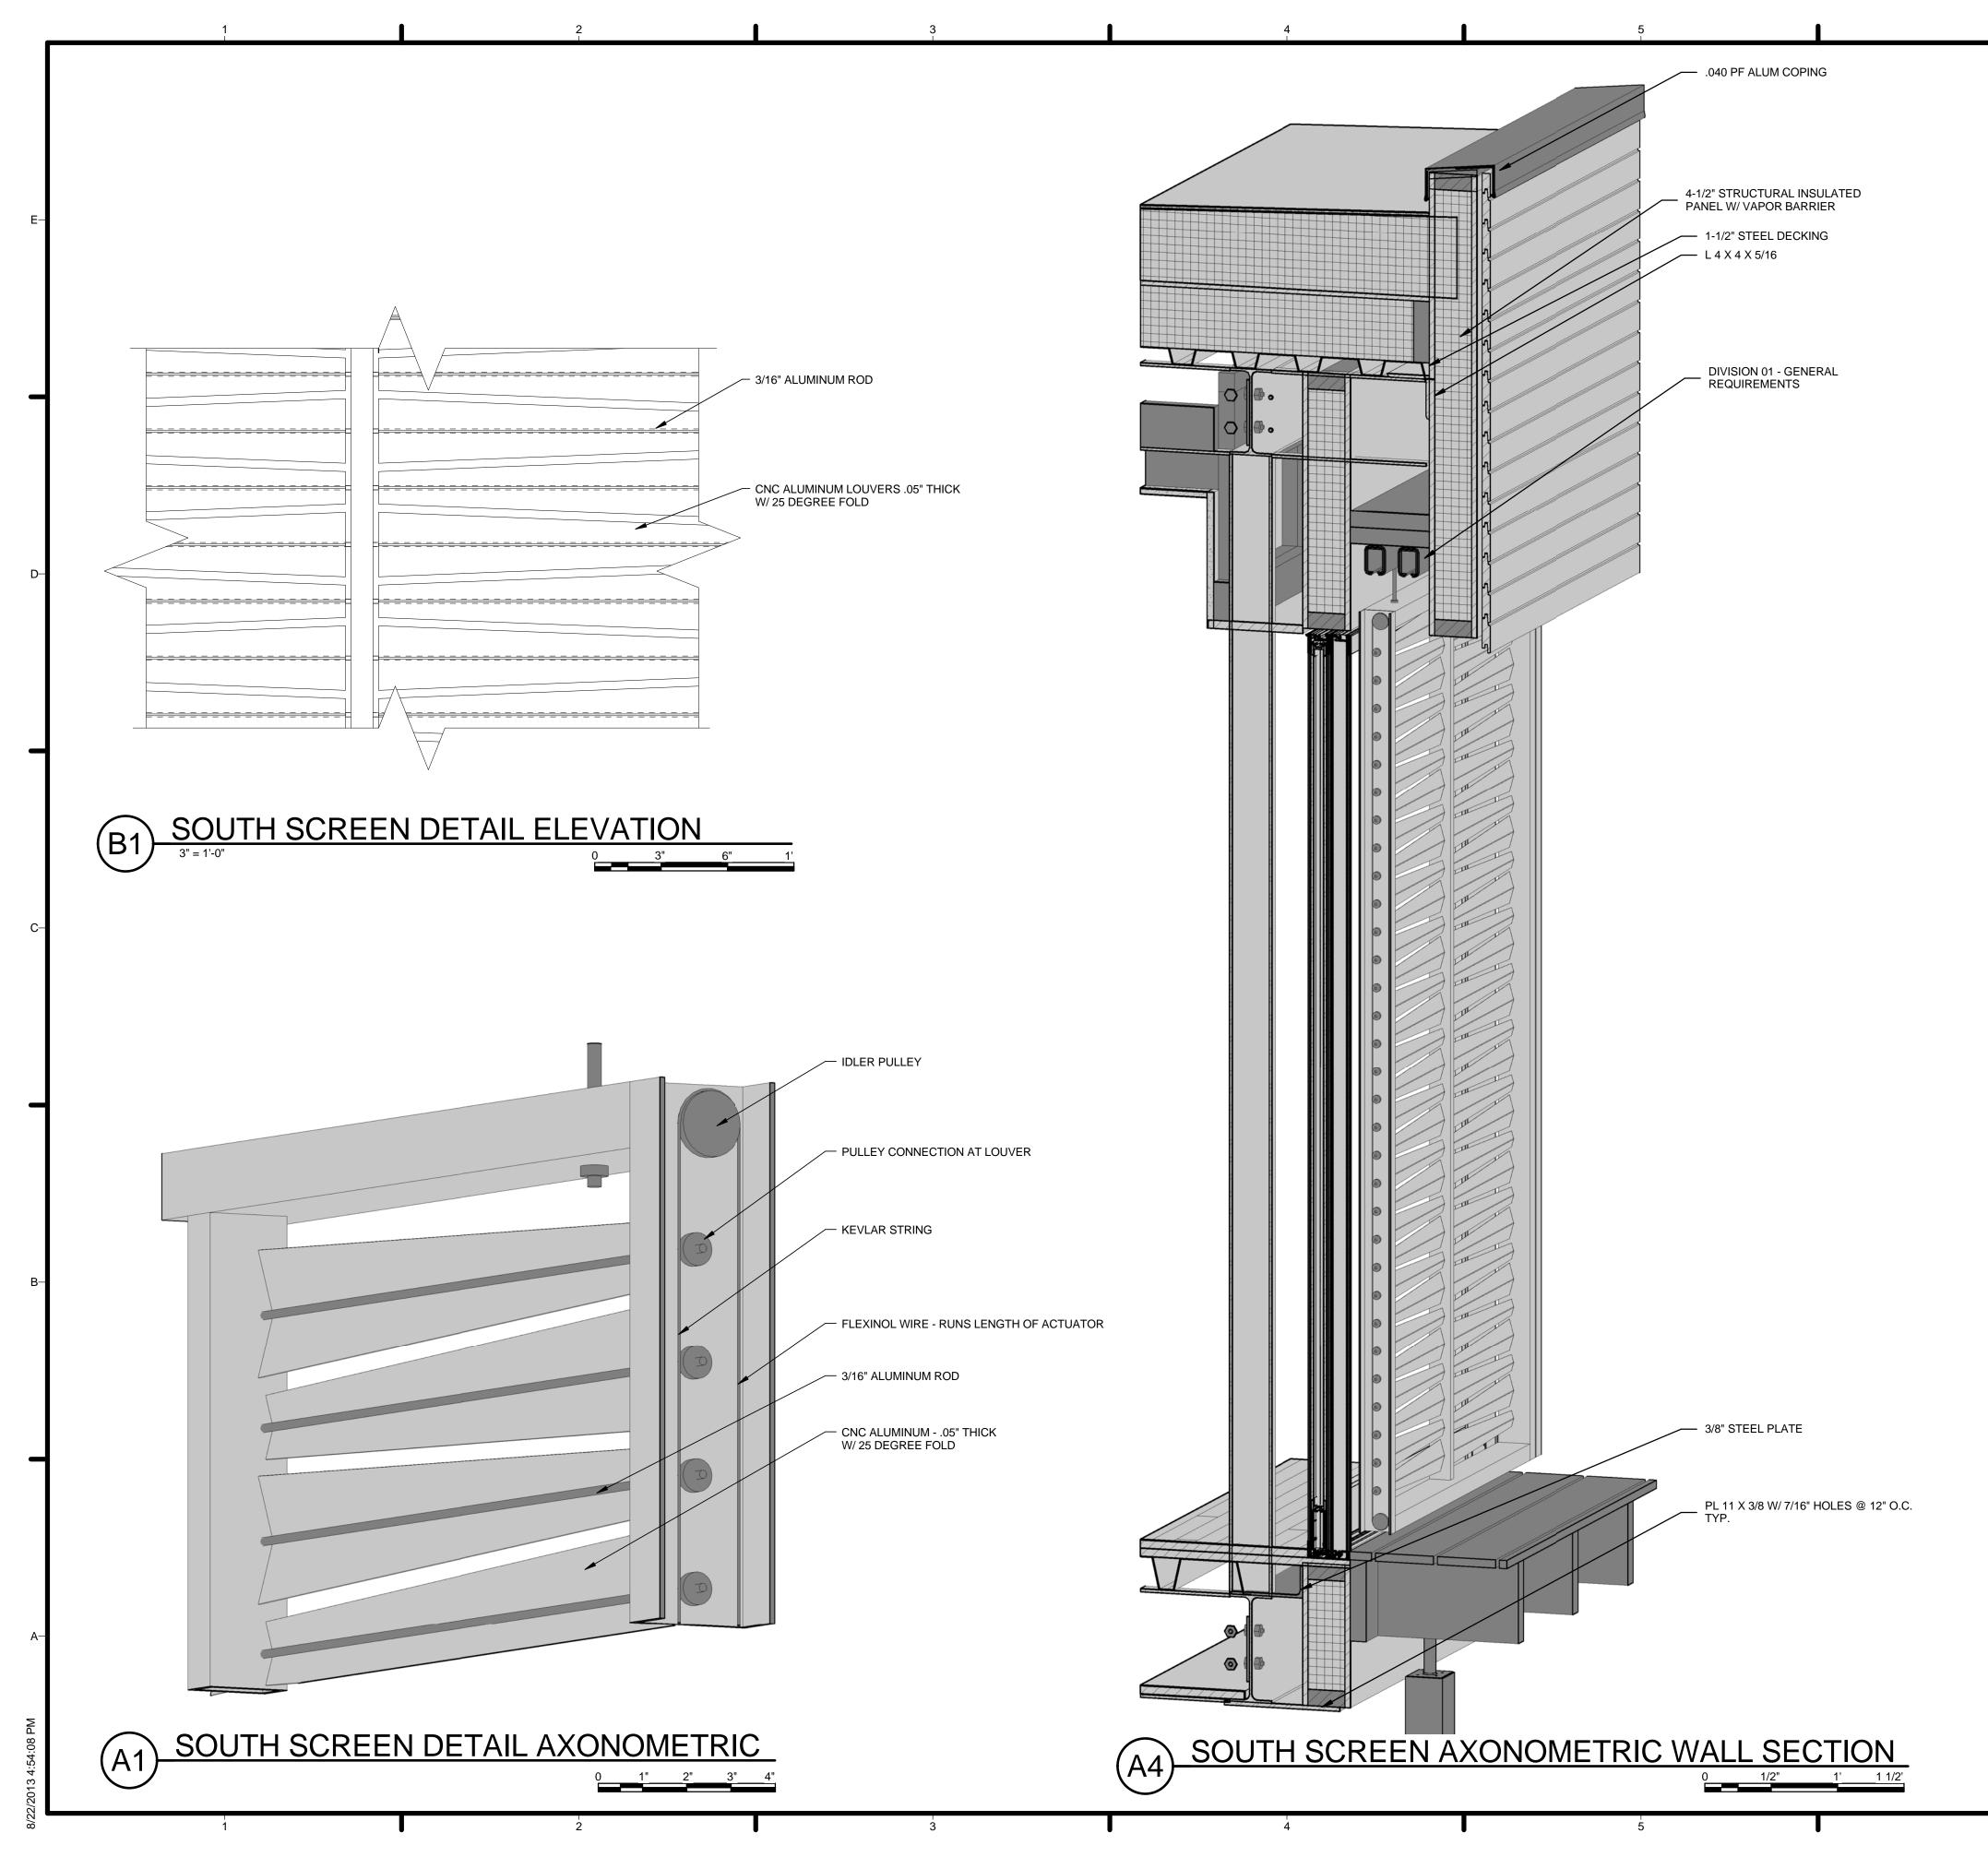


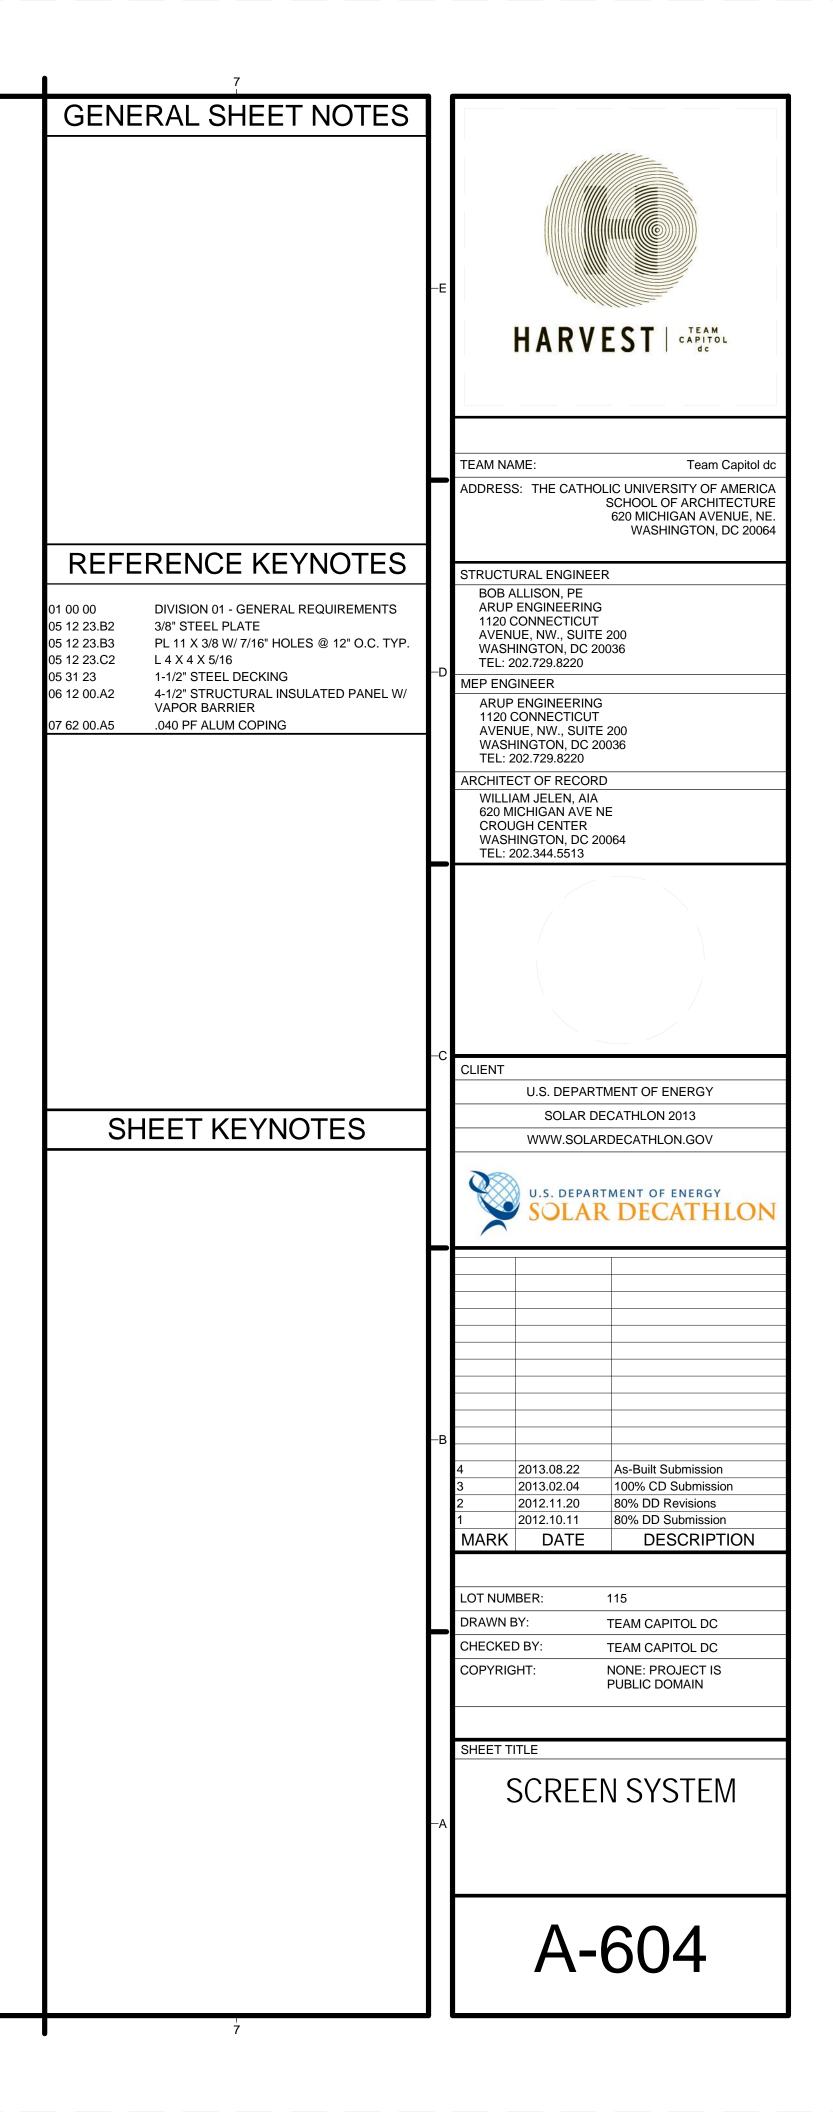


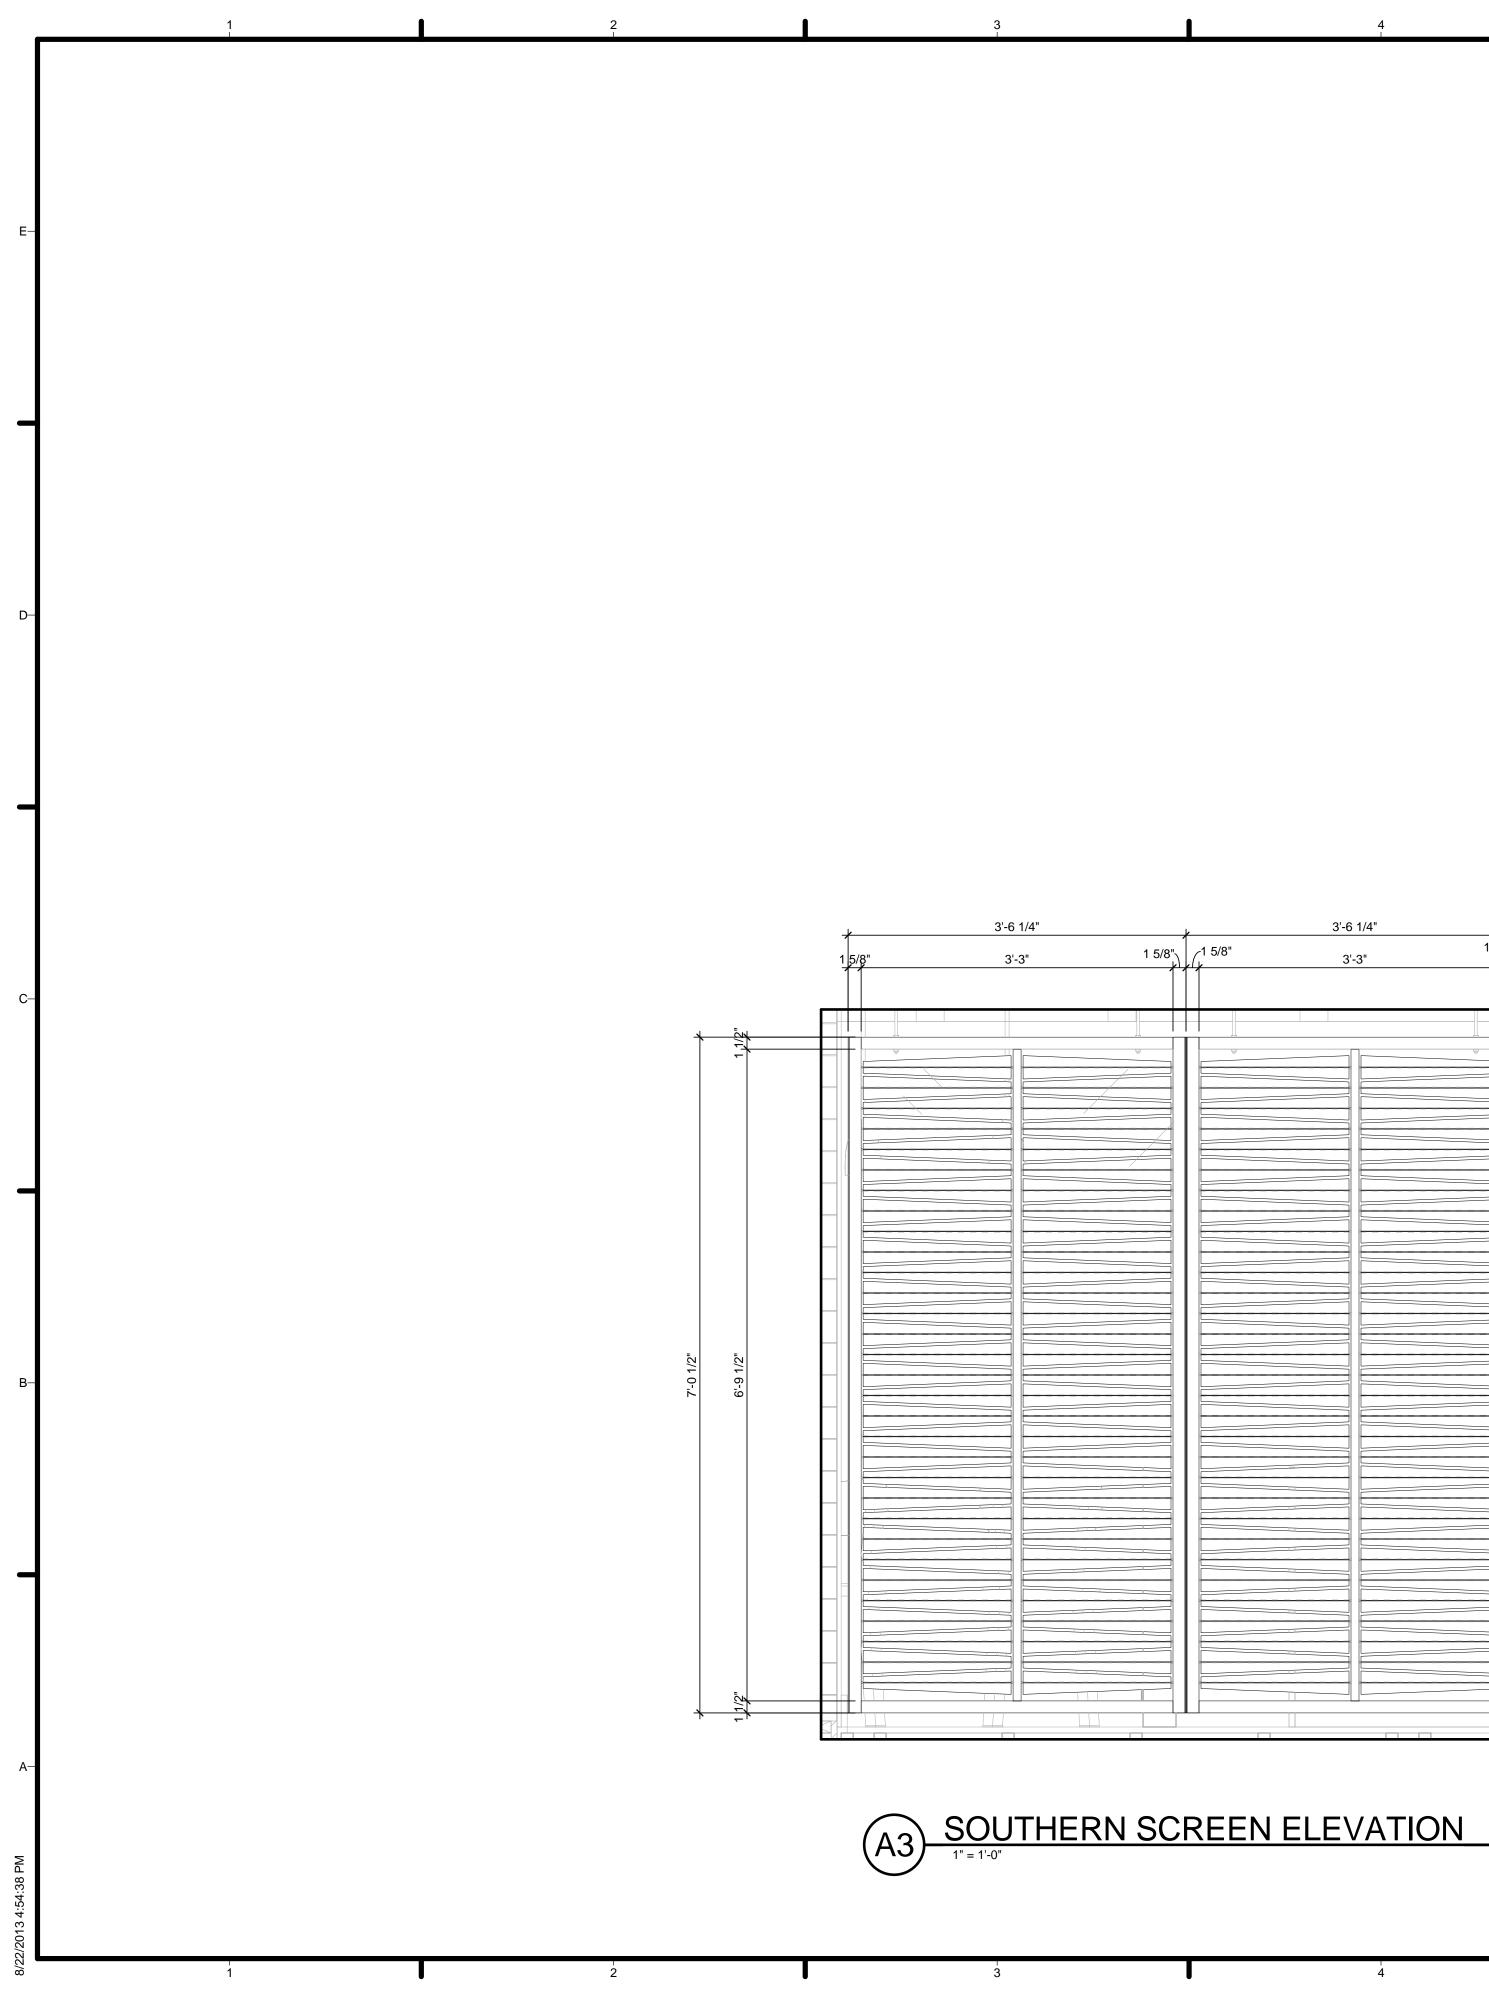




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 GENERAL SHEET NOTES 1. VERIFY ALL DIMENSIONS IN FIELD PRIOR TO FABRICATION AND INSTALLATION 2. SEE S-101 FOR FOOTING PLAN 	E HARVEST CAPITOL dc
REFERENCE KEYNOTES	 TEAM NAME: Team Capitol dc ADDRESS: THE CATHOLIC UNIVERSITY OF AMERICA SCHOOL OF ARCHITECTURE 620 MICHIGAN AVENUE, NE. WASHINGTON, DC 20064 STRUCTURAL ENGINEER BOB ALLISON, PE ARUP ENGINEERING 1120 CONNECTICUT AVENUE, NW., SUITE 200 WASHINGTON, DC 20036 TEL: 202.729.8220 MEP ENGINEER ARUP ENGINEERING 1120 CONNECTICUT AVENUE, NW., SUITE 200 WASHINGTON, DC 20036 TEL: 202.729.8220 MEP ENGINEERING 1120 CONNECTICUT AVENUE, NW., SUITE 200 WASHINGTON, DC 20036 TEL: 202.729.8220 ARCHITECT OF RECORD
	-C CLIENT U.S. DEPARTMENT OF ENERGY SOLAR DECATHLON 2013
SHEET KEYNOTES	WWW.SOLARDECATHLON.GOV
	B 4 2013.08.22 As-Built Submission 3 2013.02.04 100% CD Submission 2 2012.11.20 80% DD Revisions 1 2012.10.11 80% DD Submission MARK DATE DESCRIPTION LOT NUMBER: 115 DRAWN BY: TEAM CAPITOL DC CHECKED BY: TEAM CAPITOL DC COPYRIGHT: NONE: PROJECT IS PUBLIC DOMAIN
7	BHEET TITLE DOOR SCHEDULE A A-603

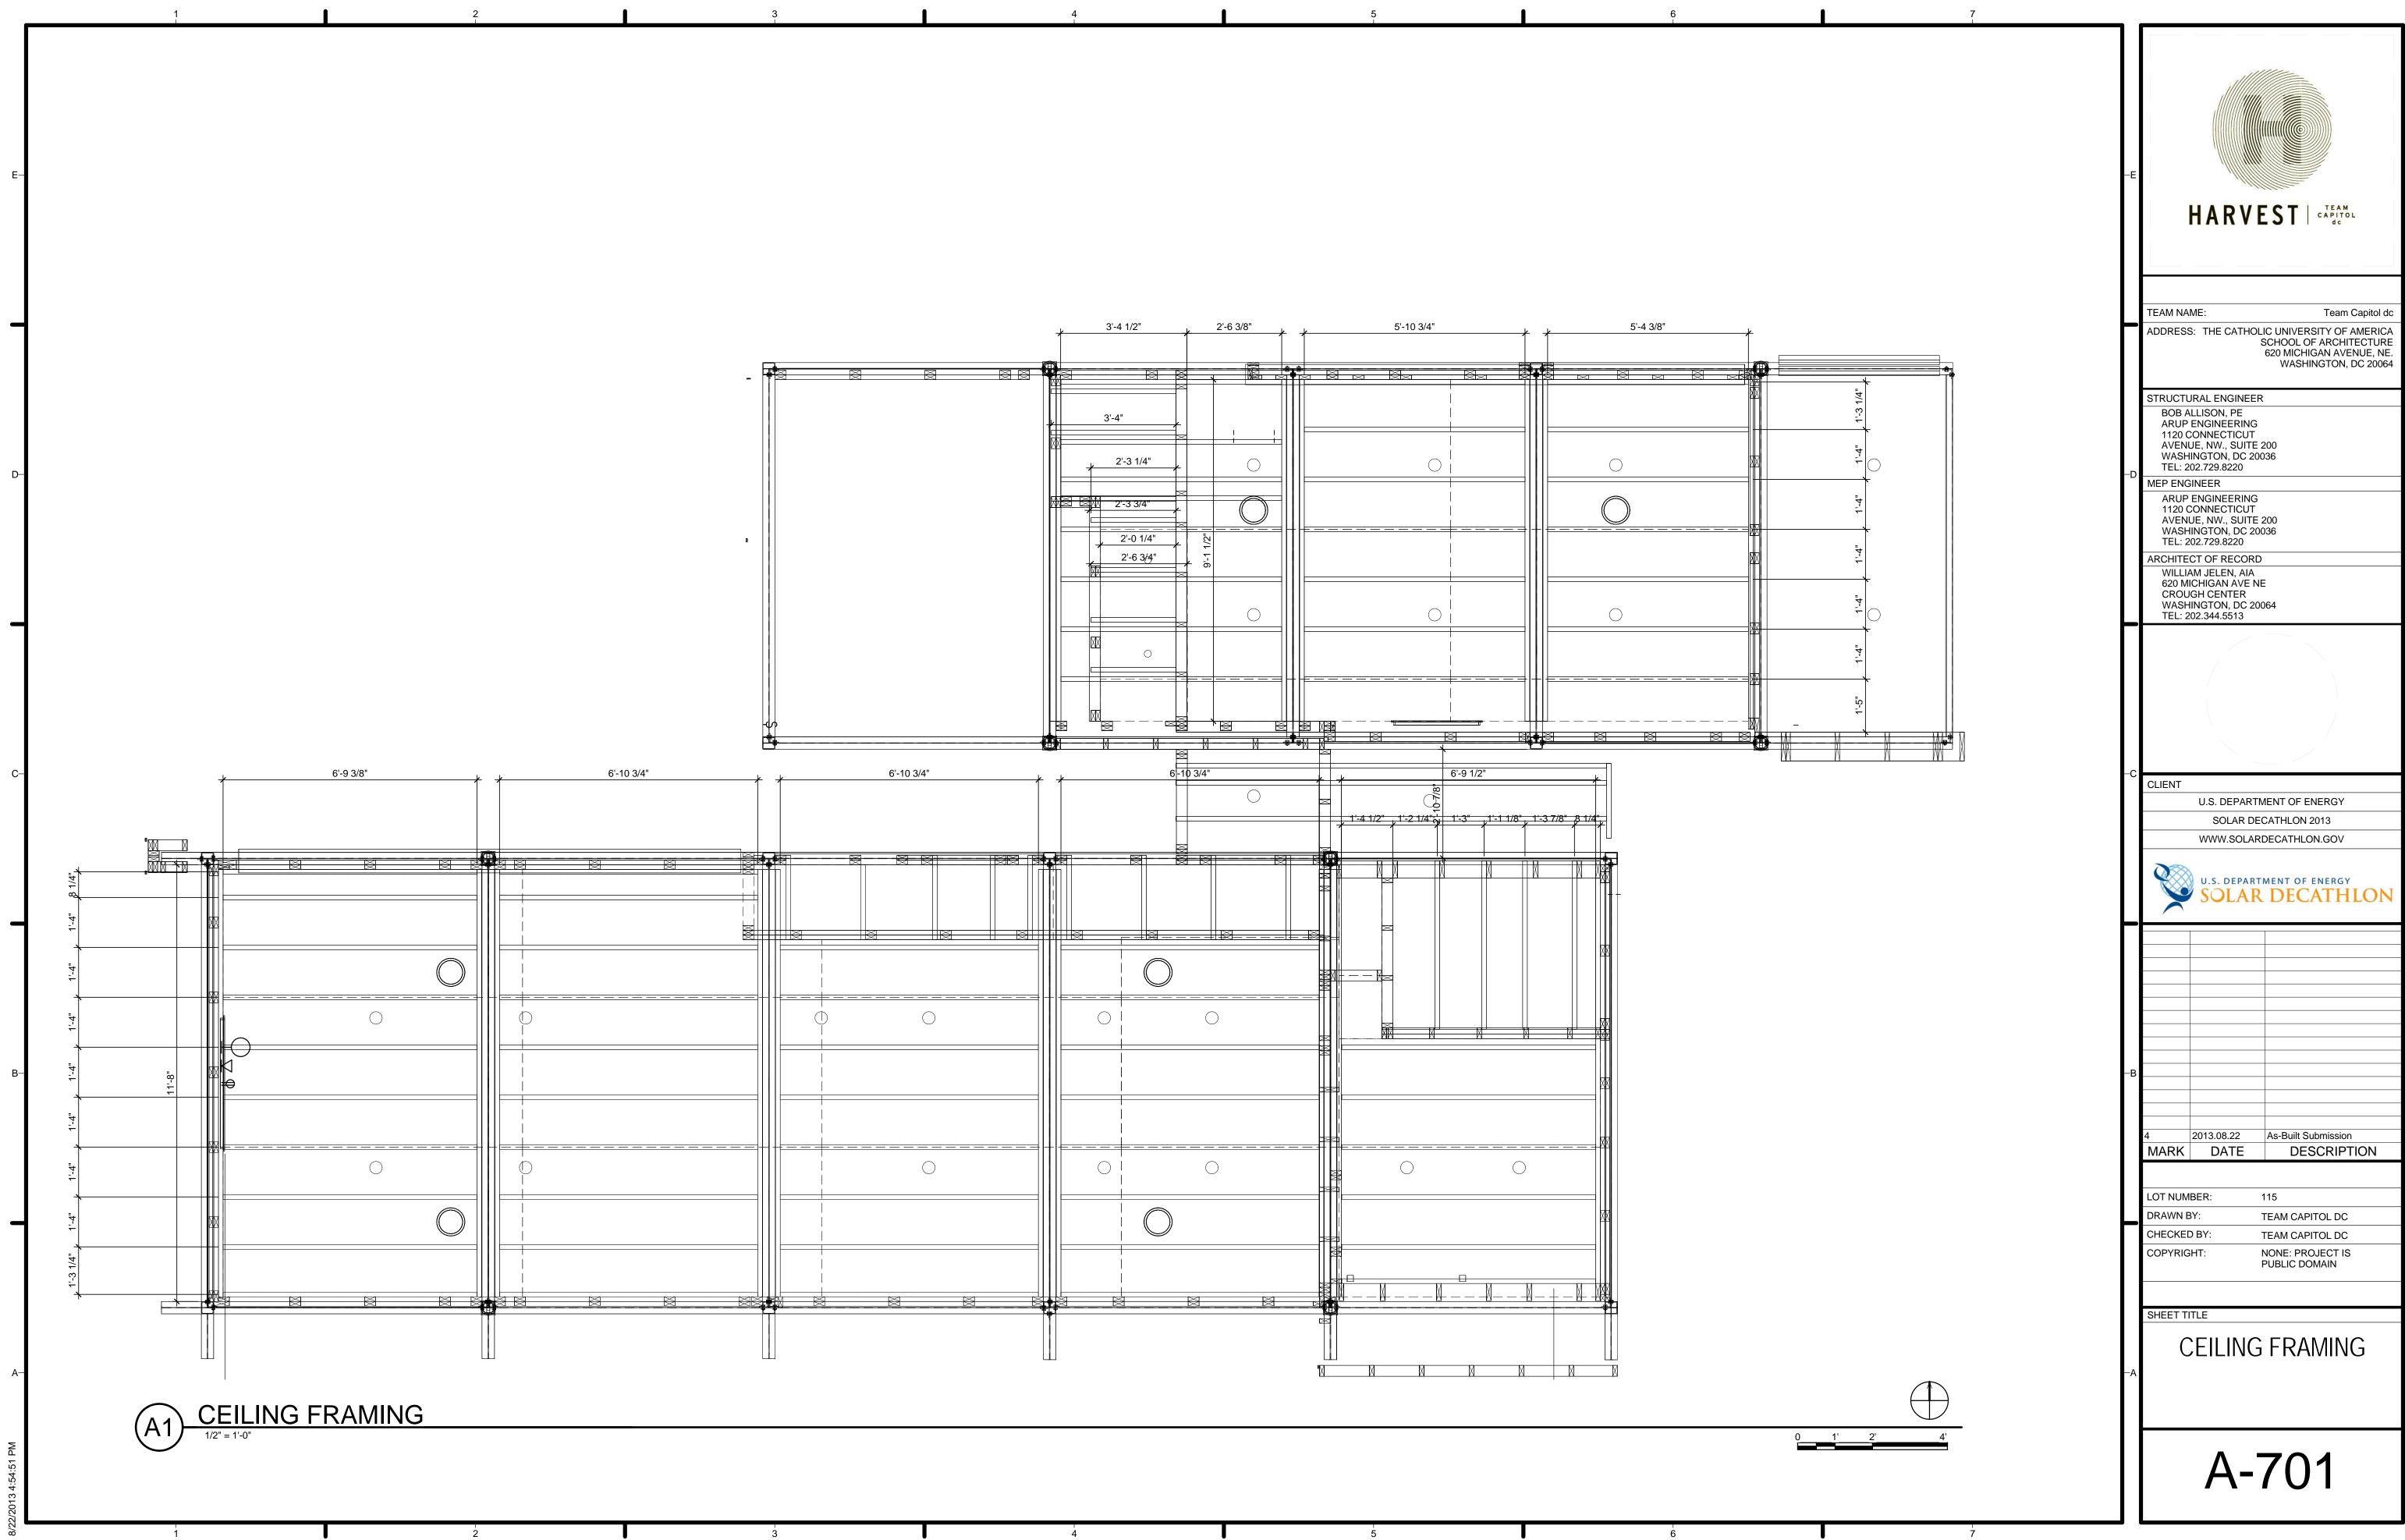


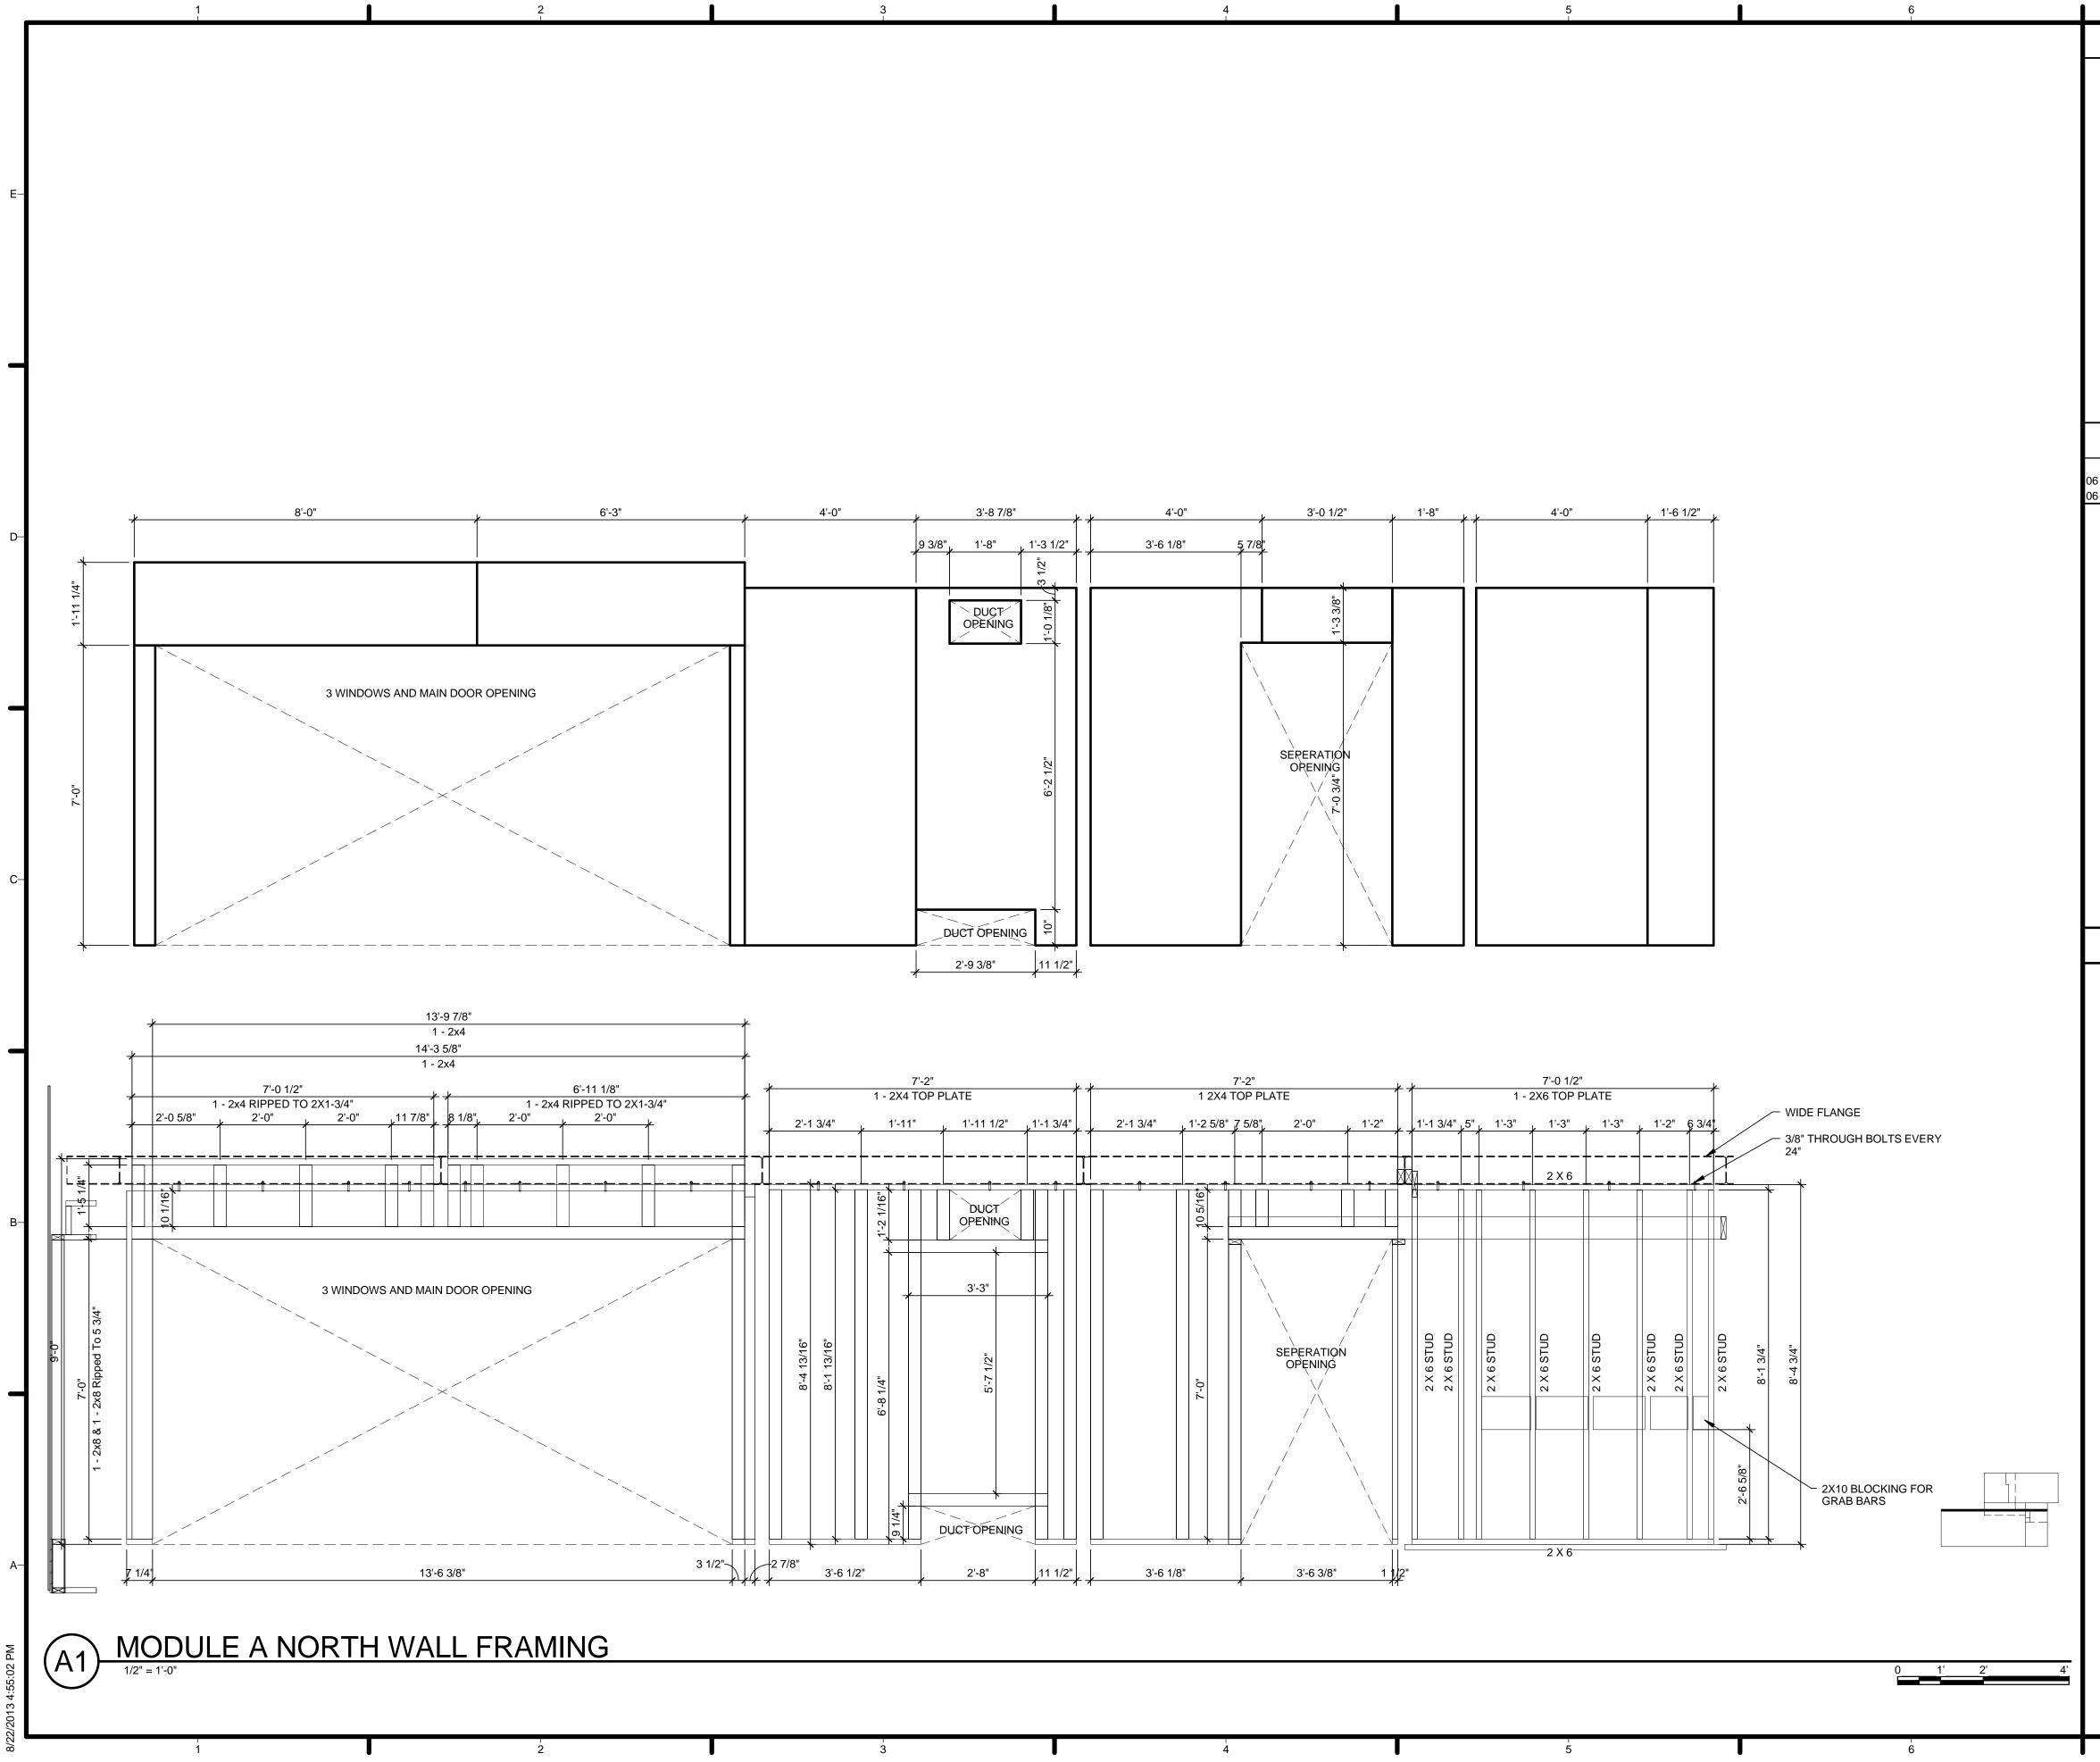




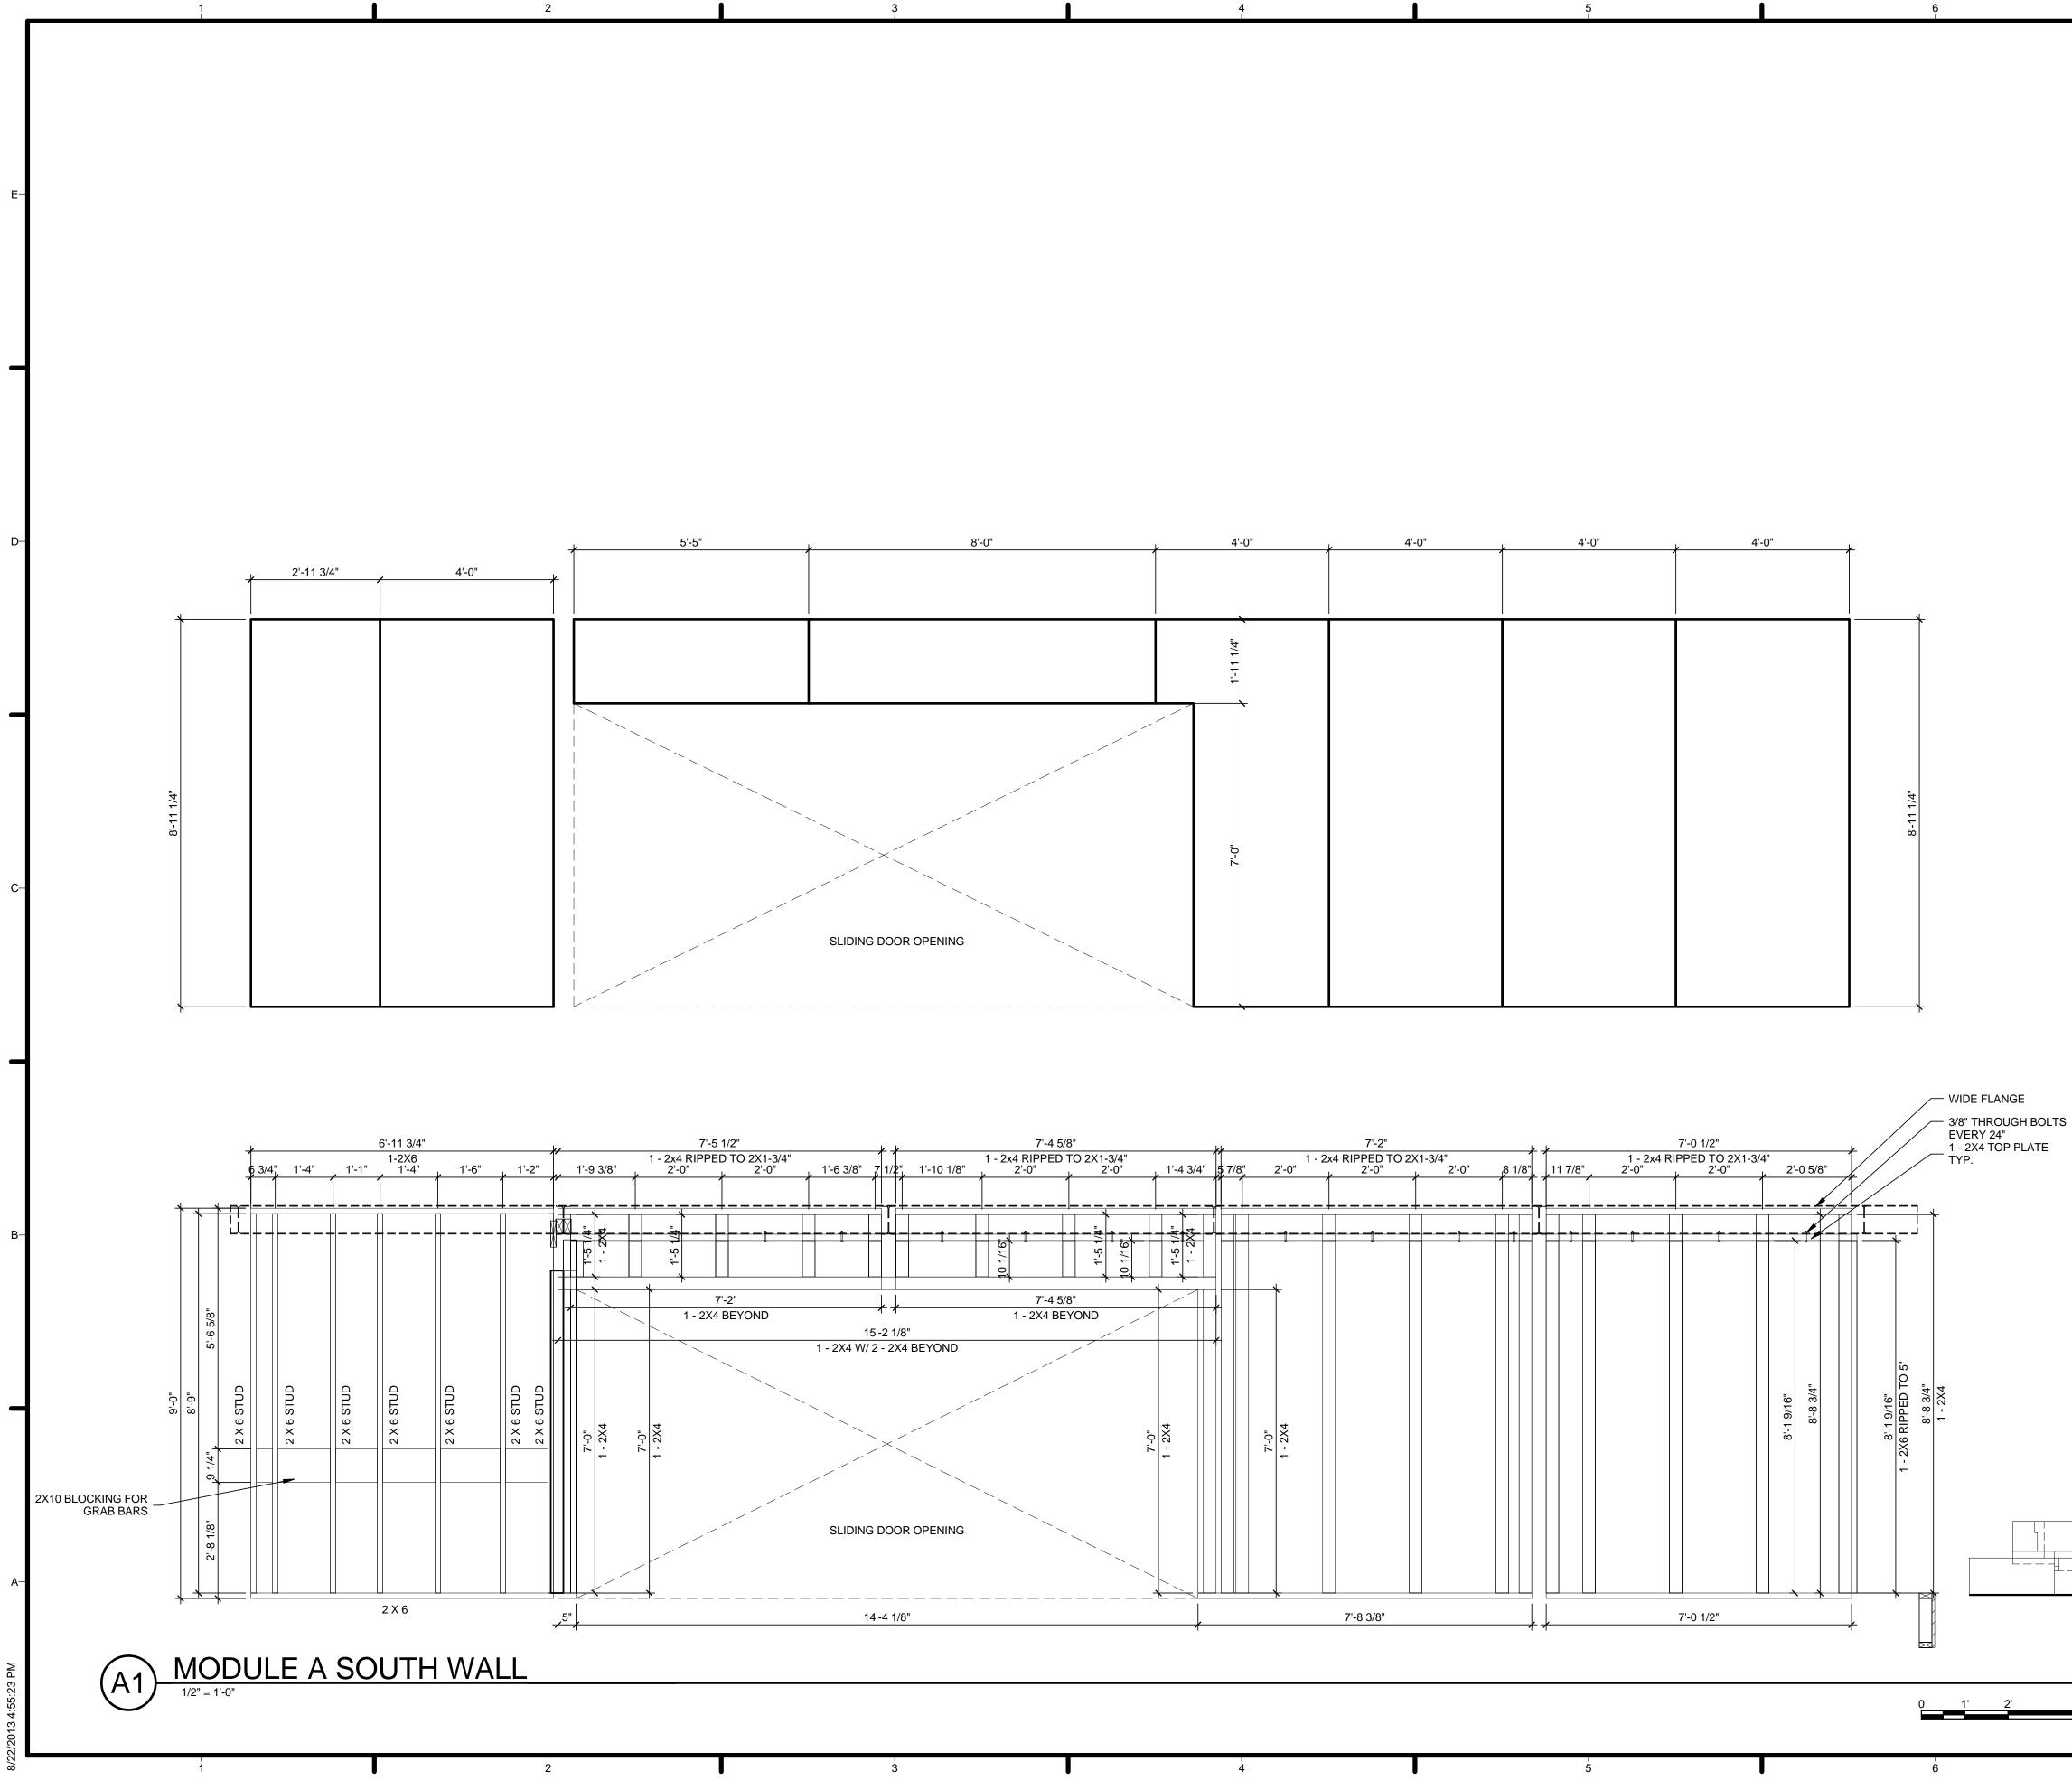
;	ب 3'-6	5 1/4"	3'-6 1/4"	3'-6 1/4"
، 1 5/8"	1 5/8" ₃	'-3" 1 5/8"	1 5/8" 1 5/8 k 3'-3"	3",] [1 5/8" 3'-3" 1
			1	3'-3" <u>1</u>
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GENERAL SHEET NOTES	
	HARVEST CAPITOL
	TEAM NAME: Team Capitol dc ADDRESS: THE CATHOLIC UNIVERSITY OF AMERICA SCHOOL OF ARCHITECTURE
REFERENCE KEYNOTES	620 MICHIGAN AVENUE, NE. WASHINGTON, DC 20064
	BOB ALLISON, PE ARUP ENGINEERING 1120 CONNECTICUT AVENUE, NW., SUITE 200 WASHINGTON, DC 20036 TEL: 202.729.8220
	D MEP ENGINEER ARUP ENGINEERING 1120 CONNECTICUT AVENUE, NW., SUITE 200 WASHINGTON, DC 20036
	TEL: 202.729.8220 ARCHITECT OF RECORD WILLIAM JELEN, AIA 620 MICHIGAN AVE NE CROUGH CENTER
	WASHINGTON, DC 20064 TEL: 202.344.5513
	-C CLIENT
SHEET KEYNOTES	U.S. DEPARTMENT OF ENERGY SOLAR DECATHLON 2013 WWW.SOLARDECATHLON.GOV
	U.S. DEPARTMENT OF ENERGY SOLAR DECATHLON
	B
	4 2013.08.22 As-Built Submission MARK DATE DESCRIPTION
	LOT NUMBER: 115
	DRAWN BY: TEAM CAPITOL DC CHECKED BY: TEAM CAPITOL DC
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	SHEET TITLE
	SCREEN ELEVATION
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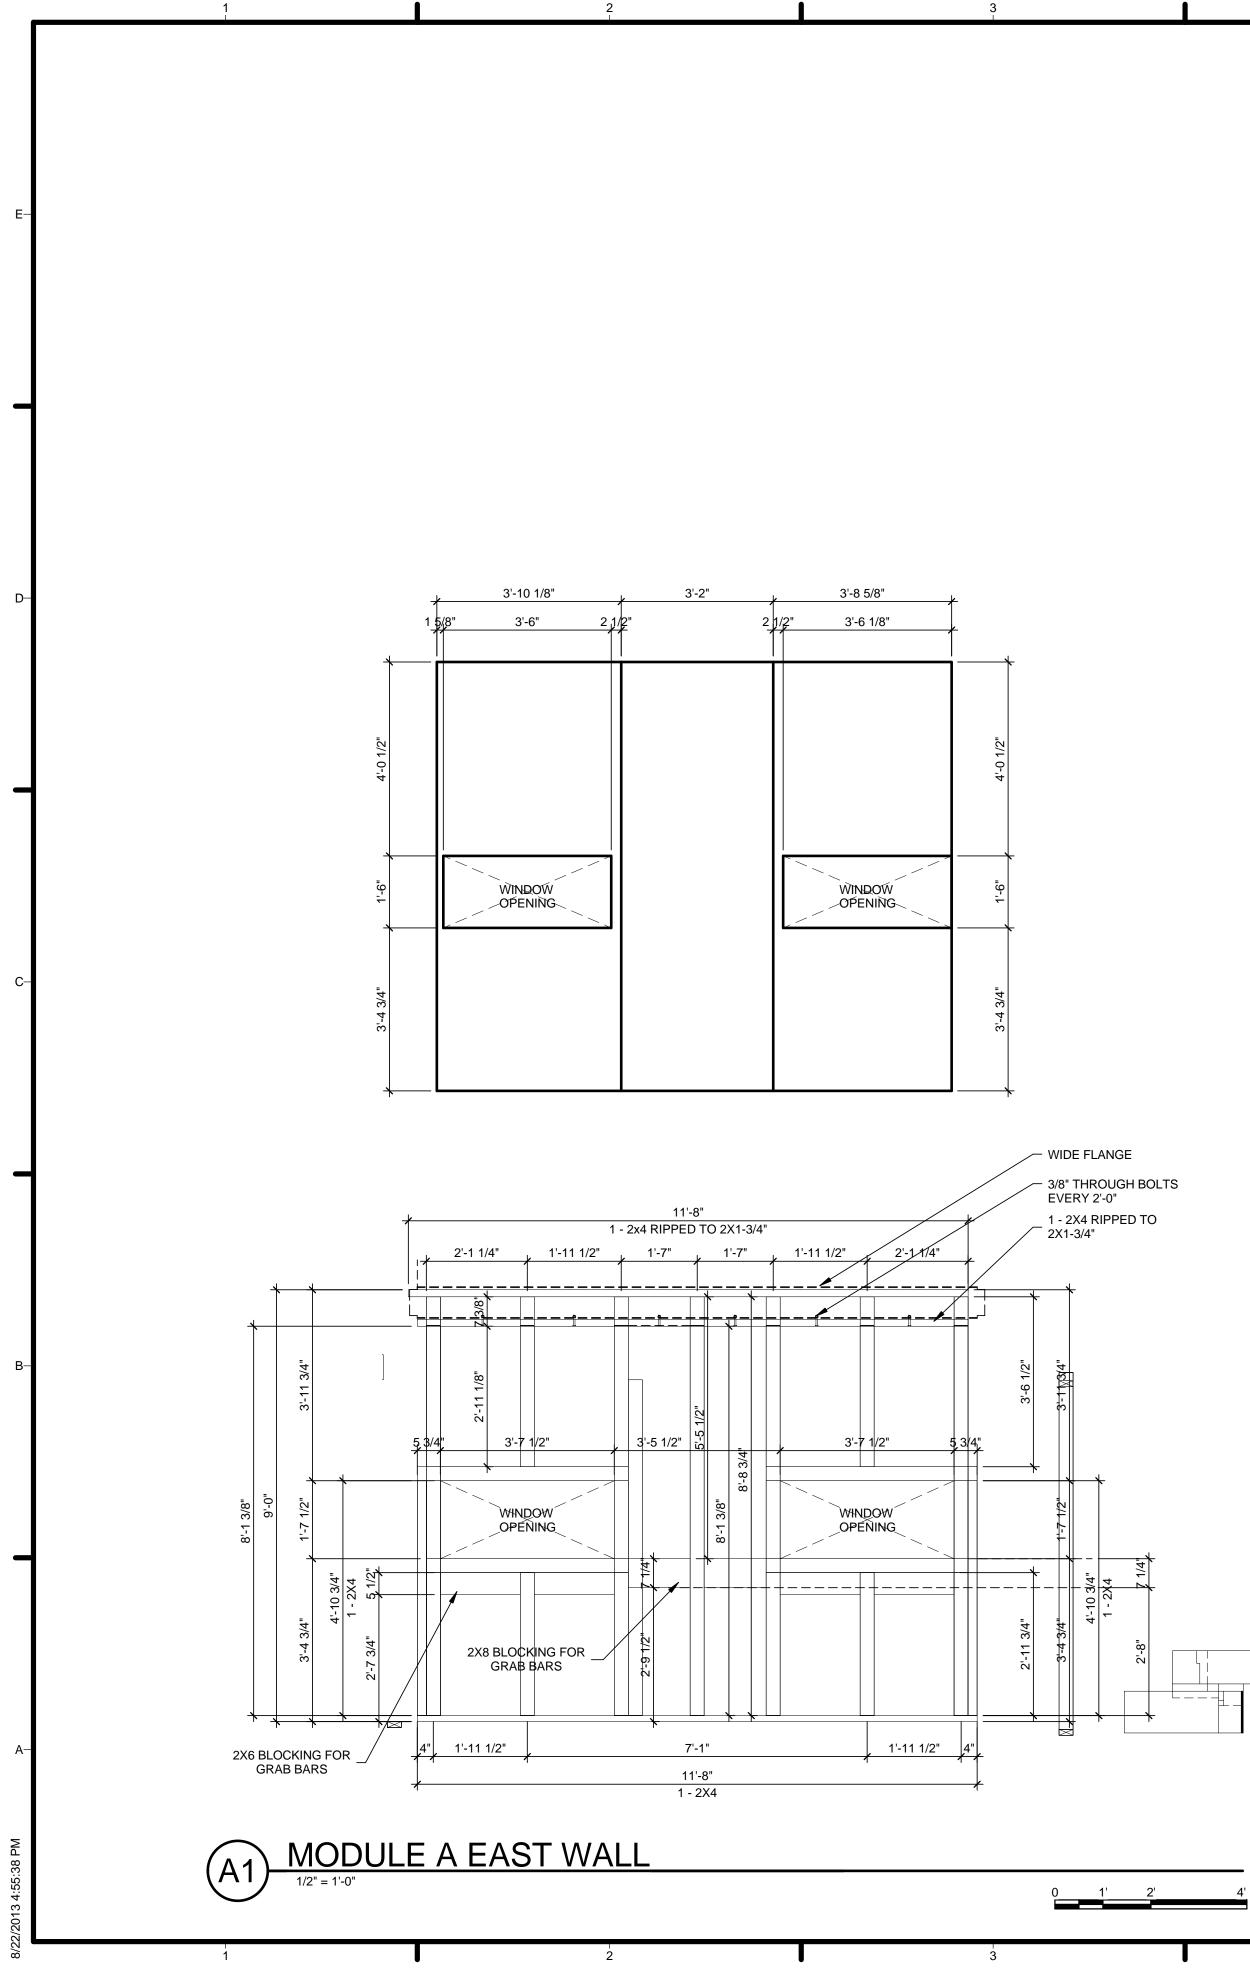


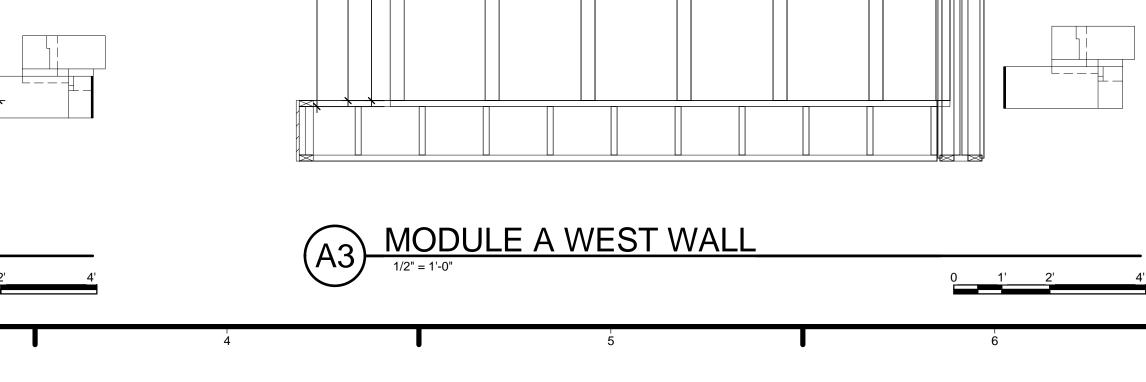


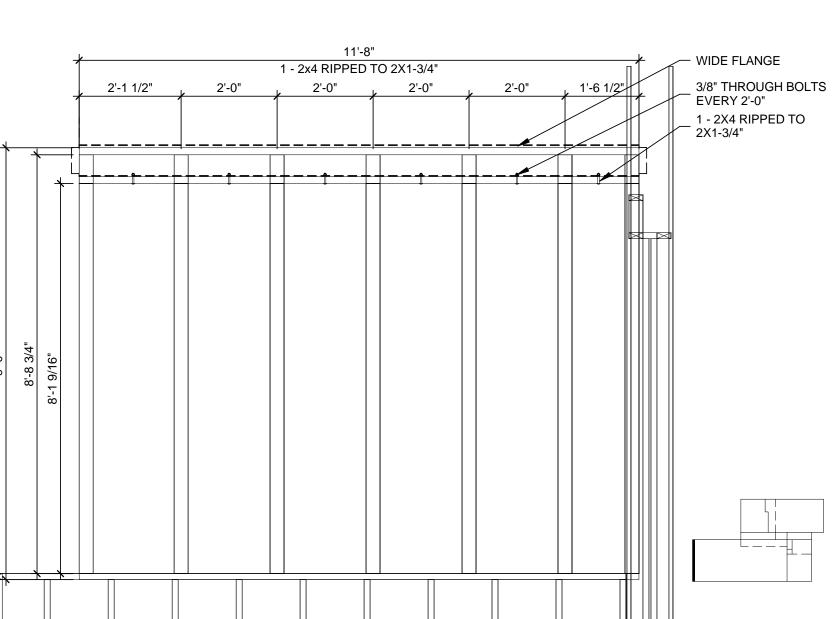
7		
 VERIFY ALL DIMENSIONS IN FIELD PRIOR TO FABRICATION AND INSTALLATION SEE SHEET C-102 FOR MODULE IDENTITY ALL STUDS (2) 2X4 UNLESS SPECIFIED OTHERWISE GYPSUM LAYOUT ABOVE FRAMING DRAWINGS 	-E	HARVEST CAPITOL
REFERENCE KEYNOTES 06 11 00.B1 2 X 6 STUD 06 11 00.B6 2 X 6		TEAM NAME: Team Capitol dc ADDRESS: THE CATHOLIC UNIVERSITY OF AMERICA SCHOOL OF ARCHITECTURE 620 MICHIGAN AVENUE, NE. WASHINGTON, DC 20064 STRUCTURAL ENGINEER BOB ALLISON, PE ARUP ENGINEERING 1120 CONNECTICUT AVENUE, NW., SUITE 200 WASHINGTON, DC 20036 TEL: 202.729.8220 MEP ENGINEER ARUP ENGINEERING 1120 CONNECTICUT AVENUE, NW., SUITE 200 WASHINGTON, DC 20036 TEL: 202.729.8220 MEP ENGINEER ARUP ENGINEERING 1120 CONNECTICUT AVENUE, NW., SUITE 200 WASHINGTON, DC 20036 TEL: 202.729.8220 ARCHITECT OF RECORD WILLIAM JELEN, AIA 620 MICHIGAN AVE NE CROUGH CENTER WAOUNDICTION DD 200304
SHEET KEYNOTES	C -	VASHINGTON, DC 20064 TEL: 202.344.5513 CLIENT U.S. DEPARTMENT OF ENERGY SOLAR DECATHLON 2013 WWW.SOLARDECATHLON.GOV U.S. DEPARTMENT OF ENERGY SOLAR DECATHLON.GOV
		4 2013.08.22 As-Built Submission MARK DATE DESCRIPTION
	—А	LOT NUMBER: 115 DRAWN BY: TEAM CAPITOL DC CHECKED BY: TEAM CAPITOL DC COPYRIGHT: NONE: PROJECT IS PUBLIC DOMAIN SHEET TITLE MODULE A NORTH WALL A-711

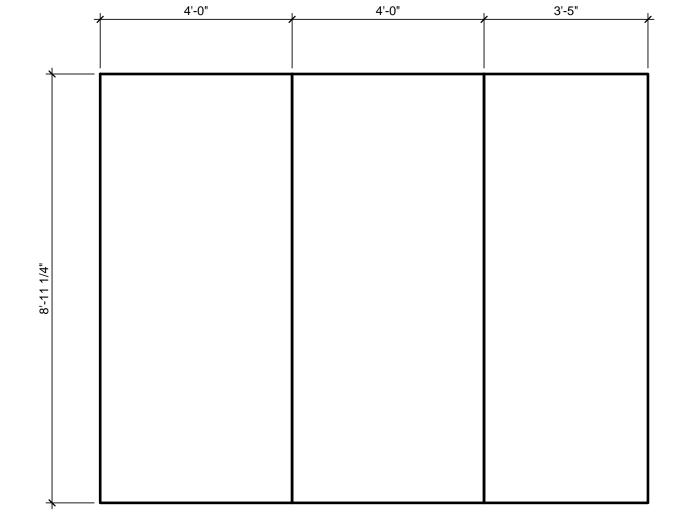


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	 VERIFY ALL DIMENSIONS IN FIELD PRIOR TO FABRICATION AND INSTALLATION SEE SHEET C-102 FOR MODULE IDENTITY ALL STUDS (2) 2X4 UNLESS SPECIFIED OTHERWISE GYPSUM LAYOUT ABOVE FRAMING DRAWINGS 	-E	HARVEST CAPITOL
	REFERENCE KEYNOTES		TEAM NAME: Team Capitol dc ADDRESS: THE CATHOLIC UNIVERSITY OF AMERICA SCHOOL OF ARCHITECTURE 620 MICHIGAN AVENUE, NE. WASHINGTON, DC 20064
	06 11 00.B1 2 X 6 STUD		STRUCTURAL ENGINEER BOB ALLISON, PE ARUP ENGINEERING
	06 11 00.B6 2 X 6		1120 CONNECTICUT AVENUE, NW., SUITE 200 WASHINGTON, DC 20036 TEL: 202.729.8220
		D -	MEP ENGINEER ARUP ENGINEERING 1120 CONNECTICUT
			AVENUE, NW., SUITE 200 WASHINGTON, DC 20036 TEL: 202.729.8220
			ARCHITECT OF RECORD WILLIAM JELEN, AIA 620 MICHIGAN AVE NE CROUGH CENTER
			WASHINGTON, DC 20064 TEL: 202.344.5513
		-c	CLIENT
	SHEET KEYNOTES		U.S. DEPARTMENT OF ENERGY SOLAR DECATHLON 2013
	SHELTKEINOTES		WWW.SOLARDECATHLON.GOV
			U.S. DEPARTMENT OF ENERGY SOLAR DECATHLON
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		—В.	
			42013.08.22As-Built SubmissionMARKDATEDESCRIPTION
			LOT NUMBER: 115
			DRAWN BY:TEAM CAPITOL DCCHECKED BY:TEAM CAPITOL DC
			COPYRIGHT: NONE: PROJECT IS PUBLIC DOMAIN
		—A	SHEET TITLE MODULE A SOUTH WALL
<u>4'</u>	7		A-712

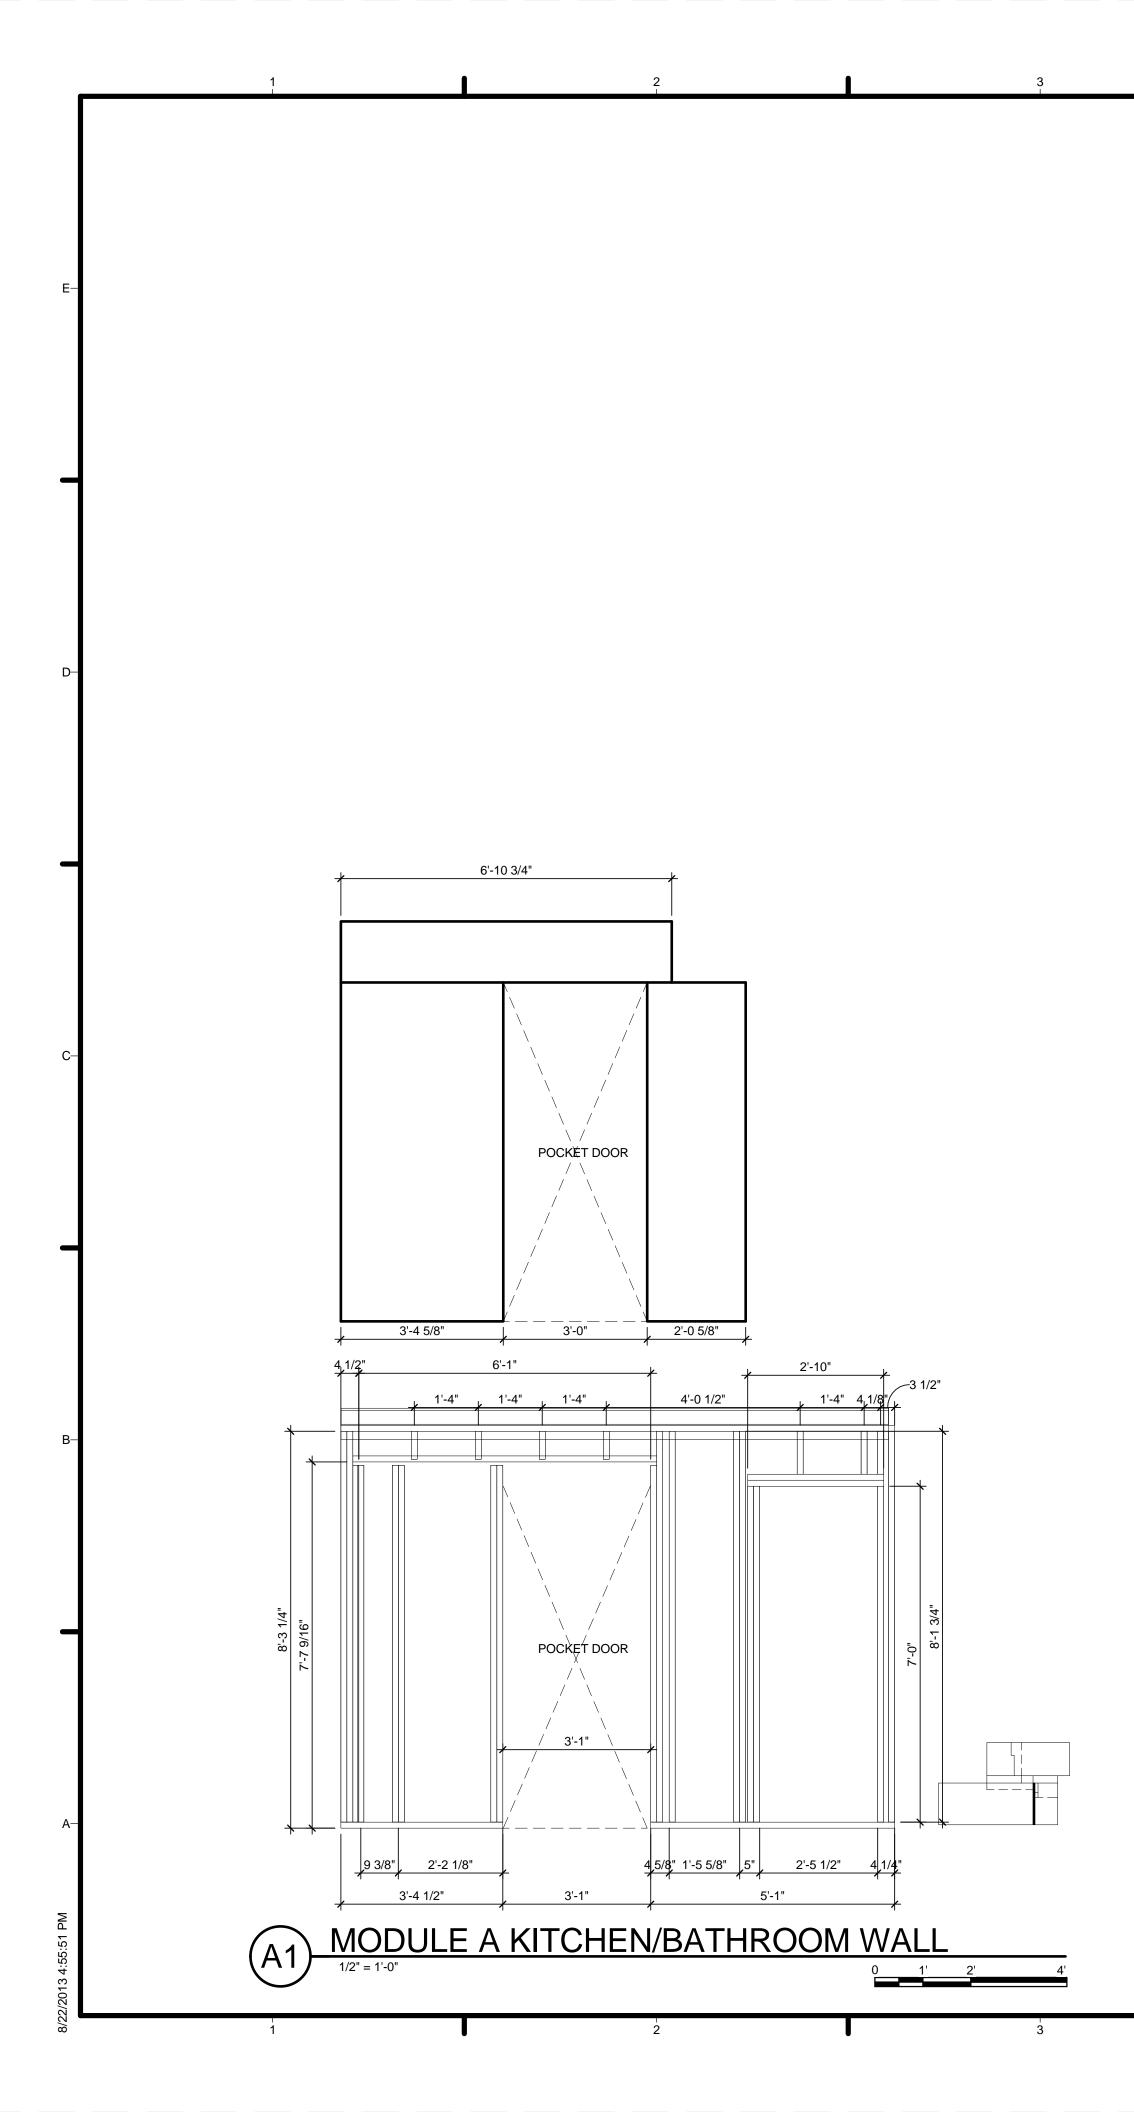


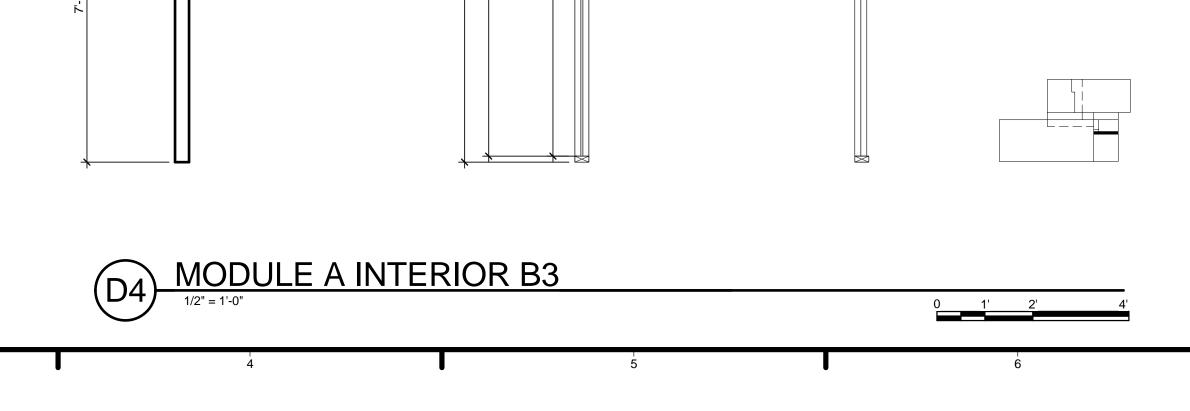


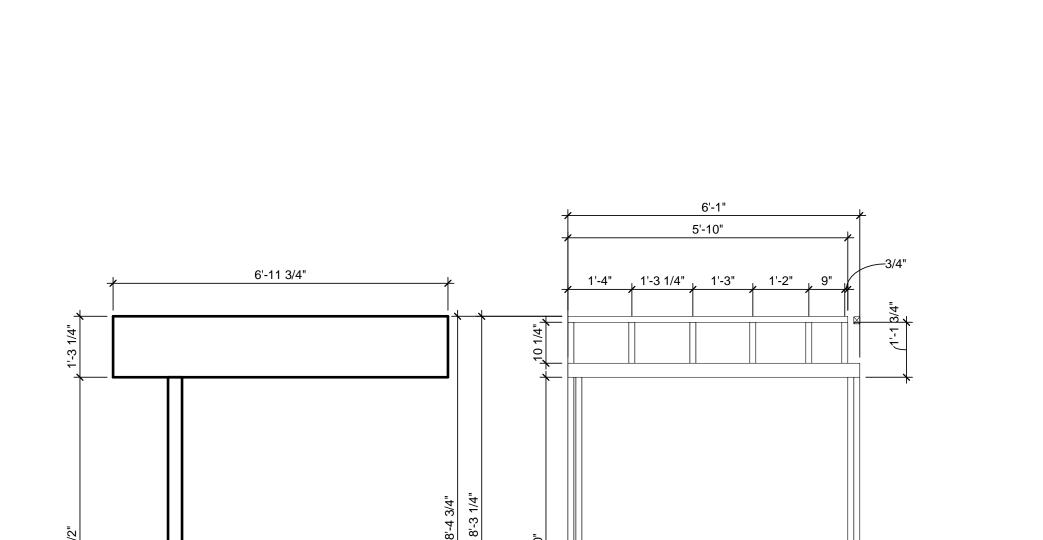




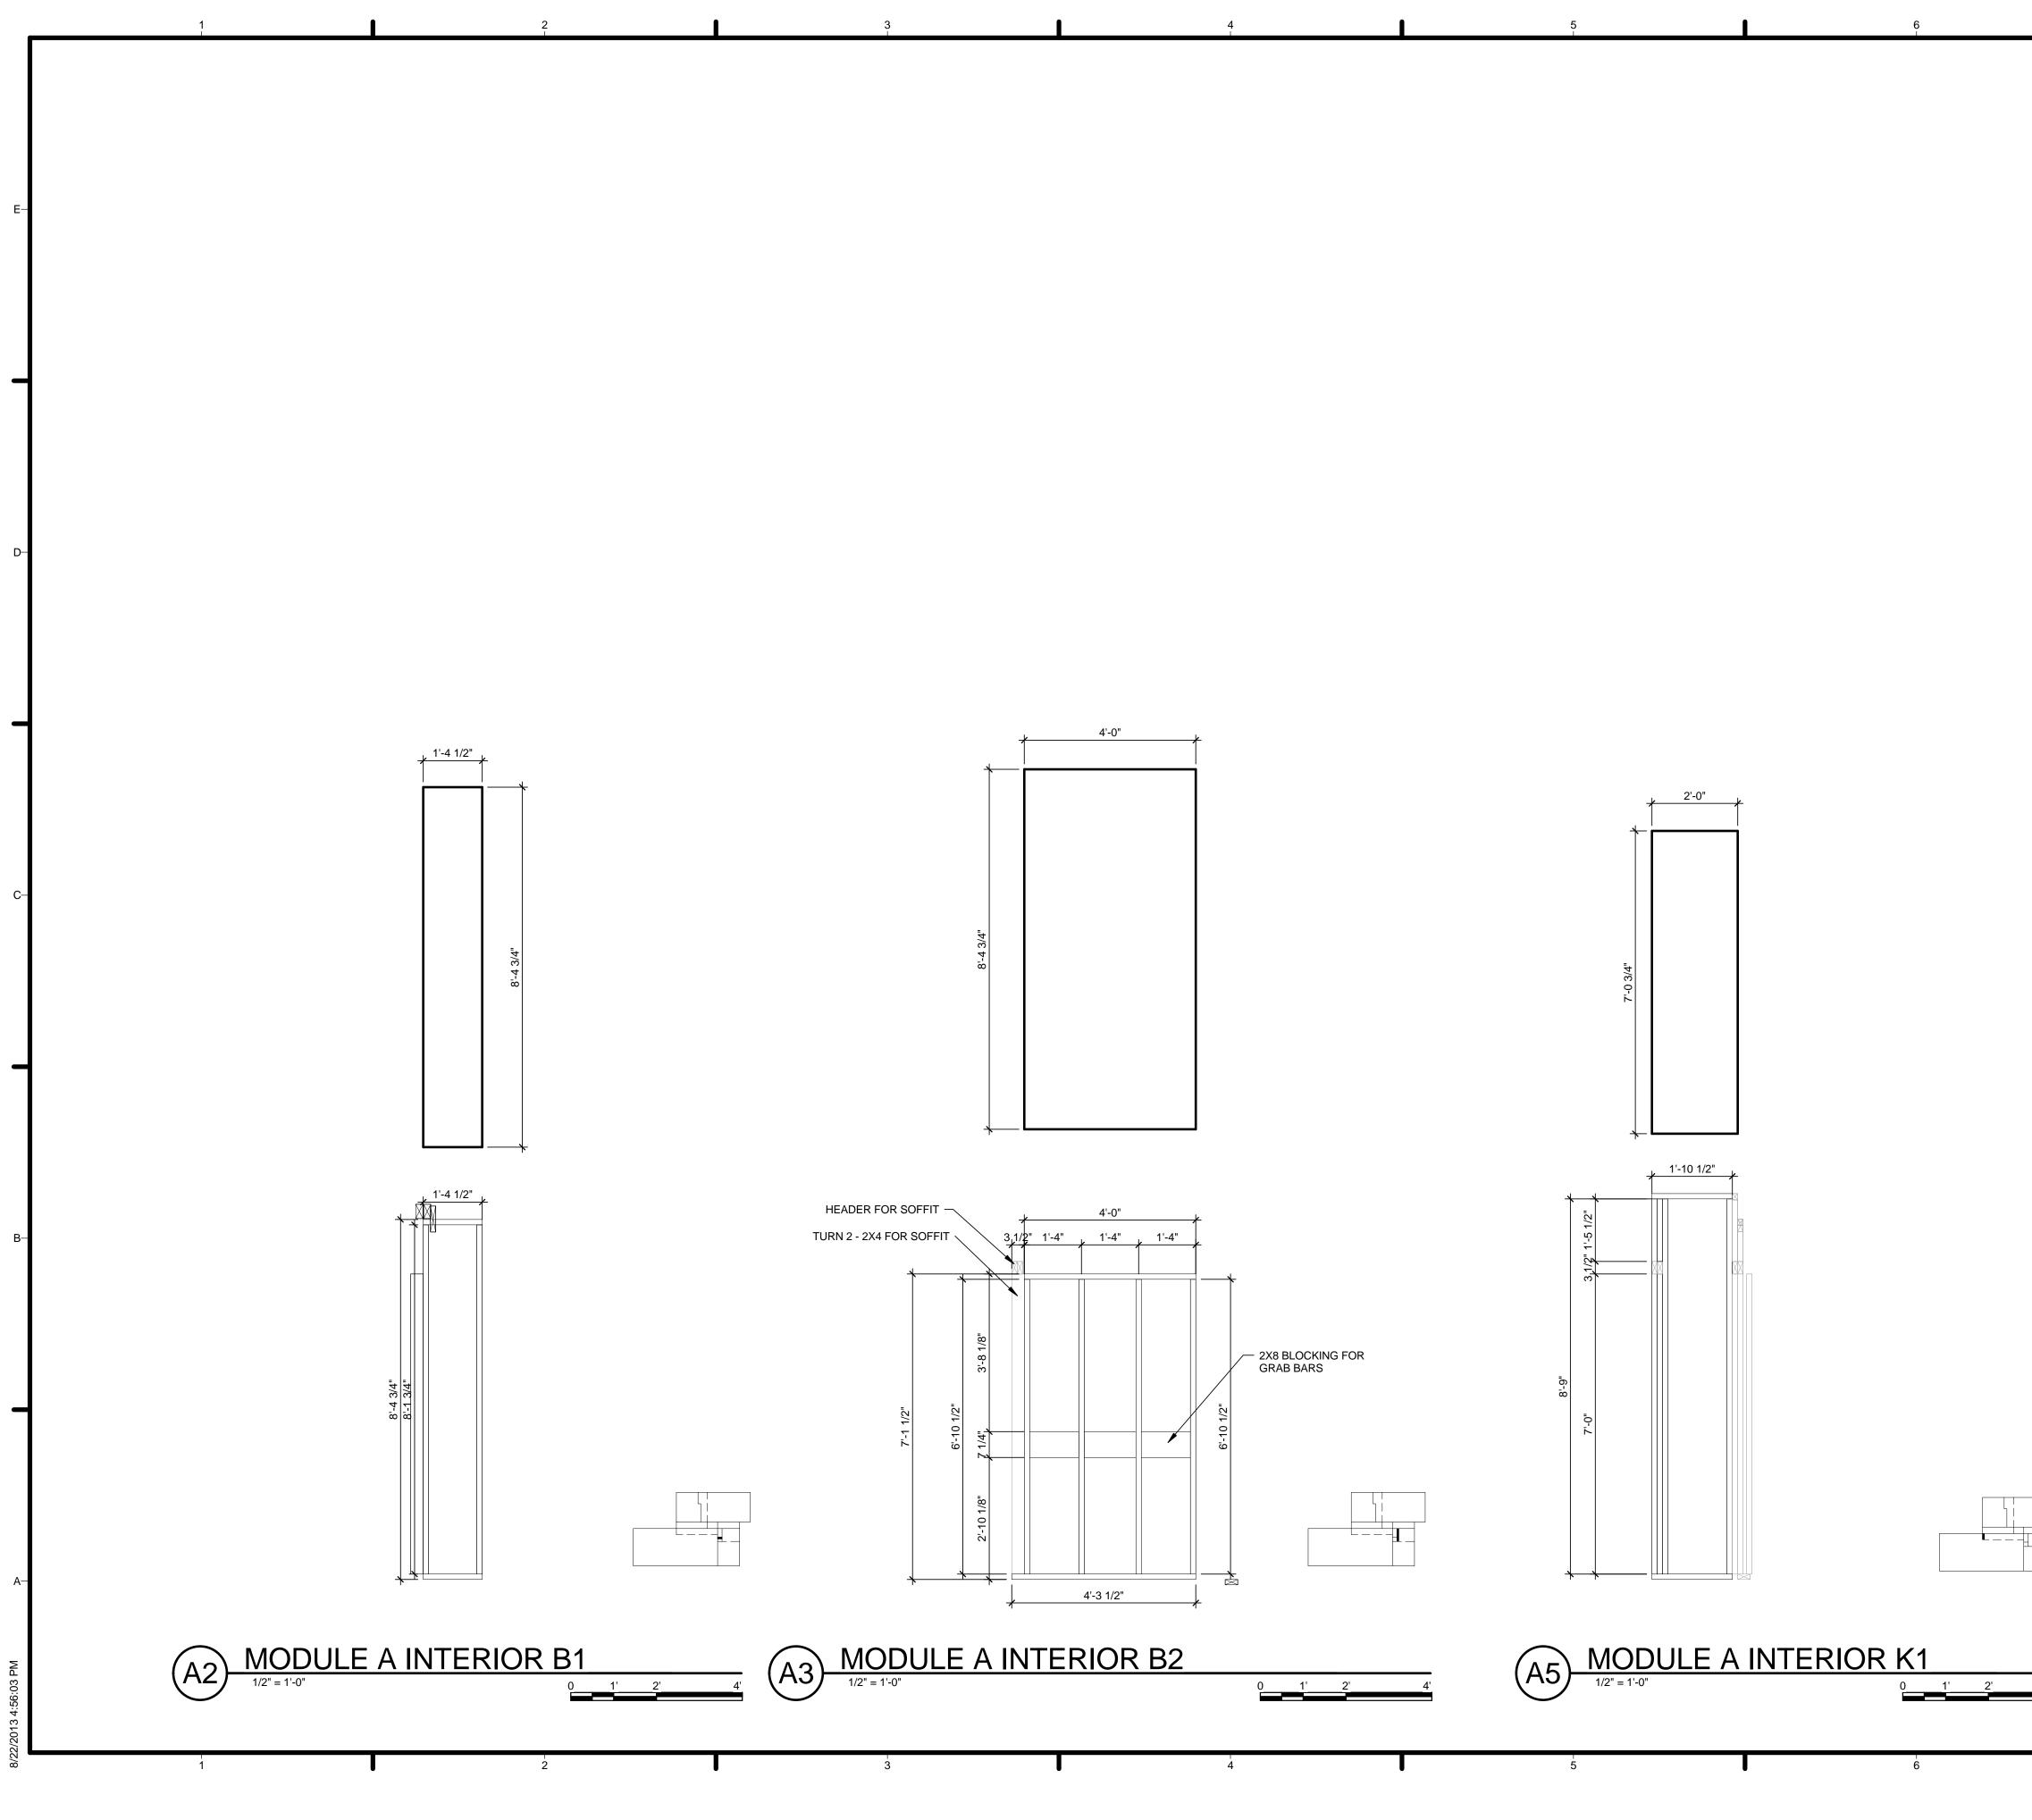
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	 VERIFY ALL DIMENSIONS IN FIELD PRIOR TO FABRICATION AND INSTALLATION SEE SHEET C-102 FOR MODULE IDENTITY ALL STUDS (2) 2X4 UNLESS SPECIFIED OTHERWISE GYPSUM LAYOUT ABOVE FRAMING DRAWINGS 	-E HARVEST CAPITOL dc
	REFERENCE KEYNOTES	TEAM NAME: Team Capitol dc ADDRESS: THE CATHOLIC UNIVERSITY OF AMERICA SCHOOL OF ARCHITECTURE 620 MICHIGAN AVENUE, NE. WASHINGTON, DC 20064 STRUCTURAL ENGINEER BOB ALLISON, PE ARUP ENGINEERING 1120 CONNECTICUT AVENUE, NW., SUITE 200 WASHINGTON, DC 20036 TEL: 202.729.8220 MEP ENGINEER
		ARUP ENGINEERING 1120 CONNECTICUT AVENUE, NW., SUITE 200 WASHINGTON, DC 20036 TEL: 202.729.8220 ARCHITECT OF RECORD WILLIAM JELEN, AIA 620 MICHIGAN AVE NE CROUGH CENTER WASHINGTON, DC 20064 TEL: 202.344.5513
	SHEET KEYNOTES	-C CLIENT U.S. DEPARTMENT OF ENERGY SOLAR DECATHLON 2013 WWW.SOLARDECATHLON.GOV U.S. DEPARTMENT OF ENERGY SOLAR DECATHLON
WIDE FLANGE 3/8" THROUGH BOLTS EVERY 2'-0" 1 - 2X4 RIPPED TO 2X1-3/4"		-B B B B B
		MARK DATE DESCRIPTION LOT NUMBER: 115 DRAWN BY: TEAM CAPITOL DC CHECKED BY: TEAM CAPITOL DC COPYRIGHT: NONE: PROJECT IS PUBLIC DOMAIN SHEET TITLE MODULE A EAST/WEST WALL
0 <u>1'2'</u> 4' 6		A-713



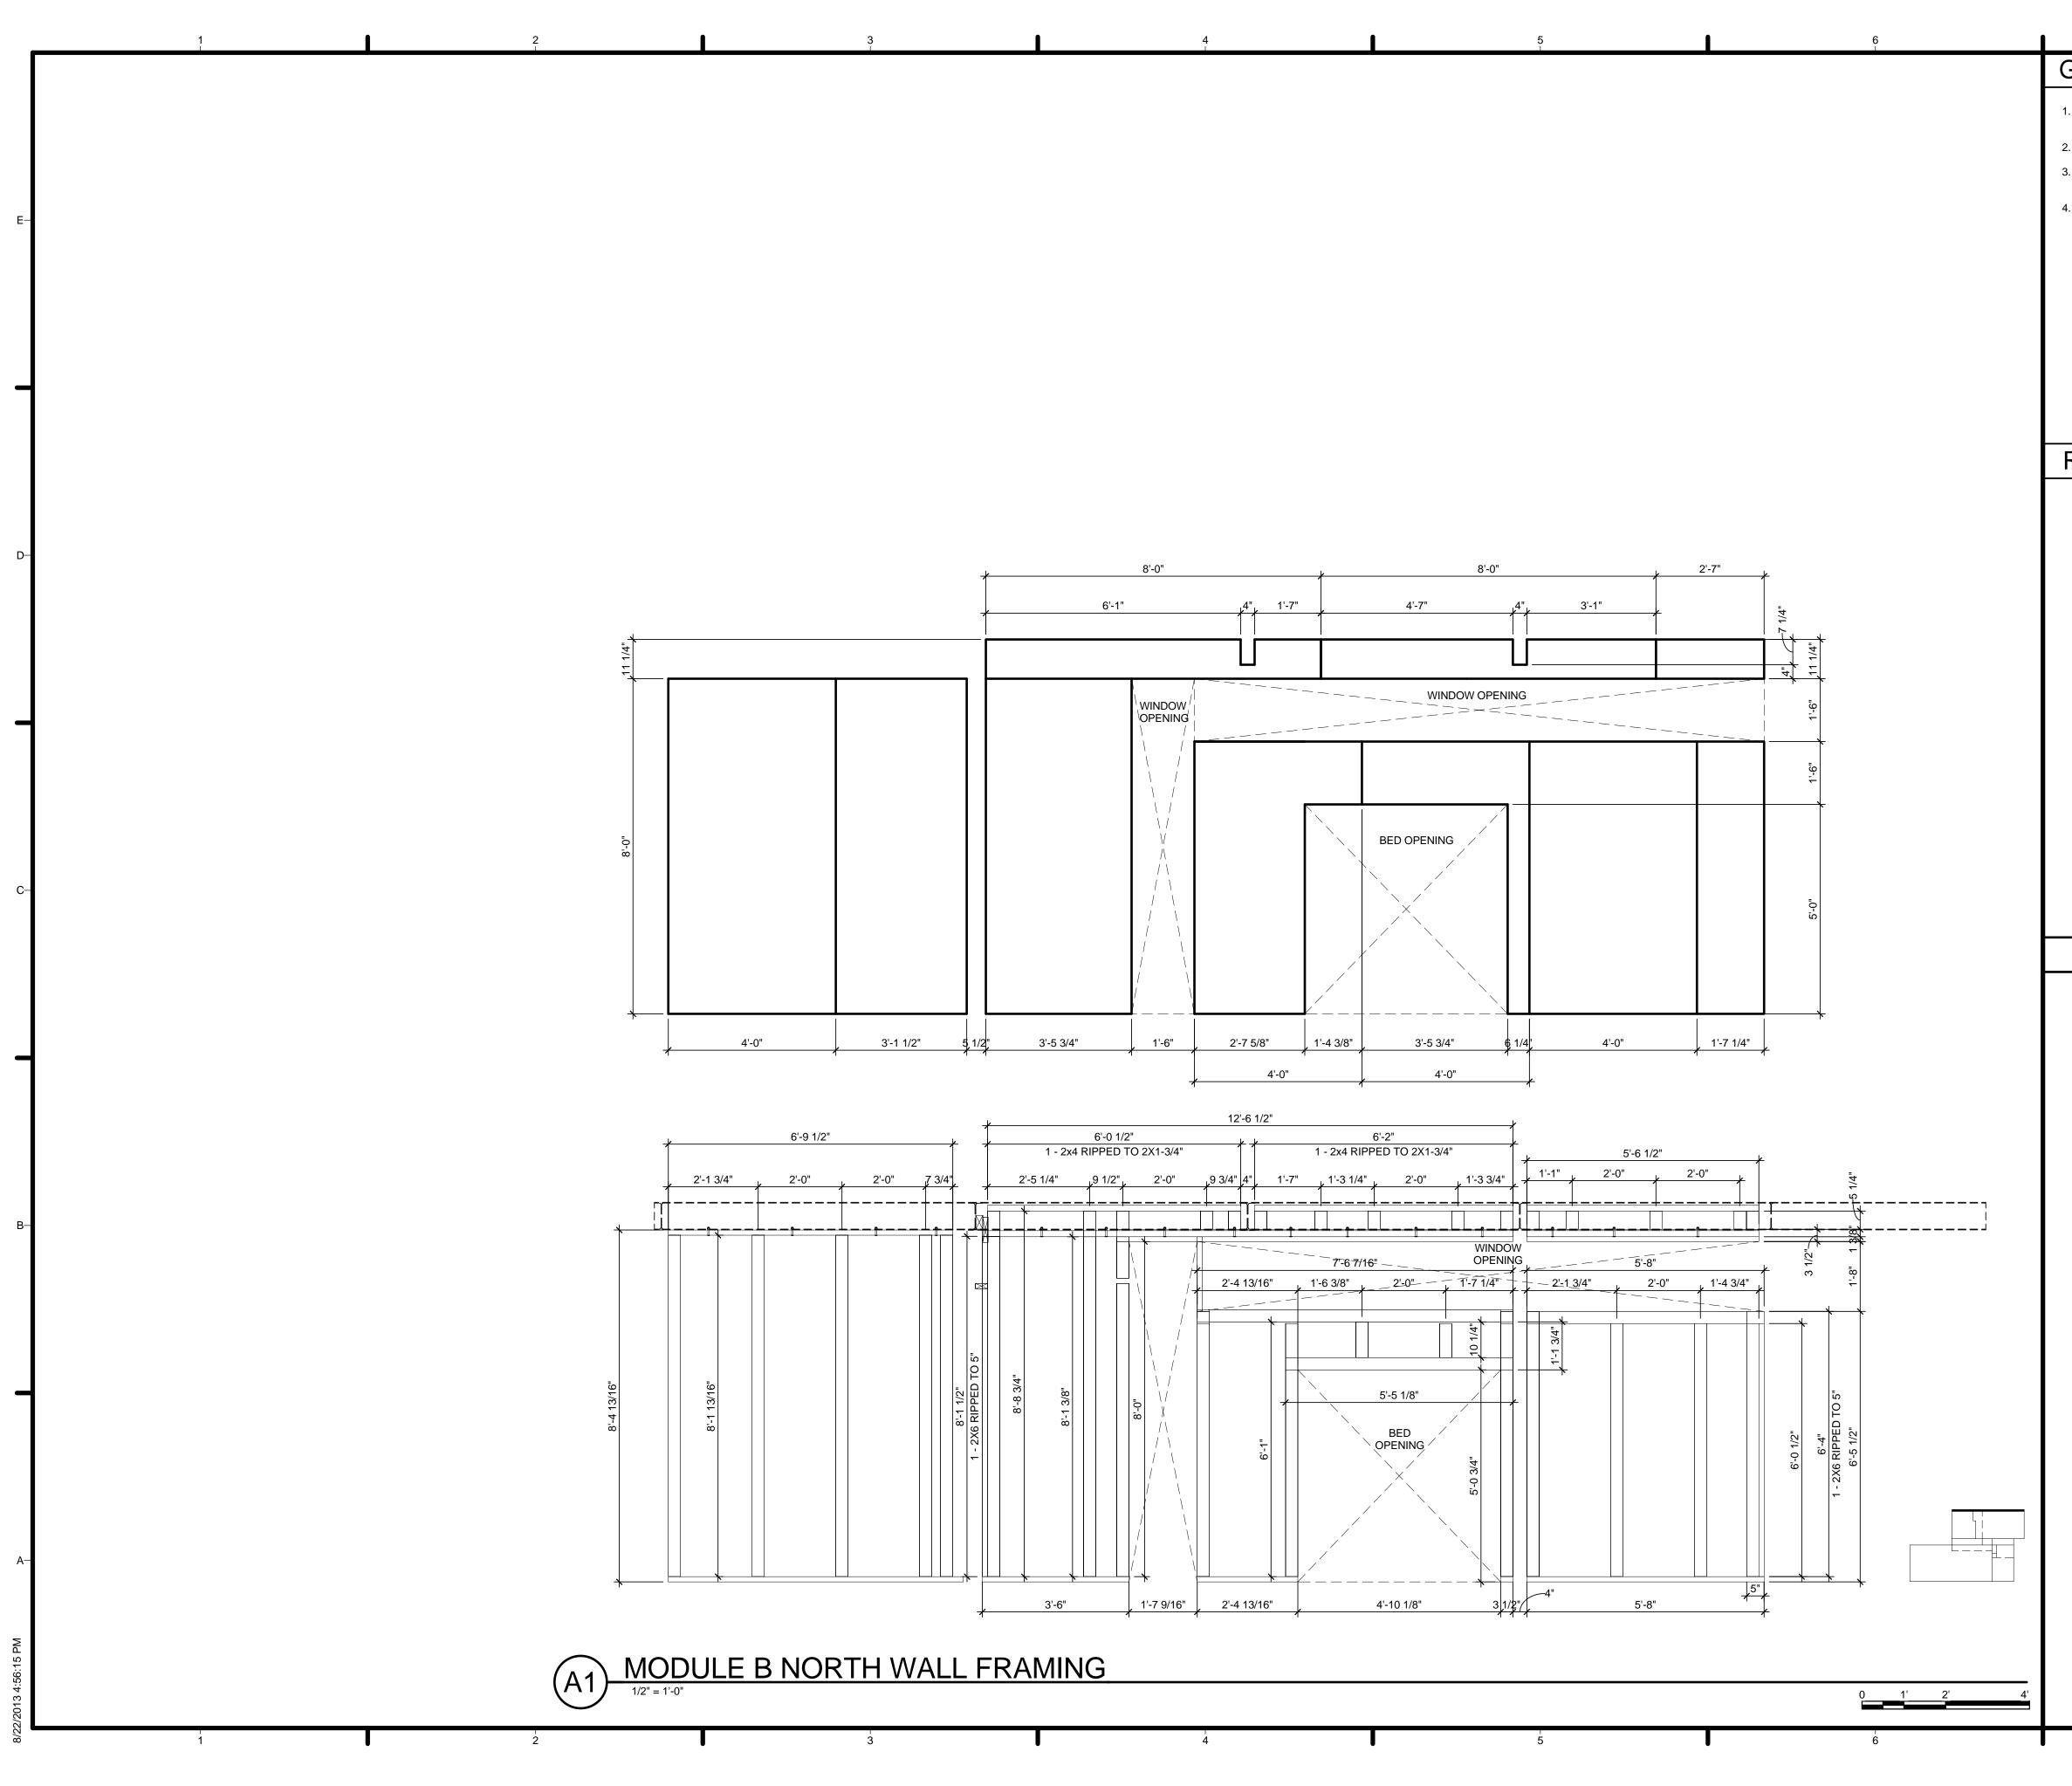


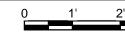


GENERAL SHEET NOTES]
 VERIFY ALL DIMENSIONS IN FIELD PRIOR TO FABRICATION AND INSTALLATION SEE SHEET C-102 FOR MODULE IDENTITY ALL STUDS (2) 2X4 UNLESS SPECIFIED OTHERWISE GYPSUM LAYOUT ABOVE FRAMING DRAWINGS 	-Е
	HARVEST
REFERENCE KEYNOTES	TEAM NAME: Team Capitol dc ADDRESS: THE CATHOLIC UNIVERSITY OF AMERICA SCHOOL OF ARCHITECTURE 620 MICHIGAN AVENUE, NE. WASHINGTON, DC 20064 STRUCTURAL ENGINEER
	-D BOB ALLISON, PE ARUP ENGINEERING 1120 CONNECTICUT AVENUE, NW., SUITE 200 WASHINGTON, DC 20036 TEL: 202.729.8220 MEP ENGINEER ARUP ENGINEERING
	1120 CONNECTICUT AVENUE, NW., SUITE 200 WASHINGTON, DC 20036 TEL: 202.729.8220 ARCHITECT OF RECORD WILLIAM JELEN, AIA 620 MICHIGAN AVE NE CROUGH CENTER WASHINGTON, DC 20064
	TEL: 202.344.5513
	-C CLIENT U.S. DEPARTMENT OF ENERGY
SHEET KEYNOTES	SOLAR DECATHLON 2013 WWW.SOLARDECATHLON.GOV
	-B
	4 2013.08.22 As-Built Submission MARK DATE DESCRIPTION LOT NUMBER: 115 DRAWN BY: TEAM CAPITOL DC
	CHECKED BY: TEAM CAPITOL DC COPYRIGHT: NONE: PROJECT IS PUBLIC DOMAIN SHEET TITLE
	MODULE A INTERIOR
	A-714



	GENERAL SHEET NOTES	Ì	
	 VERIFY ALL DIMENSIONS IN FIELD PRIOR TO FABRICATION AND INSTALLATION SEE SHEET C-102 FOR MODULE IDENTITY ALL STUDS (2) 2X4 UNLESS SPECIFIED OTHERWISE GYPSUM LAYOUT ABOVE FRAMING DRAWINGS 	-E	HARVEST CAPITOL
	REFERENCE KEYNOTES		TEAM NAME: Team Capitol dc ADDRESS: THE CATHOLIC UNIVERSITY OF AMERICA SCHOOL OF ARCHITECTURE 620 MICHIGAN AVENUE, NE. WASHINGTON, DC 20064
		-D	STRUCTURAL ENGINEER BOB ALLISON, PE ARUP ENGINEERING 1120 CONNECTICUT AVENUE, NW., SUITE 200 WASHINGTON, DC 20036 TEL: 202.729.8220 MEP ENGINEER ARUP ENGINEERING 1120 CONNECTICUT AVENUE, NW., SUITE 200 WASHINGTON, DC 20036 TEL: 202.729.8220 ARCHITECT OF RECORD WILLIAM JELEN, AIA 620 MICHIGAN AVE NE CROUGH CENTER WASHINGTON, DC 20064 TEL: 202.344.5513
	SHEET KEYNOTES	_c	CLIENT U.S. DEPARTMENT OF ENERGY SOLAR DECATHLON 2013 WWW.SOLARDECATHLON.GOV U.S. DEPARTMENT OF ENERGY
		—В	SOLAR DECATHLON
		<u> </u>	4 2013.08.22 As-Built Submission MARK DATE DESCRIPTION LOT NUMBER: 115 DRAWN BY: TEAM CAPITOL DC CHECKED BY: TEAM CAPITOL DC COPYRIGHT: NONE: PROJECT IS PUBLIC DOMAIN SHEET TITLE MODULE A INTERIOR MARK MARK
4'	7		WALLS A-715

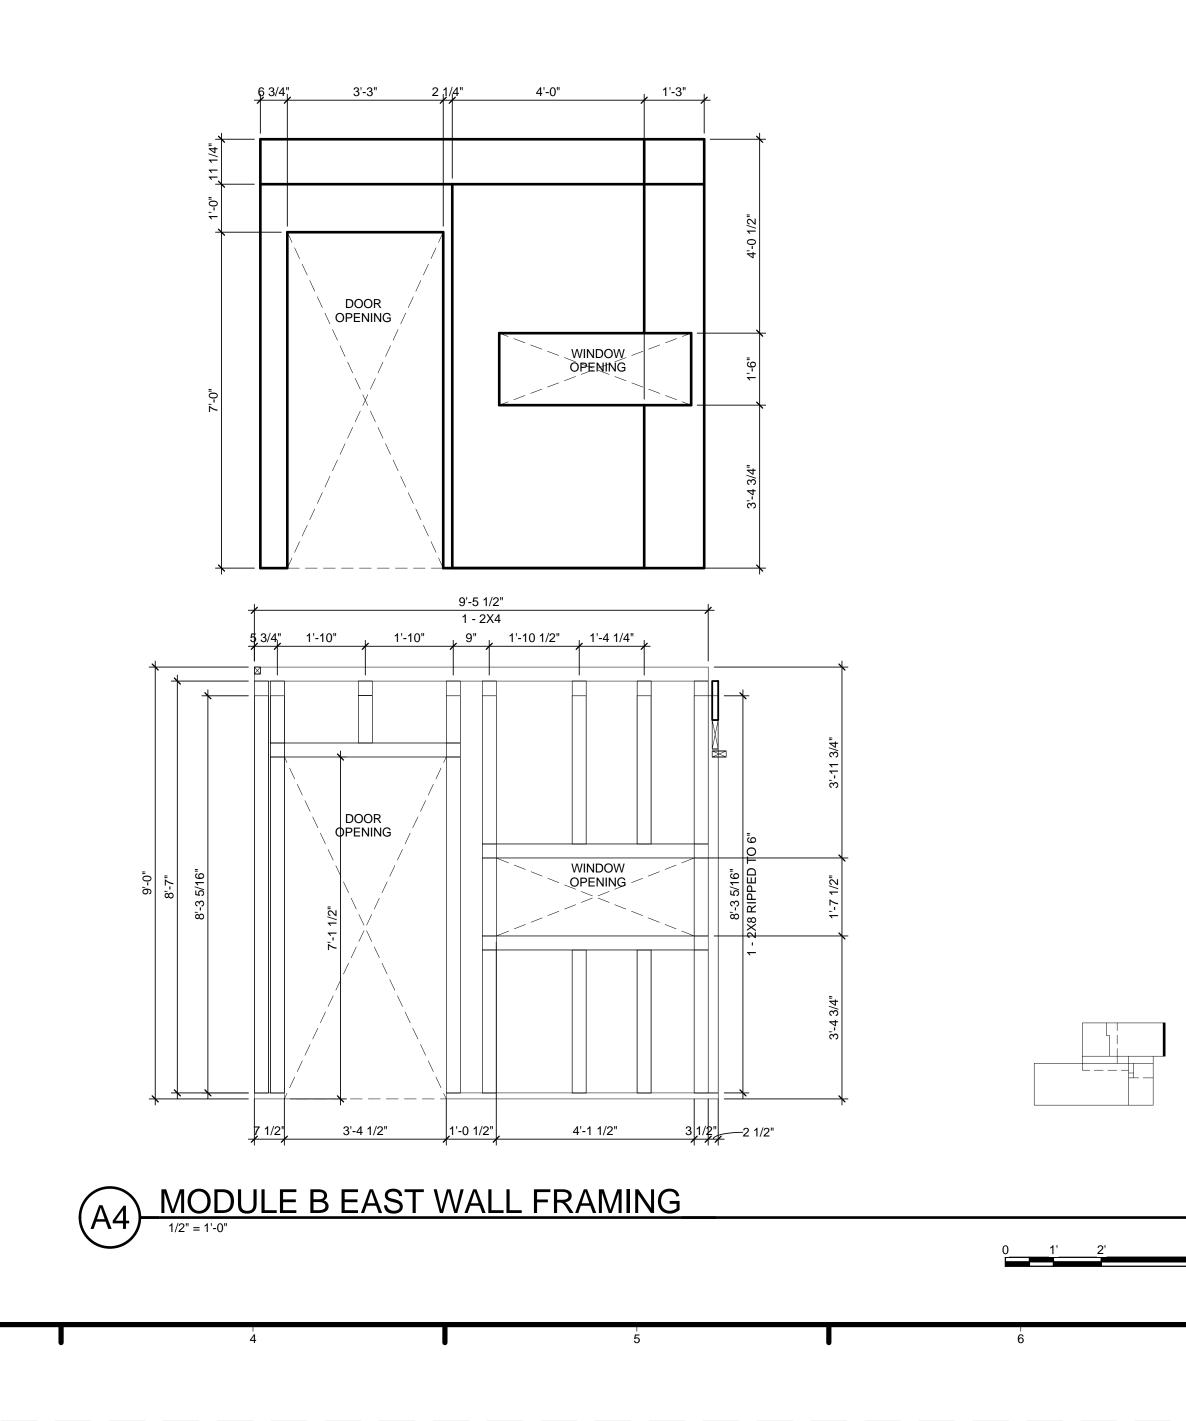






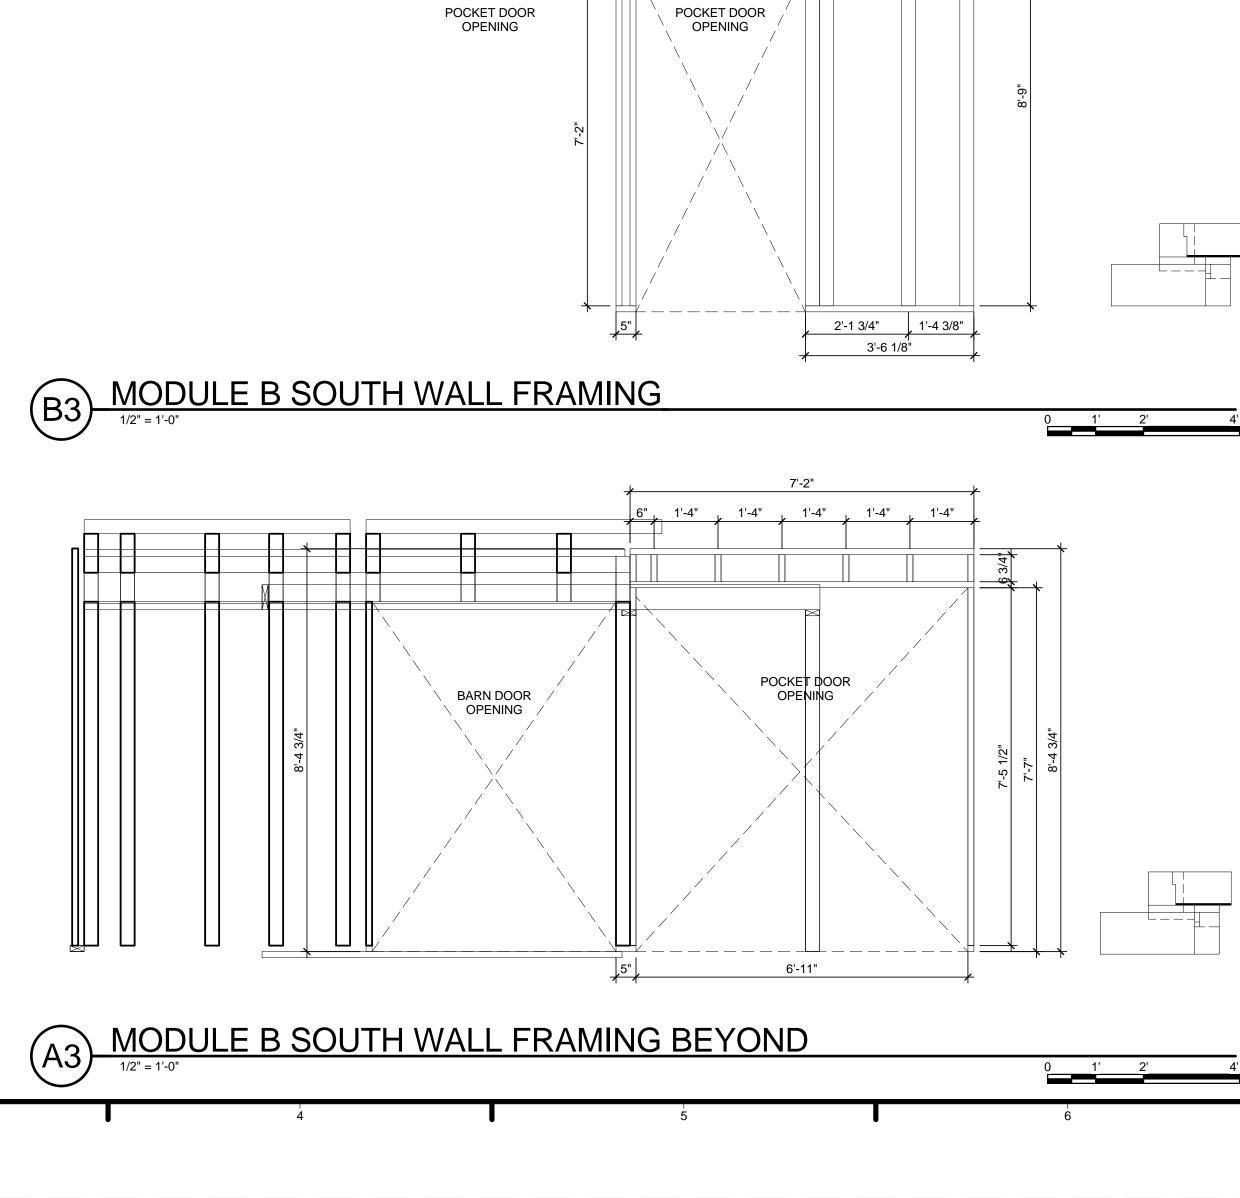
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 VERIFY ALL DIMENSIONS IN FIELD PRIOR TO FABRICATION AND INSTALLATION SEE SHEET C-102 FOR MODULE IDENTITY ALL STUDS (2) 2X4 UNLESS SPECIFIED OTHERWISE GYPSUM LAYOUT ABOVE FRAMING DRAWINGS 	-E HARVEST LAM dc	
REFERENCE KEYNOTES	 TEAM NAME: Team Capitol d ADDRESS: THE CATHOLIC UNIVERSITY OF AMERIC/ SCHOOL OF ARCHITECTURE 620 MICHIGAN AVENUE, NE WASHINGTON, DC 20064 STRUCTURAL ENGINEER BOB ALLISON, PE ARUP ENGINEERING 1120 CONNECTICUT AVENUE, NW., SUITE 200 WASHINGTON, DC 20036 TEL: 202.729.8220 MEP ENGINEER ARUP ENGINEERING 1120 CONNECTICUT AVENUE, NW., SUITE 200 WASHINGTON, DC 20036 TEL: 202.729.8220 ARCHITECT OF RECORD WILLIAM JELEN, AIA 620 MICHIGAN AVE NE CROUGH CENTER WASHINGTON, DC 20064 TEL: 202.344.5513 	
SHEET KEYNOTES	-C CLIENT U.S. DEPARTMENT OF ENERGY SOLAR DECATHLON 2013 WWW.SOLARDECATHLON.GOV U.S. DEPARTMENT OF ENERGY SOLAR DECATHLON	
	-B 4 2013.08.22 As-Built Submission MARK DATE DESCRIPTION LOT NUMBER: 115 DRAWN BY: TEAM CAPITOL DC	
	CHECKED BY: TEAM CAPITOL DC COPYRIGHT: NONE: PROJECT IS PUBLIC DOMAIN SHEET TITLE MODULE B NORTH WALL A-716	

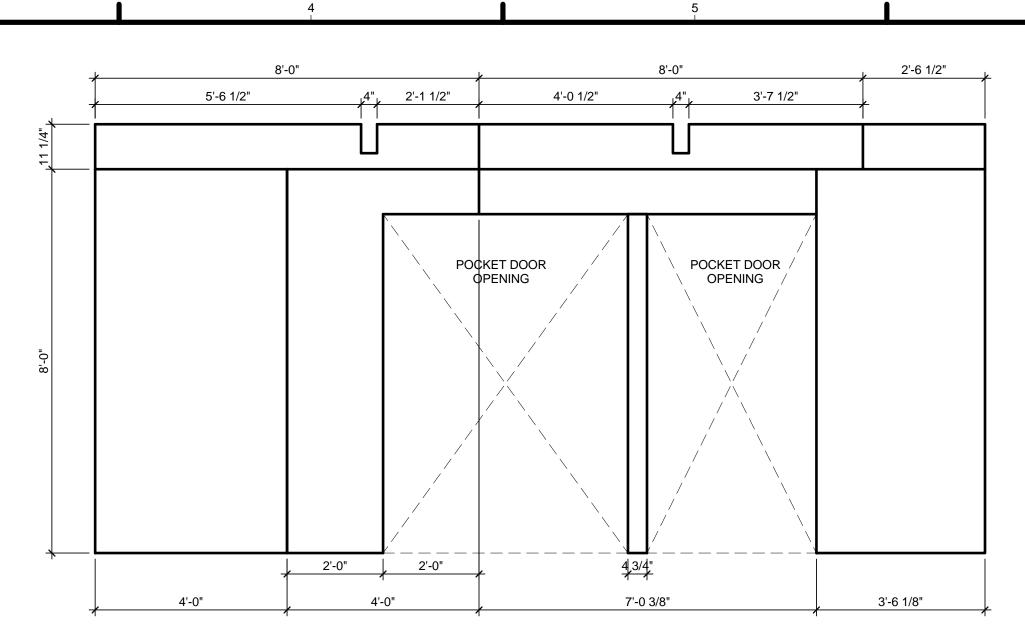
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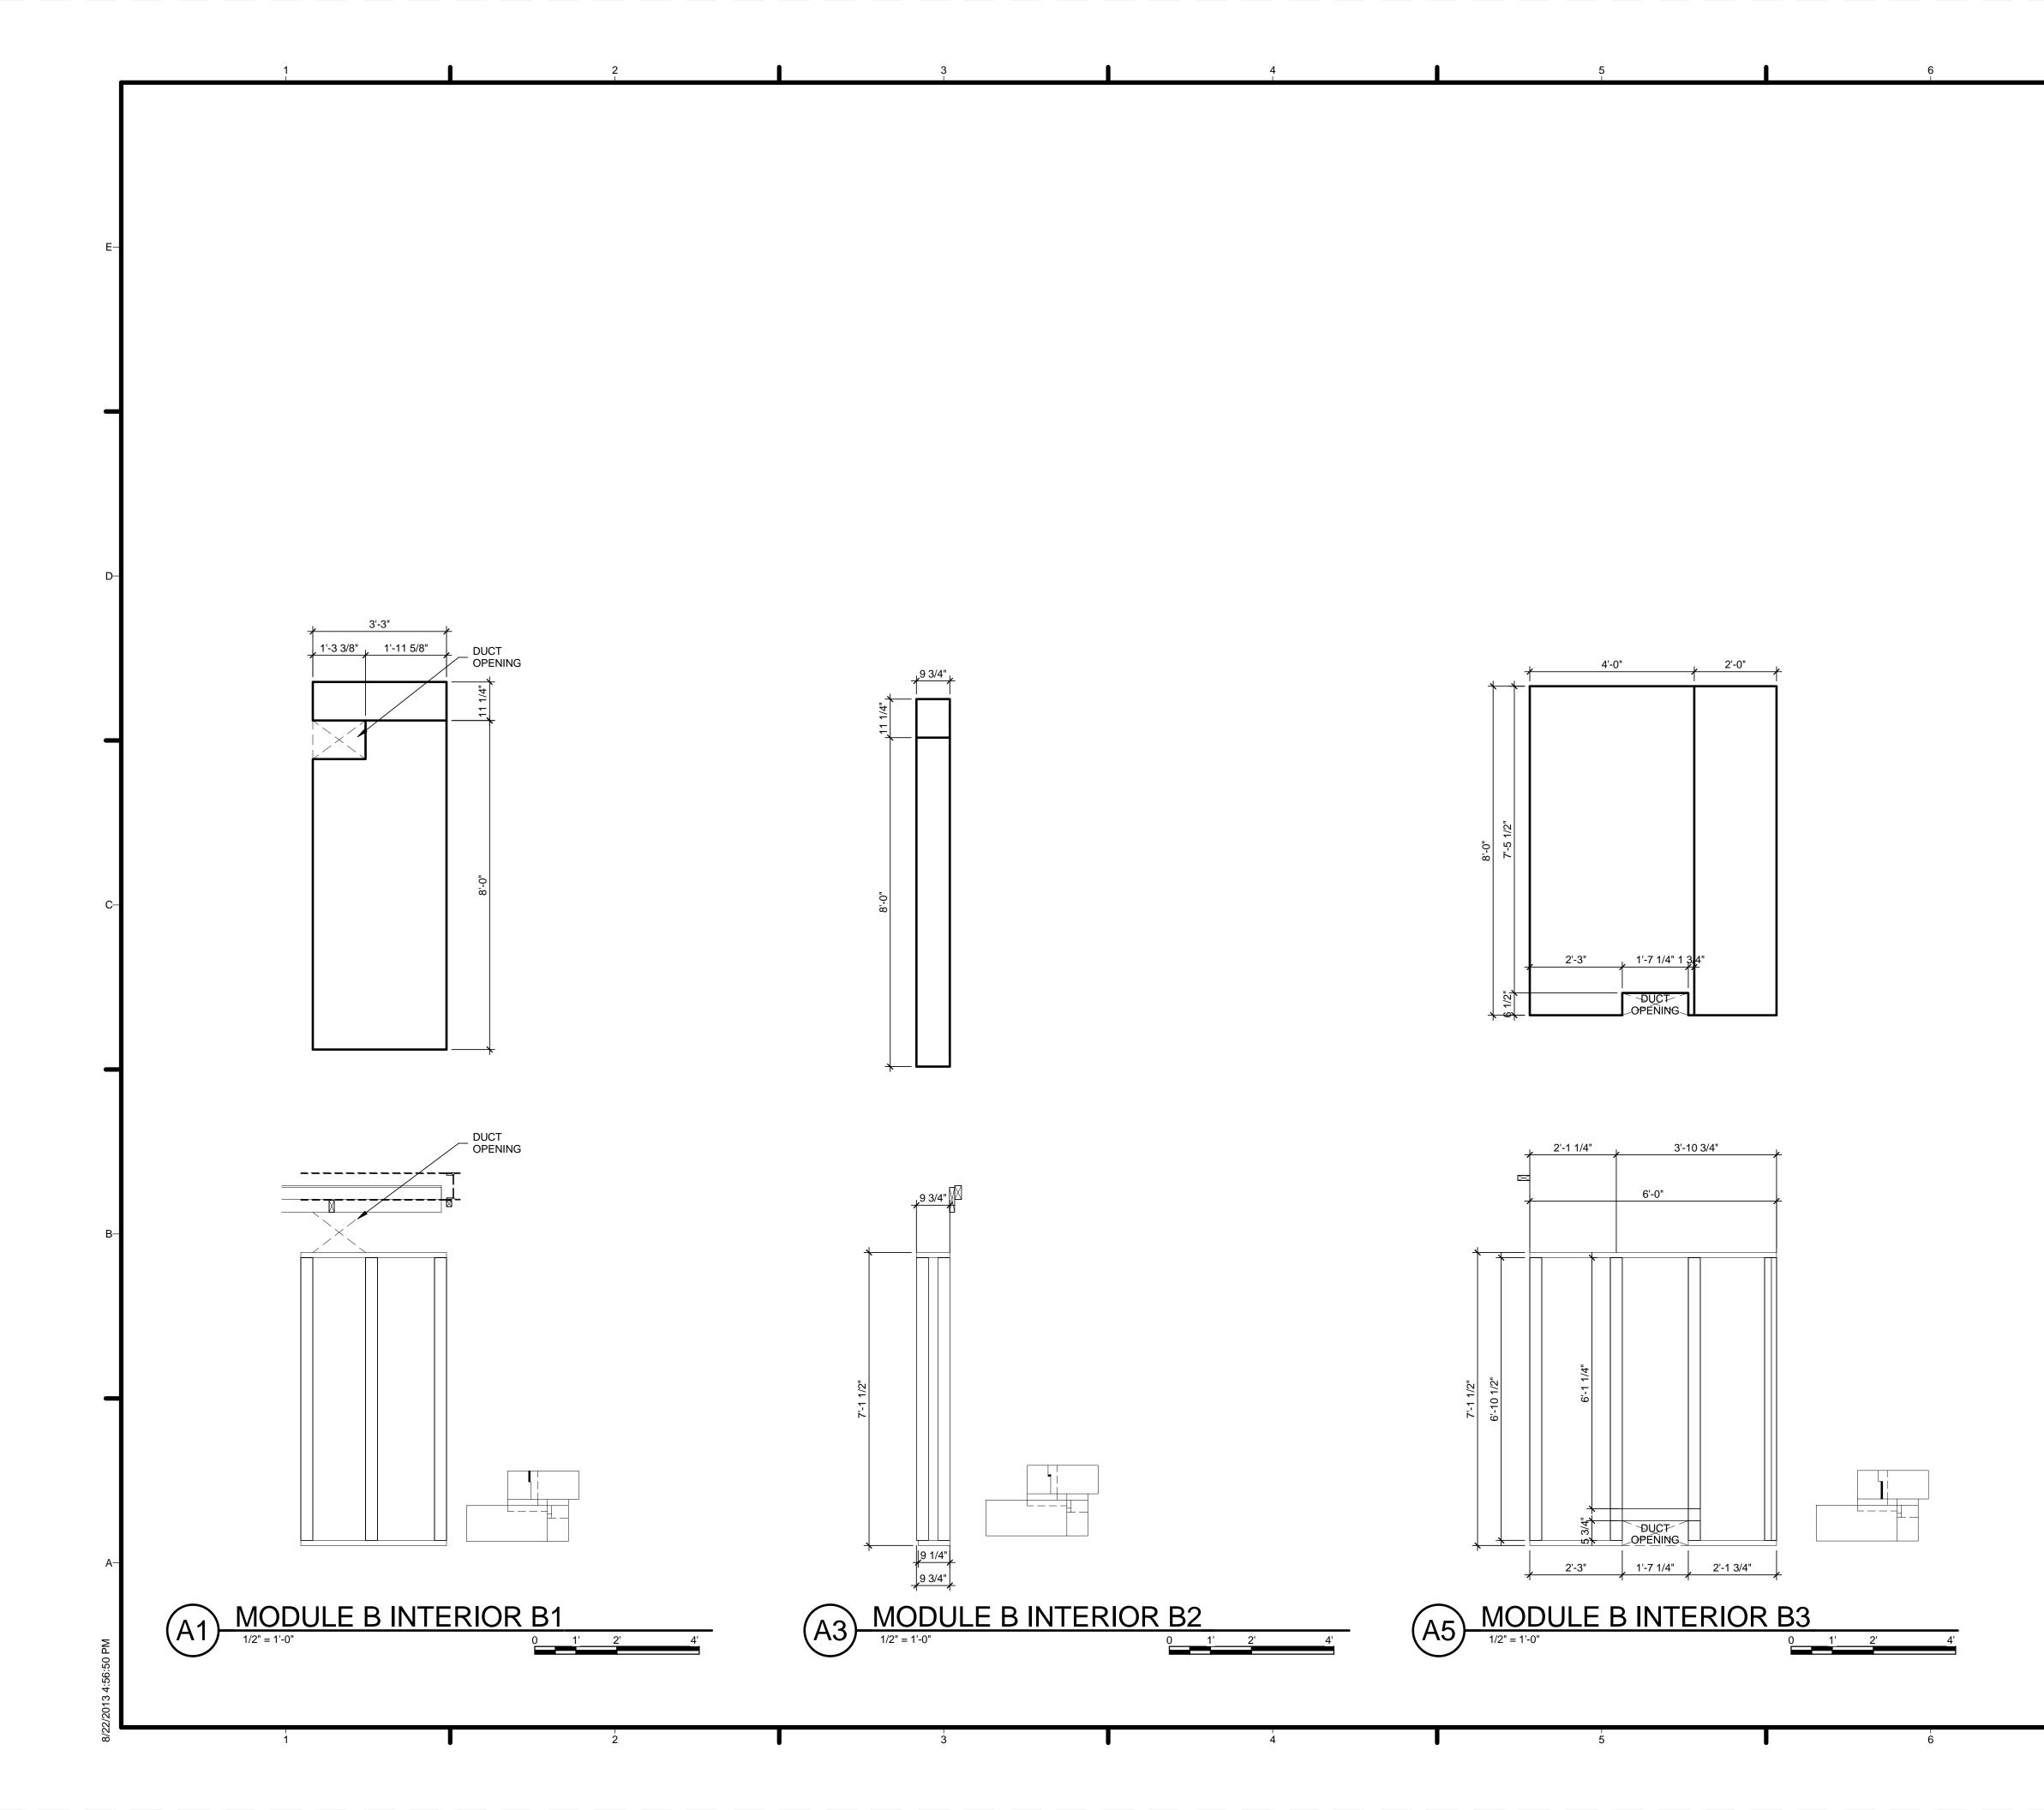
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<u>1'-7 1/2" 1'-2 1/8" 2'-0"</u>

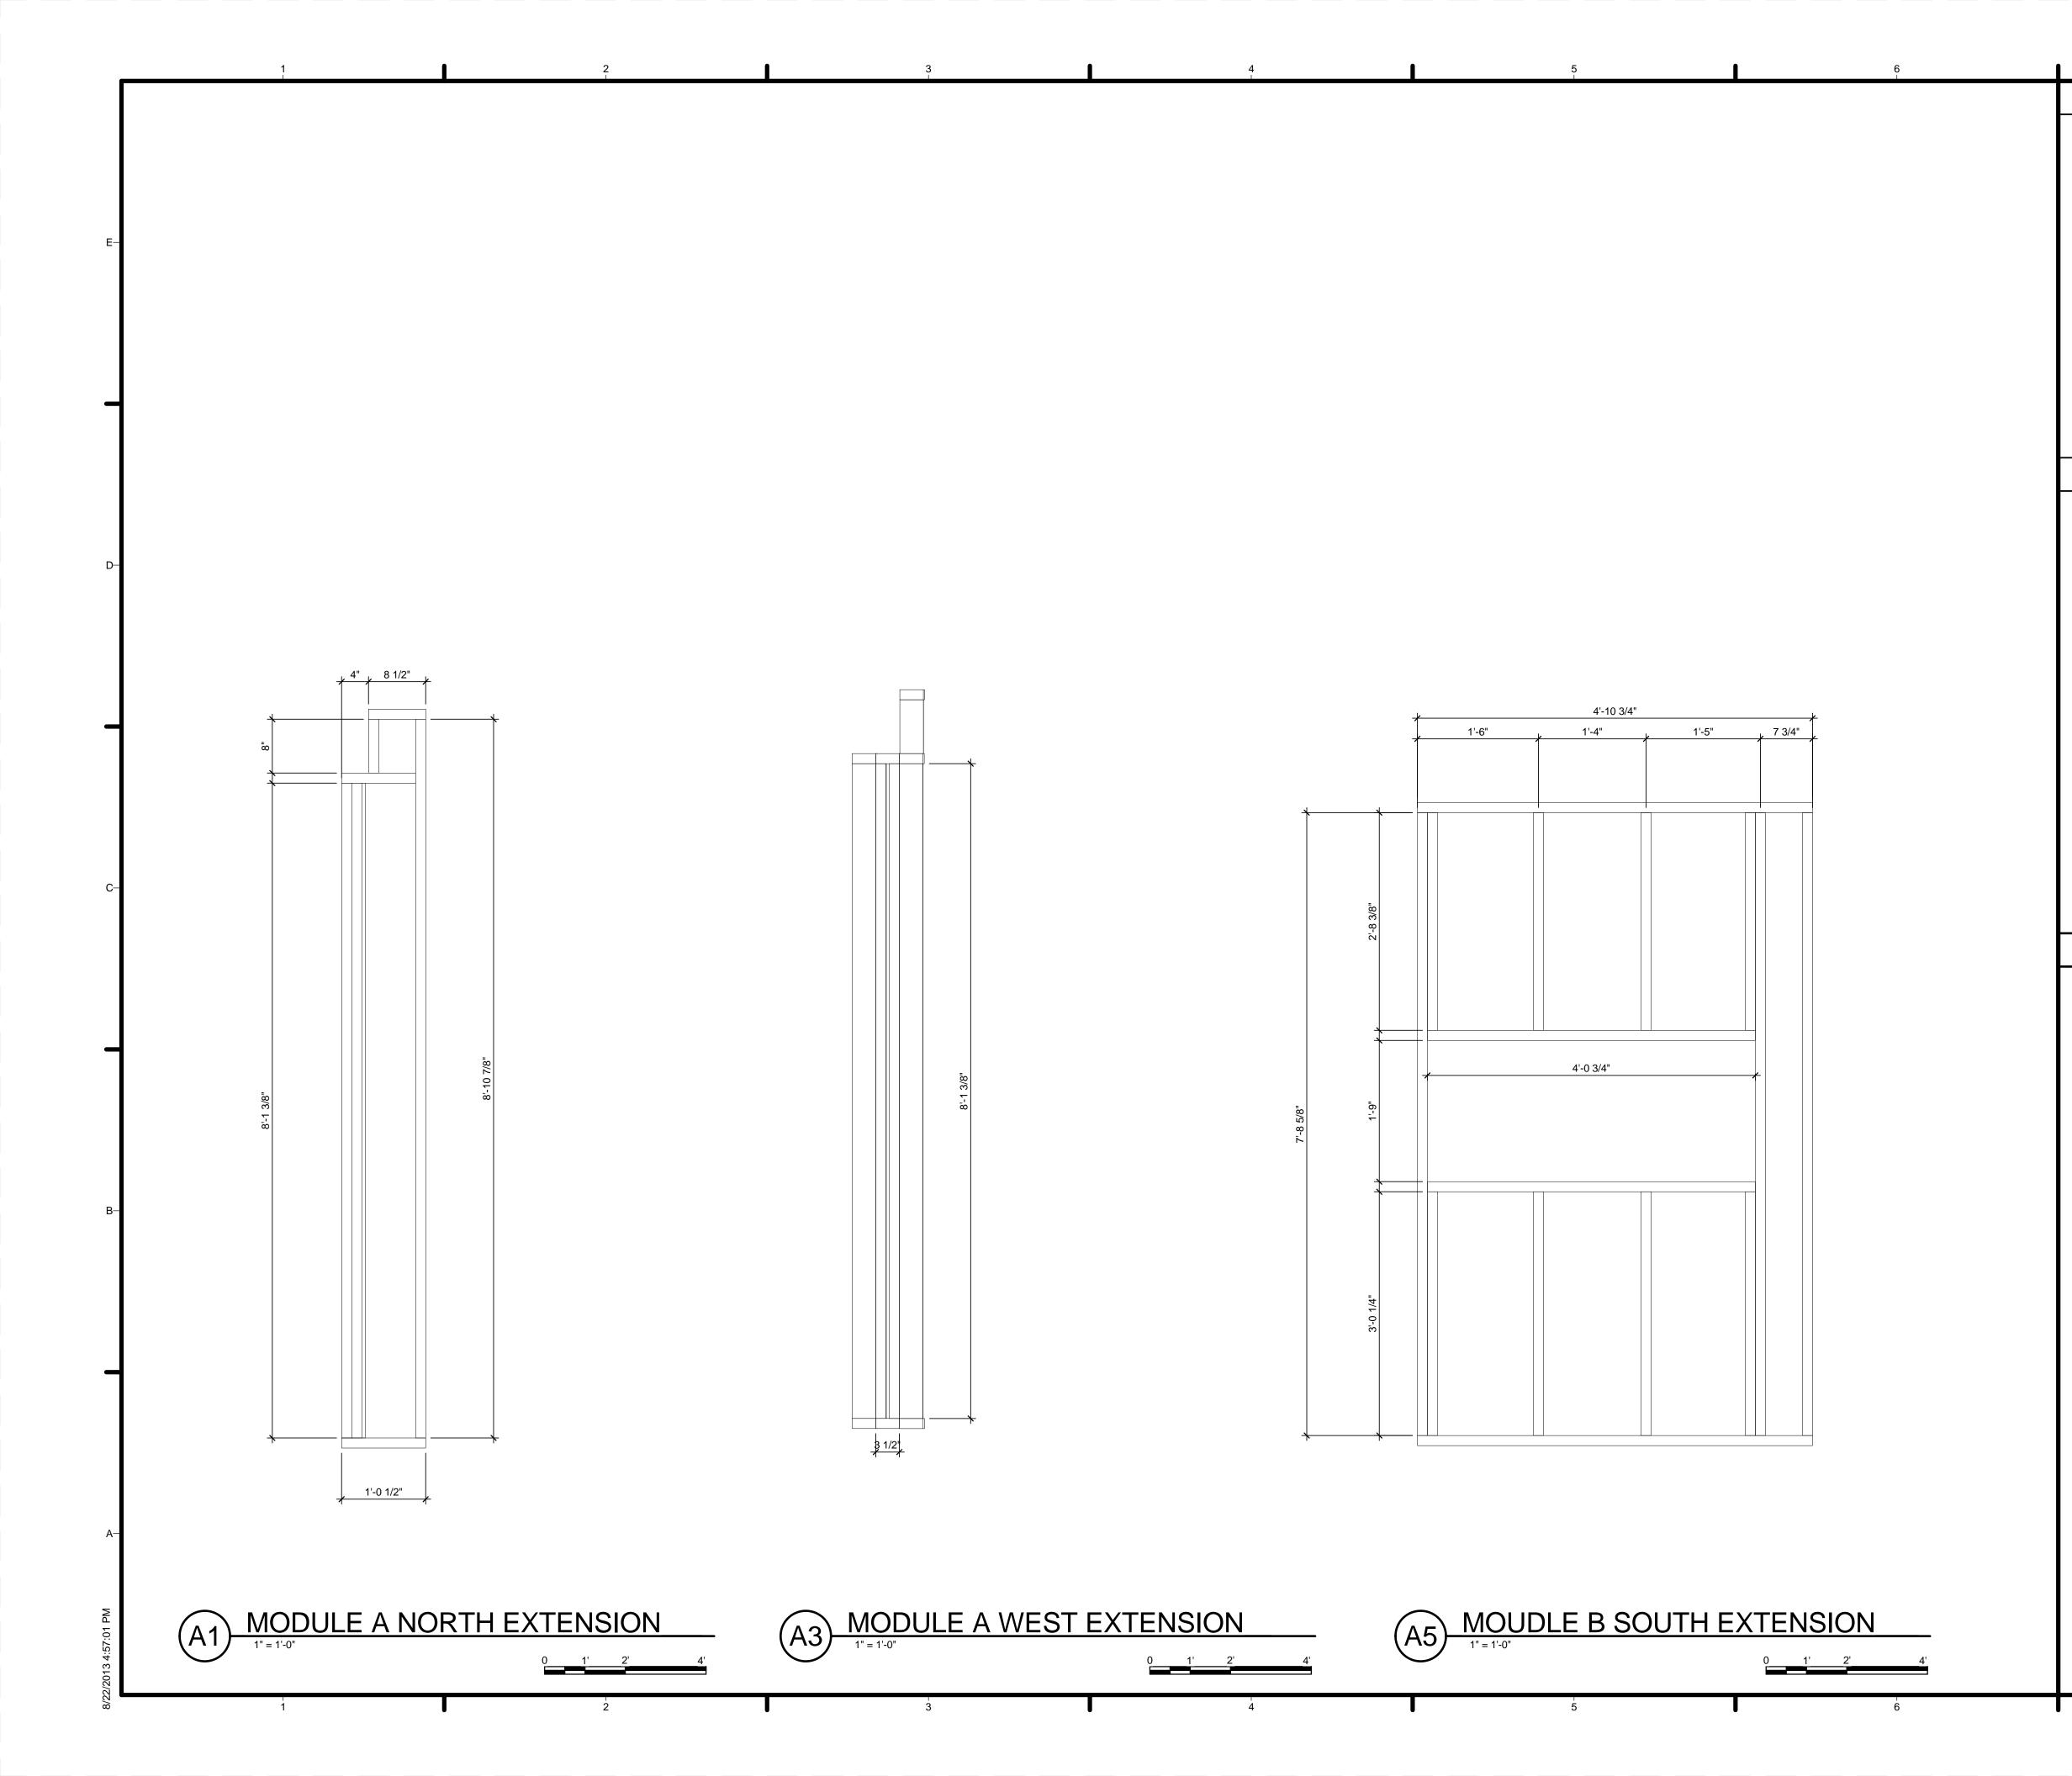
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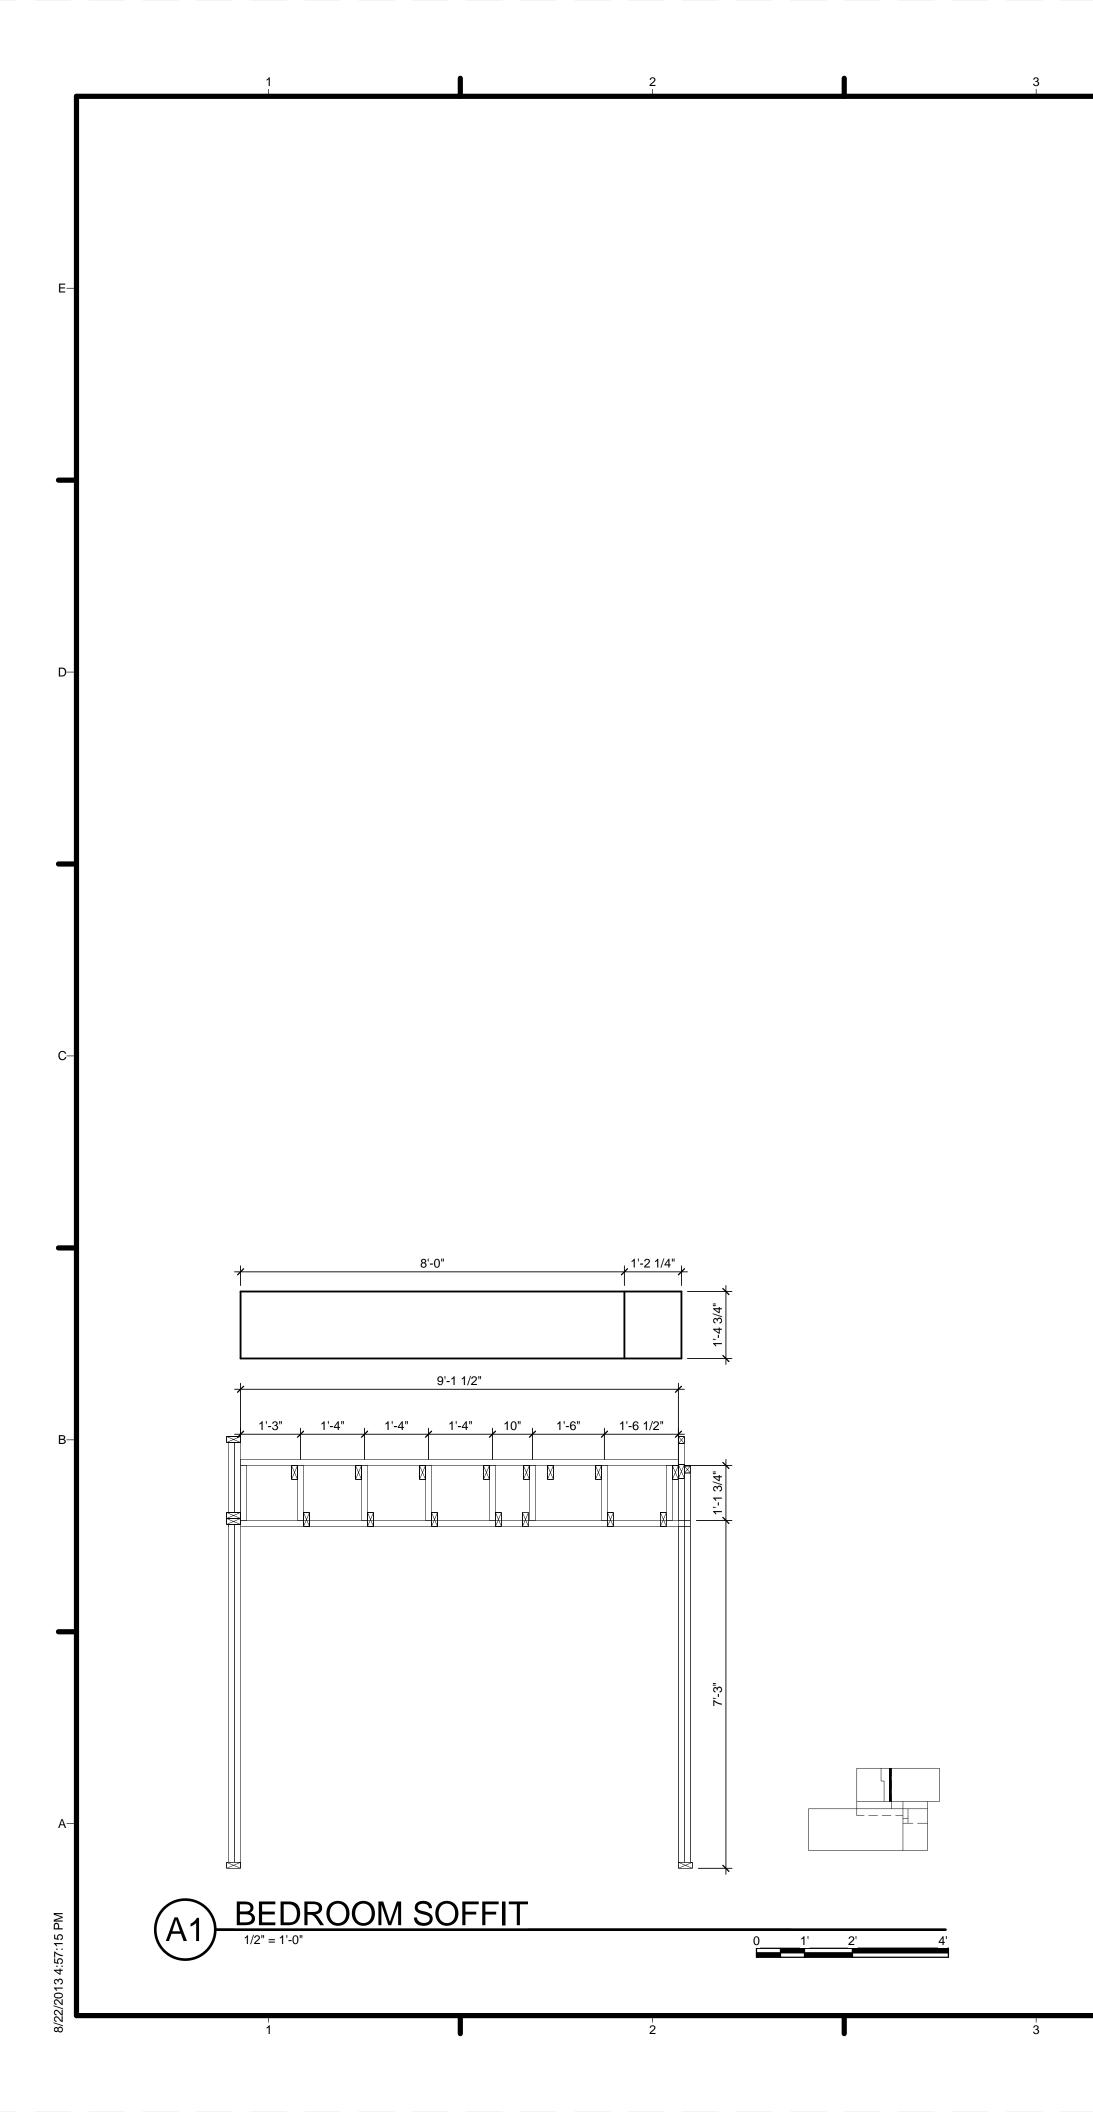
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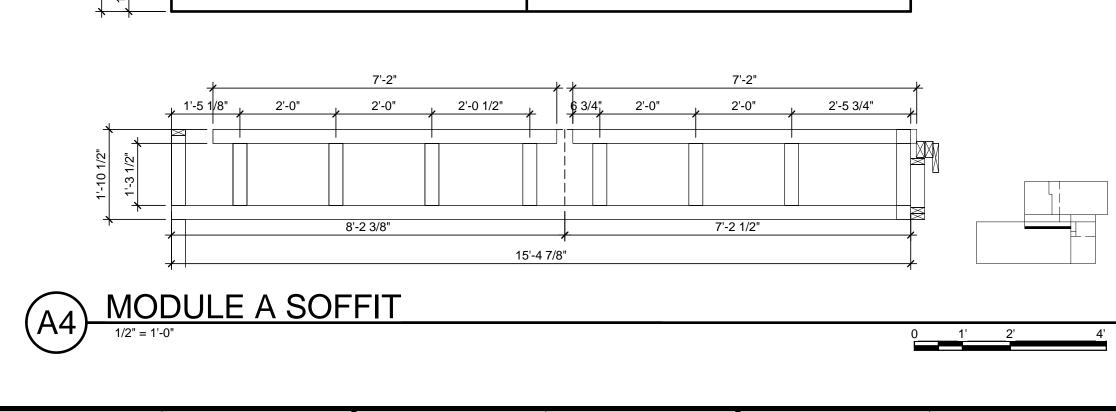


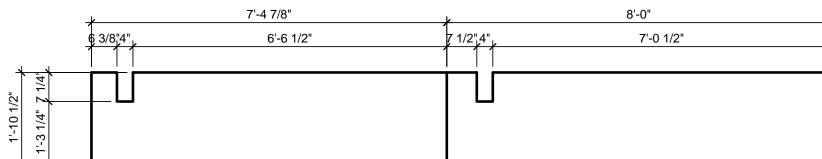
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 VERIFY ALL DIMENSIONS IN FIELD PRIOR TO FABRICATION AND INSTALLATION SEE SHEET C-102 FOR MODULE IDENTITY ALL STUDS (2) 2X4 UNLESS SPECIFIED OTHERWISE GYPSUM LAYOUT ABOVE FRAMING DRAWINGS 	-E HARVEST GC dc
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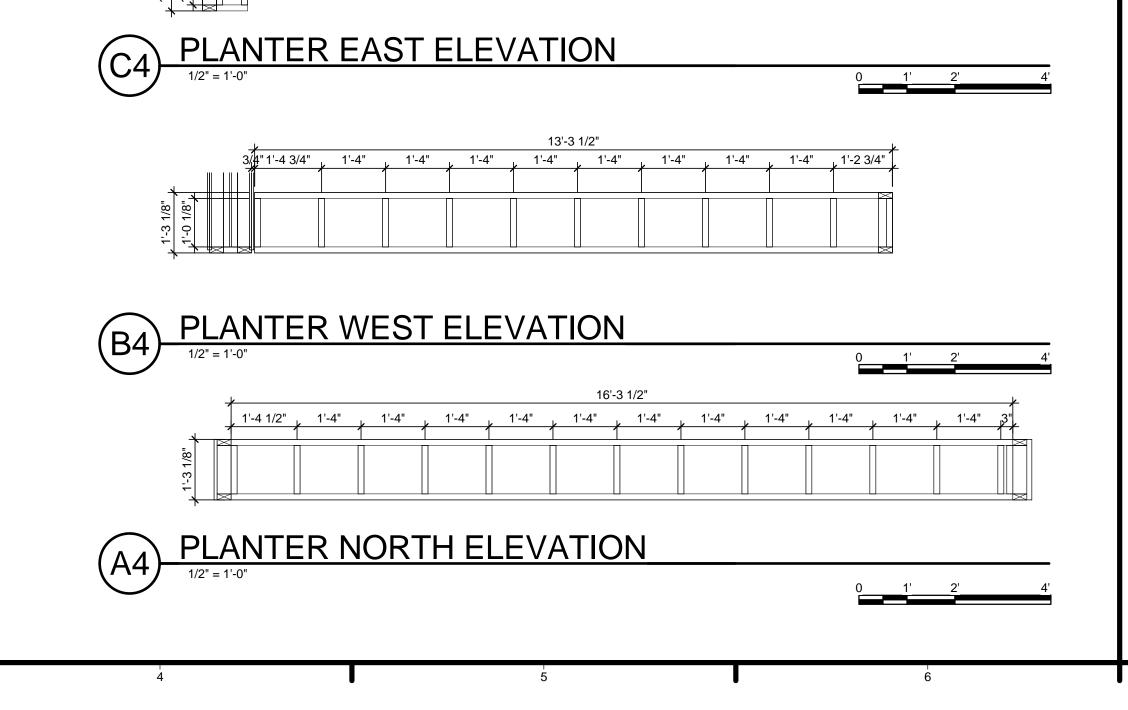






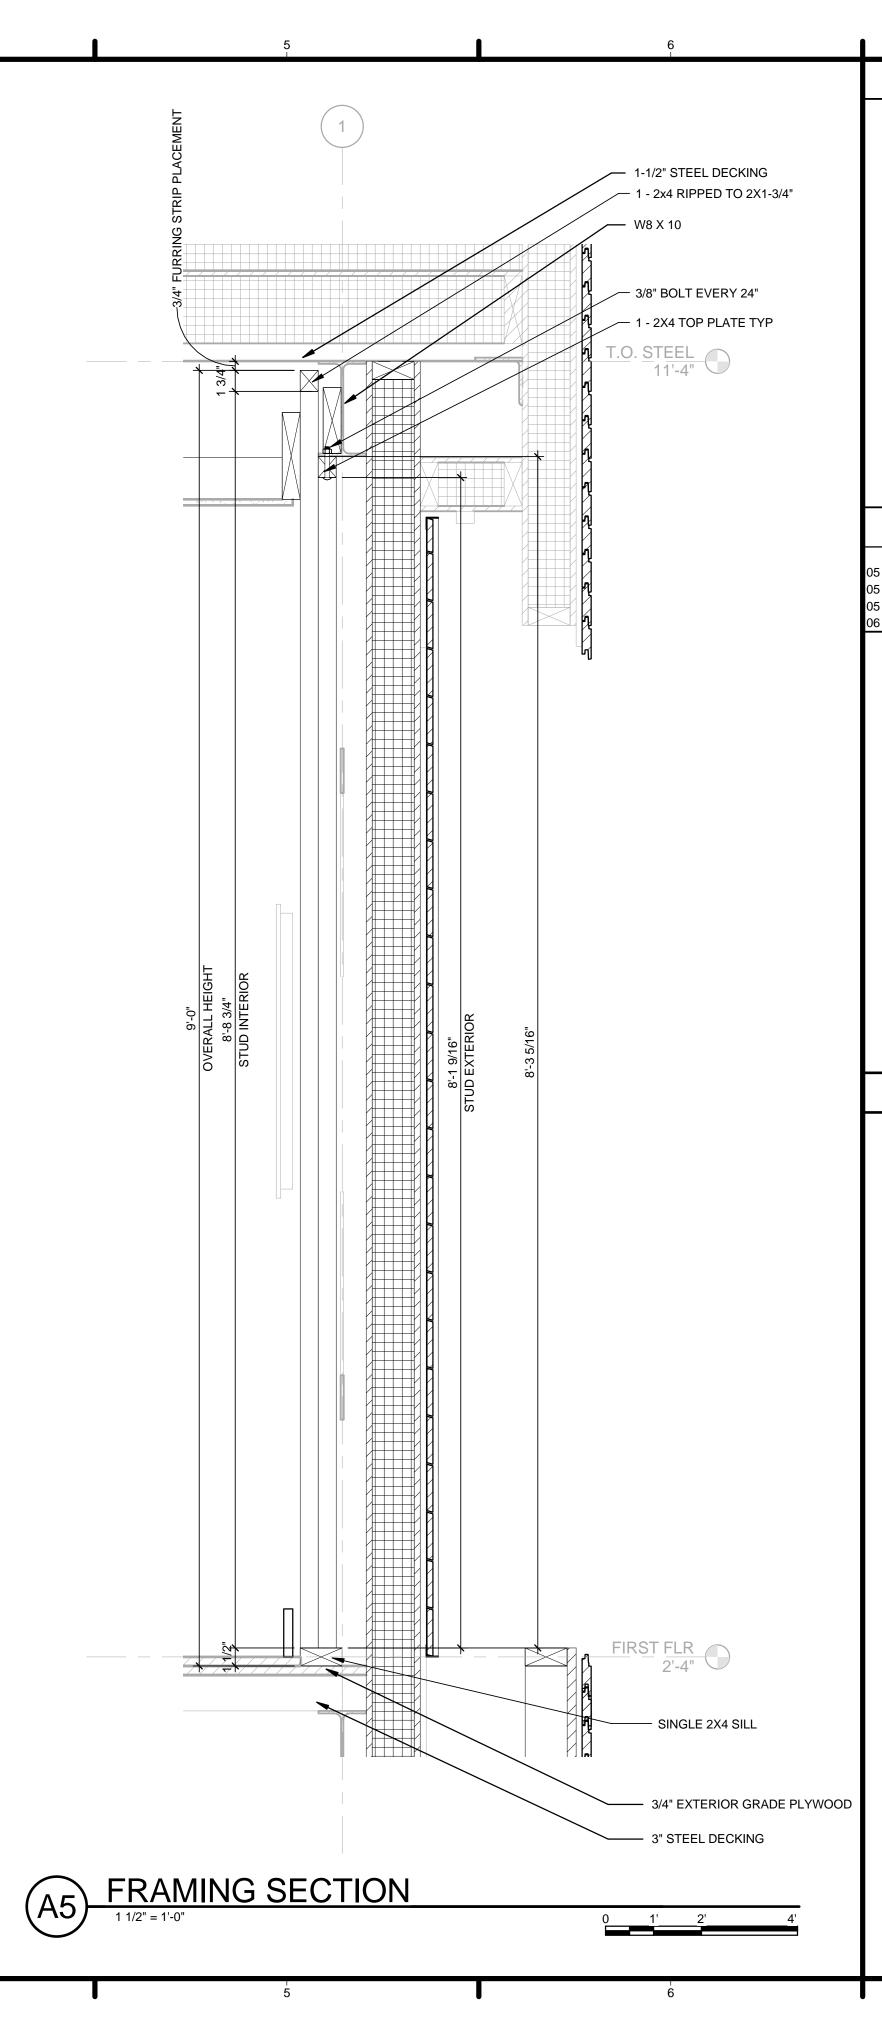
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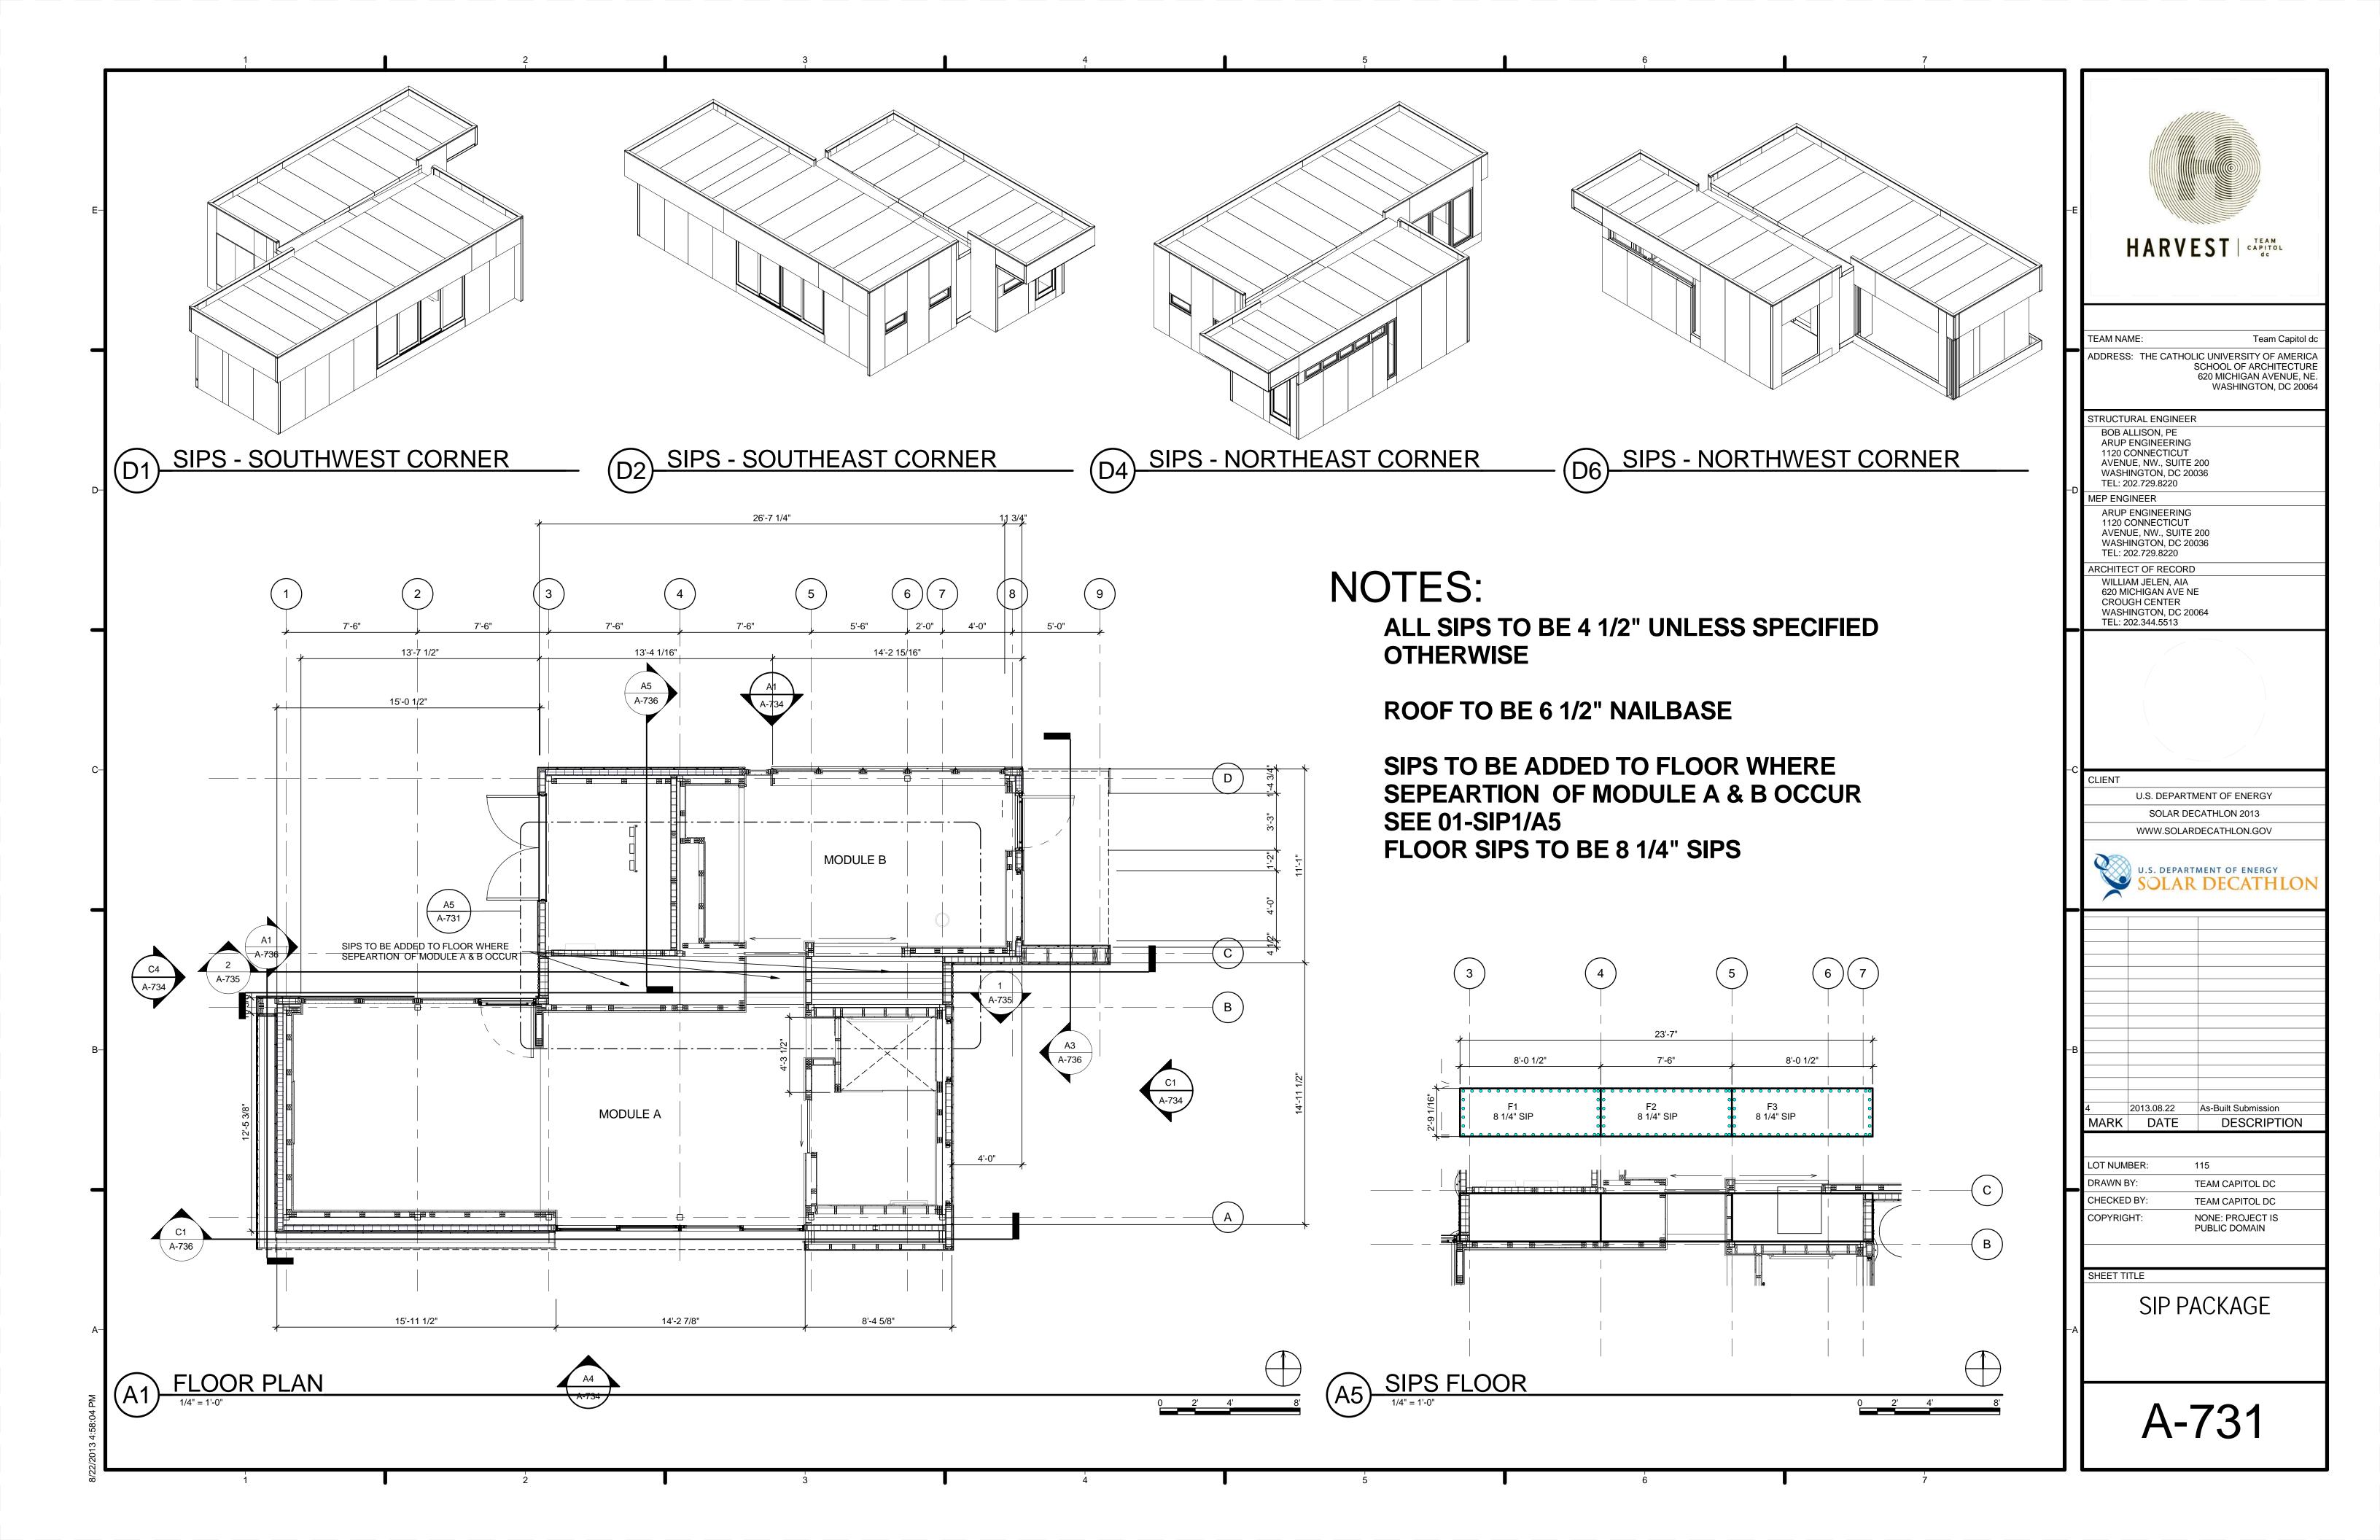


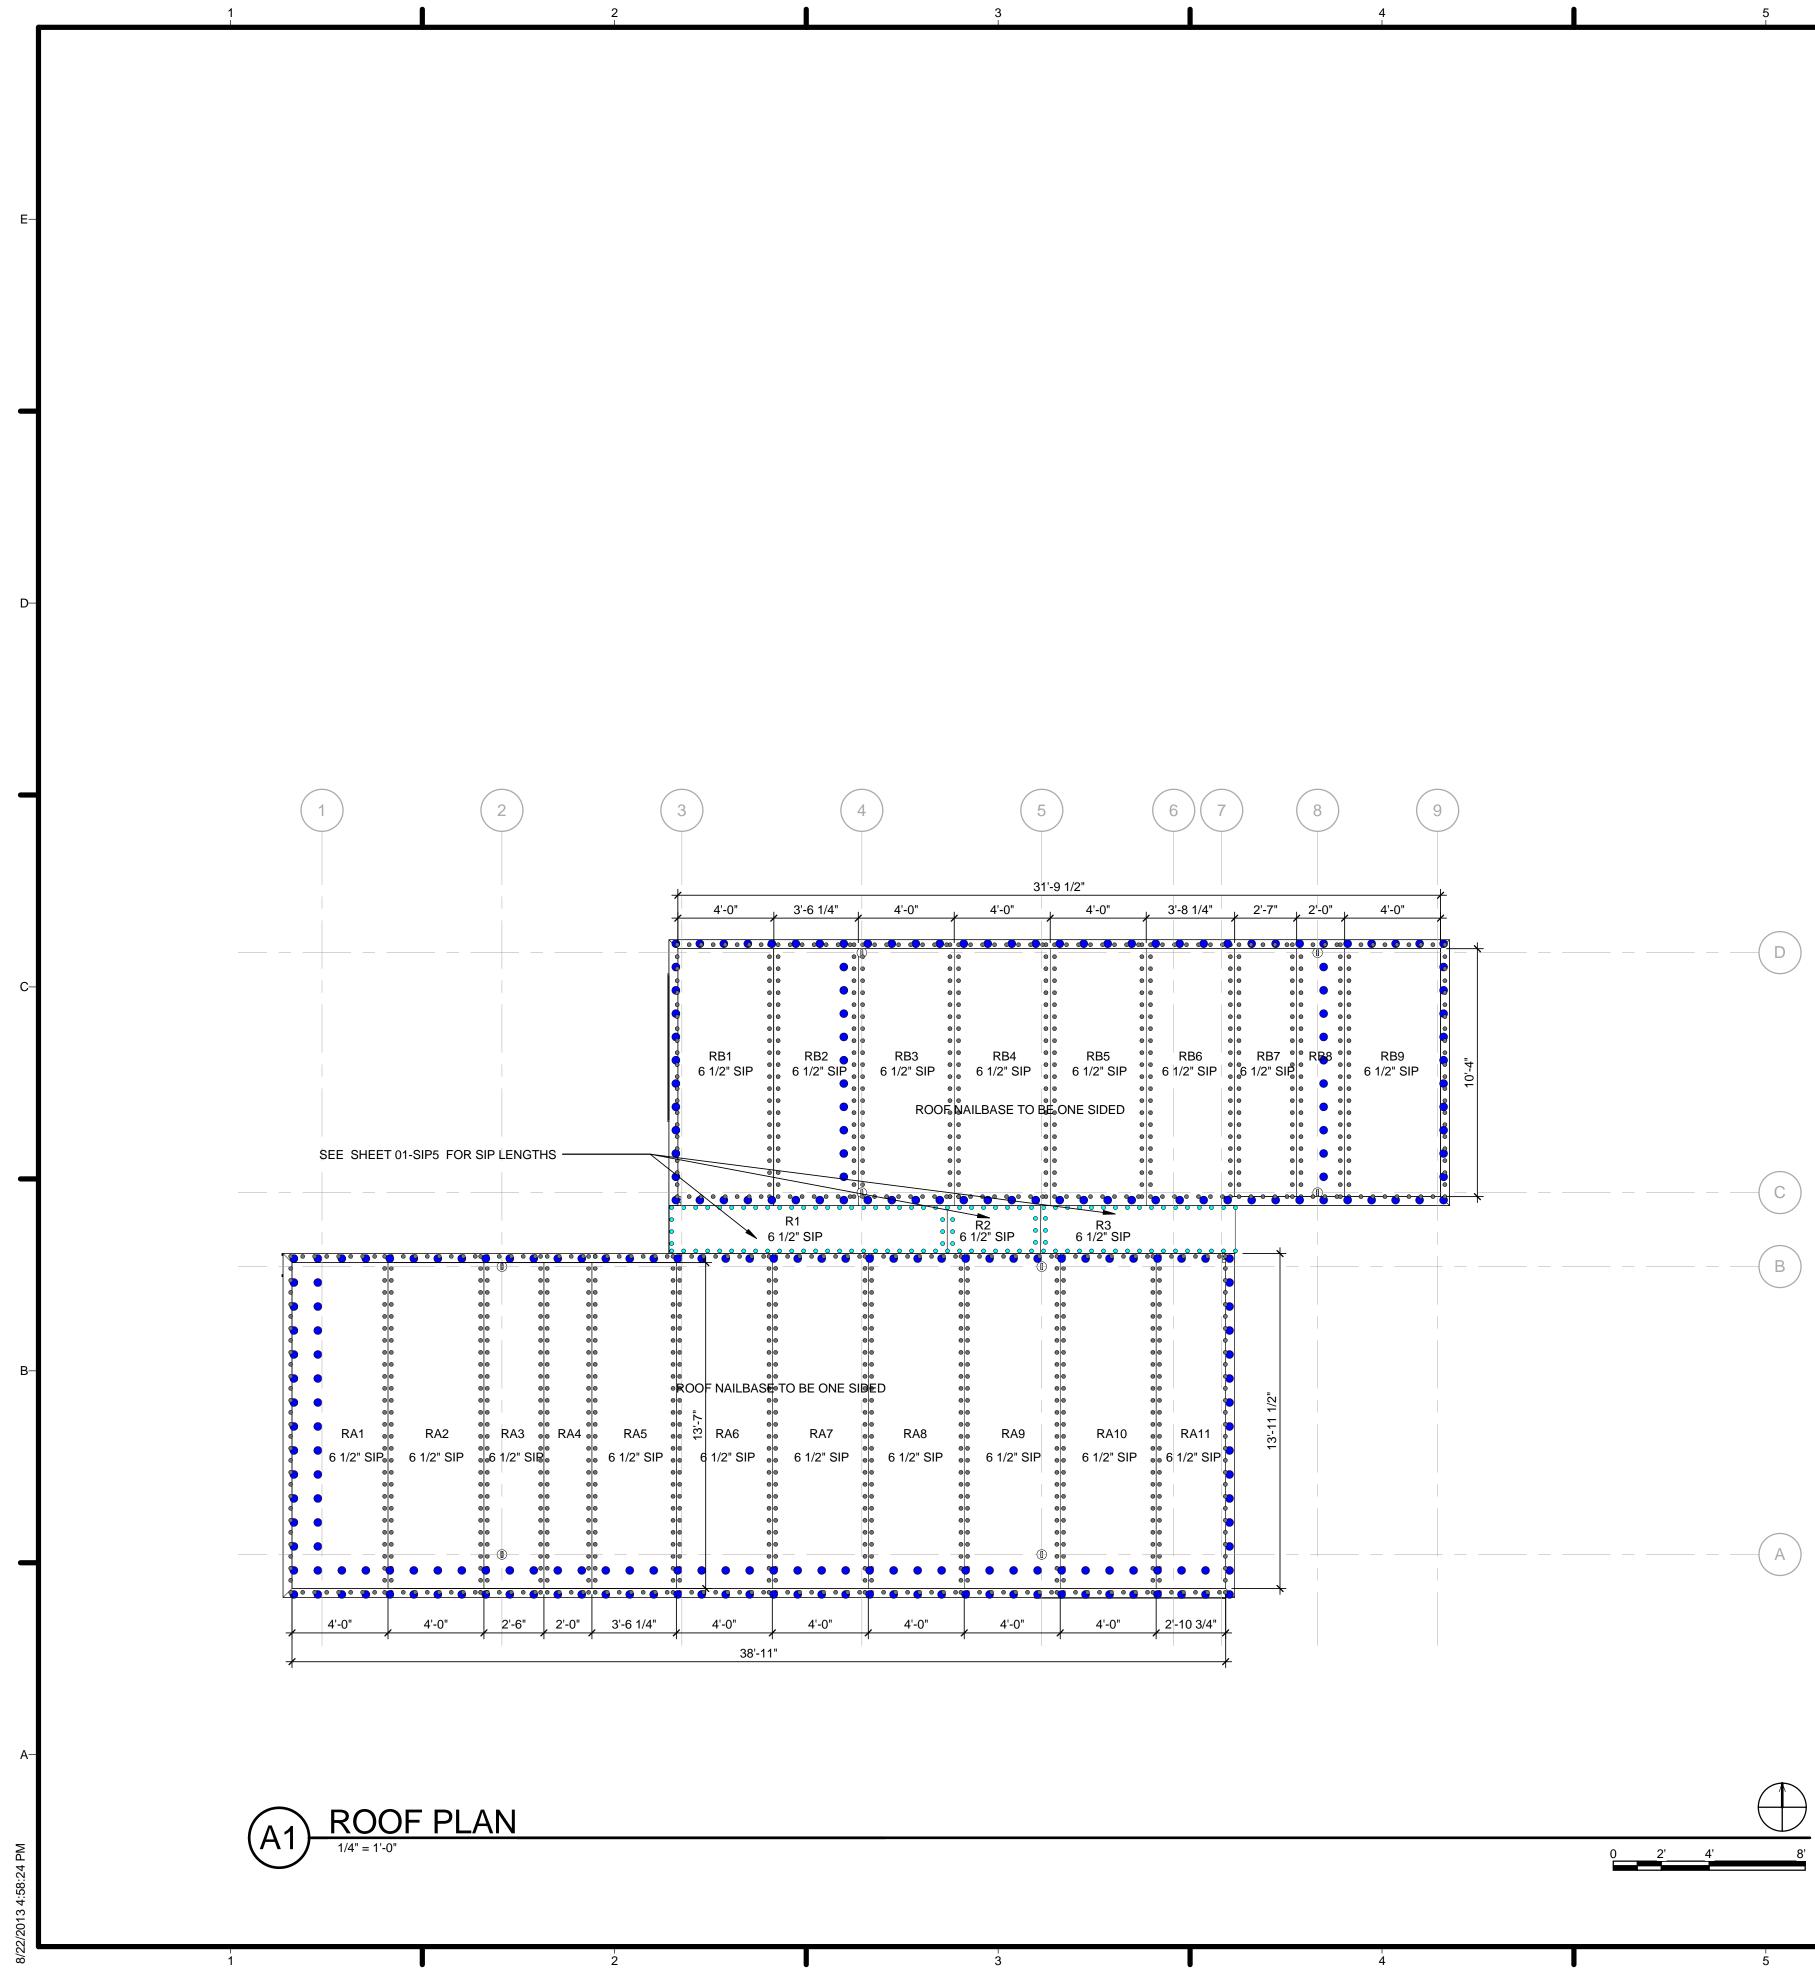
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	GENERAL SHEET NOTES	
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	4. GYPSUM LAYOUT ABOVE FRAMING DRAWINGS	E
		HARVEST
		TEAM NAME: Team Capitol dc ADDRESS: THE CATHOLIC UNIVERSITY OF AMERICA
		SCHOOL OF ARCHITECTURE 620 MICHIGAN AVENUE, NE. WASHINGTON, DC 20064
	REFERENCE KEYNOTES	STRUCTURAL ENGINEER BOB ALLISON, PE
		ARUP ENGINEERING 1120 CONNECTICUT AVENUE, NW., SUITE 200 WASHINGTON, DC 20036
		D TEL: 202.729.8220 MEP ENGINEER
		ARUP ENGINEERING 1120 CONNECTICUT AVENUE, NW., SUITE 200 WASHINGTON, DC 20036
		TEL: 202.729.8220 ARCHITECT OF RECORD WILLIAM JELEN, AIA
		620 MICHIGAN AVE NE CROUGH CENTER WASHINGTON, DC 20064 TEL: 202.344.5513
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		CLIENT U.S. DEPARTMENT OF ENERGY
	SHEET KEYNOTES	SOLAR DECATHLON 2013 WWW.SOLARDECATHLON.GOV
		U.S. DEPARTMENT OF ENERGY SOLAR DECATHLON
C4 PLANTER EAST ELEVATION		
		B
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PLANTER NORTH ELEVATION 1/2" = 1'-0"		A-722
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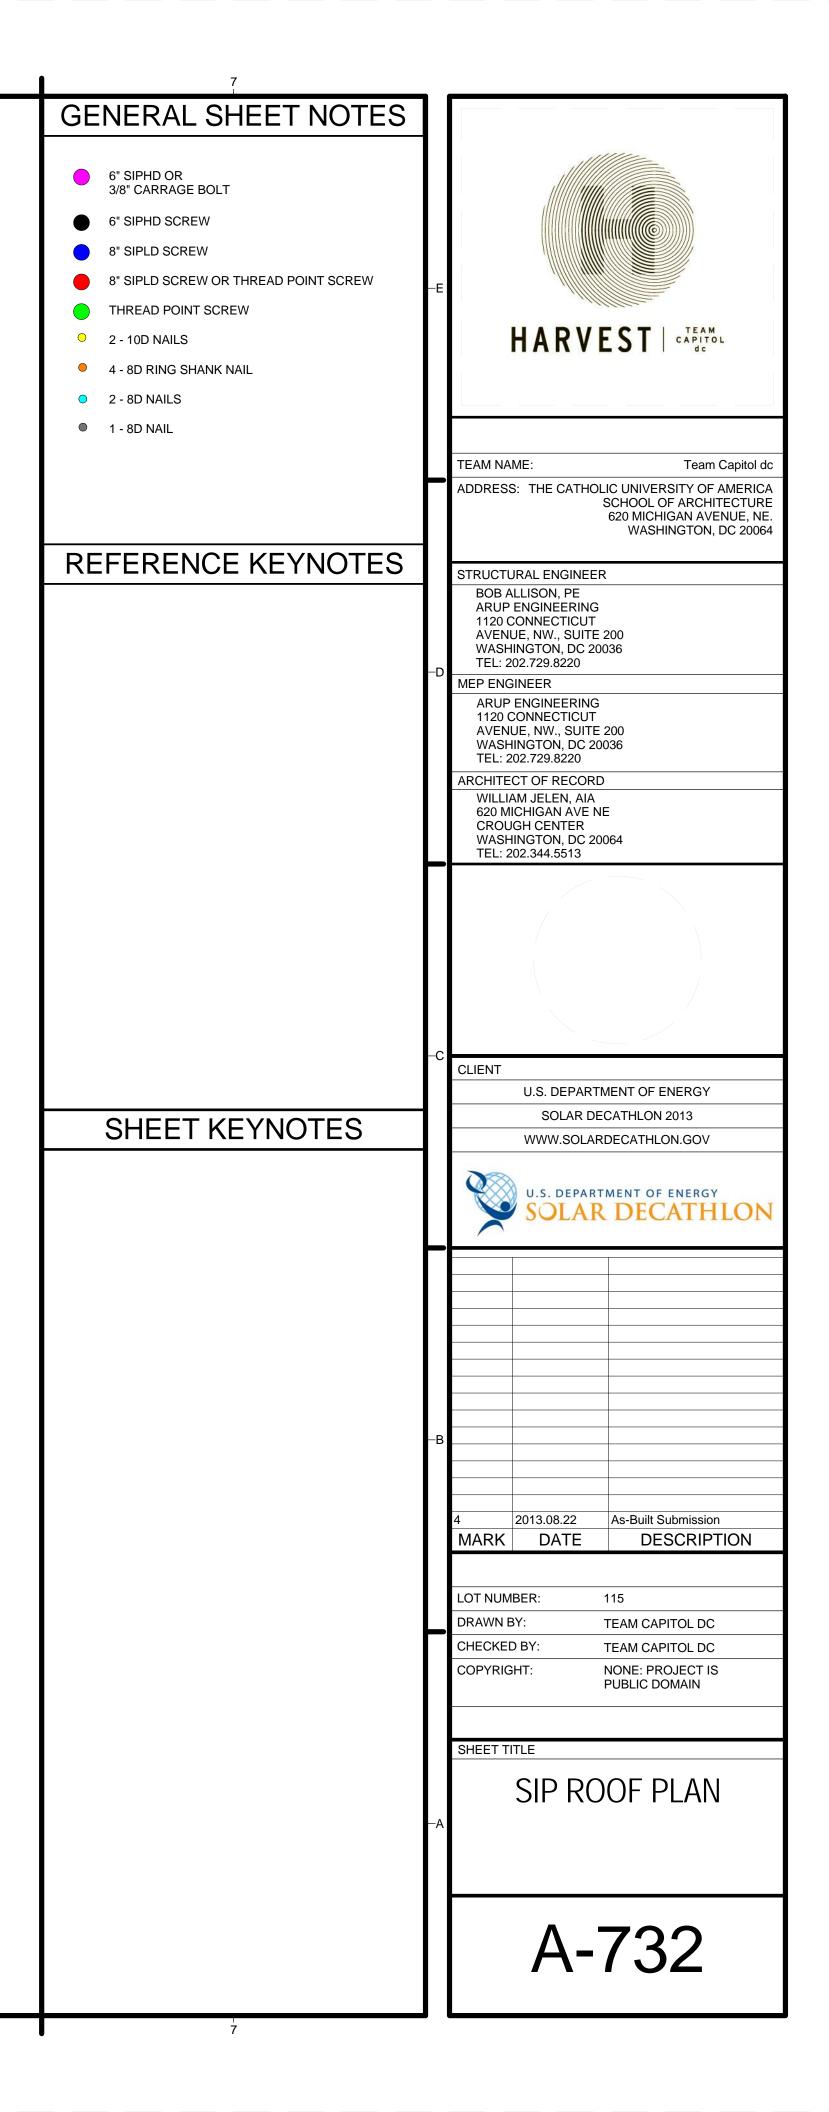
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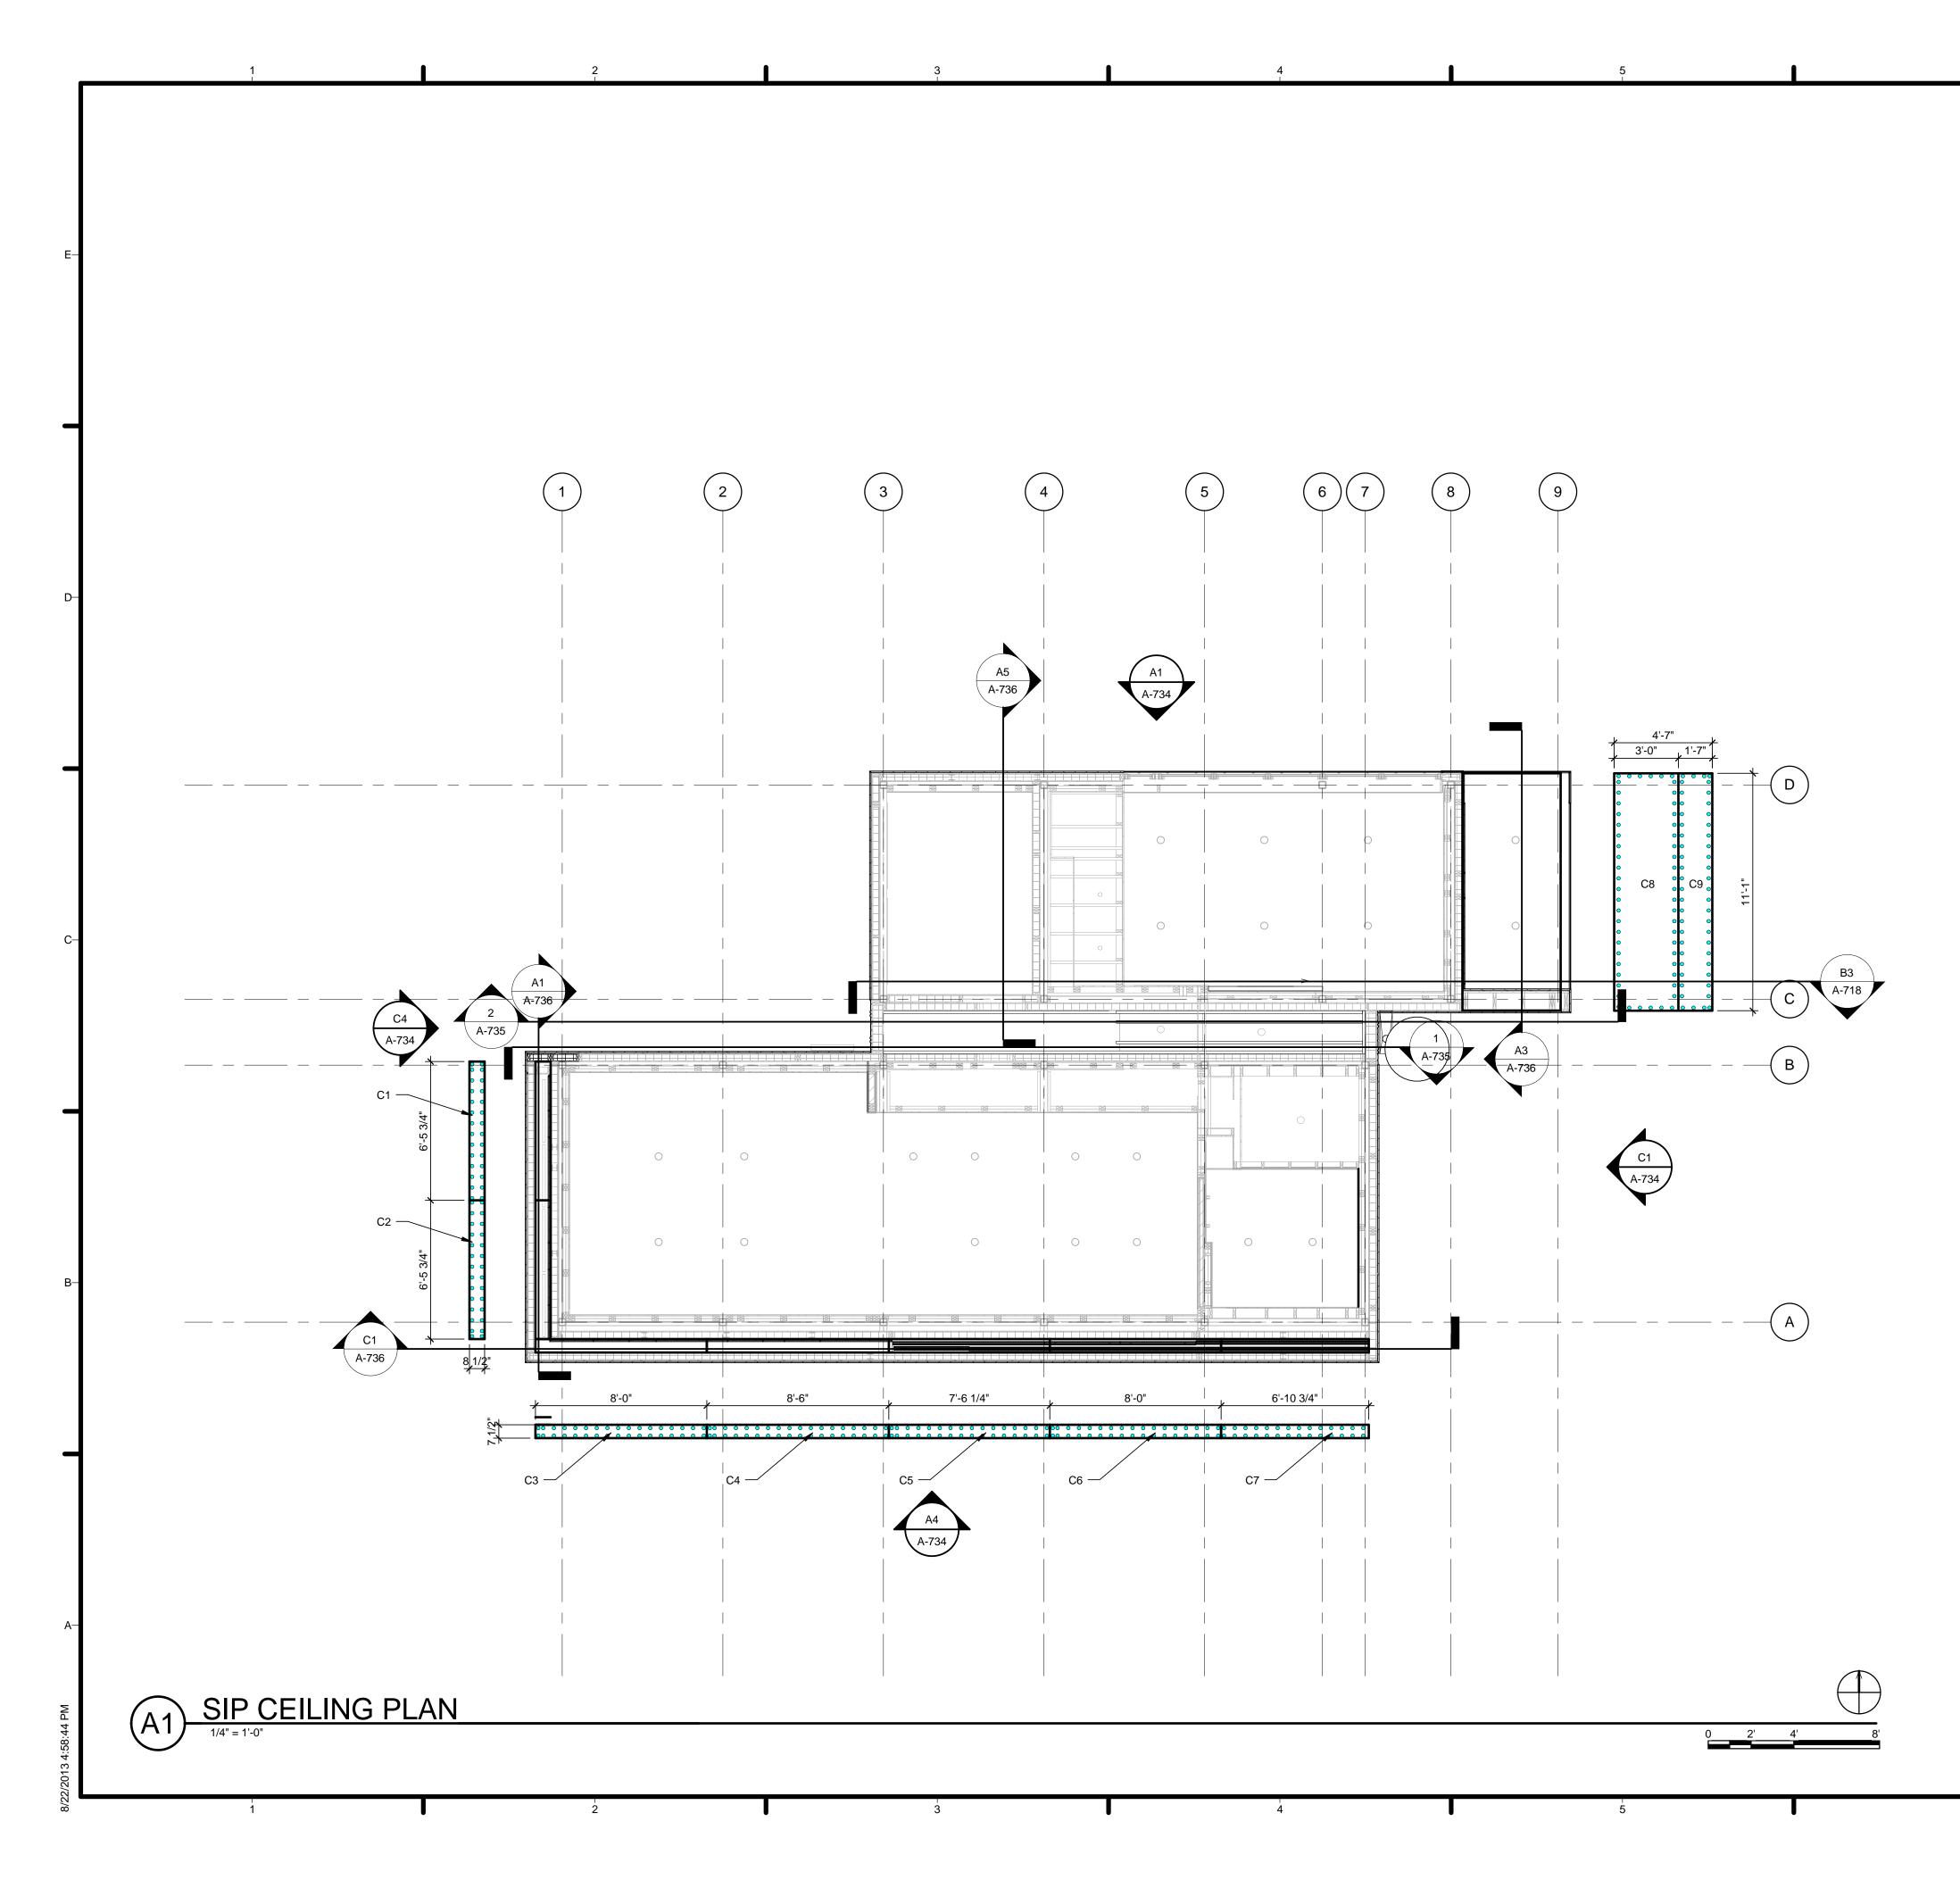


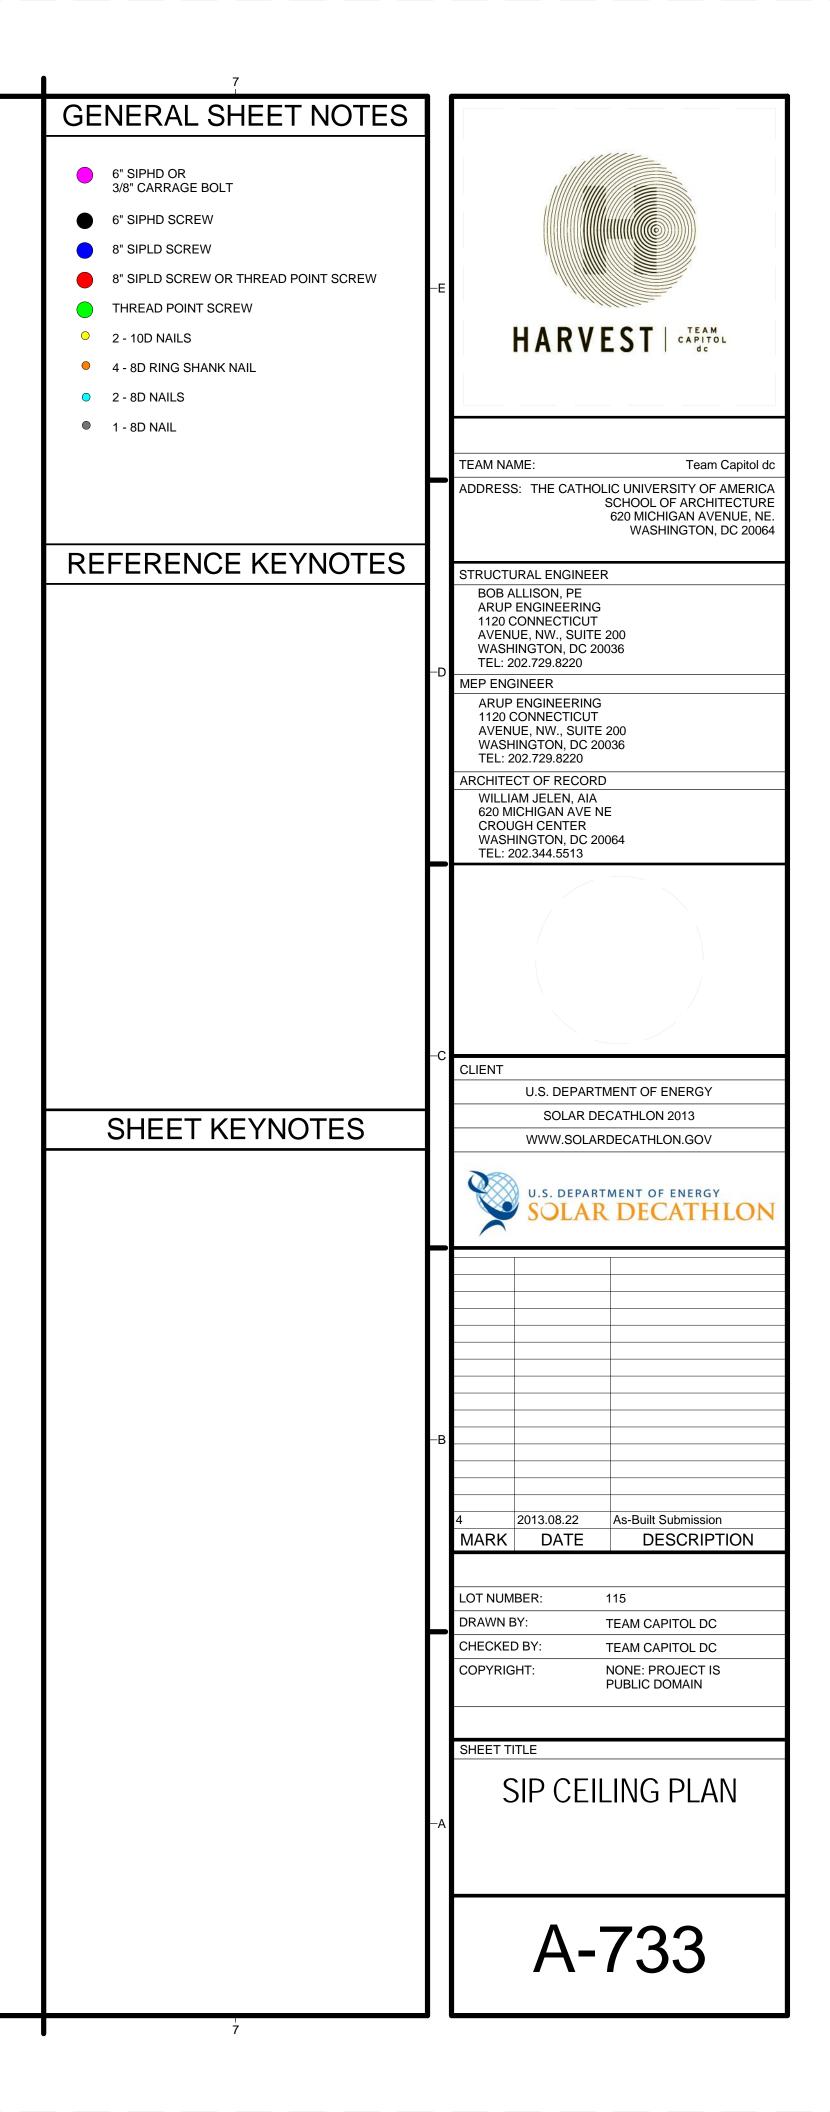
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DEFERENCE KEYNOTES 05 12 23.A1 W8 X 10 05 31 12 3" STEEL DECKING 05 31 23 1-1/2" STEEL DECKING 06 16 00.B3 3/4" EXTERIOR GRADE PLYWOOD	D	TEAM NAME: Team Capitol dc ADDRESS: THE CATHOLIC UNIVERSITY OF AMERICA SCHOOL OF ARCHITECTURE 620 MICHIGAN AVENUE, NE. WASHINGTON, DC 20064 STRUCTURAL ENGINEER BOB ALLISON, PE ARUP ENGINEERING 1120 CONNECTICUT AVENUE, NW., SUITE 200 WASHINGTON, DC 20036 TEL: 202.729.8220 MEP ENGINEER ARUP ENGINEERING 1120 CONNECTICUT AVENUE, NW., SUITE 200 WASHINGTON, DC 20036 TEL: 202.729.8220 ARCHITECT OF RECORD
SHEET KEYNOTES	C	WILLIAM JELEN, AIA 620 MICHIGAN AVE NE CROUGH CENTER WASHINGTON, DC 20064 TEL: 202.344.5513 CLIENT U.S. DEPARTMENT OF ENERGY SOLAR DECATHLON 2013 WWW.SOLARDECATHLON.GOV U.S. DEPARTMENT OF ENERGY
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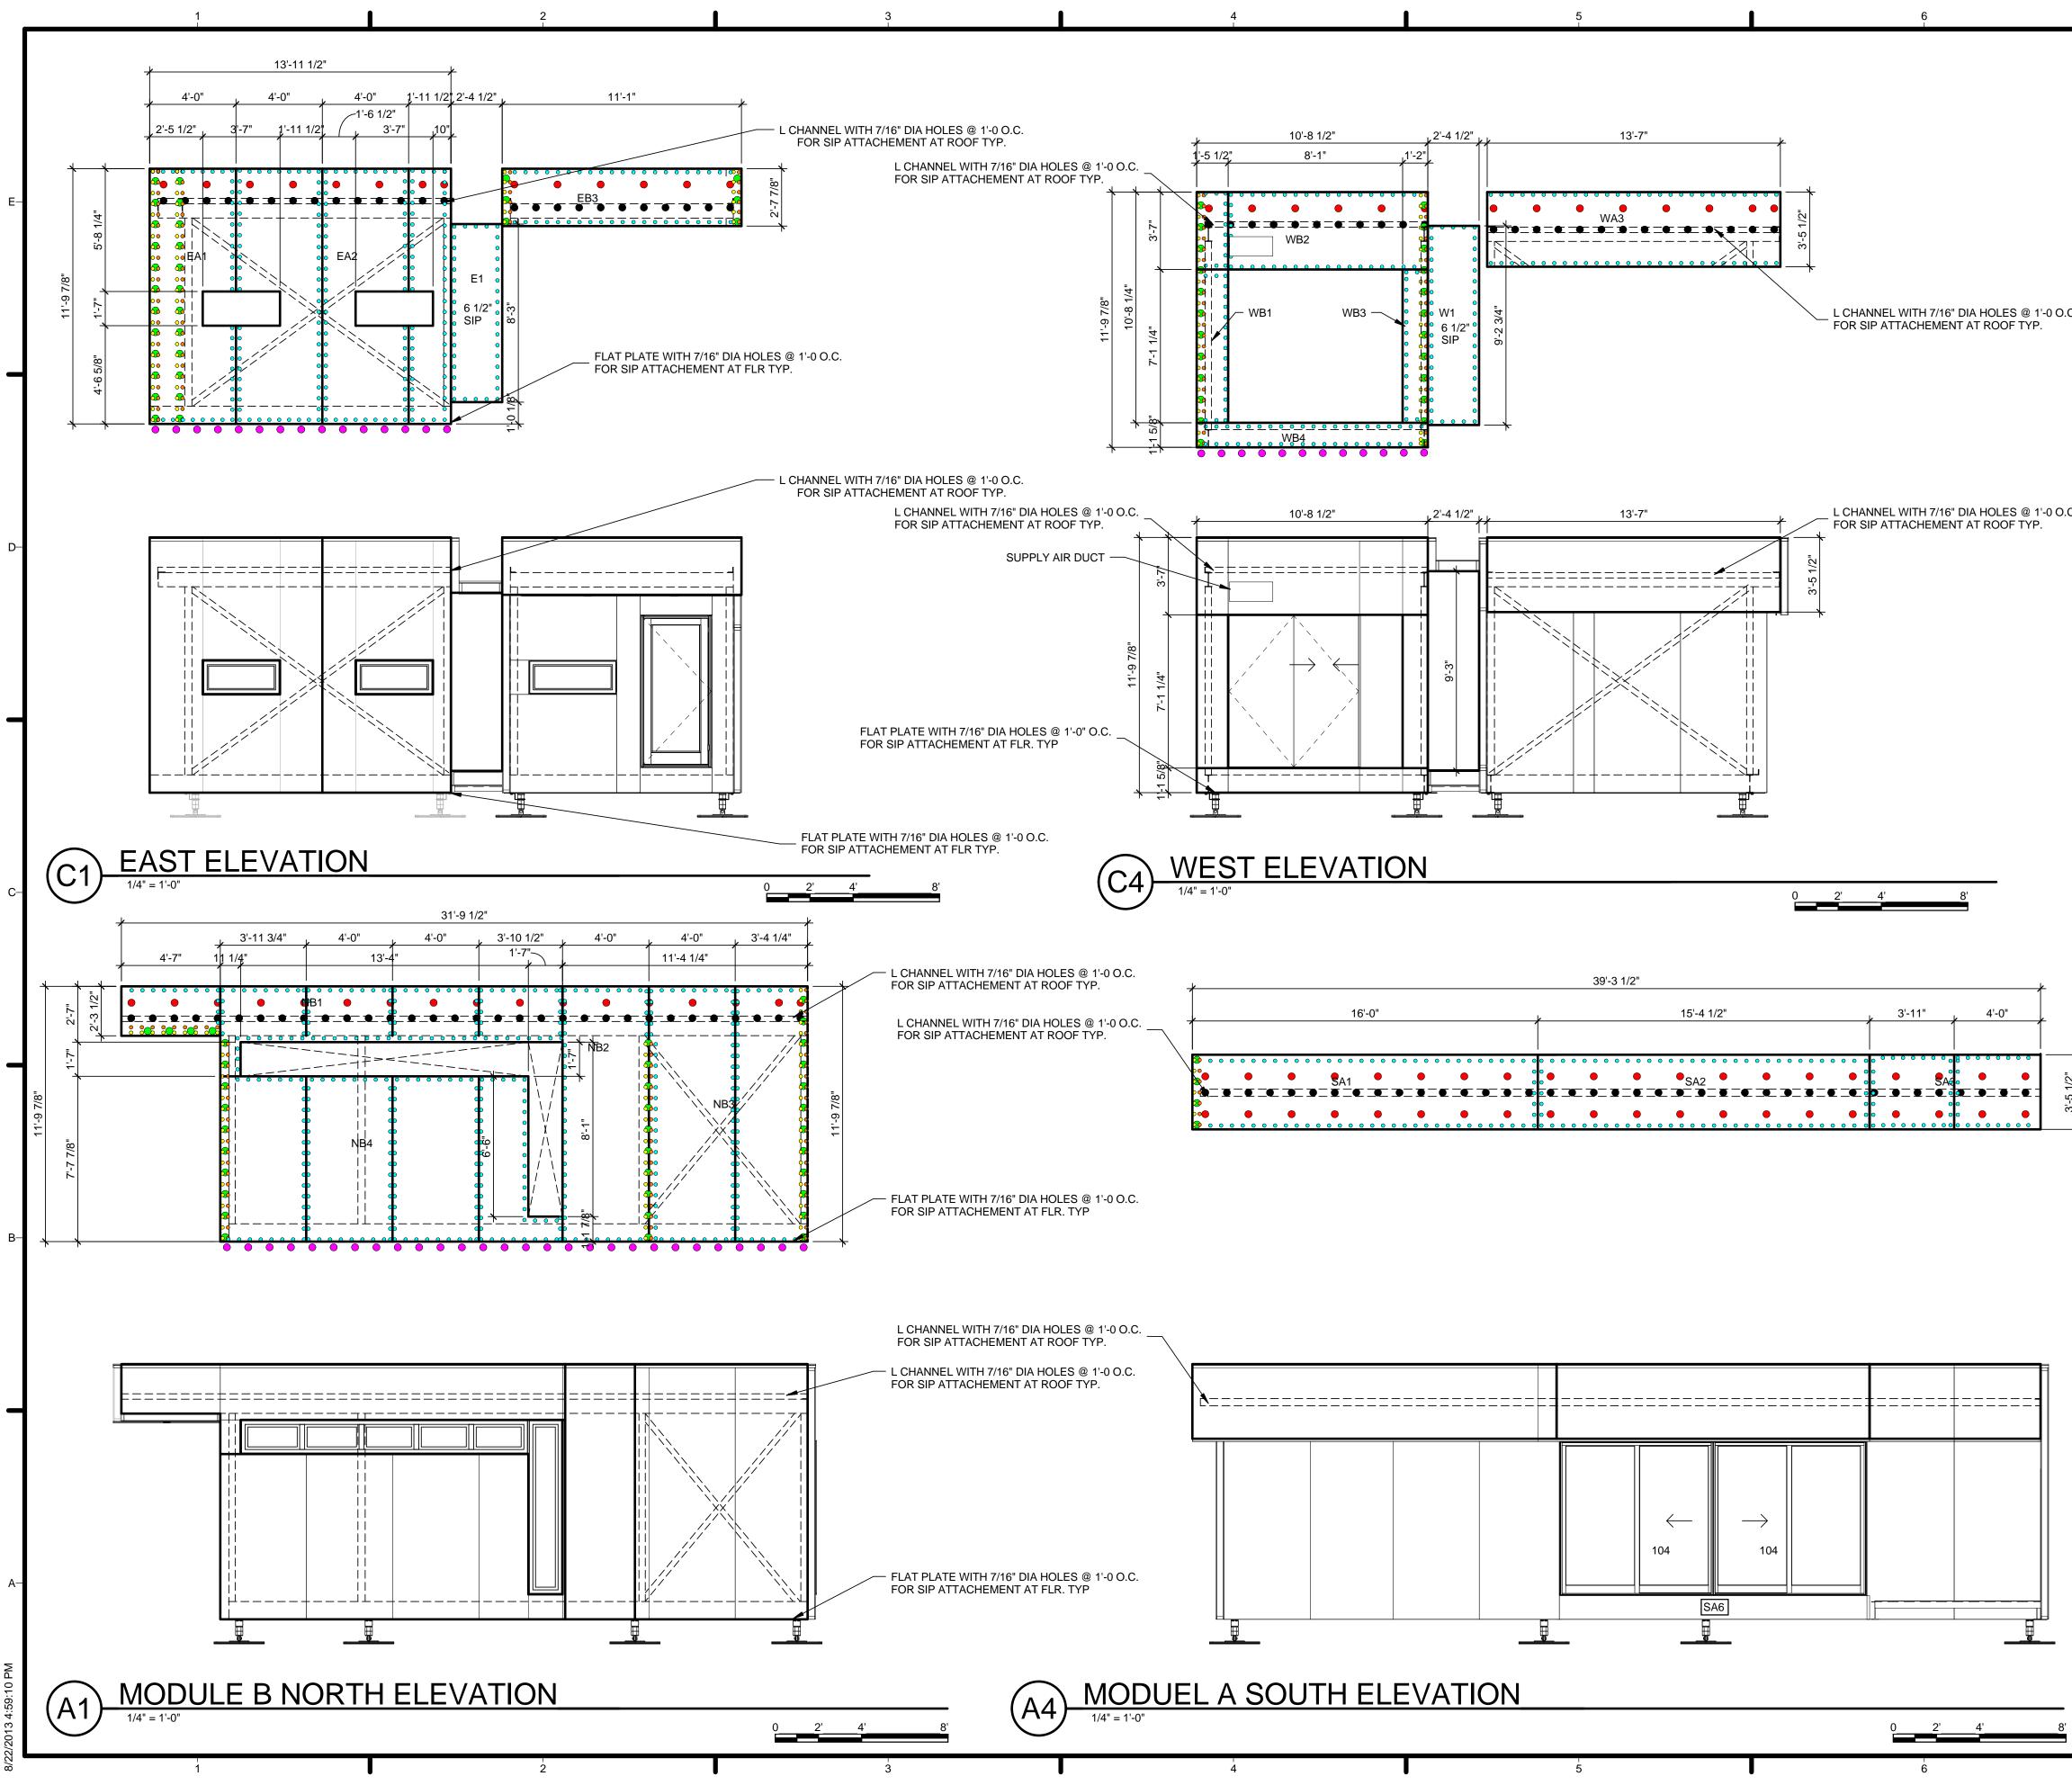




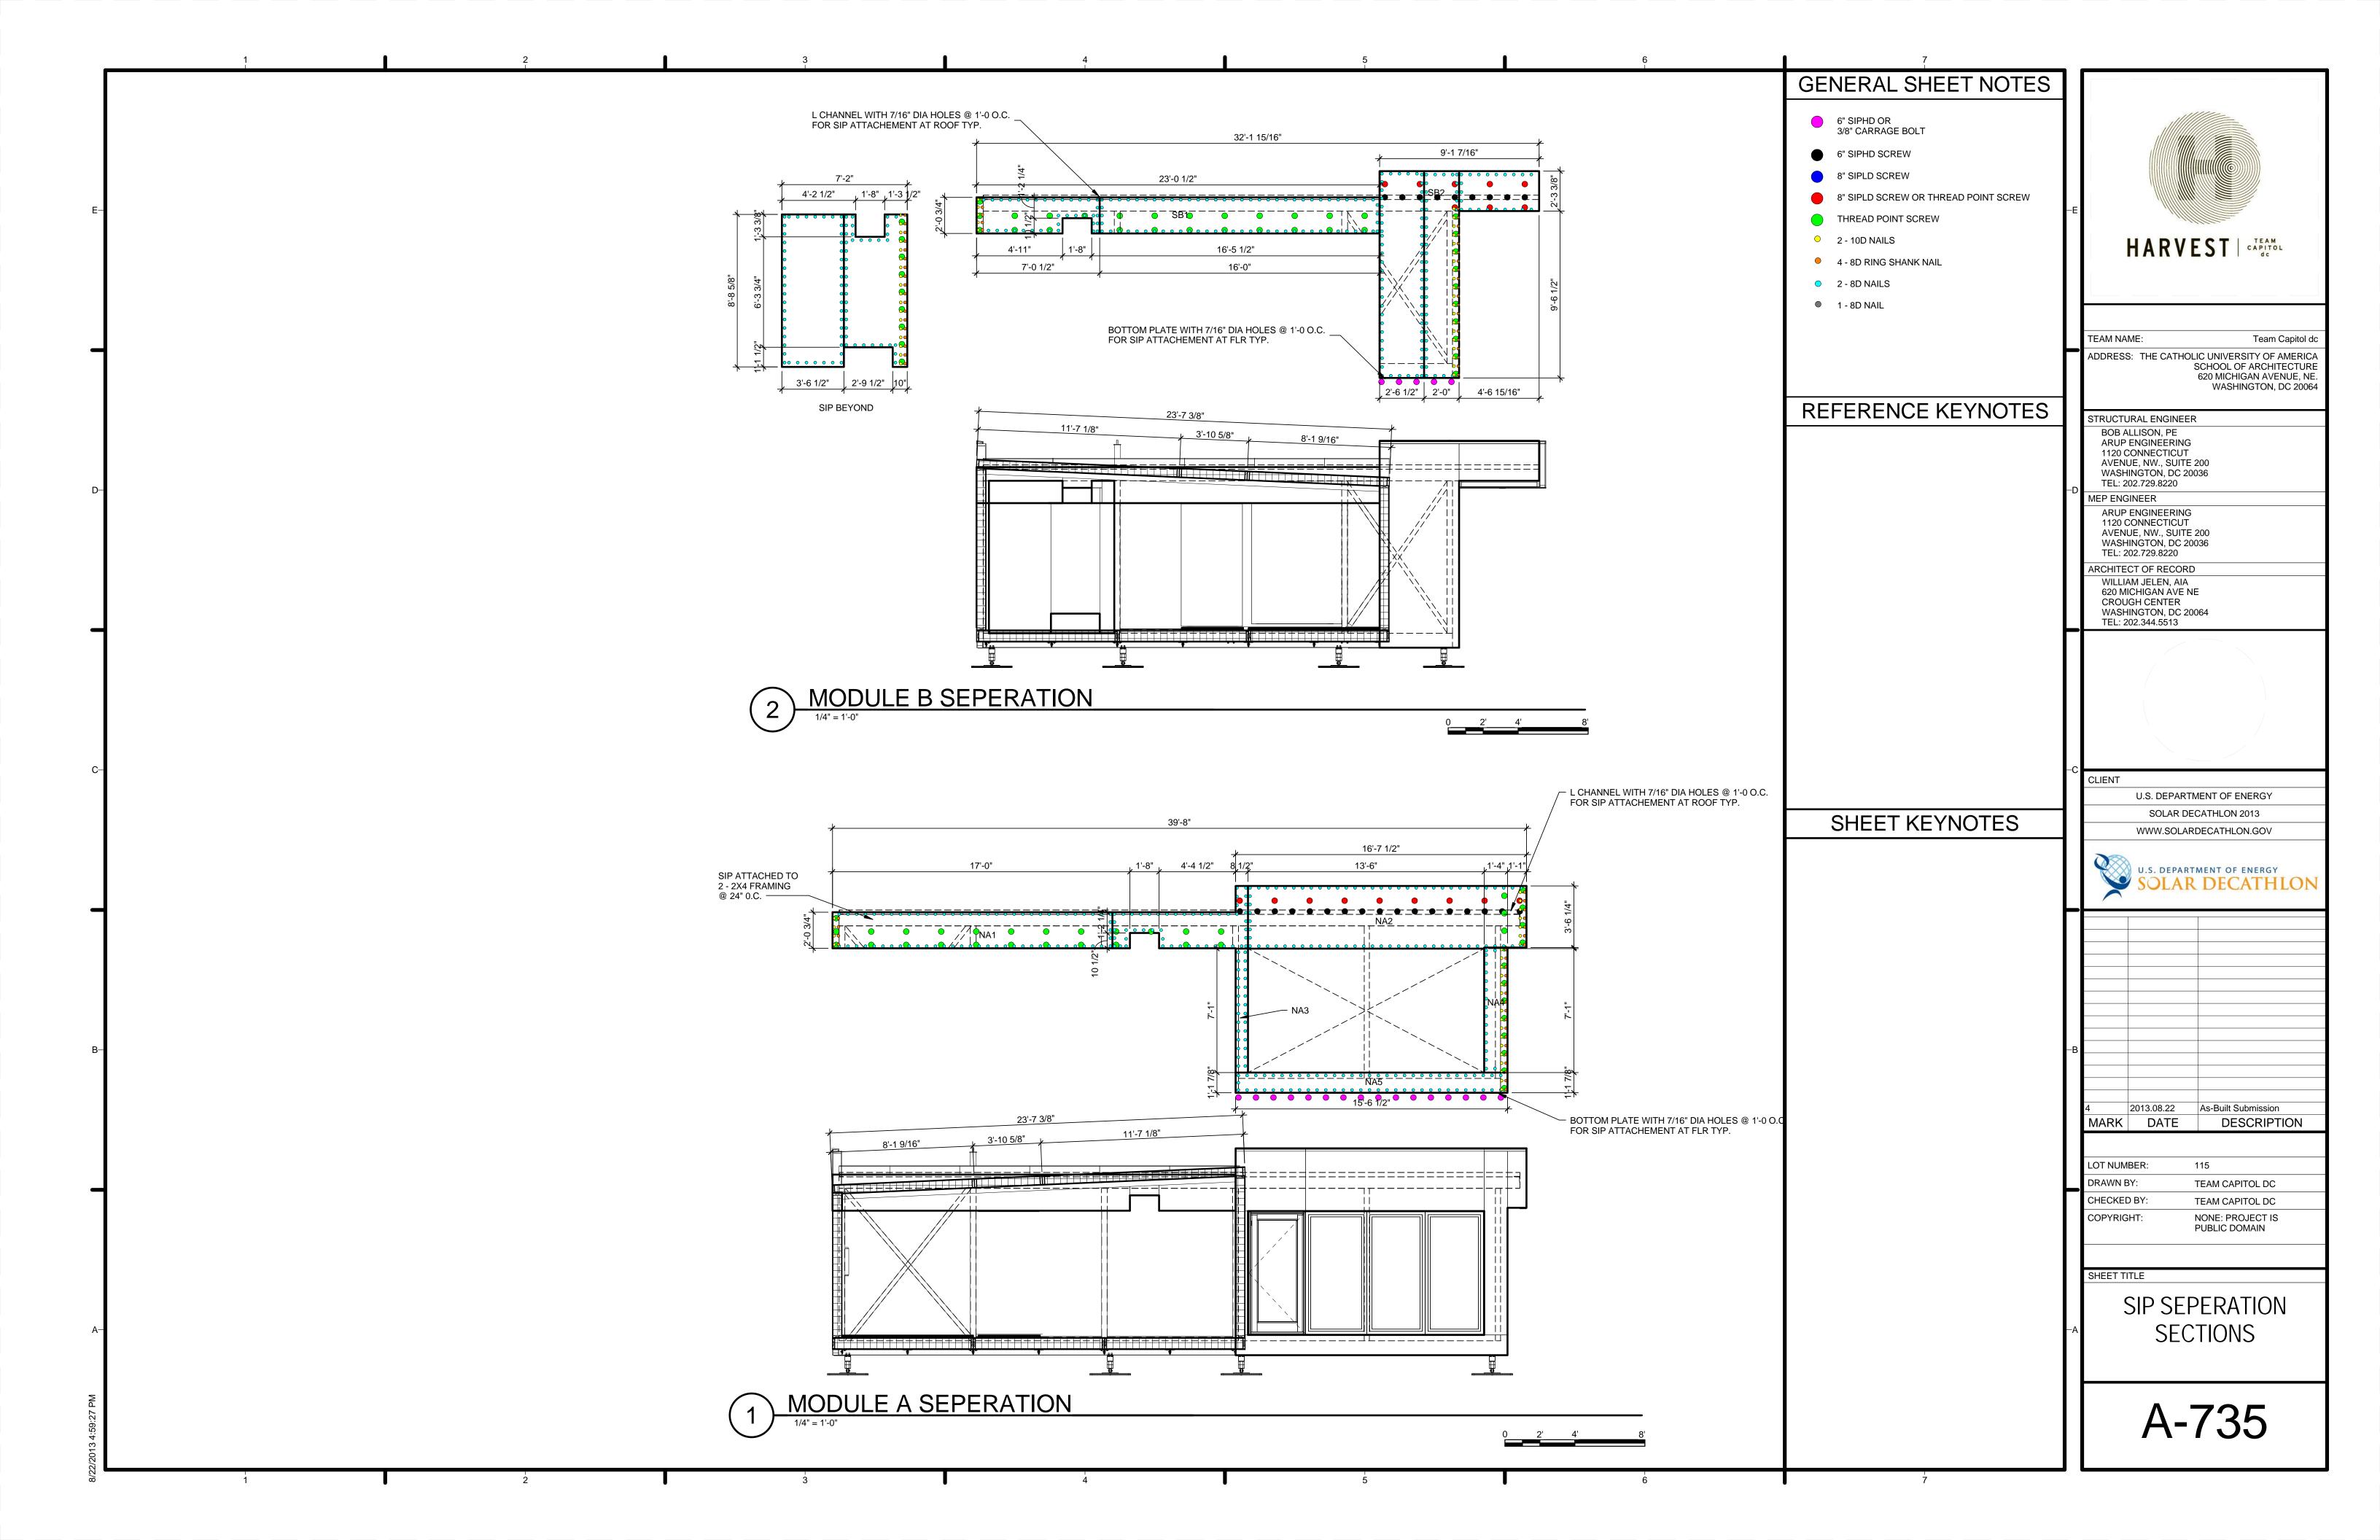


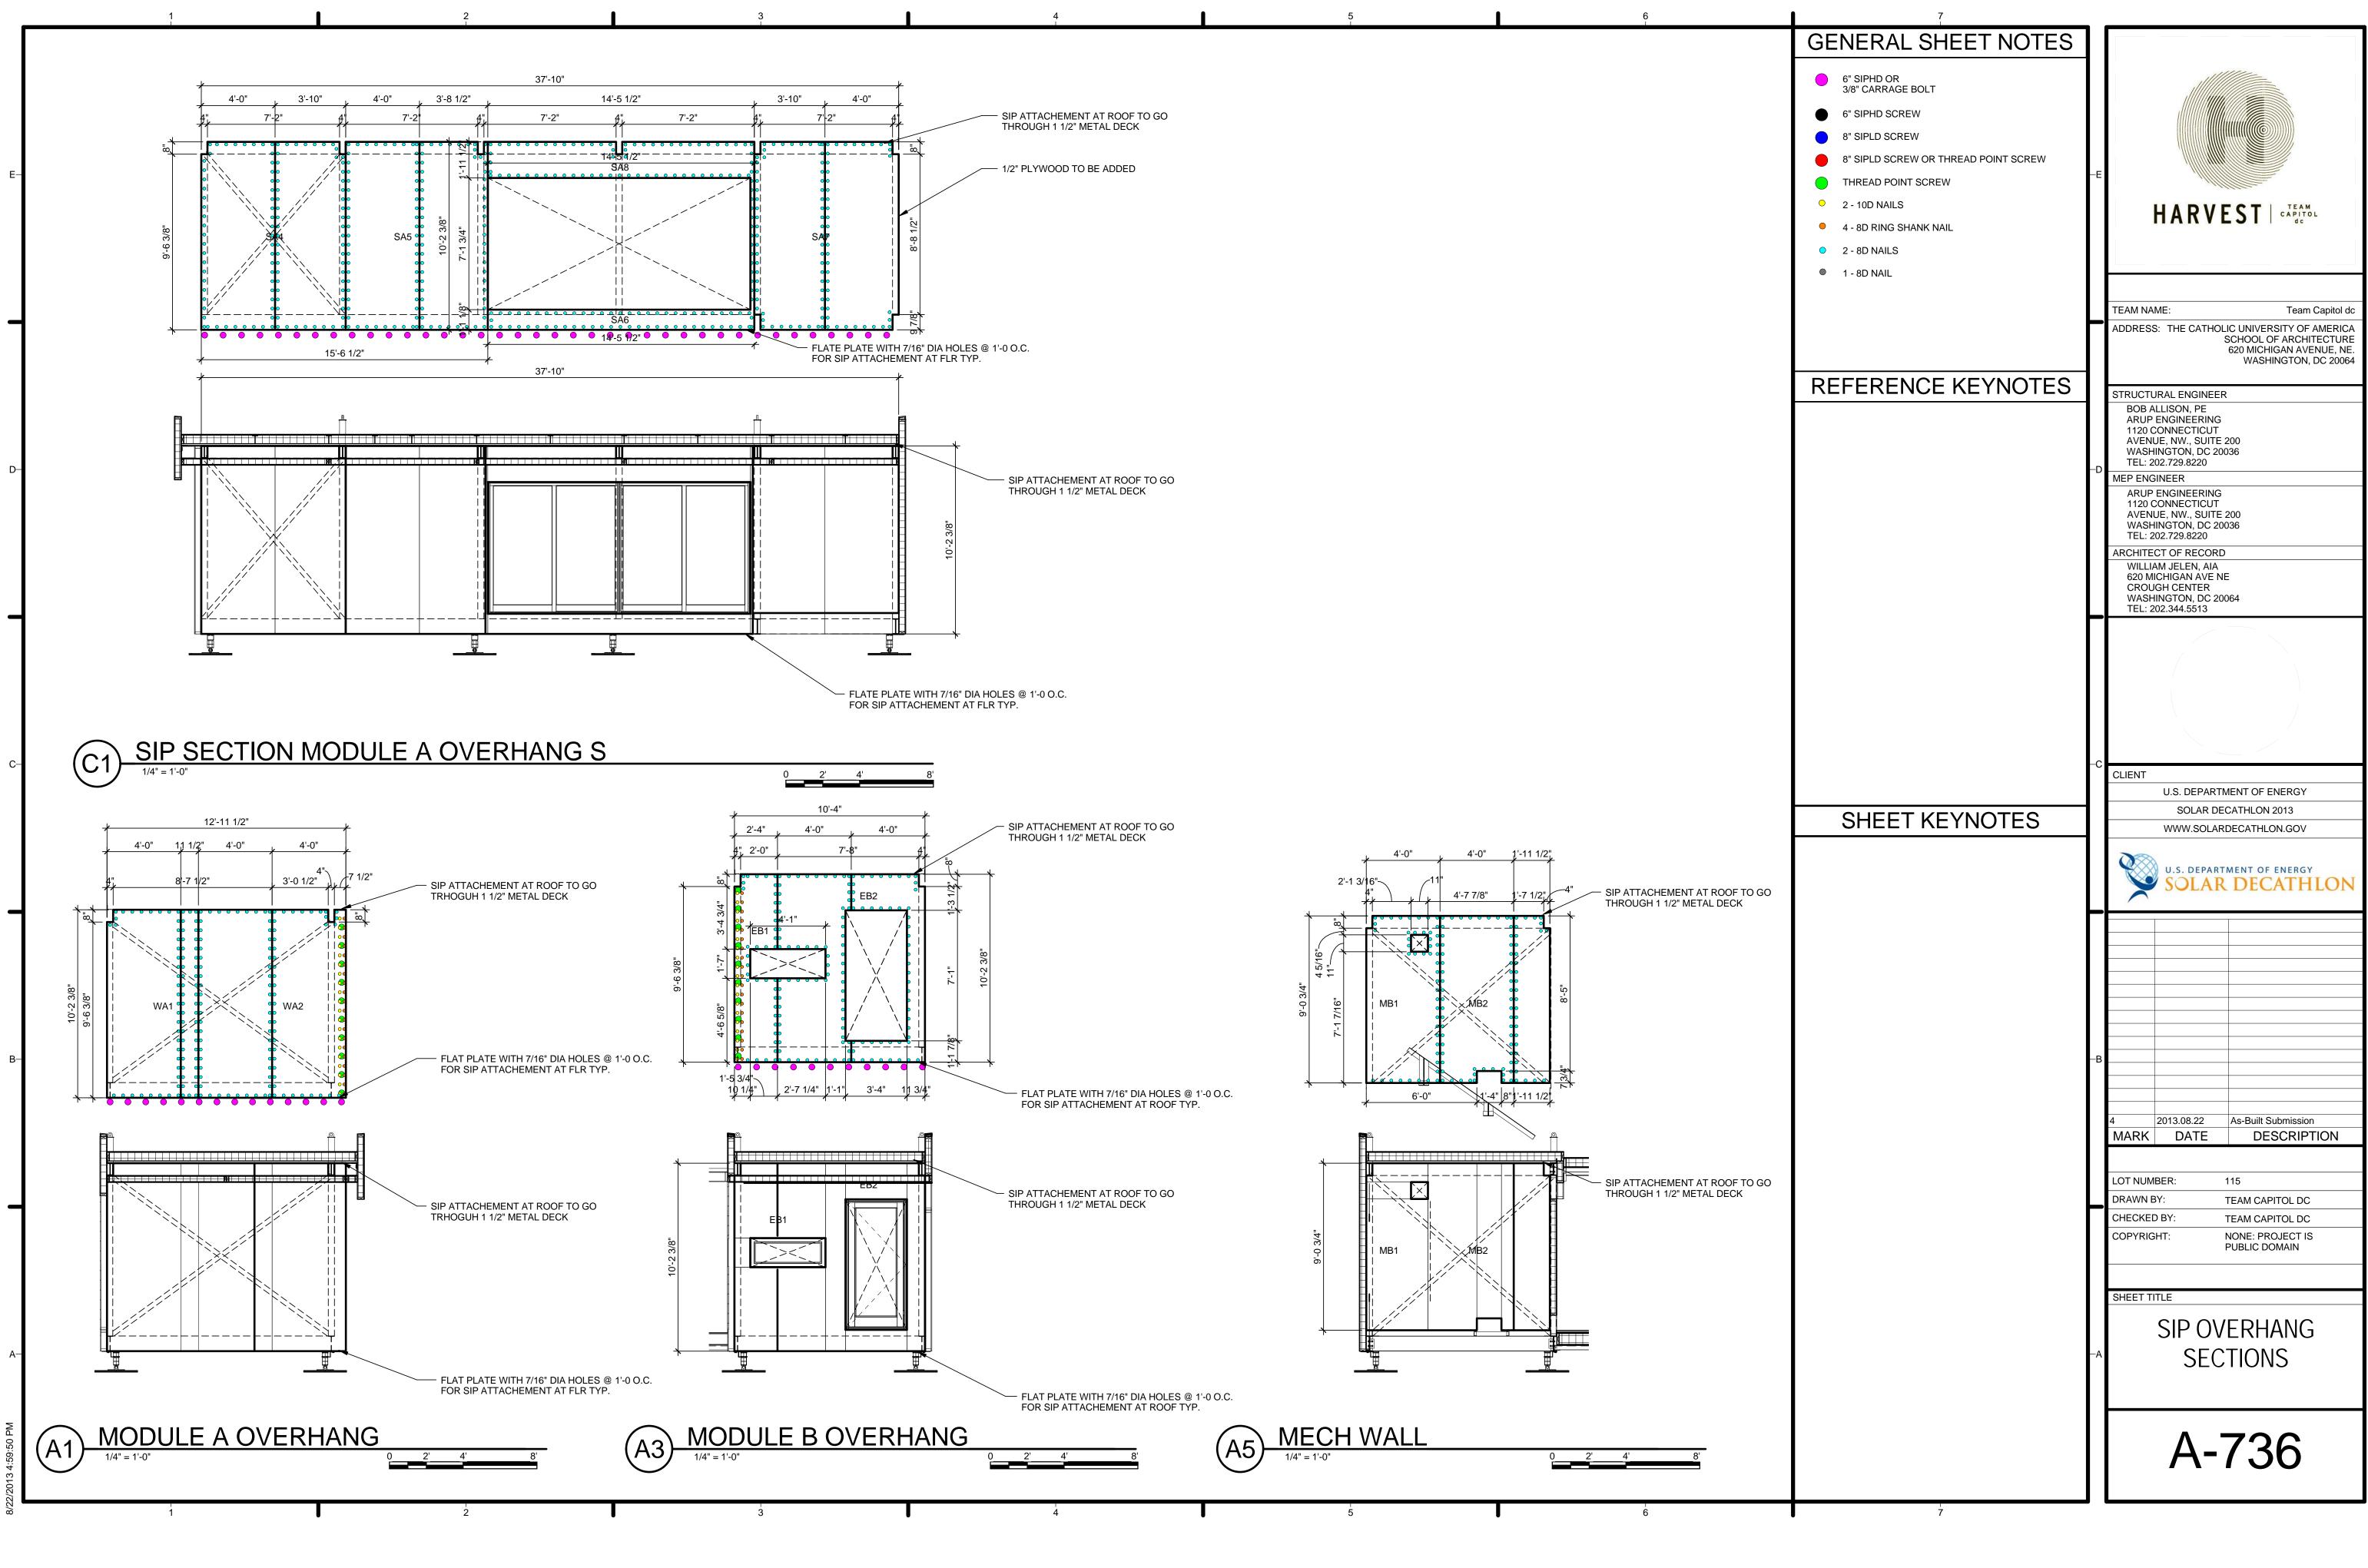


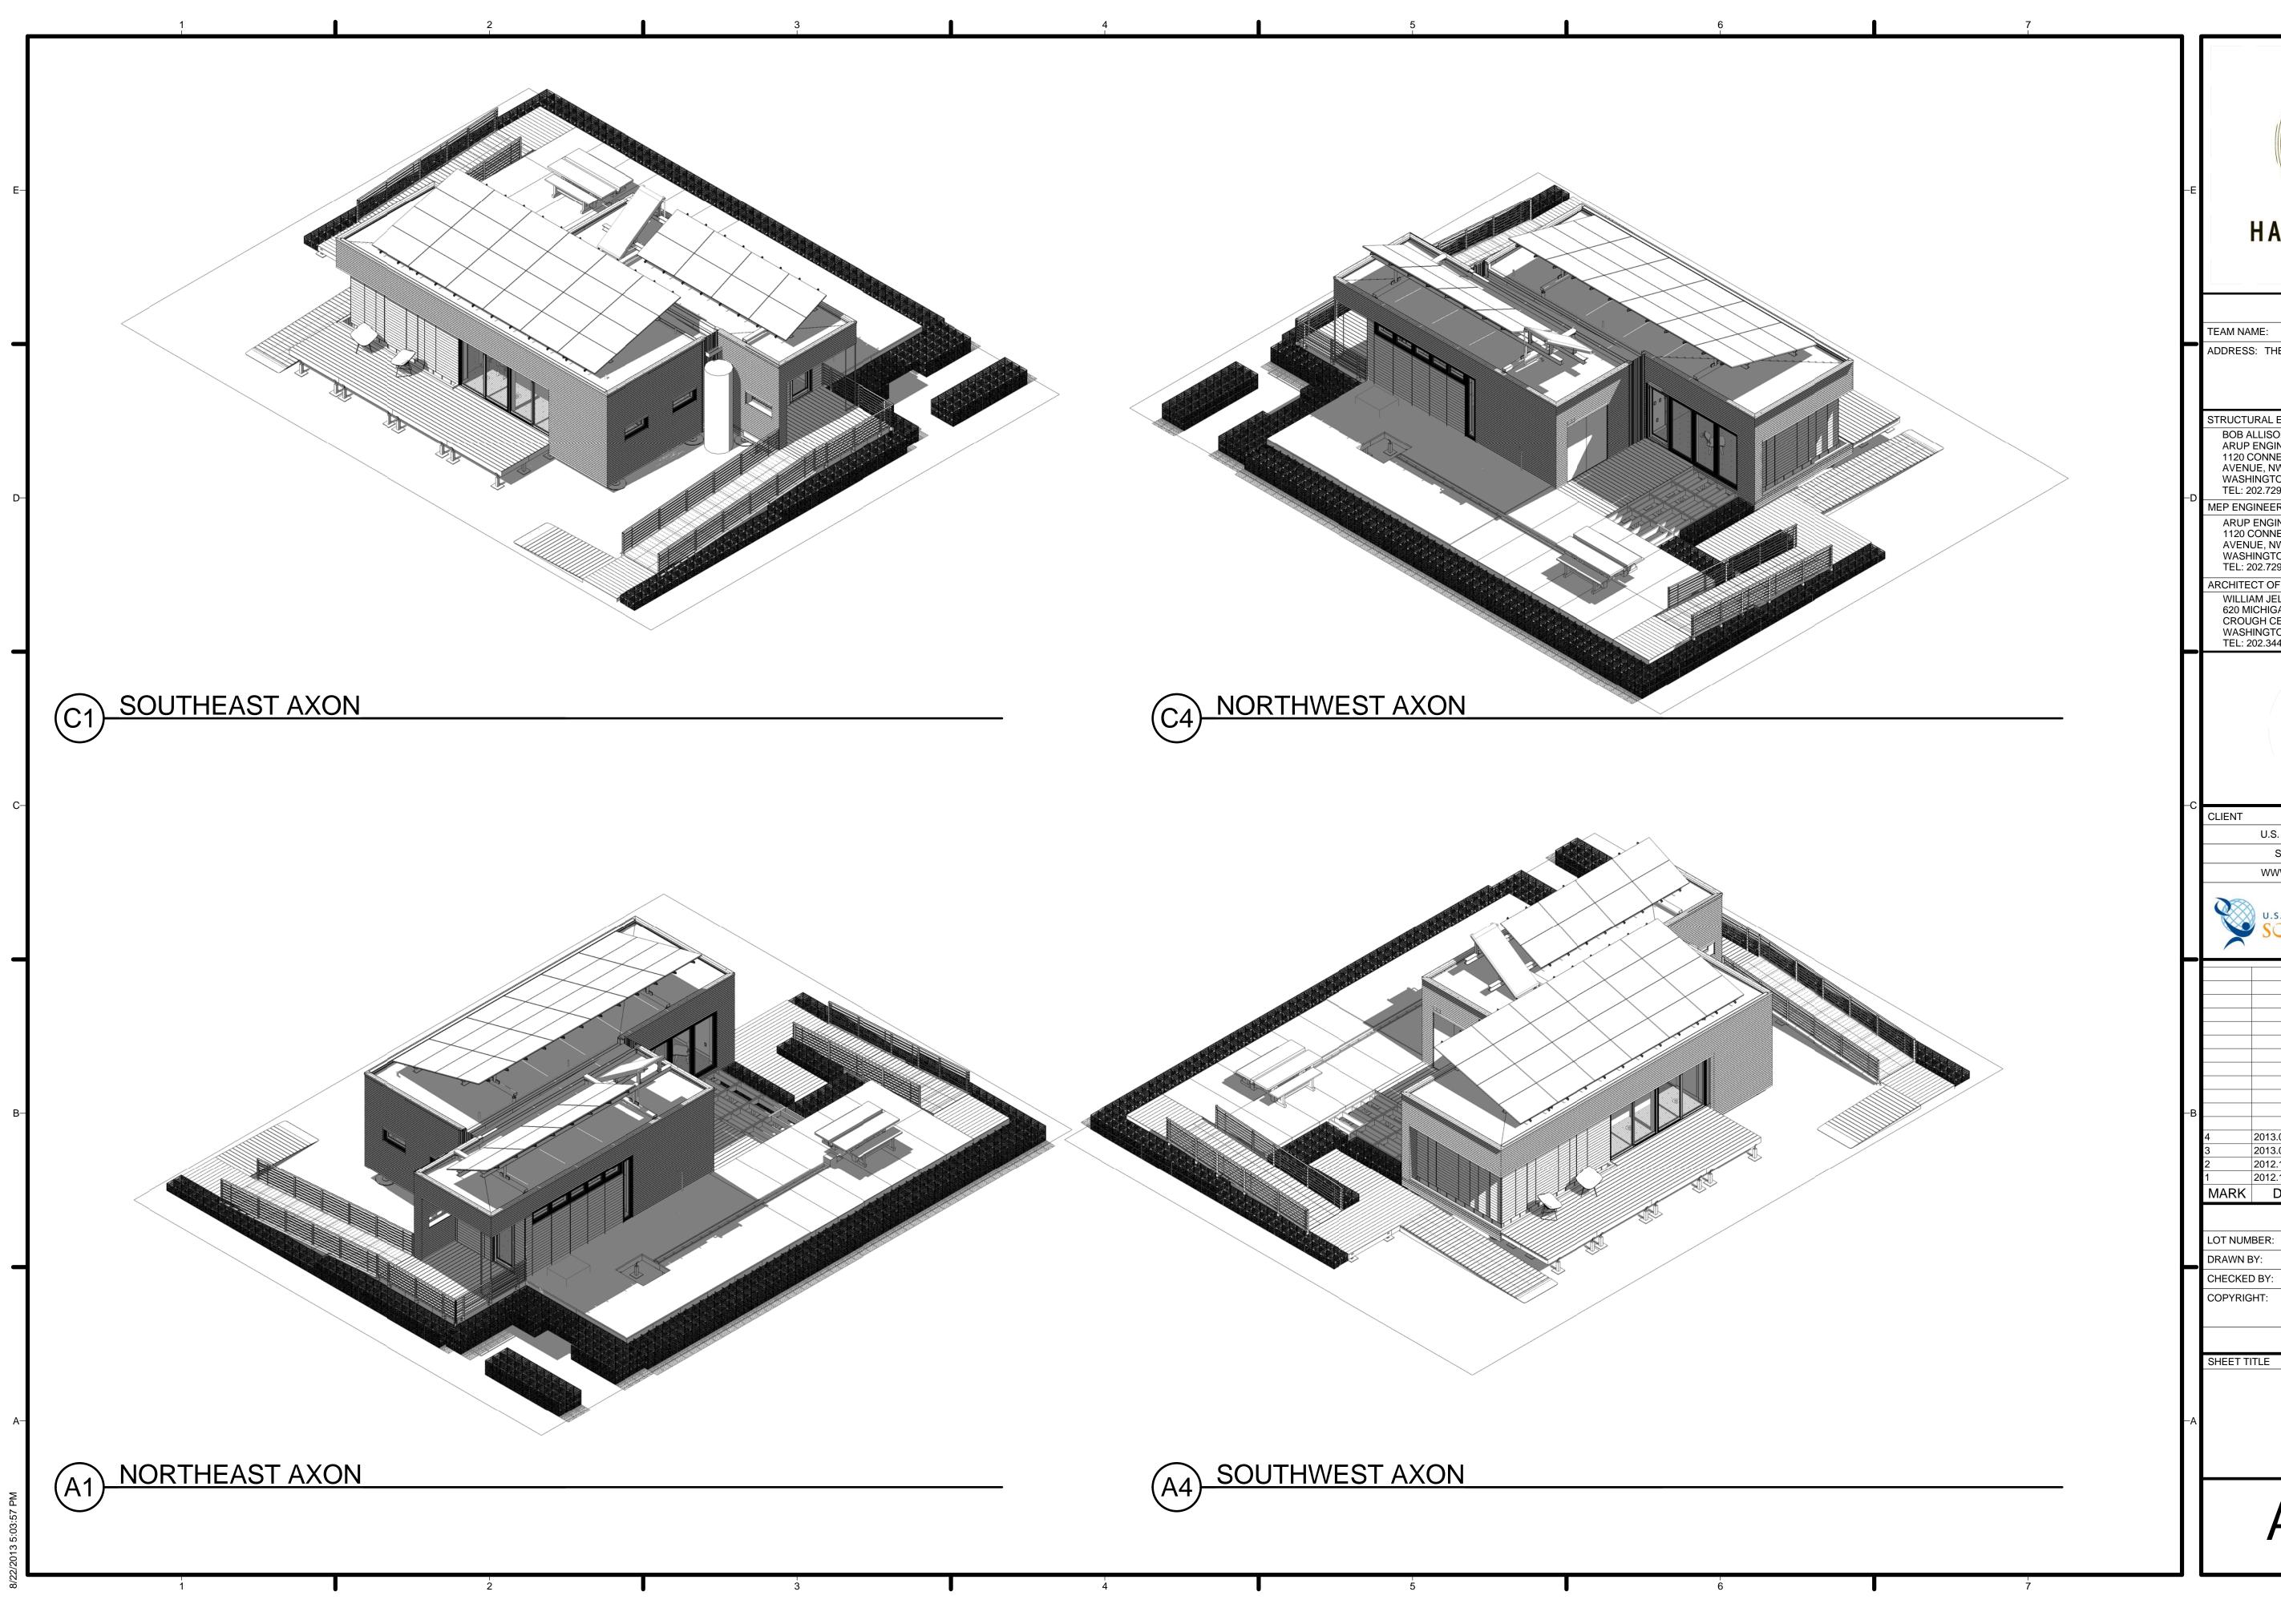




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D.C.	 GENERAL SHEET NOTES G" SIPHD OR 3/8" CARRAGE BOLT G" SIPHD SCREW G" SIPLD SCREW 8" SIPLD SCREW OR THREAD POINT SCREW THREAD POINT SCREW 2 - 10D NAILS 4 - 8D RING SHANK NAIL 2 - 8D NAILS 1 - 8D NAIL 	—E	HARVEST
	REFERENCE KEYNOTES		ADDRESS: THE CATHOLIC UNIVERSITY OF AMERICA SCHOOL OF ARCHITECTURE 620 MICHIGAN AVENUE, NE. WASHINGTON, DC 20064 STRUCTURAL ENGINEER
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	SHEET KEYNOTES		SOLAR DECATHLON 2013 WWW.SOLARDECATHLON.GOV
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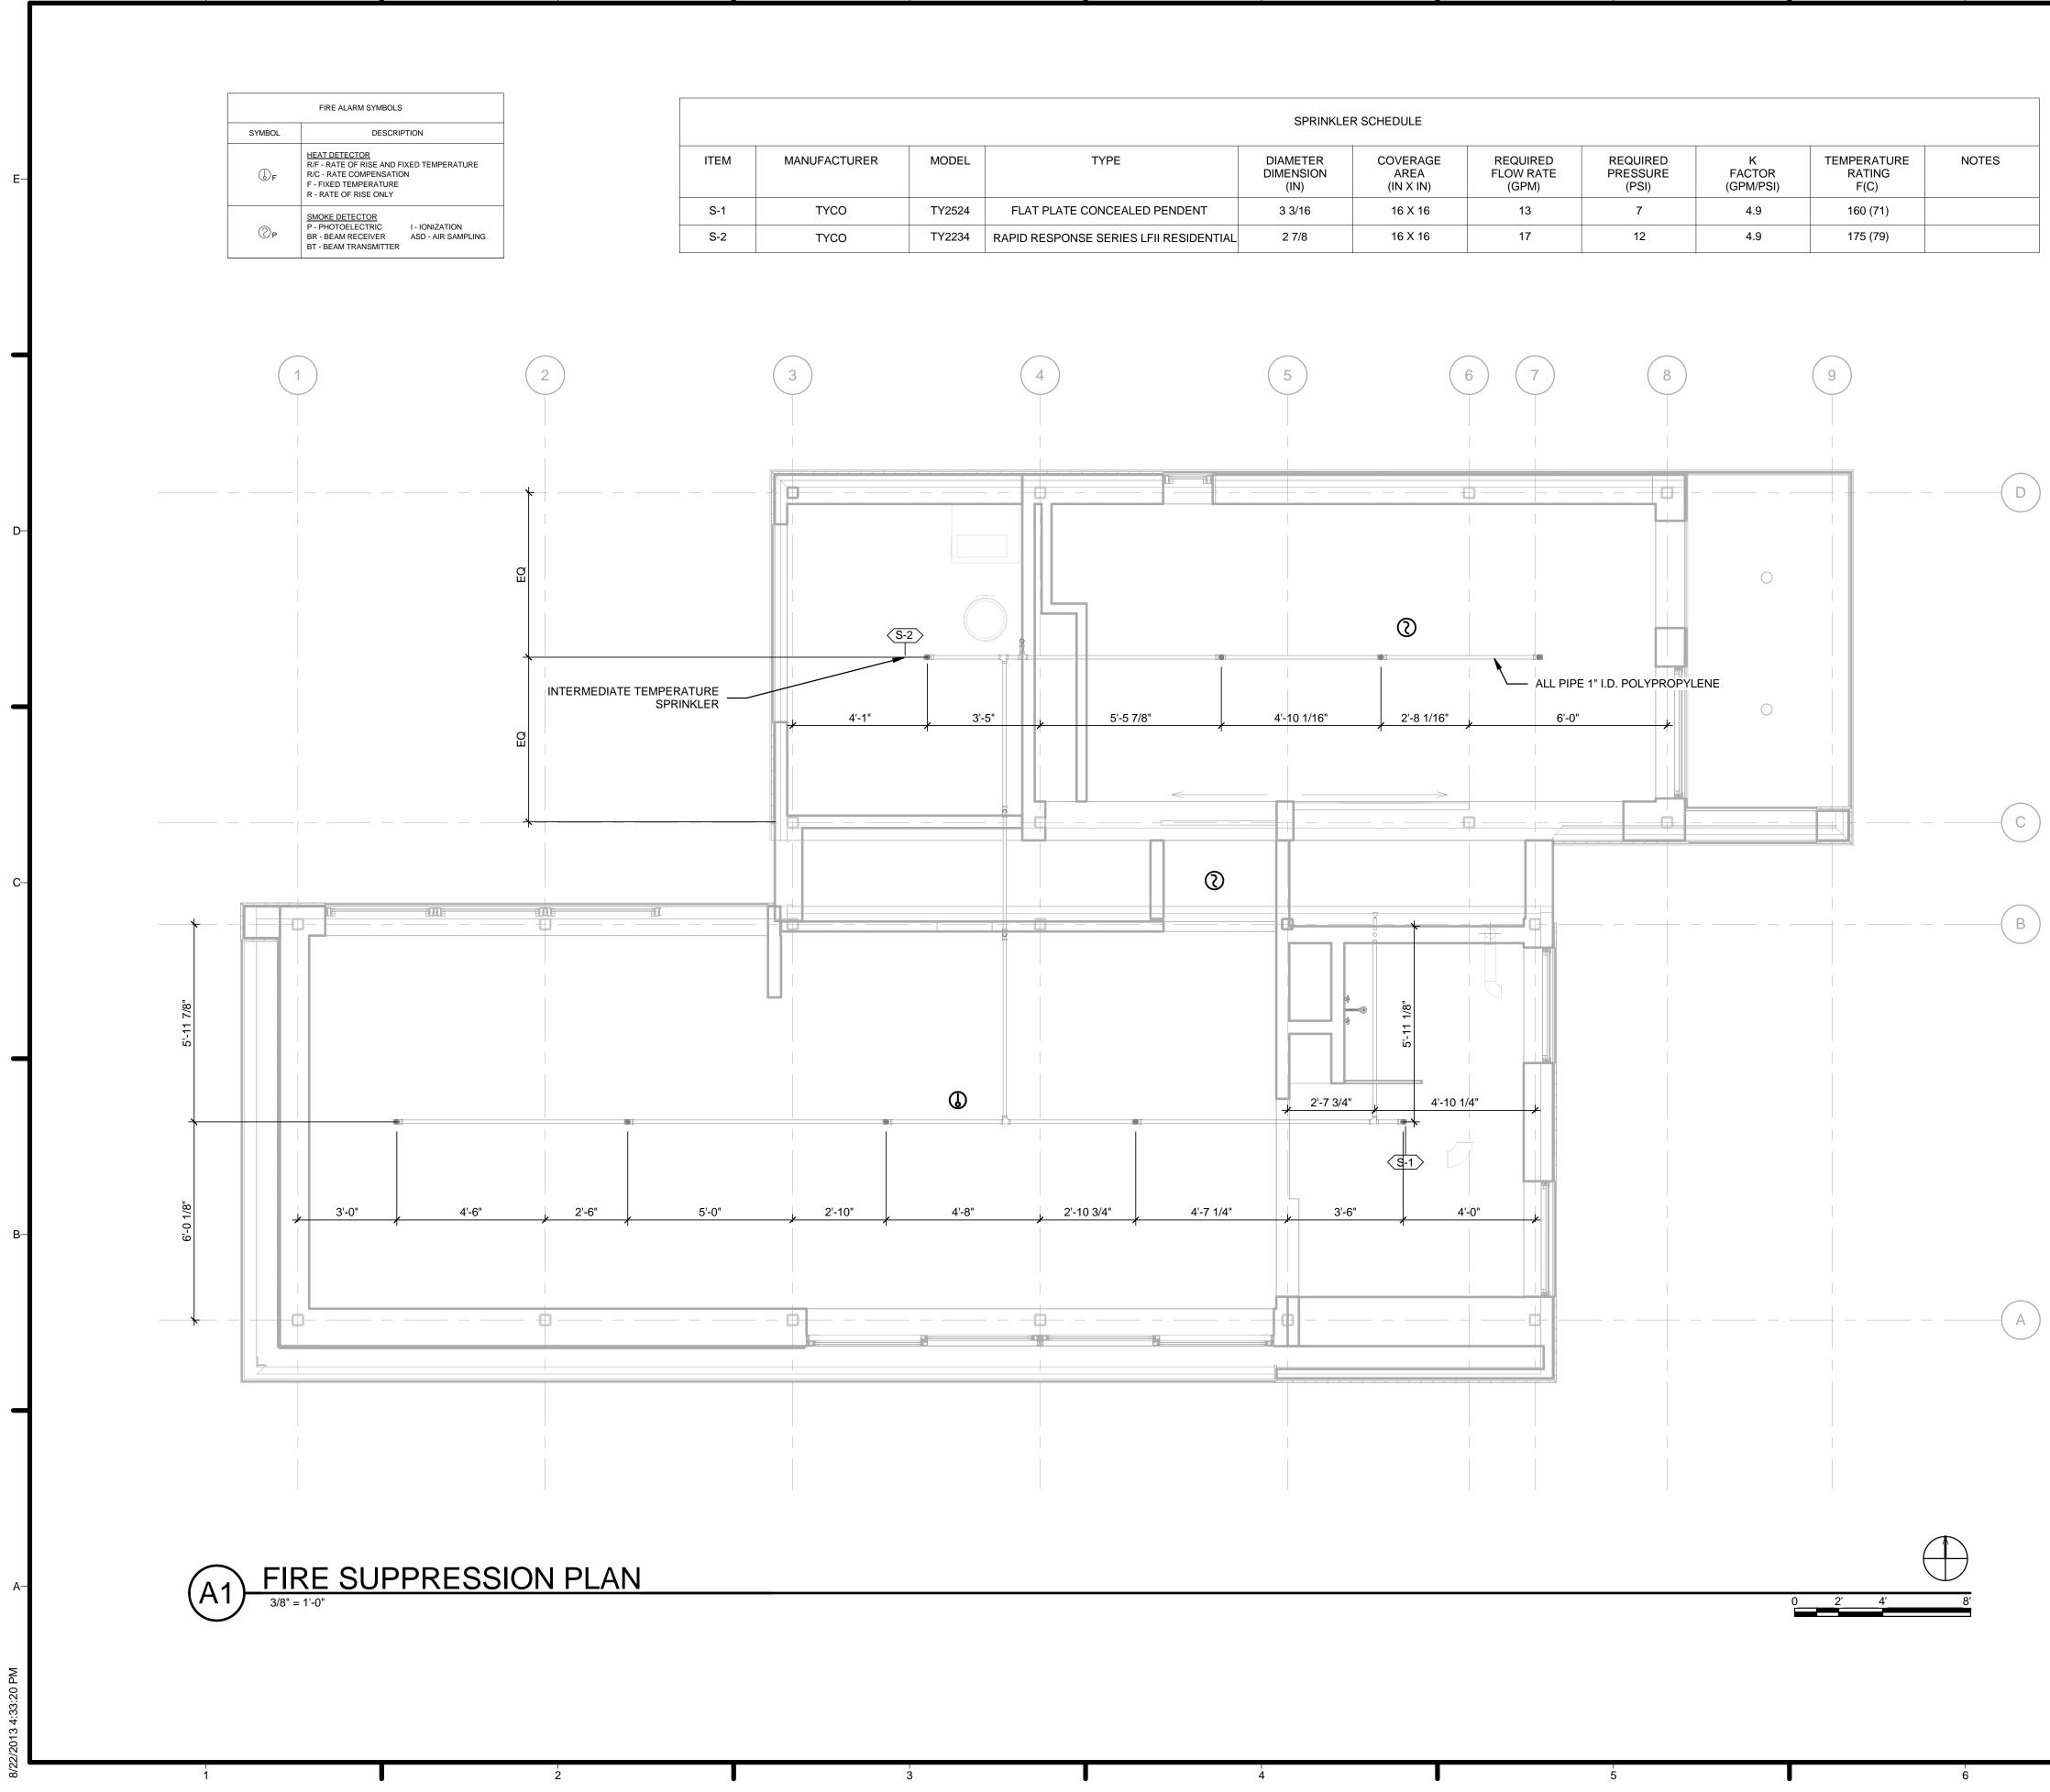


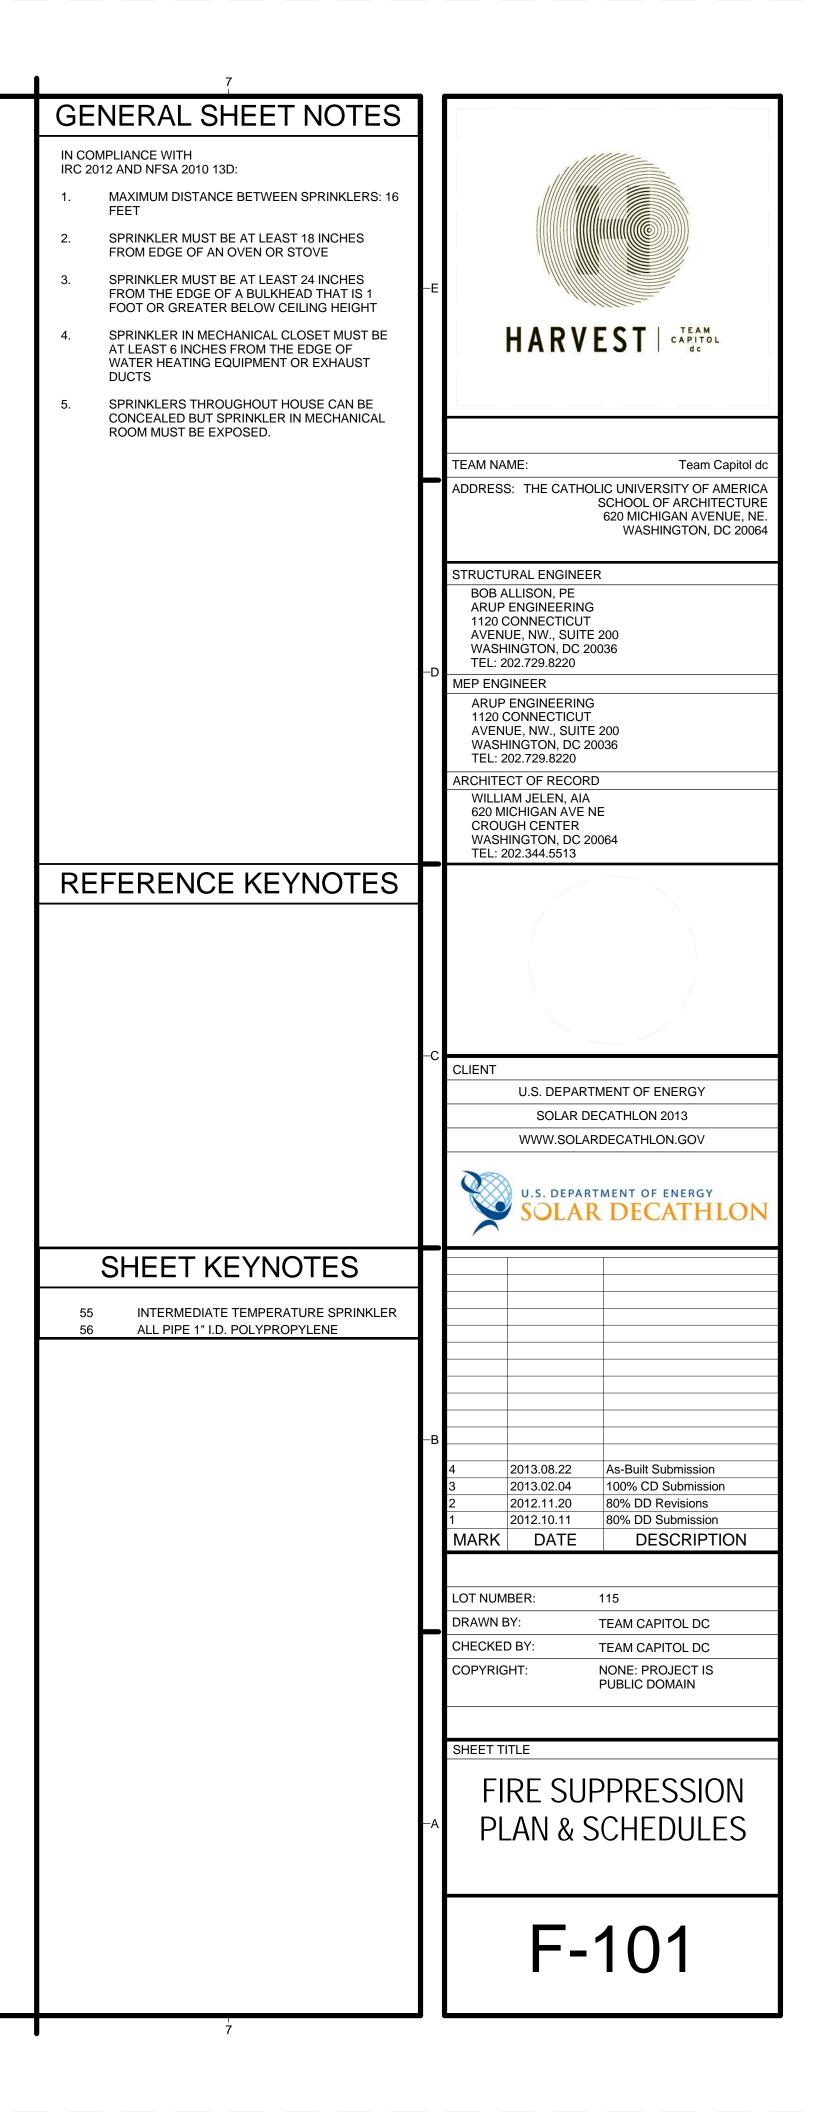




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ABBREVIATIONS		
SYMBOL	DESCRIPTION	
DHW	DOMESTIC HOT WATER	
SPL	SUPPLY TANK	
GWT	GRAY WATER TANK	
BWT	BLACK WATER TANK	
WBP	WATER BOOSTER PUMP	
STP	SOLAR THERMAL TANK	
VTR	VENT THROUGH ROOF	
CW	CLOTHES WASHER	
DW	DISH WASHER	
KS	KITCHEN SINK	
WC	WATER CLOSET	
BS	BATHROOM SINK	
S	SHOWER	
ST	SOLAR THERMAL	

PIPING SYMBOLS		
SYMBOL	DESCRIPTION	
	WATER STORAGE TANK	
— — —	PUMP	
	ACCUMLATOR TANK	
_ _	MANUAL VALVE	
	END CAP	
	THEROMETER	
	CHECK VALVE	
(PIPE DROP OR DOWN	
0	PIPE RISE OR UP	
0("P" TRAP	
	VENT THROUGH ROOF	
- T	HOSE BIBB	
_ -	DIRECTION OF FLOW	
	EQUIPMENT TYPE	
	PRESSURE GAUGE	
	COLD WATER PIPING FOR DOMESTIC PURPOSES	
	HOT WATER PIPING FOR DOMESTIC PURPOSES	
	VENT PIPING	

					DOMESTIC I	HOT WATER TA	ANK SCHEDULE						
ITEM	MANUFACTURER	LOCATION	SERVICE	CALCULATED	TANK AND	LENGTH	DIAMETER	MINIMUM	SYSTEM	ELECTRI	CAL DATA	MOUNTING	NOTES
				MINIMUM	ACCEPTANCE			CHARGE	OPERATING	KW	V/PH/HZ		
				VOLUME	VOLUME			PRESSURE	TEMP				
				(GAL)	(GAL)	(IN)	(IN)	(PSIG)	(F)				
DHW	SUNMAXX SOLAR	MECHANICAL ROOM	HOT WATER SUPPLY TANK	8	14	48 1/4	22	150	115	4.5	120/1/60	MOUNTED TO FLOOR	1

1. TANK IS TO SIT ON DRAIN PAN

DDE	DESCRIPTION WASTE VENT CW HW MANUFACTURER/MODEL NUMBER		ELECTR	RICAL DATA	NOTES					
							KW	V/PH/HZ		
P-1	LAVATORY	1 1/4	1 1/2	1/2	1/2	KOHLER / PURIST LAVATORY 2314-0	-	-		
P-2	CLOTHES WASHER	1 1/4	1 1/2	1/2	1/2	FRIGIDAIRE AFFINITY / FAFS4073NW	-	120/1/60	-	
P-3	DISHWASHER	1 1/4	1 1/2	1/2	1/2	FISHER & PAYKEL / DISHDRAWER WIDE DD36SDFTX2	-	120/1/60	1	
P-4	KITCHEN SINK			1/2	1/2	KOHLER / VAULT KITCHEN SINK 3894-4-NA	-	-	1	
P-5	SHOWER	1 1/4	1 1/2	1/2	1/2	KOHLER / PURIST ECO SHOWER TRIM T14422-4E-CP	-	-	-	
P-6	WATER CLOSET	3	1 1/2	1/2	-	KOLER / PERSUADE TOILET BOWL 4322-0	-	-	-	
P-7	SHOWER DRAIN	2	1 1/2	-	-	SCHLUTER / KERDI-LINE / KLV 60 E 90	-	-		

					NK SCHEDULE				
ITEM	MANUFACTURER	LOCATION	SERVICE	QTY	CAPACITY (GAL)	DIMENSIONS LXWXH (+/- 6" WHEN FILLED	INLET DIAMETER (IN)	EMPTY WEIGHT (LBS)	NOTES
SPL	FOLDA-TANK	NORTH-CENTRAL FROM HOUSE	SUPPLY	3	525	8'-3"x5'-4"x18"	4	33	-
GW	FOLDA-TANK	NORTH EAST OF HOUSE	GRAY WATER	1	525	8'-3"x5'-4"x18"	4	33	-
BW	FOLDA-TANK	SOUTH-CENTRAL FROM HOUSE	BLACK WATER	1	525	8'-3"x5'-4"x18"	4	33	-

	PUMP SCHEDULE														
ITEM	EQUIPMENT DESCRIPTION	MODEL	LOCATION	SYSTEM	GPM	HEAD		ELECTRI	CAL DATA		WEIGHT	NOTES			
						(FT)	HP	VOLT	PHASE	HZ	(LBS)				
WBP	GOULDS	JRS5K	MECHANICAL ROOM	WATER BOOSTER PUMP & ACCUMULATOR TANK	14.6	6	0.5	230	1	60	58	2, 3			
STP	SUNMAXX SOLAR	UNIMAXX PLUS PUMP STATION	MECHANICAL ROOM	SOLAR THERMAL	0.26 - 3.43	5	0.12	115	1	60	-	1, 2			
ST	SUNMAXX SOLAR	TITAN POWER PLUS SU-2 FLAT PLATE COLLECTOR	ROOF	SOLAR THERMAL	.1379	-	-	-	-	-	75	-			
NOTES	•	•		•		•		•	•			•			

NOTES:

1. PUMP STP IS TO BE MOUNTED TO WALL

2. PUMPS ARE IN-LINE

3. PUMP WBP IS TO BE MOUNTED TO FLOOR

				DRAINPAI	N SCHEDULE		
ITEM	MANUFACTURER	MODEL NO.	LOCATION	EQUIPMENT SERVED	DIMENSION (IN)	CONNECTION FOR DRAIN DIAMETER (IN)	NOTES
DP-1	SEARS	33016	MECHANICAL ROOM	DHW	DIAMETER 24	1	DHW SITS ON DRAIN I
DP-2	САМСО	20752	BEDROOM CLOSET	CW	30 X 32	1	CW SITS ON DRAIN P

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6. CHECK VALVES SHALL BE PVC BALL CHECK VALVES OF APPROPRIATE SIZE, PROVIDED BY AMERICAN VALVE, INC. AND SHALL HAVE A PRESSURE RATING OF A LEAST 126 PSIG AT 73 F.

7. TRANSITION FITTINGS IN BETWEEN PIPES OF DISSIMILAR DIAMETER SHALL BE SLEEVE-TYPE TRANSITION COUPLINGS (AWWA C219) PROVIDED BY CASCADE WATERWORKS MANUFACTURING. FITTING SHALL HAVE PRESSURE RATING AT LEAST EQUAL TO PIPES TO BE JOINED.

1

1. SUPPLY WATER SHALL FIRST TRANSITION FROM 4" OUTLET OF TANKS TO 1 1/4" PIPING WITH THE USE OF A BUSHING LOCATED DIRECTLY AT THE OUTLET OF TANK.

2. SUPPLY WATER SHALL RUN THROUGH CEILING BETWEEN TAPERED RIGID INSULATION AND EXTERIOR GRADE PLYWOOD.

3. SUPPY WATER SHALL DROP VERTICALY TO FIXTURES THROUGH WALL SPACE IN AN APPROPRIATE FASHION TO MEET FIXTURE INLET.

4. A PURPLE PRIMER THAT CONFORMS TO ASTM F 656 SHALL BE APPLIED TO PVC SOLVENT-CEMENTED JOINTS. SOLVENT CEMENT FOR PVC PLASTIC PIP CONFORMING TO ASTM D 2554 SHALL BE APPLIED TO ALL JOINT SURFACES.

5. MANUAL VALVES SHALL BE PVC NON-UNION BALL VALVES OF APPROPRIATE SIZE, PROVIDED BY AMERICAN VALVE, INC. AND SHALL BE MSS SP-122 STANDARD WITH A PRESSURE RATING OF AT LEAST 125 PSIG AT 73 F.

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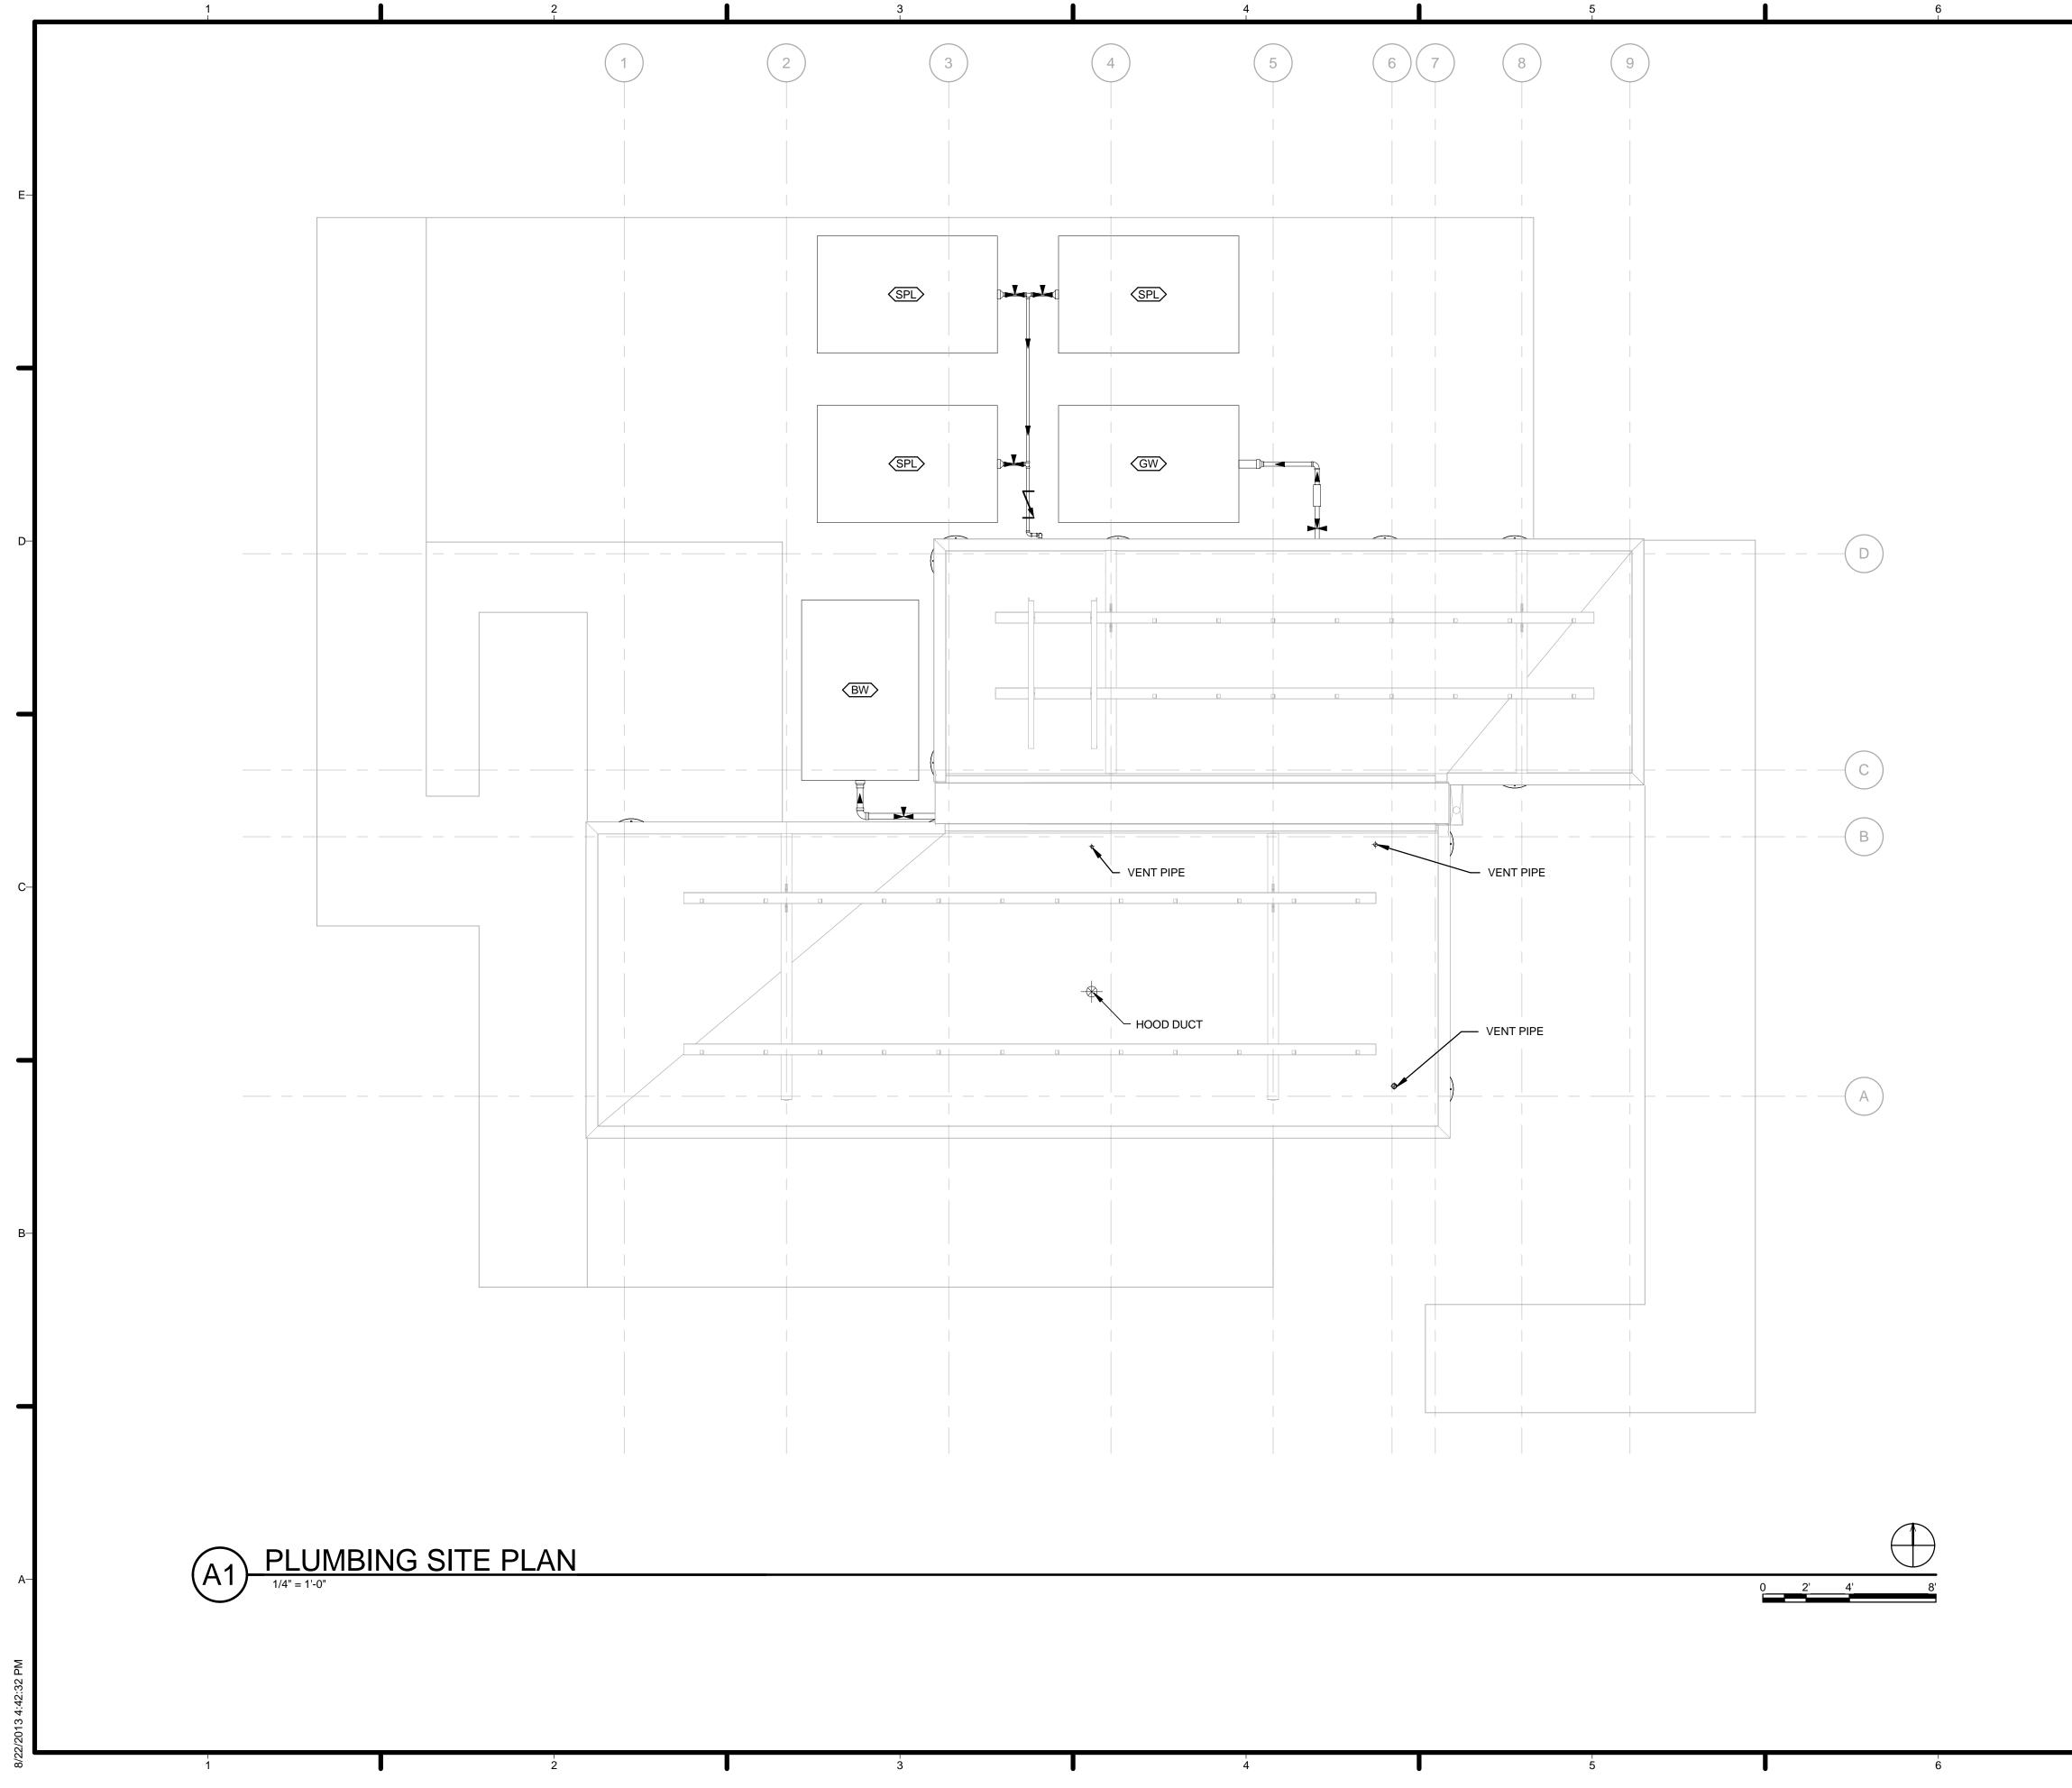
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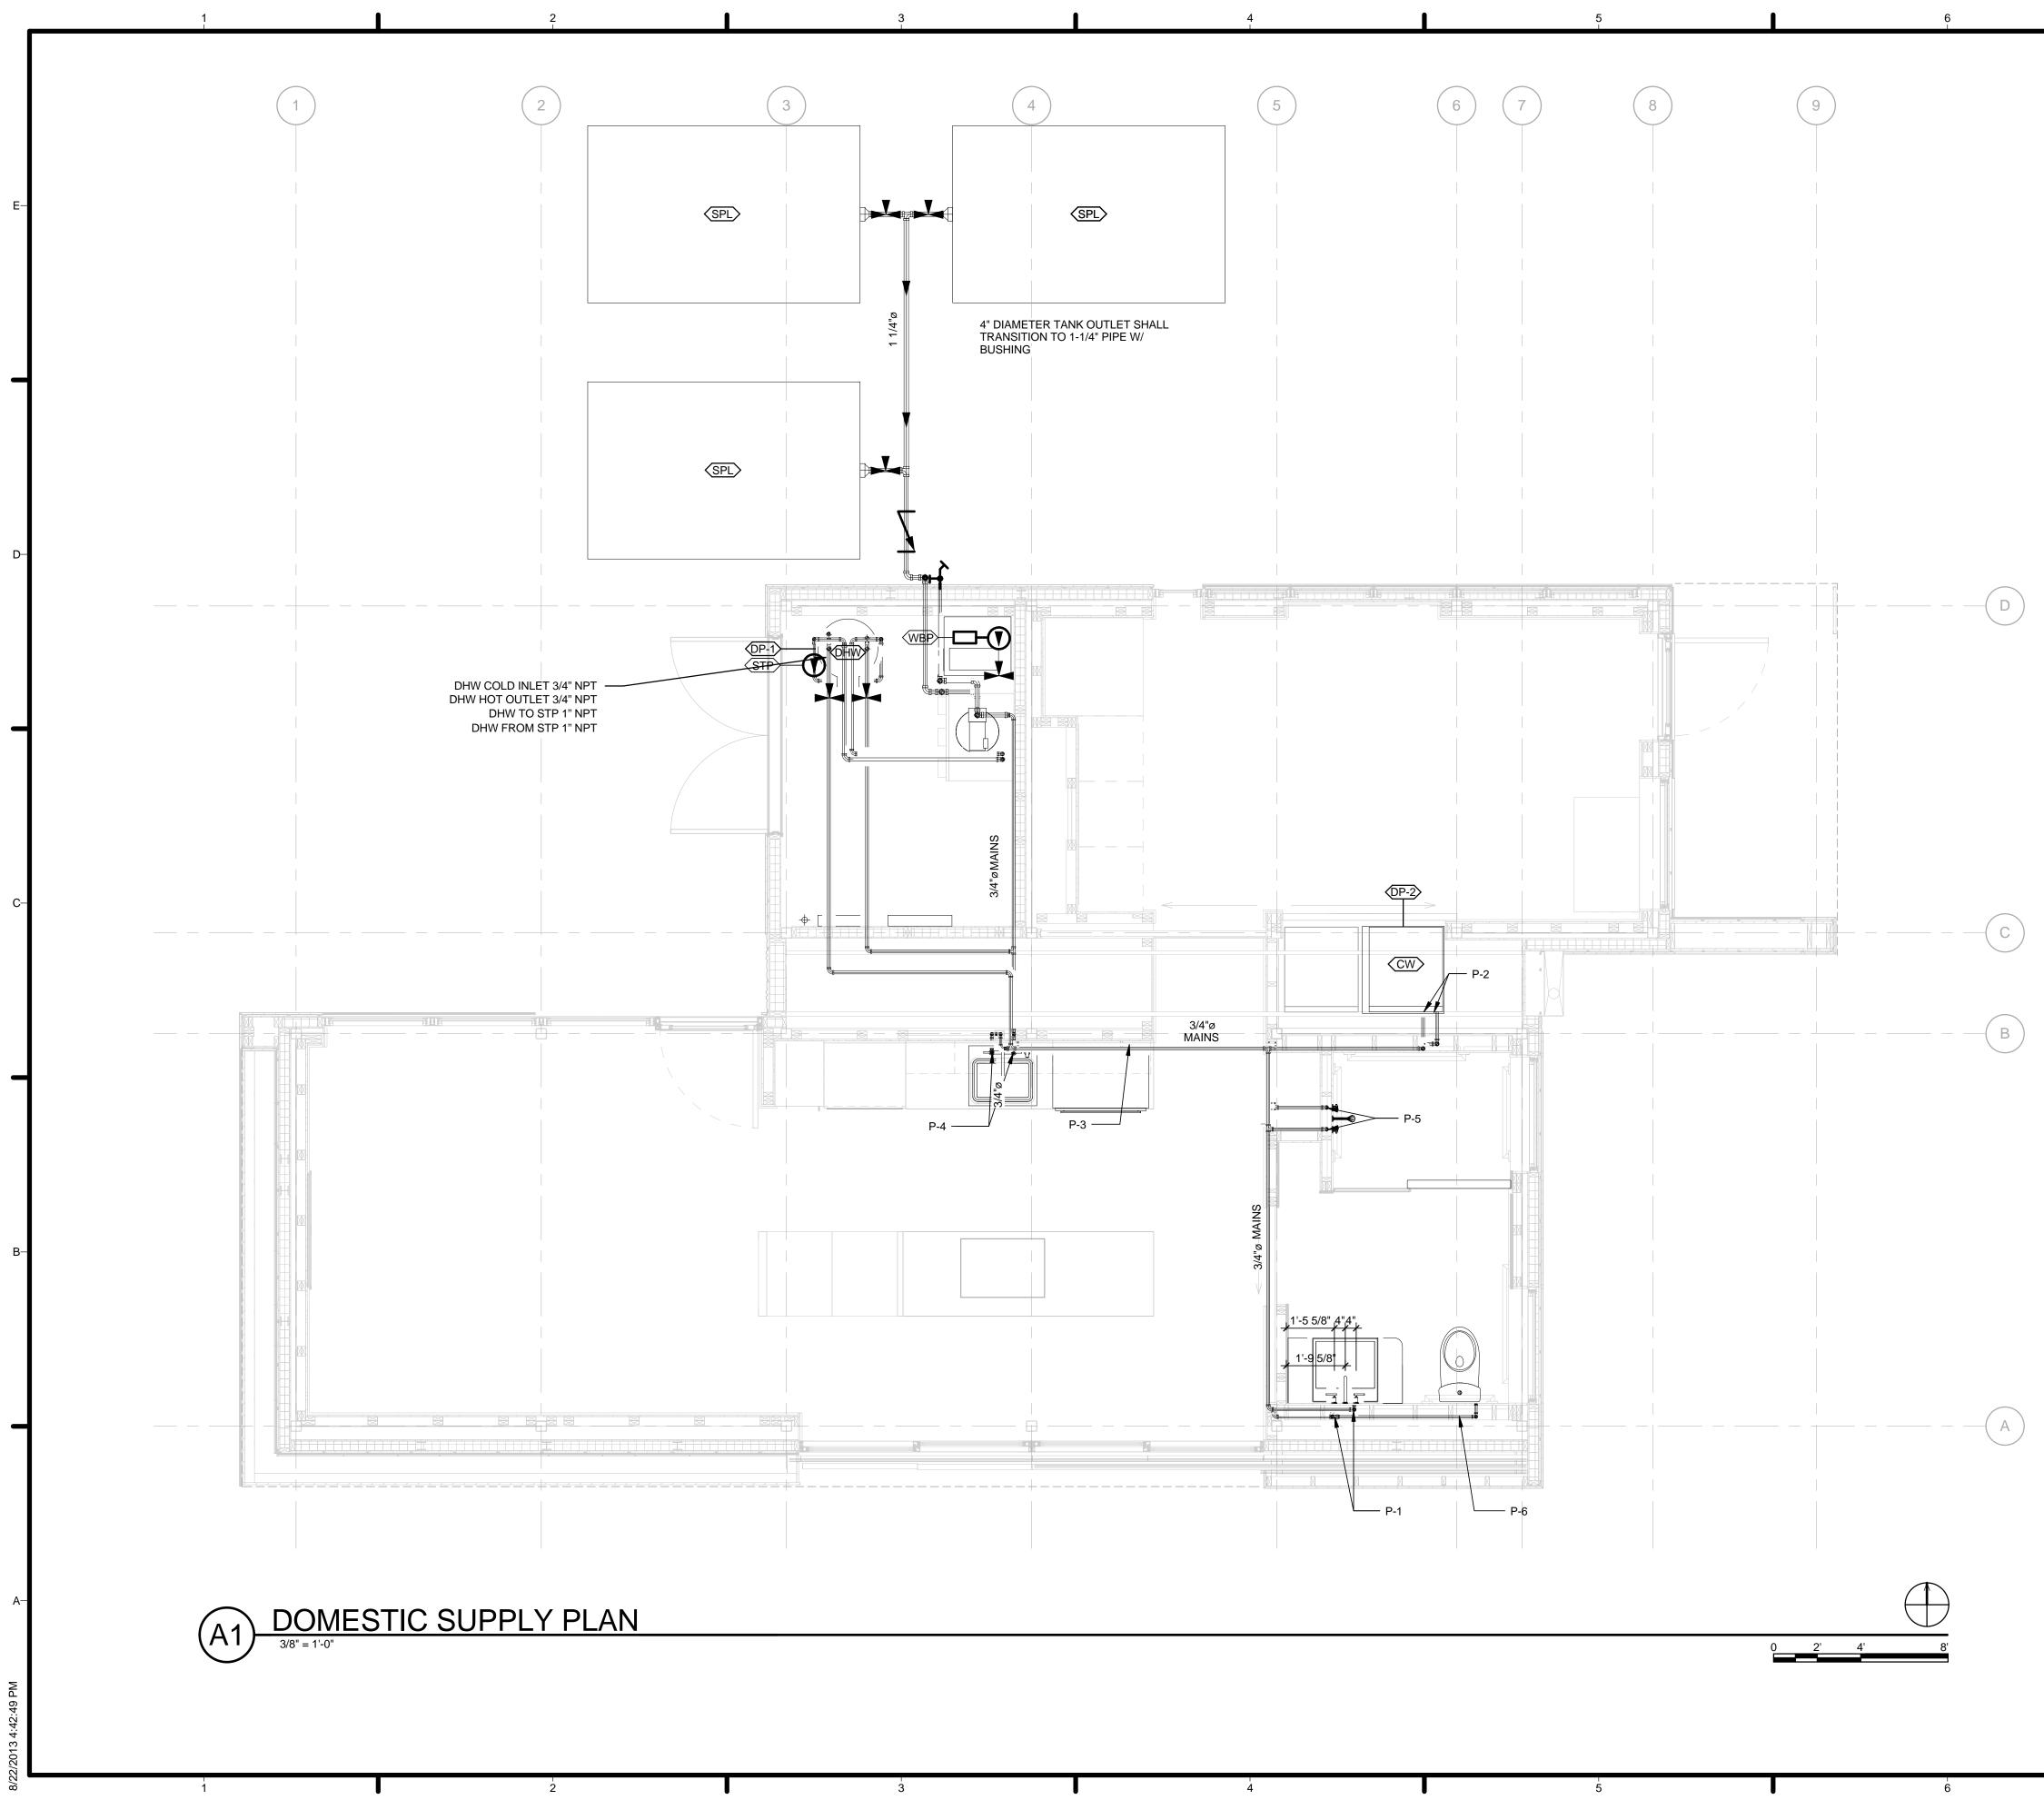
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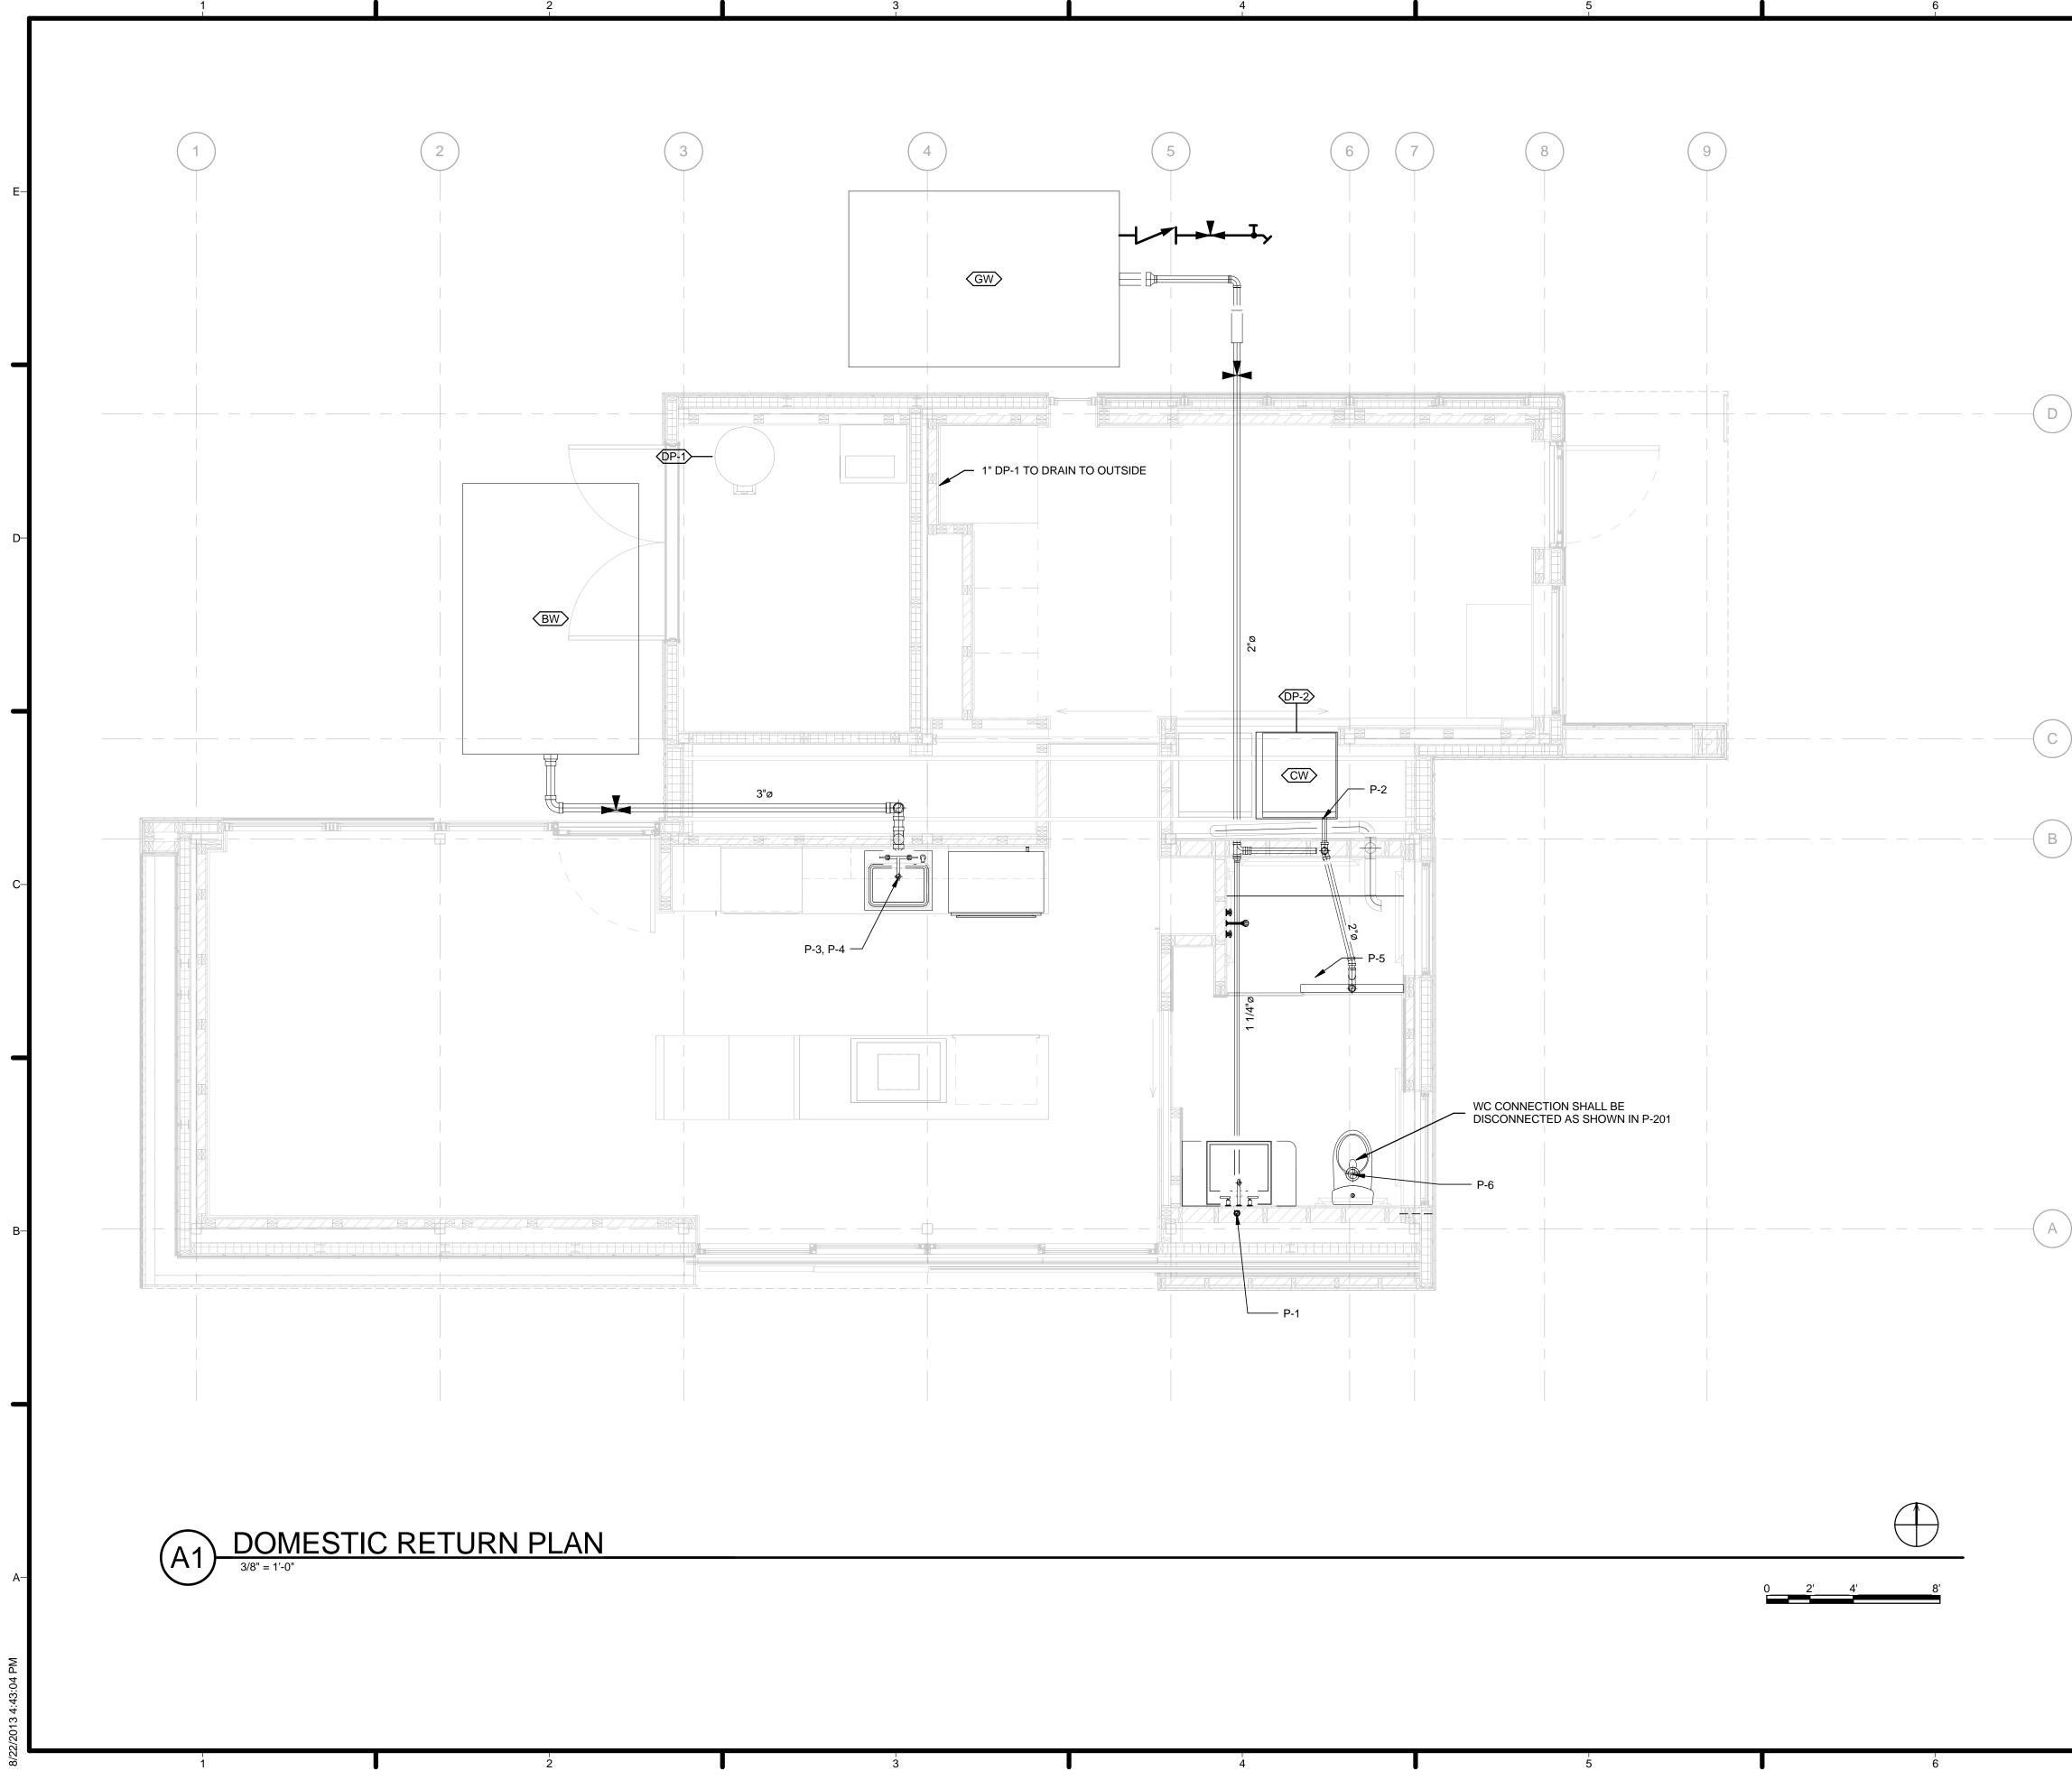
-E	HARVEST SC	
	TEAM NAME: Team Ca ADDRESS: THE CATHOLIC UNIVERSITY OF AN SCHOOL OF ARCHITE 620 MICHIGAN AVEN WASHINGTON, DO	IERICA CTURE JE, NE.
-D	STRUCTURAL ENGINEER BOB ALLISON, PE ARUP ENGINEERING 1120 CONNECTICUT AVENUE, NW., SUITE 200 WASHINGTON, DC 20036 TEL: 202.729.8220 MEP ENGINEER ARUP ENGINEERING	
	1120 CONNECTICUT AVENUE, NW., SUITE 200 WASHINGTON, DC 20036 TEL: 202.729.8220 ARCHITECT OF RECORD WILLIAM JELEN, AIA 620 MICHIGAN AVE NE CROUGH CENTER WASHINGTON, DC 20064 TEL: 202.344.5513	
-c	CLIENT U.S. DEPARTMENT OF ENERGY SOLAR DECATHLON 2013 WWW.SOLARDECATHLON.GOV	
	U.S. DEPARTMENT OF ENERGY SOLAR DECATHL	ON
-В	Image: second	
	4 2013.08.22 As-Built Submission 3 2013.02.04 100% CD Submission 2 2012.11.20 80% DD Revisions 1 2012.10.11 80% DD Submission MARK DATE DESCRIPTIC	DN
	LOT NUMBER: 115 DRAWN BY: TEAM CAPITOL DC CHECKED BY: TEAM CAPITOL DC COPYRIGHT: NONE: PROJECT IS PUBLIC DOMAIN	
—А	SHEET TITLE PLUMBING NOTES A SYMBOLS	ND
	P-001	

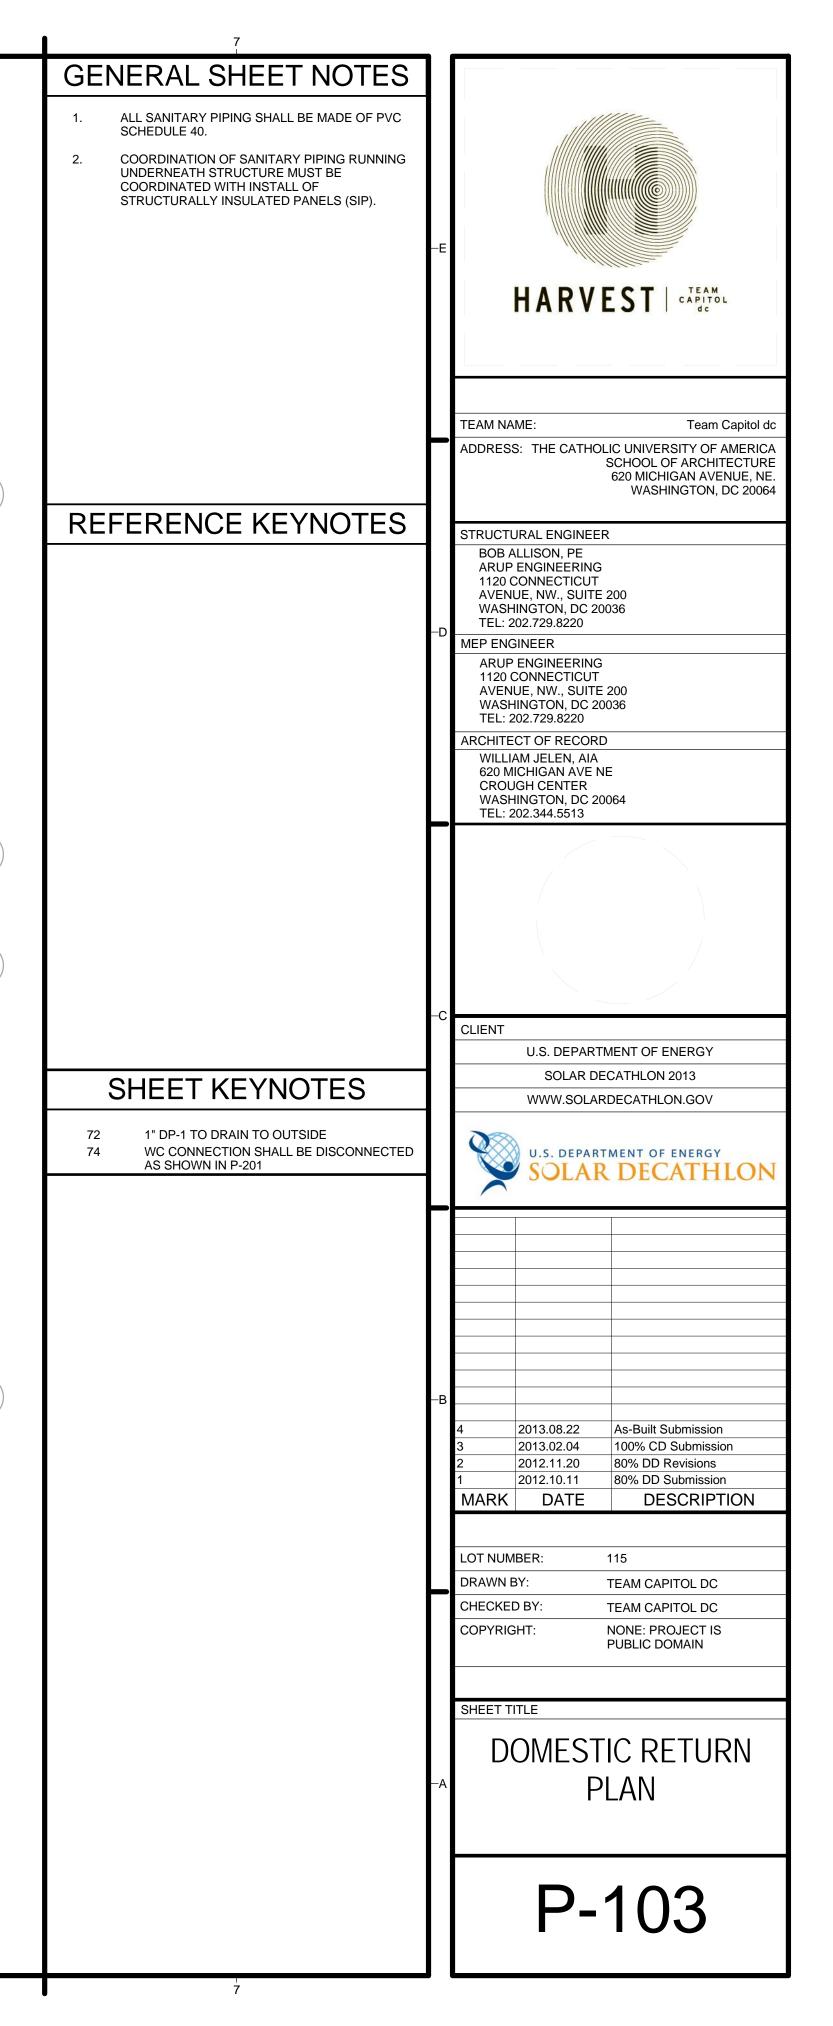


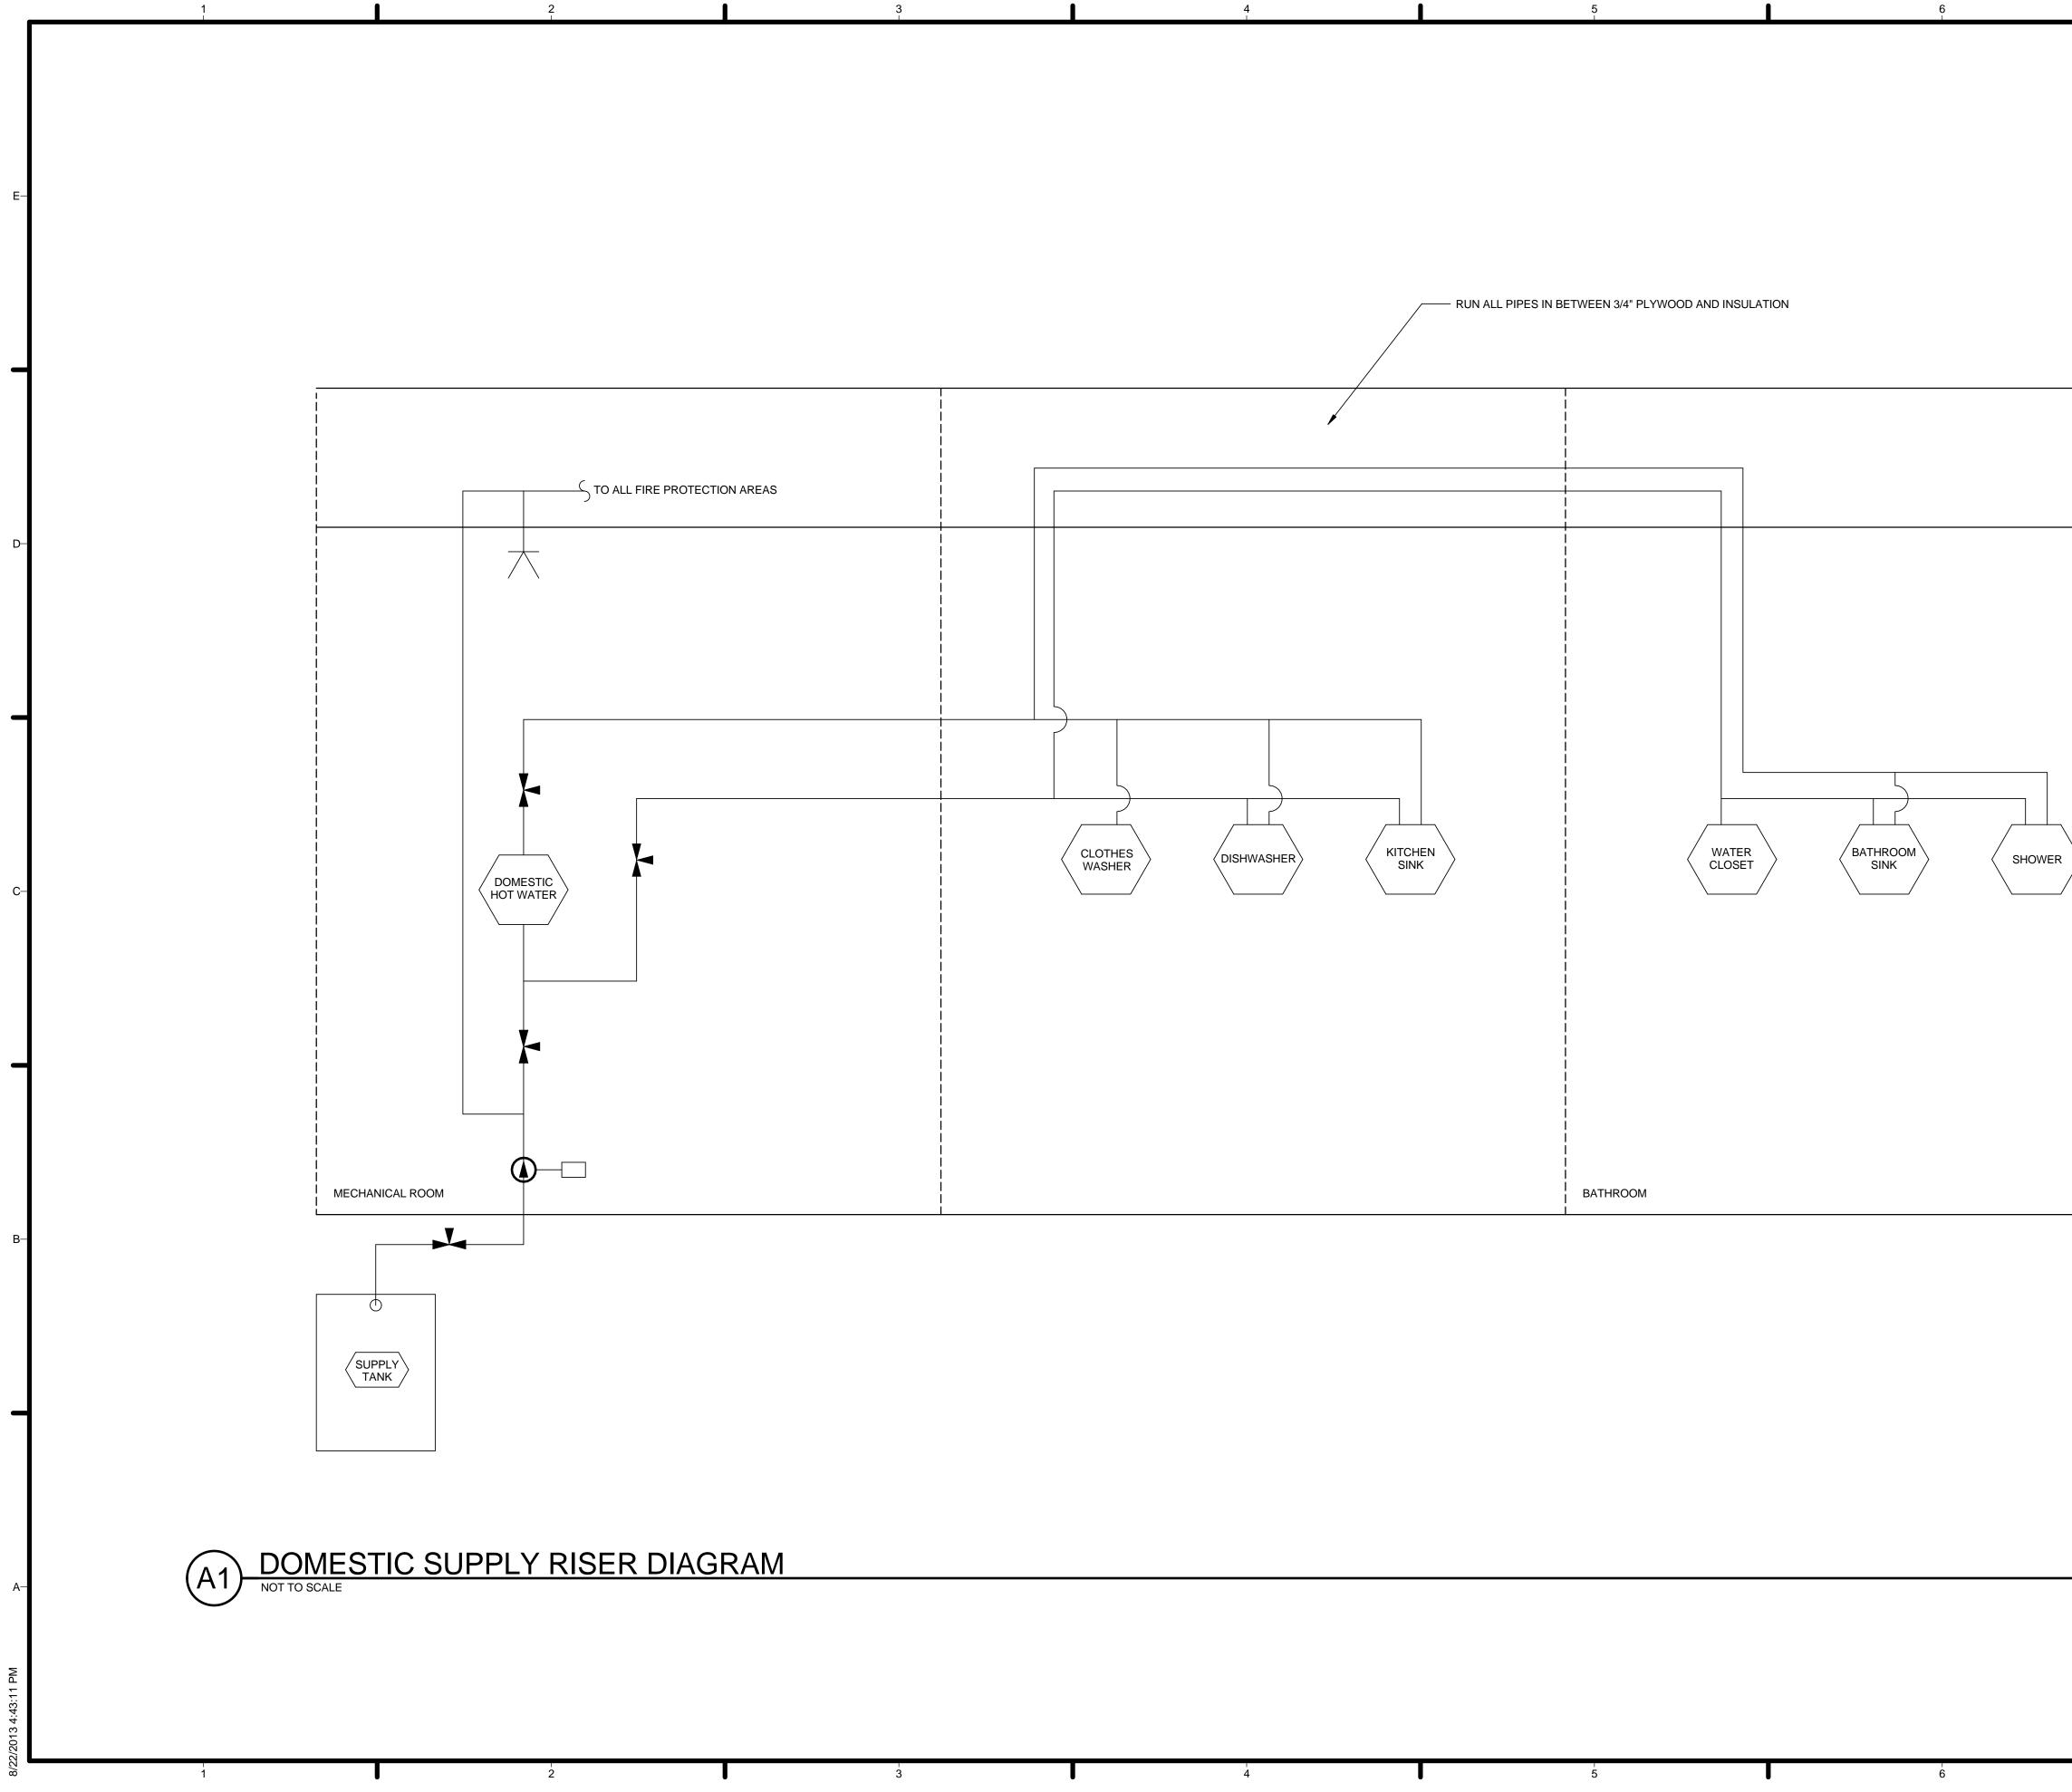
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GENERAL SHEET NOTES		
1. REFER TO SHEET P-001 FOR ABBREVIATIONS AND SYMBOLS		
AND STMBOLS		
	Ε	
		HARVEST
		TEAM NAME: Team Capitol dc
		ADDRESS: THE CATHOLIC UNIVERSITY OF AMERICA SCHOOL OF ARCHITECTURE
		620 MICHIGAN AVENUE, NE. WASHINGTON, DC 20064
REFERENCE KEYNOTES		STRUCTURAL ENGINEER
		BOB ALLISON, PE ARUP ENGINEERING
		1120 CONNECTICUT AVENUE, NW., SUITE 200
	-D	WASHINGTON, DC 20036 TEL: 202.729.8220
		MEP ENGINEER ARUP ENGINEERING
		1120 CONNECTICUT AVENUE, NW., SUITE 200
		WASHINGTON, DC 20036 TEL: 202.729.8220
		ARCHITECT OF RECORD WILLIAM JELEN, AIA
		620 MICHIGAN AVE NE CROUGH CENTER WASHINGTON, DC 20064
	\mathbf{F}	TEL: 202.344.5513
		\backslash
	–c	CLIENT
		U.S. DEPARTMENT OF ENERGY
SHEET KEYNOTES		SOLAR DECATHLON 2013 WWW.SOLARDECATHLON.GOV
67 VENT PIPE	1	
		U.S. DEPARTMENT OF ENERGY
		U.S. DEPARTMENT OF ENERGY SOLAR DECATHLON
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	—В	SOLAR DECATHION Solar Decation Solar
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	B	SOLAR DECATHION SOLAR DECATHION Solar decays Solar decays <tr< th=""></tr<>
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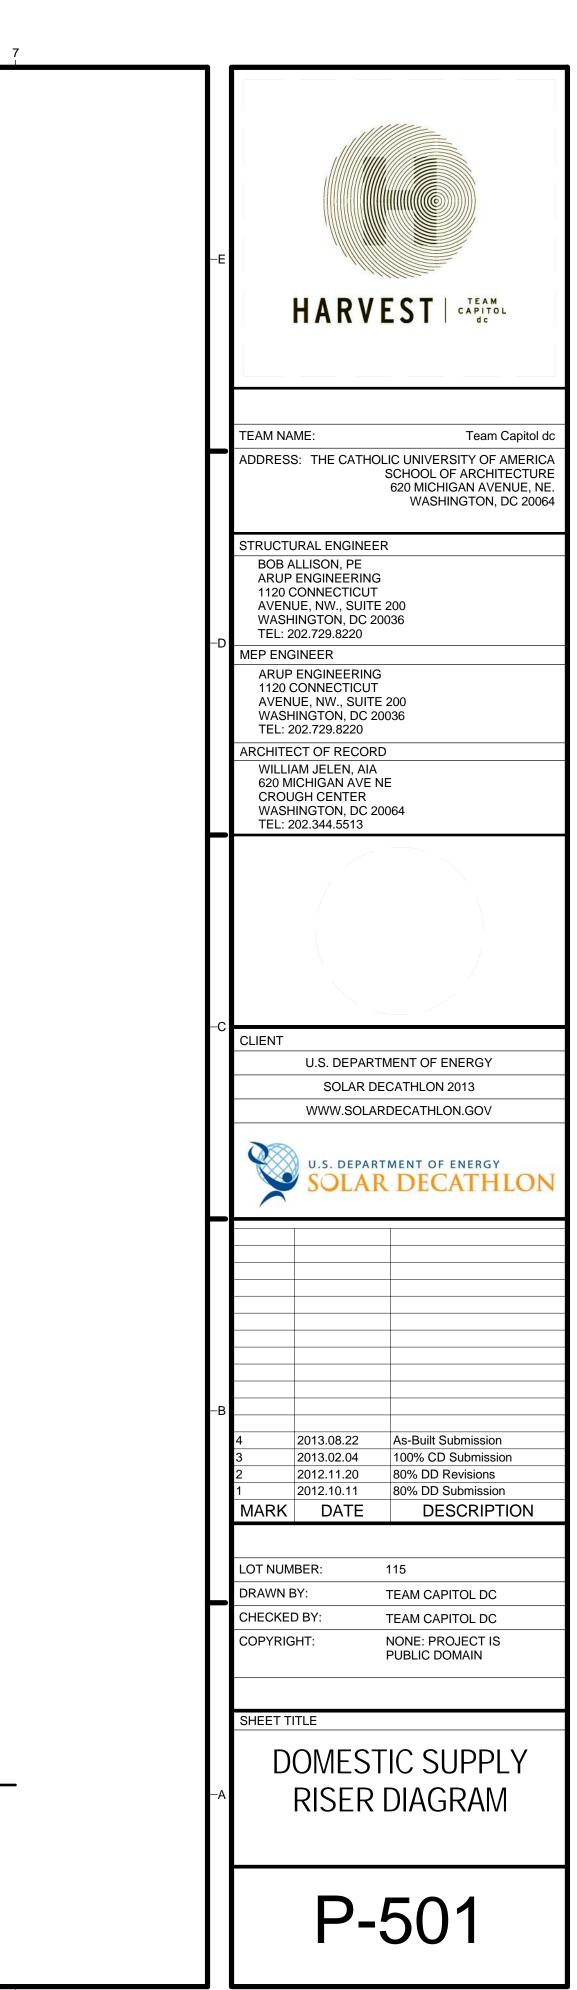


7	_
GENERAL SHEET NOTES	
1. ALL DOMESTIC WATER SUPPLY SHALL BE MADE OF PVC SCHEDULE 40.	
2. SUPPLY WATER PIPING SHALL RUN ALONG FLOOR IN MECHANICAL ROOM	
3. WBP Ø 15.75" HEIGHT 38.0" TO BE MOUNTED TO	
 FLOOR STP WIDTH 12.5", HEIGHT 20.5", TO FLBE 	
MOUNTED TO FLOOR	-E
5. ALL FIXTURES SHALL HAVE MANUAL VALVES LOCKED NEAR PIPE CONNECTION, EXCEPT FOR SHOWER	HARVEST
6. DP-1 AND DP-2 SHALL DRAIN OUTSIDE OF	
STRUCTURE AS SHOWN IN P-1027. DHW COLD INLET	
	ADDRESS: THE CATHOLIC UNIVERSITY OF AMERICA
	SCHOOL OF ARCHITECTURI 620 MICHIGAN AVENUE, NE WASHINGTON, DC 2006
REFERENCE KEYNOTES	
	STRUCTURAL ENGINEER BOB ALLISON, PE ARUP ENGINEERING
	1120 CONNECTICUT AVENUE, NW., SUITE 200
	WASHINGTON, DC 20036 TEL: 202.729.8220
	MEP ENGINEER ARUP ENGINEERING 1120 CONNECTICUT
	AVENUE, NW., SUITE 200 WASHINGTON, DC 20036
	TEL: 202.729.8220 ARCHITECT OF RECORD
	WILLIAM JELEN, AIA 620 MICHIGAN AVE NE CROUGH CENTER
	WASHINGTON, DC 20064 TEL: 202.344.5513
	/
	-C CLIENT
	U.S. DEPARTMENT OF ENERGY SOLAR DECATHLON 2013
SHEET KEYNOTES	WWW.SOLARDECATHLON.GOV
77 DHW COLD INLET 3/4" NPT78 DHW HOT OUTLET 3/4" NPT	U.S. DEPARTMENT OF ENERGY
79 DHW TO STP 1" NPT 80 DHW FROM STP 1" NPT	SOLAR DECATHLON
	-B
	4 2013.08.22 As-Built Submission 3 2013.02.04 100% CD Submission
	2 2012.11.20 80% DD Revisions 1 2012.10.11 80% DD Submission
	MARK DATE DESCRIPTION
	LOT NUMBER: 115 DRAWN BY: TEAM CAPITOL DC
	CHECKED BY: TEAM CAPITOL DC COPYRIGHT: NONE: PROJECT IS
	PUBLIC DOMAIN
	DOMESTIC SUPPLY
	PLAN
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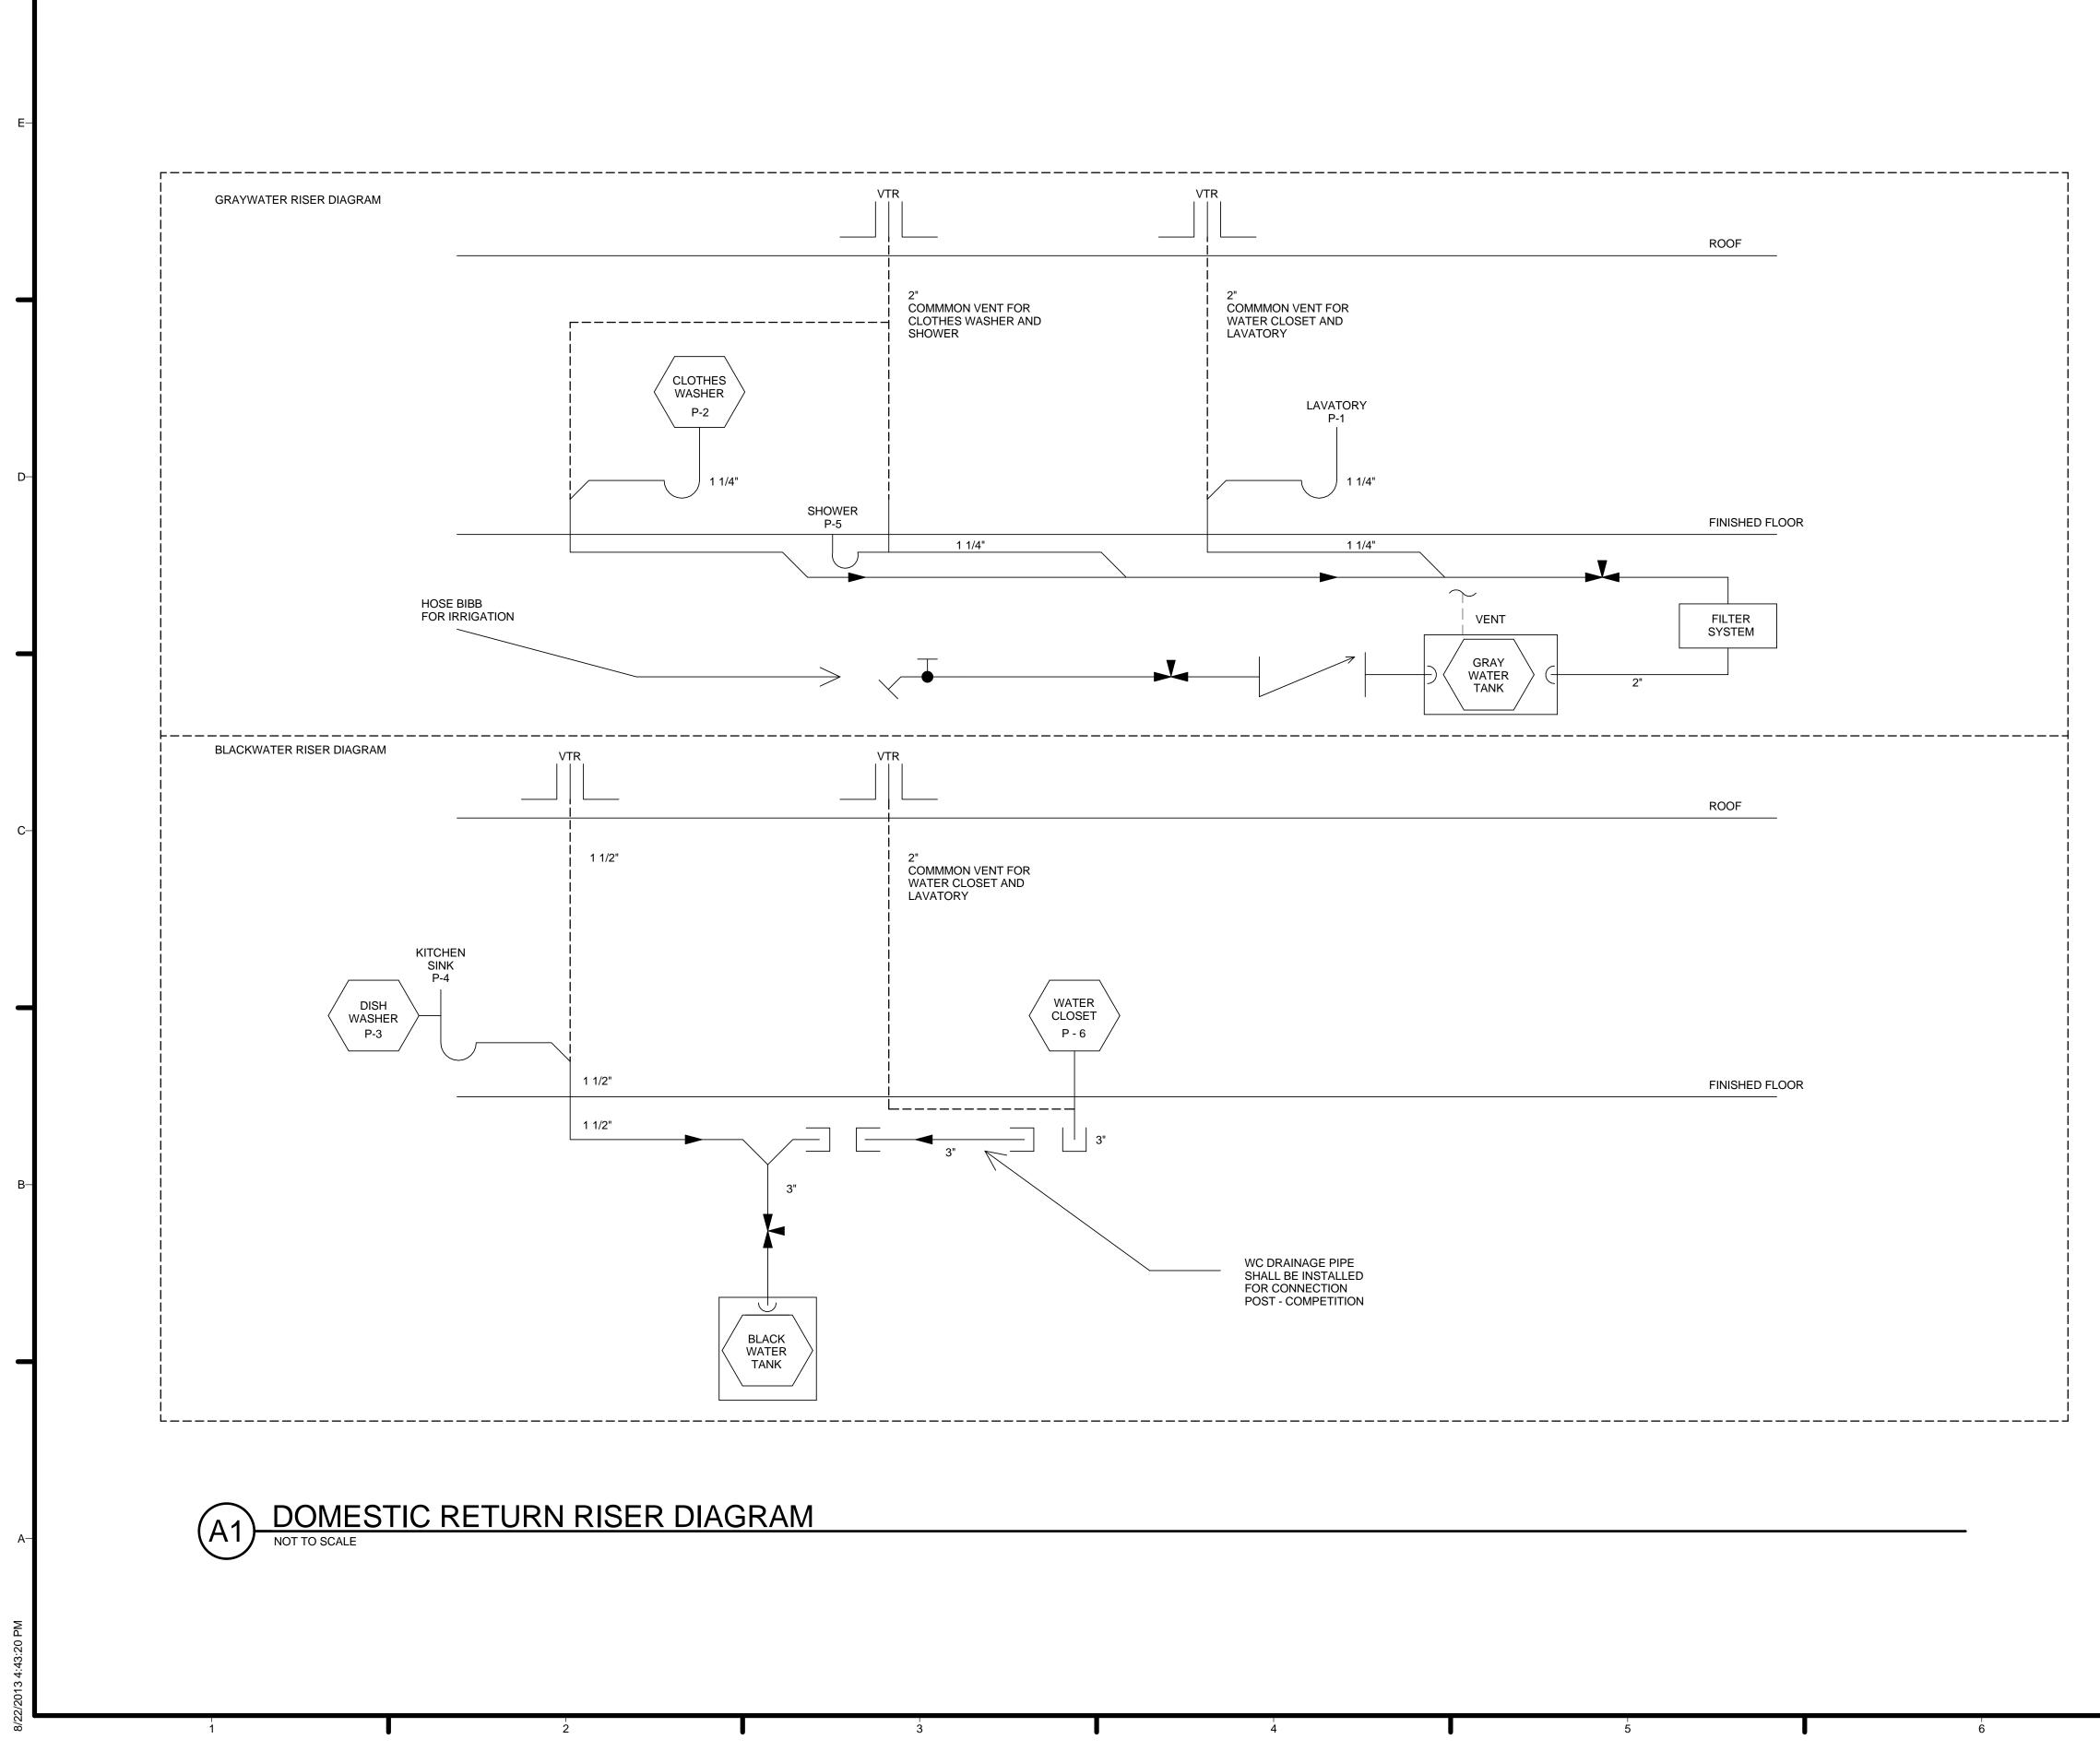


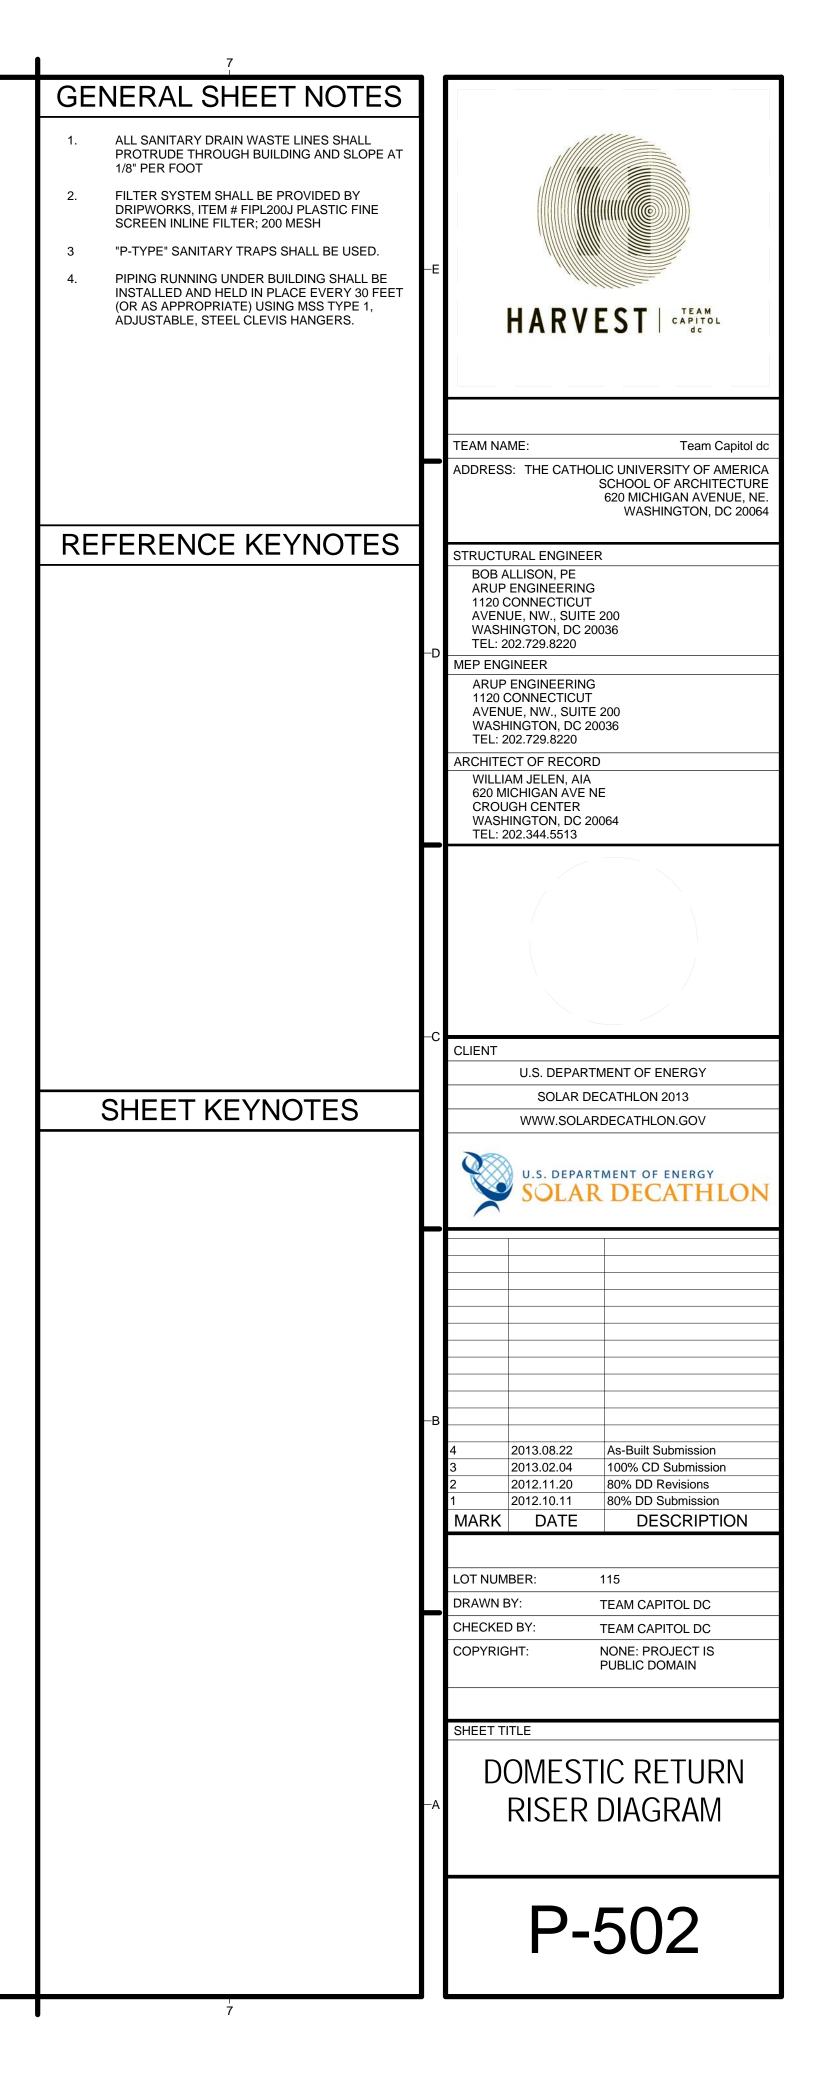


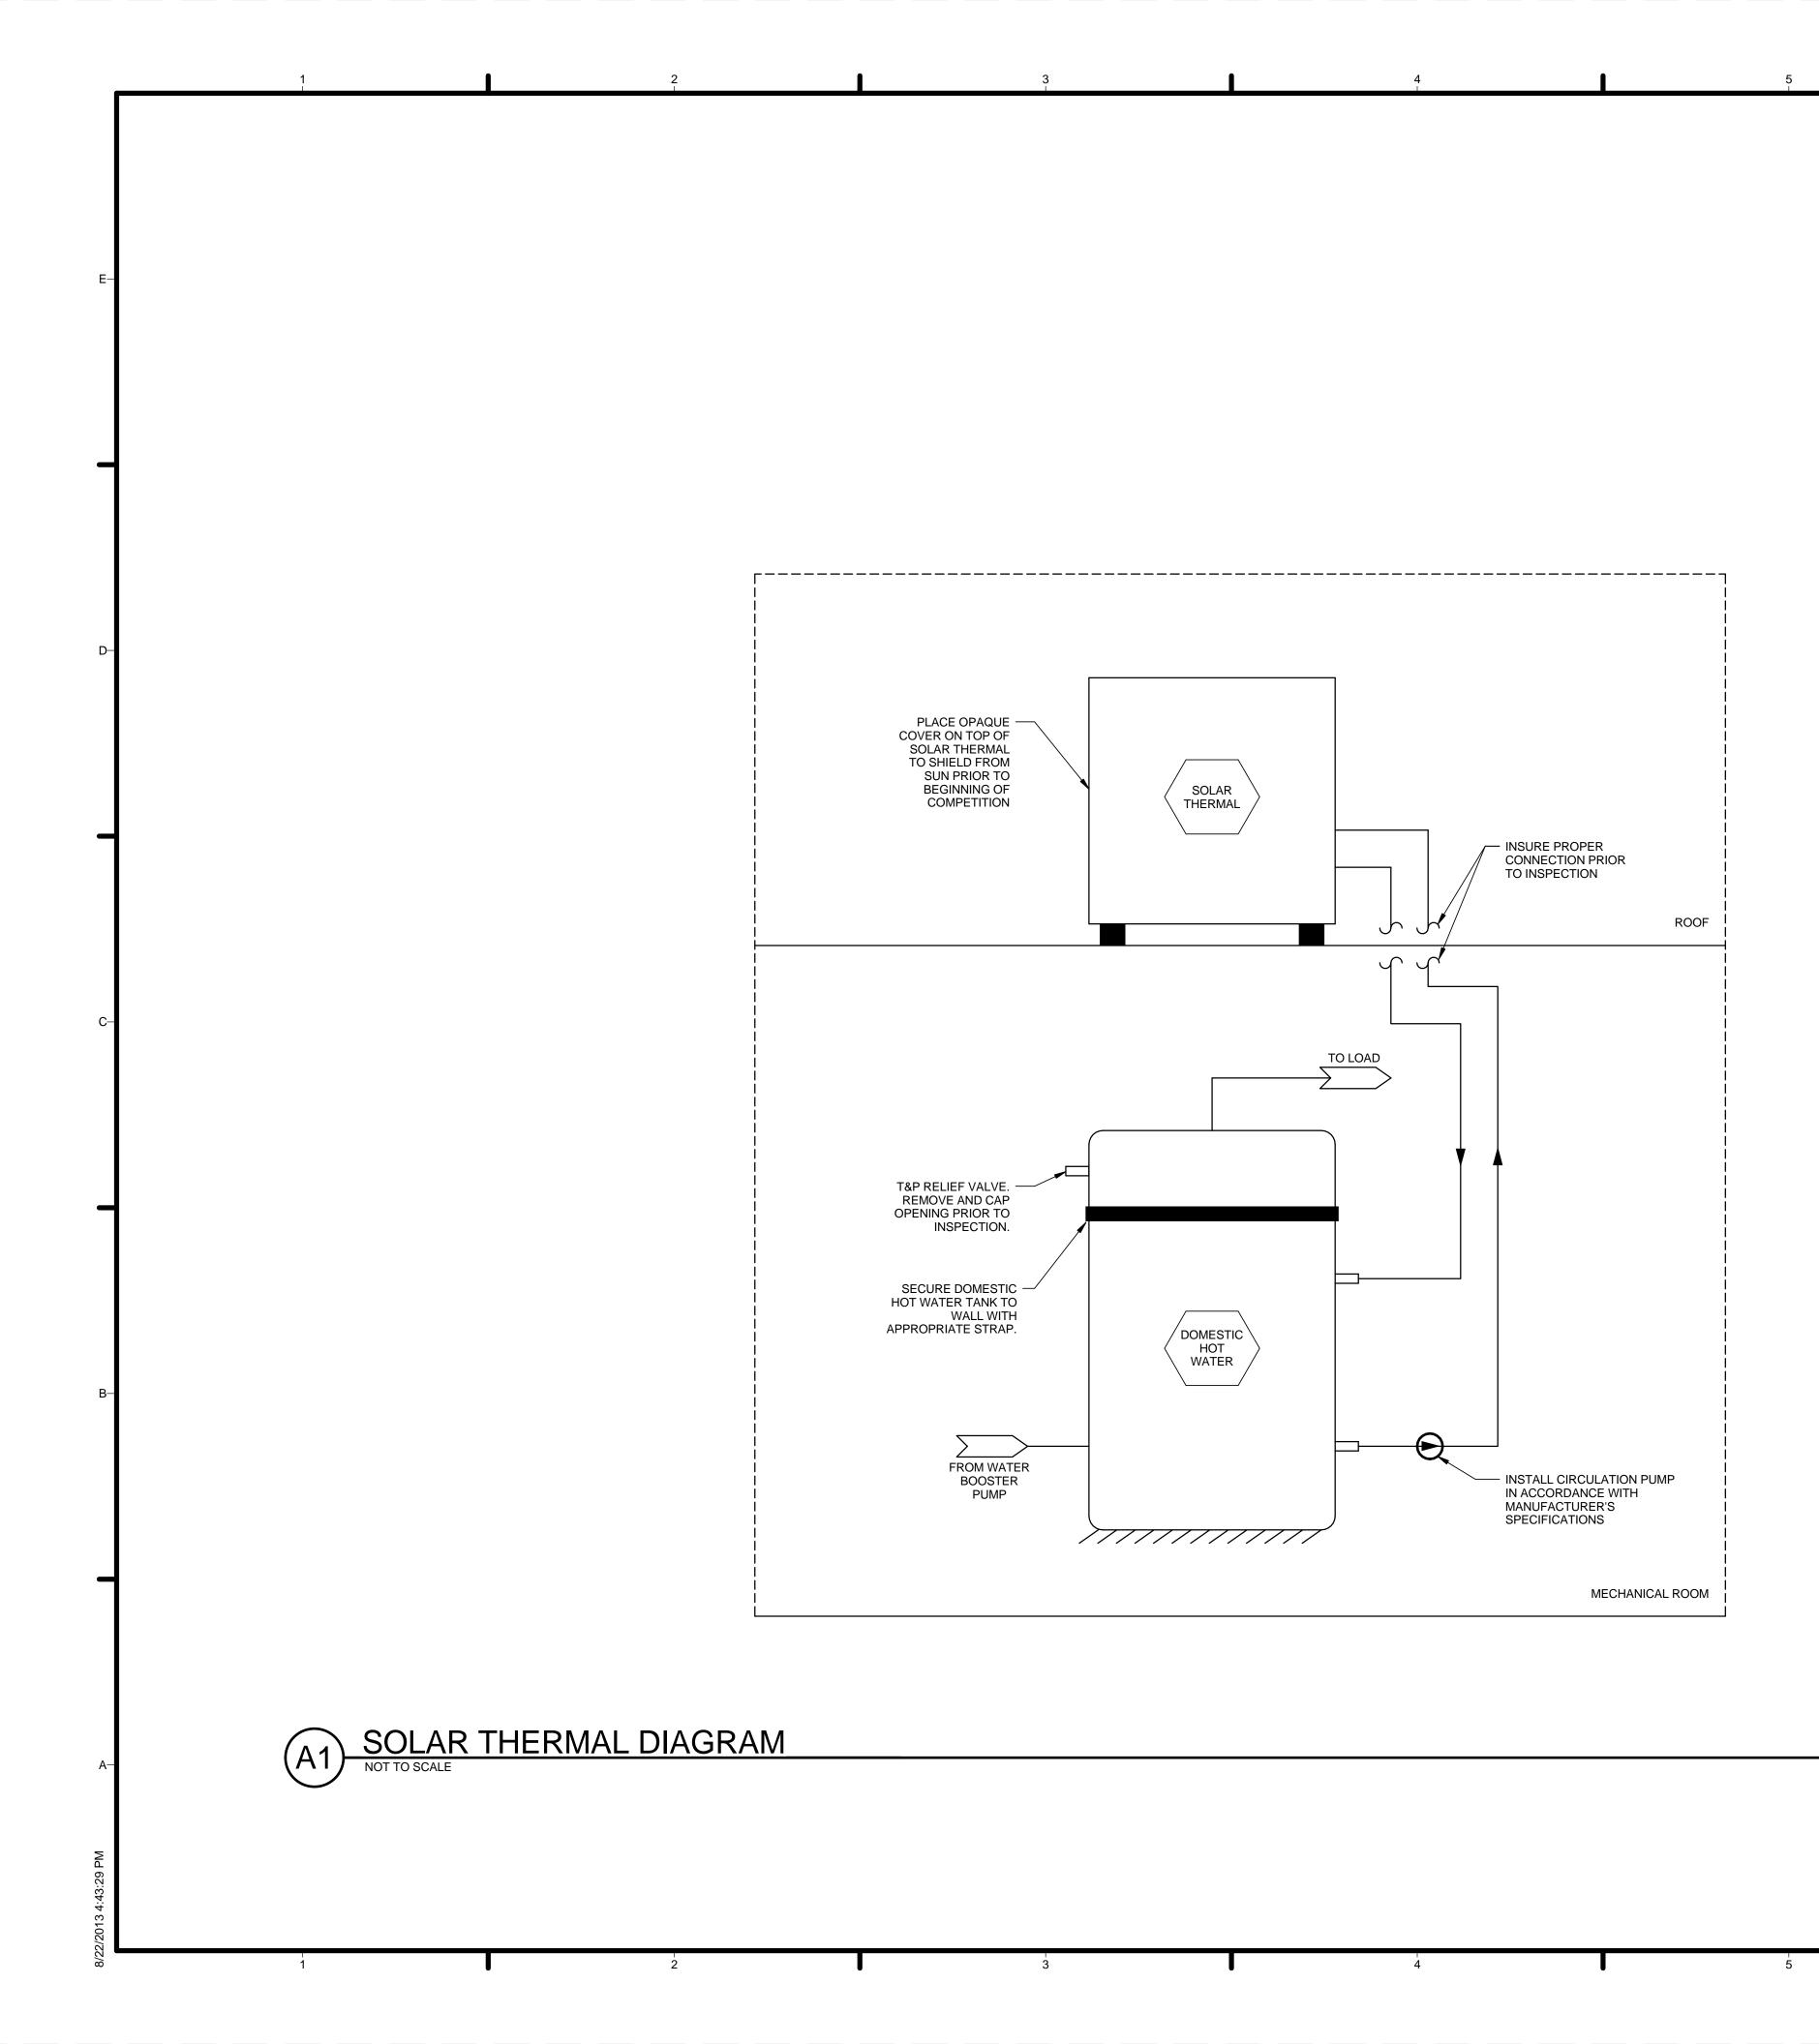


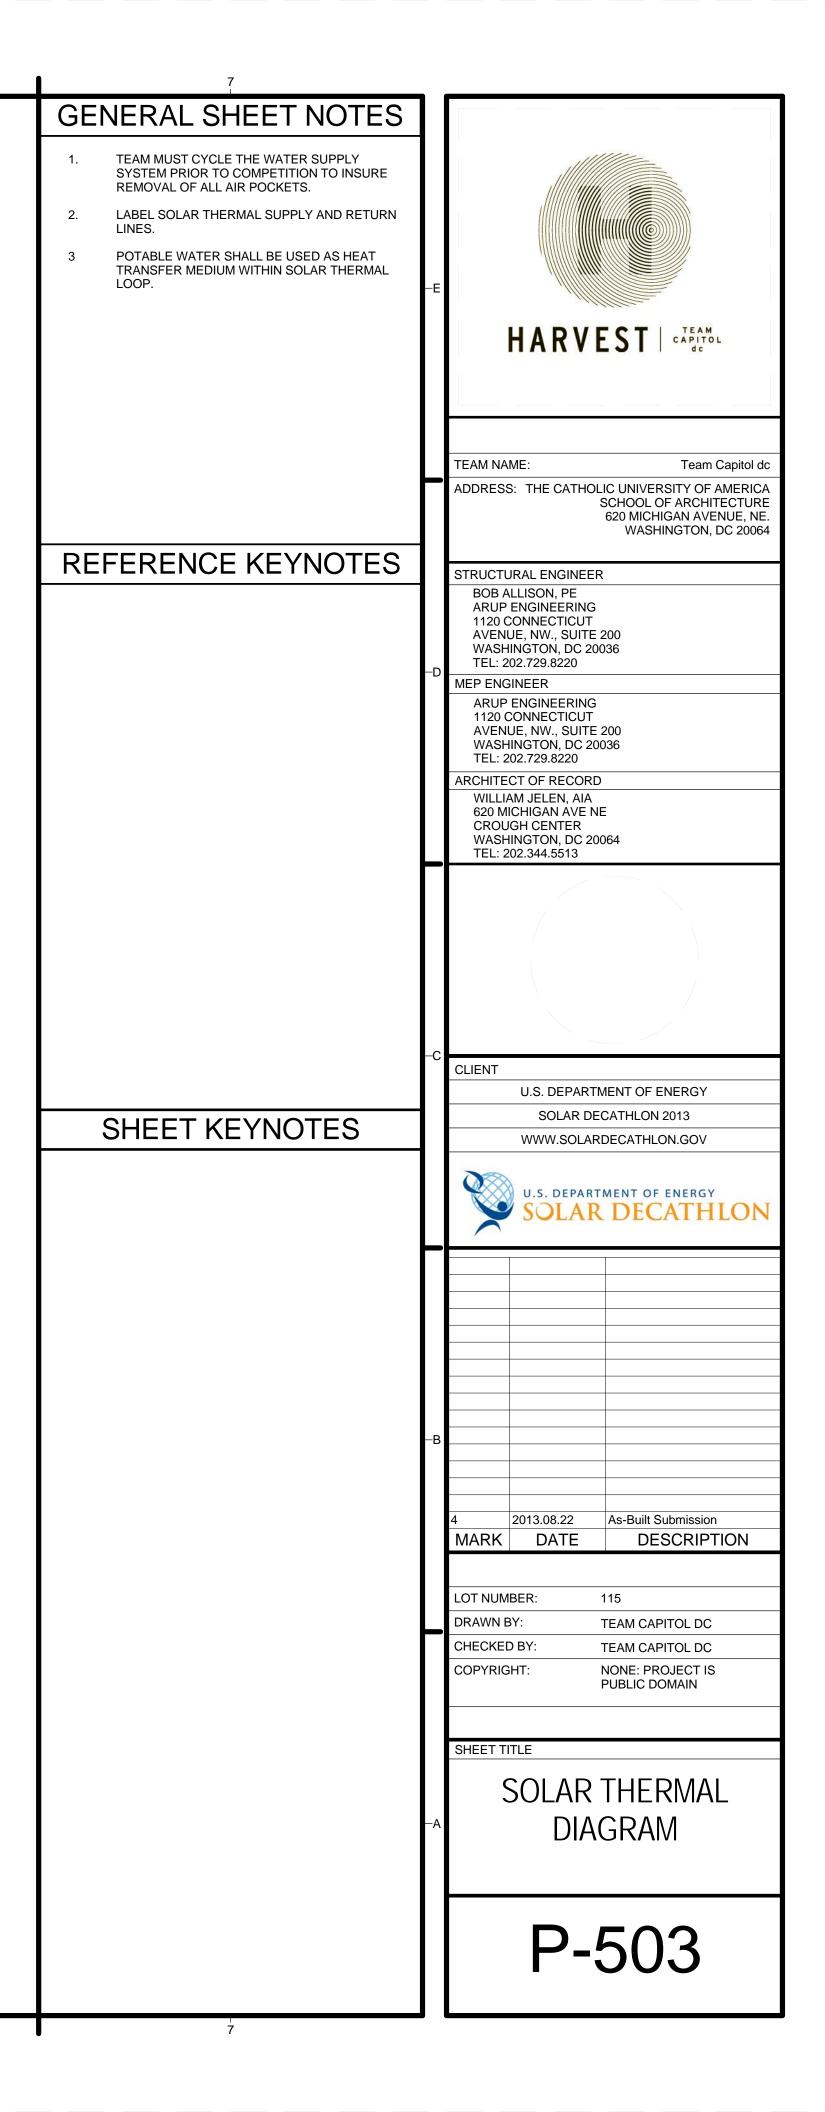
FINISHED FLOOR

CEILING CAVITY









ABBREVI	ATIONS
SYMBOL	DESCRIPTION
AHU	AIR HANDLING UNIT
BMS	BUILDING MANAGEMENT SYSTEM
DHW	DOMESTIC HOT WATER TANK
HP	HEAT PUMP
IDD	INTEGRATED DUCT DAMPERS

SYM	BOLS
SYMBOL	DESCRIPTION
	THERMOMETER
	HUMIDISTAT

DUCT S'	YMBOLS
SYMBOL	DESCRIPTION
	DAMPER
\bigcirc	SUPPLY DIFFUSER
	RETURN GRILL

ALL DUCTWORK SHALL BE CONSTRUCTED, ERECTED, AND TESTED IN ACCORDANCE WITH THE MOST RESTRICTIVE OF LOCAL REGULATIONS, PROCEDURES DETAILED IN THE ASHRAE HANDBOOK OF FUNDAMENTALS, OR THE APPLICABLE STANDARDS ADOPTED BY THE SHEET METAL AND AIR CONDITIONING CONTRACTORS NATIONAL ASSOCIATION.

2

								AIR HAND	LING UN	NIT SCHI	EDULE											
ITEM	MANUFACTURER	MODEL NO.	LOCATION	AREA SERVED	OUTSIDE	SUPPLY FAN					COOLING					HEATING		FILTER		NOTES		
					AIR	DESIGN	МАХ	EXTL.	MOTOR DATA			EAT	EAT	LAT	LAT	CAPACITY	EAT	CAPACITY	LxWxD	MERV		
						RATE	RATE	SP	MAX	VOLT	PH	HZ										
									HP				DB	WB	DB	WB		DB				
					(CFM)	(CFM)	(CFM)	(IN WG)					(F)	(F)	(F)	(F)	(MBH)	(F)	MBH			
AHU	YORK	MV12DN21C	MECHANICAL ROOM	ALL CONDITIONED SPACES	30	900	1,200	0.50	-	240	1	60	46.5	64.9	53.5	52.9	36.0	34.0	36.0	20x24x2	8	1, 2

NOTES:

NOTES:

1. HEATING AND COOLING MODES UTILIZE THE SAME COIL. COIL SIZED FOR COOLING CONDITIONS.

2. PROVIDE DRAIN LINE

	AIR TO AIR HEAT PUMP SCHEDULE															
ITEM	MANUFACTURER	MODEL NO.	ROOMS SERVED	LOCATION			COC	DLING			HEA	TING	ELEC	CTRICAL DA	ТА	NOTES
					TOTAL	SENS	EAT	EAT	COMPRESSOR	CAPACITY	EAT	COMPRESSOR	VOLT	PH	HZ	
					CAPACITY	CAPACITY	DB	WB			DB					
					(MBH)	(MBH)	(F)	(F)	(kW)	(MBH)	(F)	(kW)				
HP	YORK	YZH03611C	ALL CONDITIONED SPACES	OUTSIDE MECH ROOM	38.9	20.1	78.0	70.0	2.43	39.7	47.0	2.33	230	1	60	1

1. PROVIDE THERMAL EXPANSION VALVE APR CONTROL DEVICE BY RAWAL DEVICES, INC. OR EQUIVALENT

	FAN SCHEDULE										
	MANUFACTURER	NUFACTURER MODEL TYPE AREA SERVED LOCATION C						Electrical Data			NOTES
ITEM							(IN W.G.)	W	VOLTAGE/PH/HZ	RPM	
EF	GREENHECK	SP-B90	CENTRIFUGAL	BATHROOM	CEILING MOUNTED	89	0.10	49.7	115/1/60	700	-
VH	FRIGIDAIRE	FHPC3660L S	CENTRIFUGAL	KITCHEN	CEILING MOUNTED	400	-	520	120/1/60	-	-

	IRC 2012 TABLE M1507.3.3(1) - VENTILATION AIRFLOW REQUIREMENTS										
DWELLING UNIT	NUMBER	REQUIRED									
FLOOR AREA	OF	AIRFLOW									
(FT^2)	BEDROOMS	(CFM)									
<15000	1	30									

		ELECTRIC HEATING COIL SCHEDULE												
	ITEM	MANUFACTURER	MODEL NO.	LOCATION		AIR FLOW DATA							NOTES	
					DESIGN FLOW			AIR	AIR SIDE ELECTRICAL					
					(CFM)	(IN WG)		EAT DB (F)	LAT DB (F)	PEAK LOAD (kW)	VOLT	PH	HZ	
ŀ	EH-1	MARKEL	HF SERIES	SUPPLY DUCT	360	0.08	15x8	53.5	59.0	0.5	240	1	60	1
	EH-2	MARKEL	HF SERIES	SUPPLY DUCT	300	0.08	15x8	53.5	59.0	0.5	240	1	60	1
	EH-3	MARKEL	HF SERIES	SUPPLY DUCT	240	0.08	14x6	53.5	59.0	0.5	240	1	60	1

NOTES: 1. SEE FLOOR PLANS FOR LOCATION

	ZONE CONTROL DAMPER SCHEDULE										
ITEM	MANUFACTURER	MODEL #	LOCATION		AIR FLOW DATA					NOTES	
				DESIGN FLOW	EXT SP DROP	COIL SIZE		AIR SIDE			
					o. Ditoi	0.22	EAT DB	VOLT	PH	HZ	
				(CFM)	(IN WG)	INxIN	(F)	AC			
ZCD-1	JACKSON SYSTEMS	HF SERIES	SUPPLY DUCT	360	0.08	15x8	53.5	24	1	60	1, 2
ZCD-2	JACKSON SYSTEMS	HF SERIES	SUPPLY DUCT	300	0.08	15x8	53.5	24	1	60	1,2
ZCD-3	JACKSON SYSTEMS	HF SERIES	SUPPLY DUCT	240	0.08	14x6	53.5	24	1	60	1,2

1. SEE FLOOR PLANS FOR LOCATION 2. PROVIDE 24 VOLT CONTROL TRANSFORMER

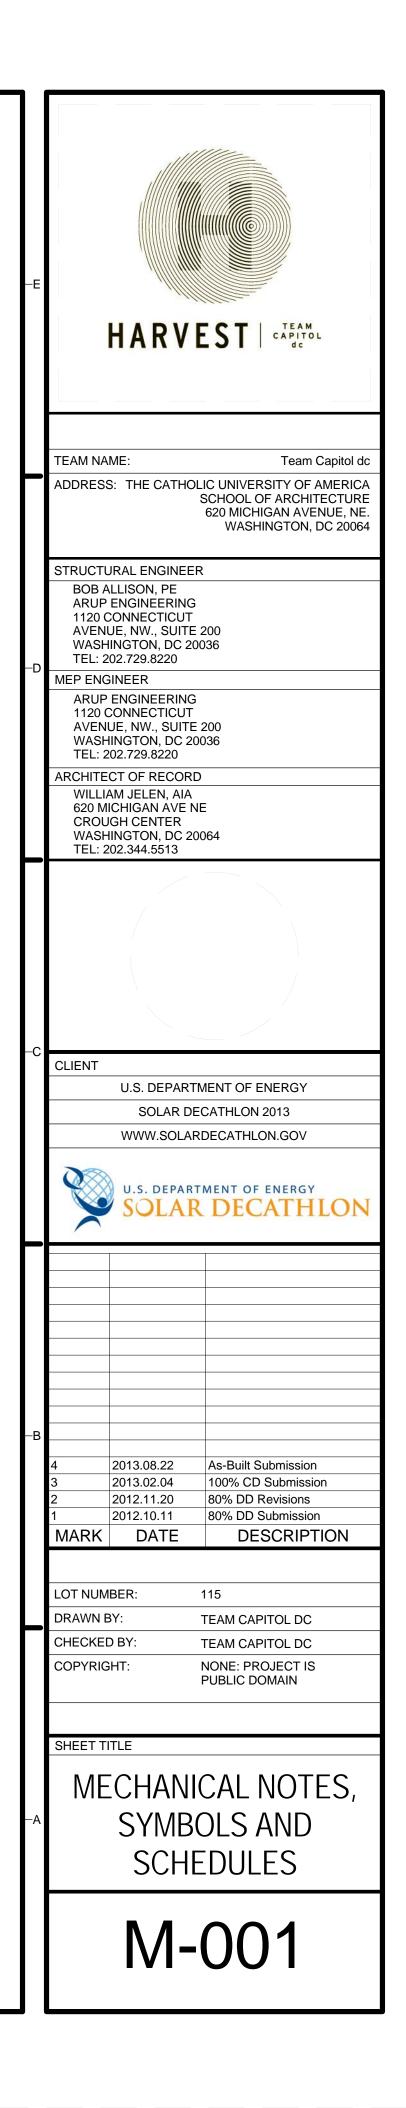
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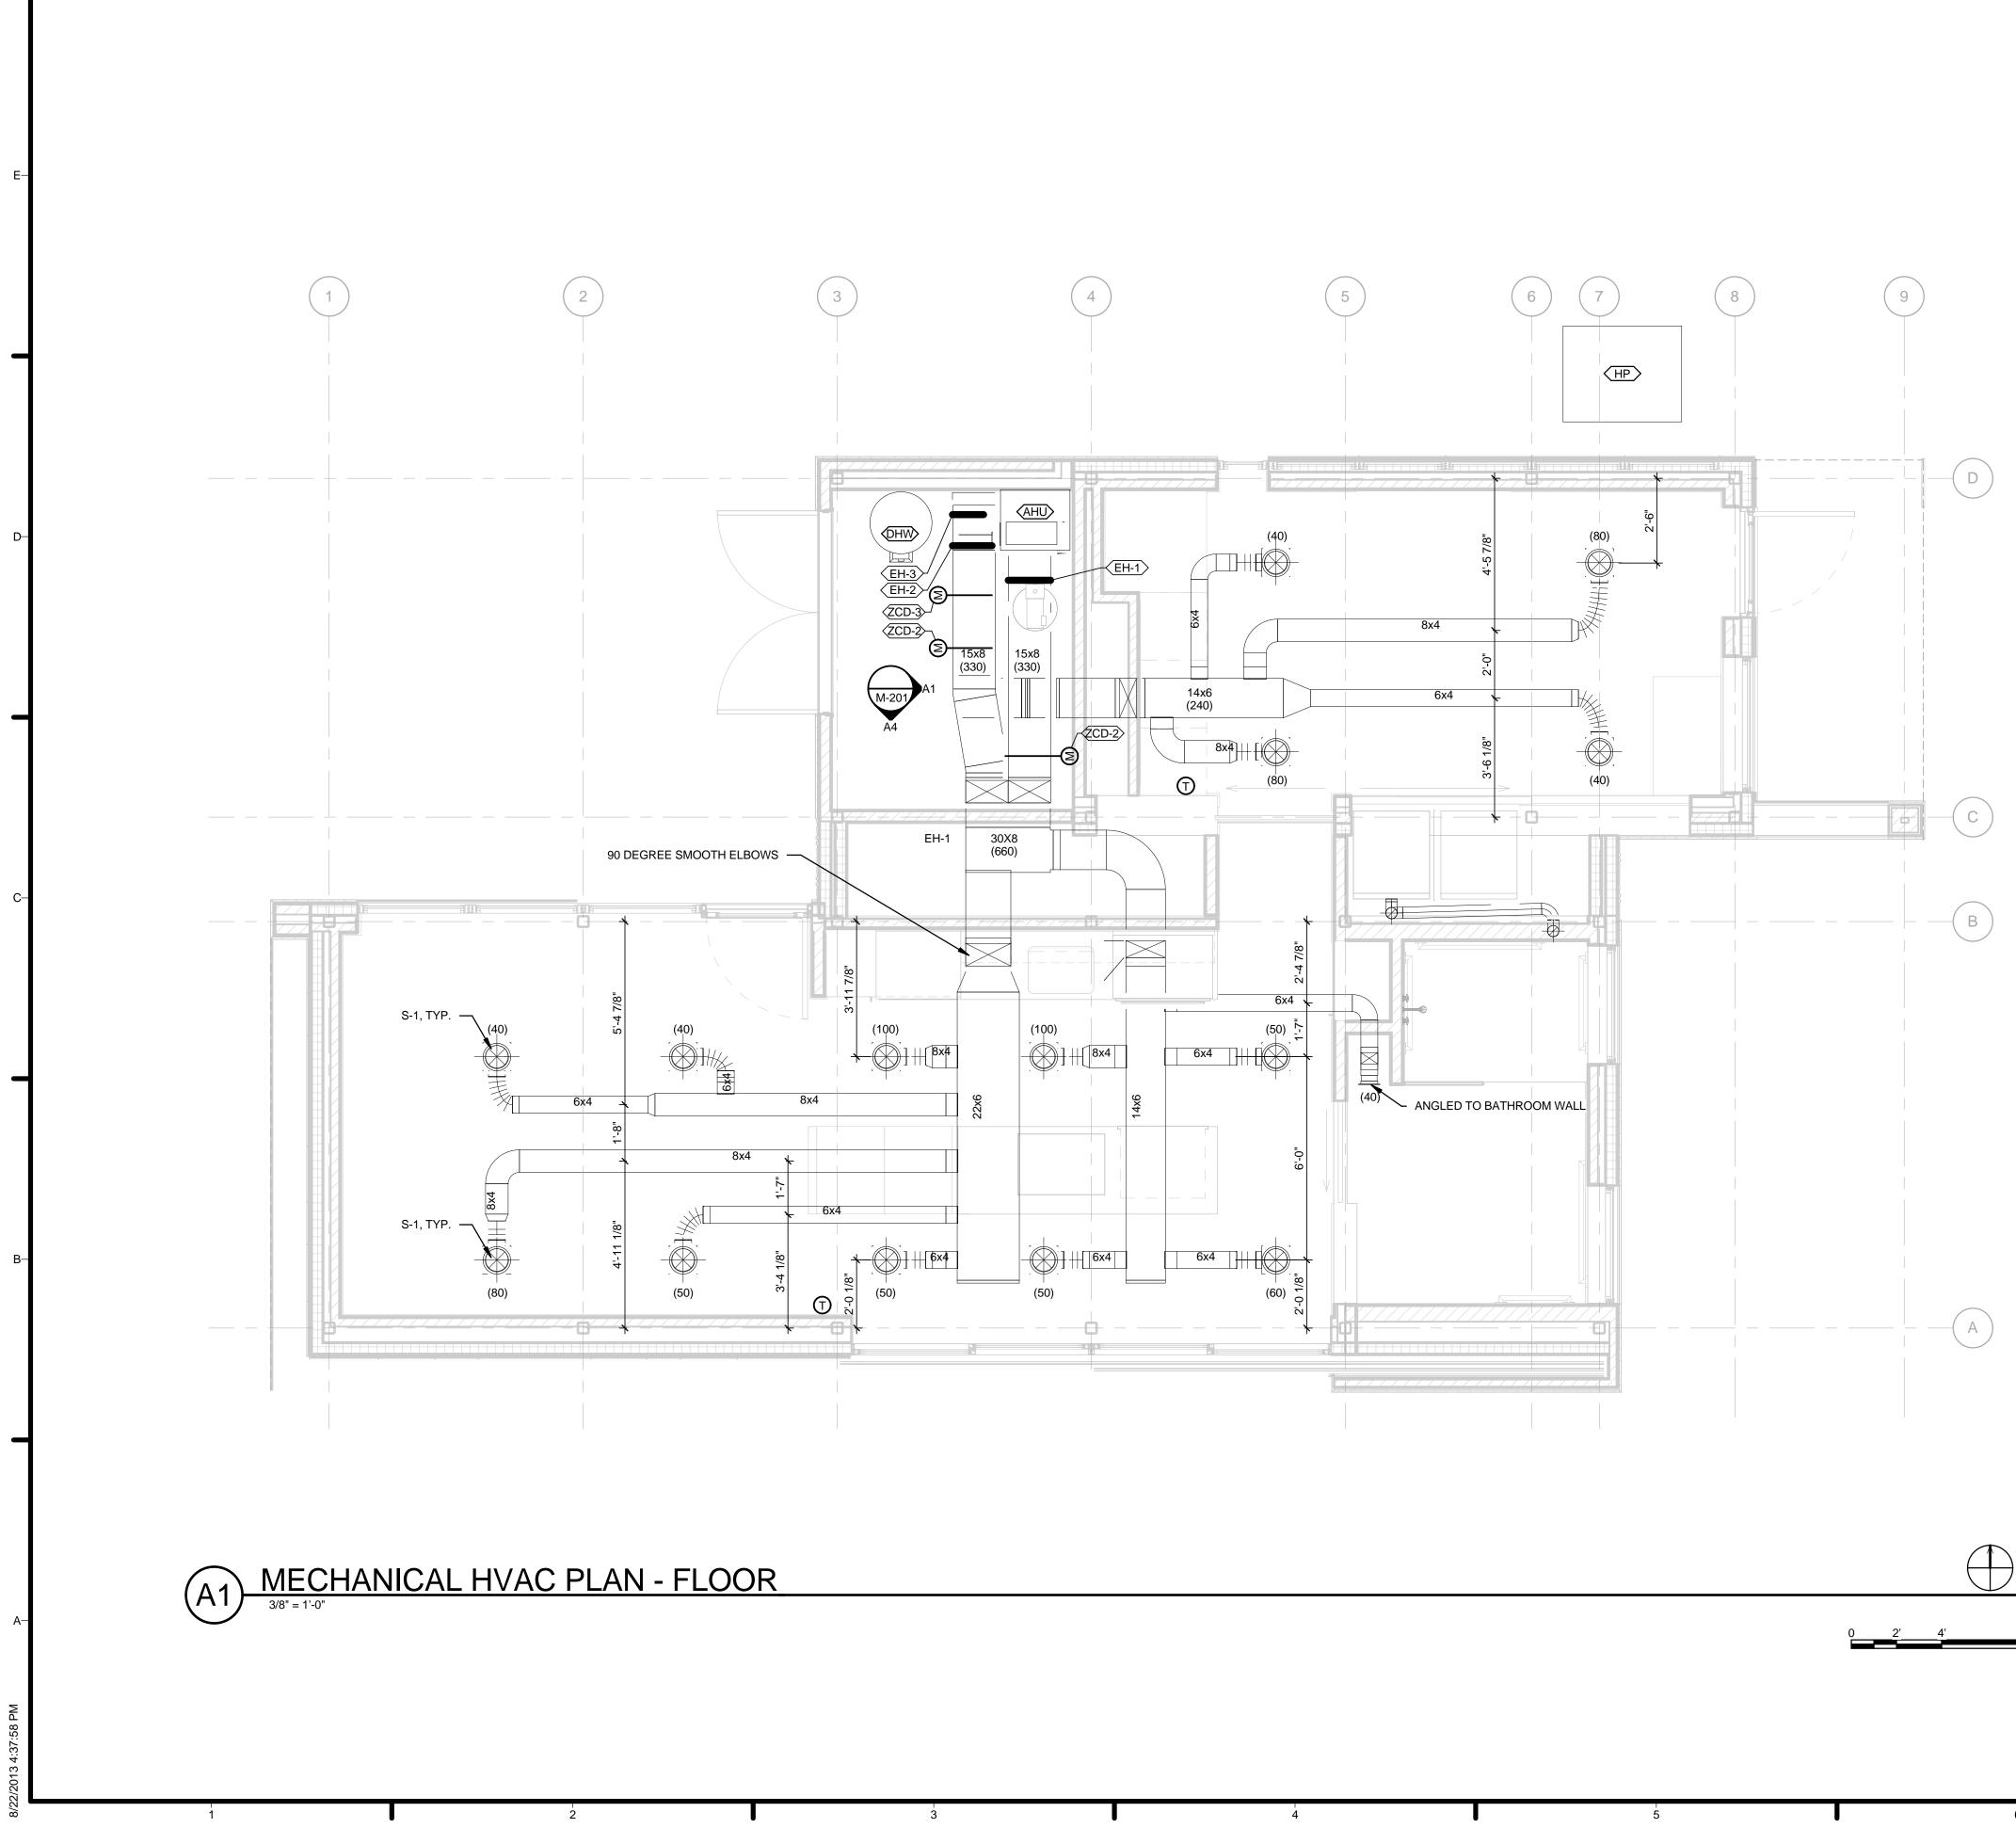
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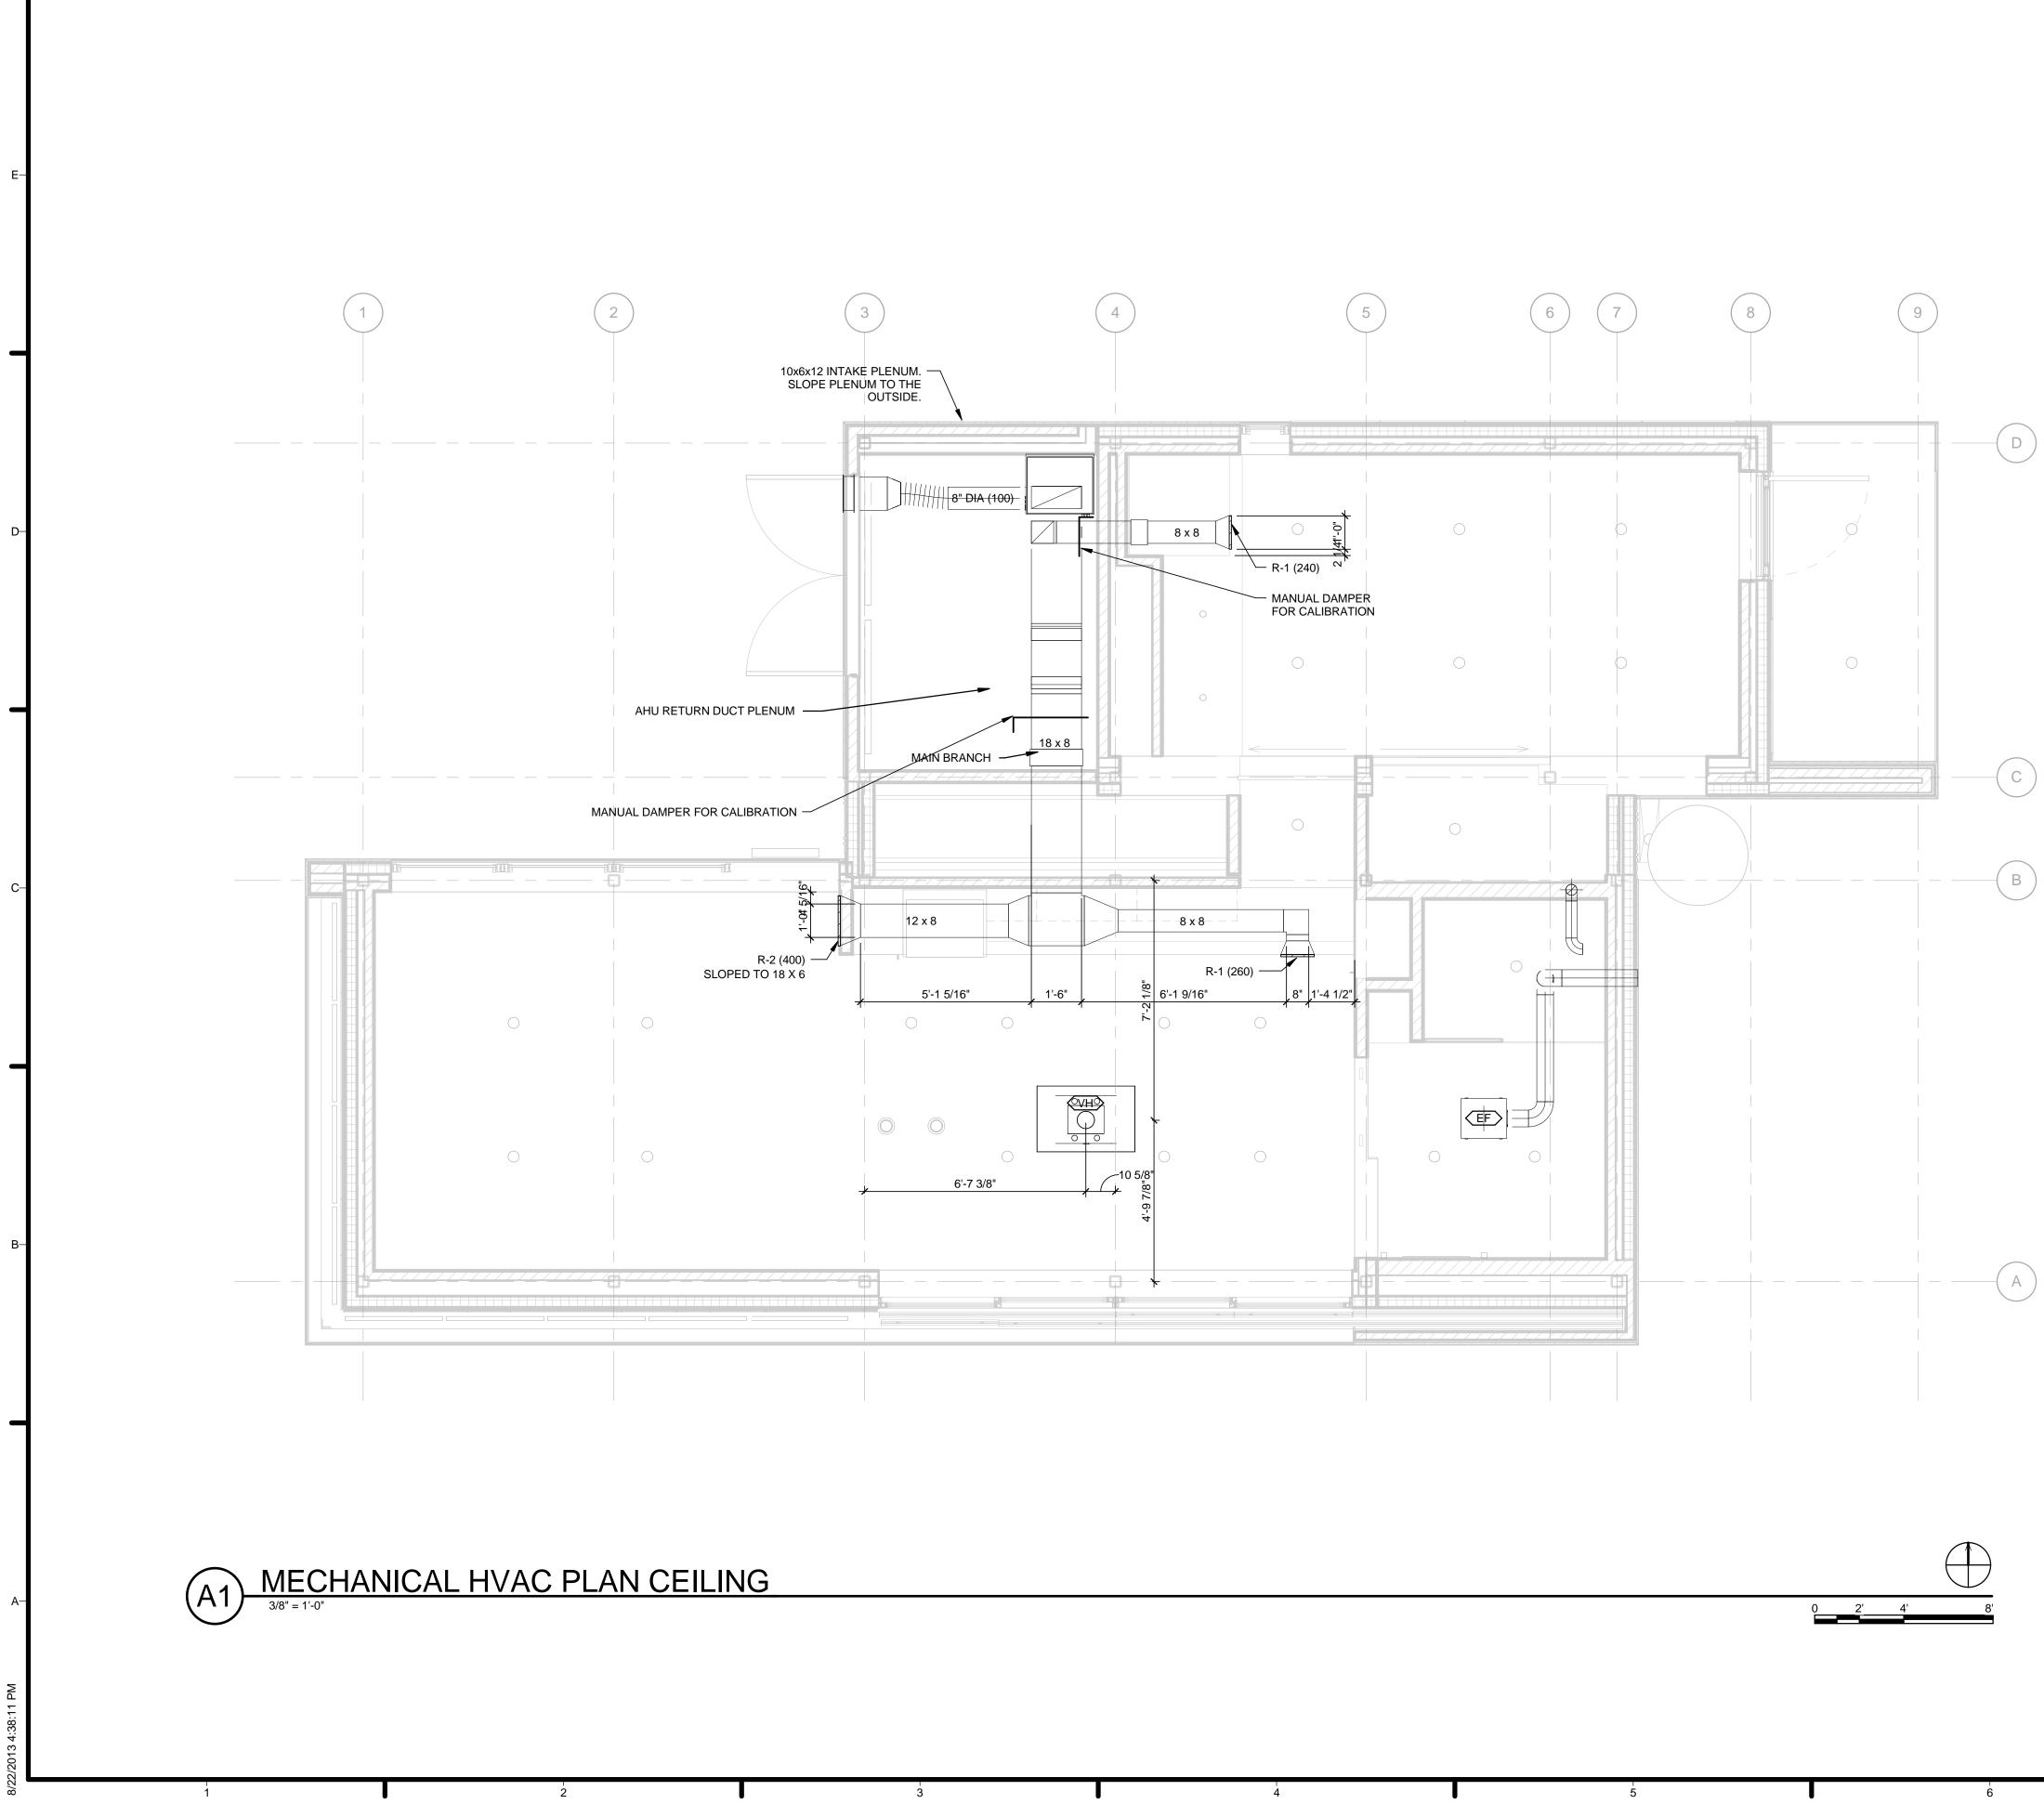
				DIFFUSER SCHEDULE				
ITEM	MANUFACTURER	MODEL	TYPE	OVERALL DIMENSION (INXIN)	MAX S.P. (IN WC)	MAX N.C.	CFM RANGE	NOTES
S-1	NAILOR	ANFD-VAV	VAV FLOOR SWIRL DIFFUSER	9 5/16" OVERALL DIA. 8 1/4" FLOOR OPENING DIA.	0.036	<20	30-120	SUPPLY
S-2	TITUS	250 L2C	GRILL	6 x 4	0.01	20	40	SUPPLY
R-1	TITUS	350R	GRILL	12 x 6	0.073	17	0-290	RETURN
R-2	TITUS	350R	GRILL	18 x 6	0.073	19	300-450	RETURN

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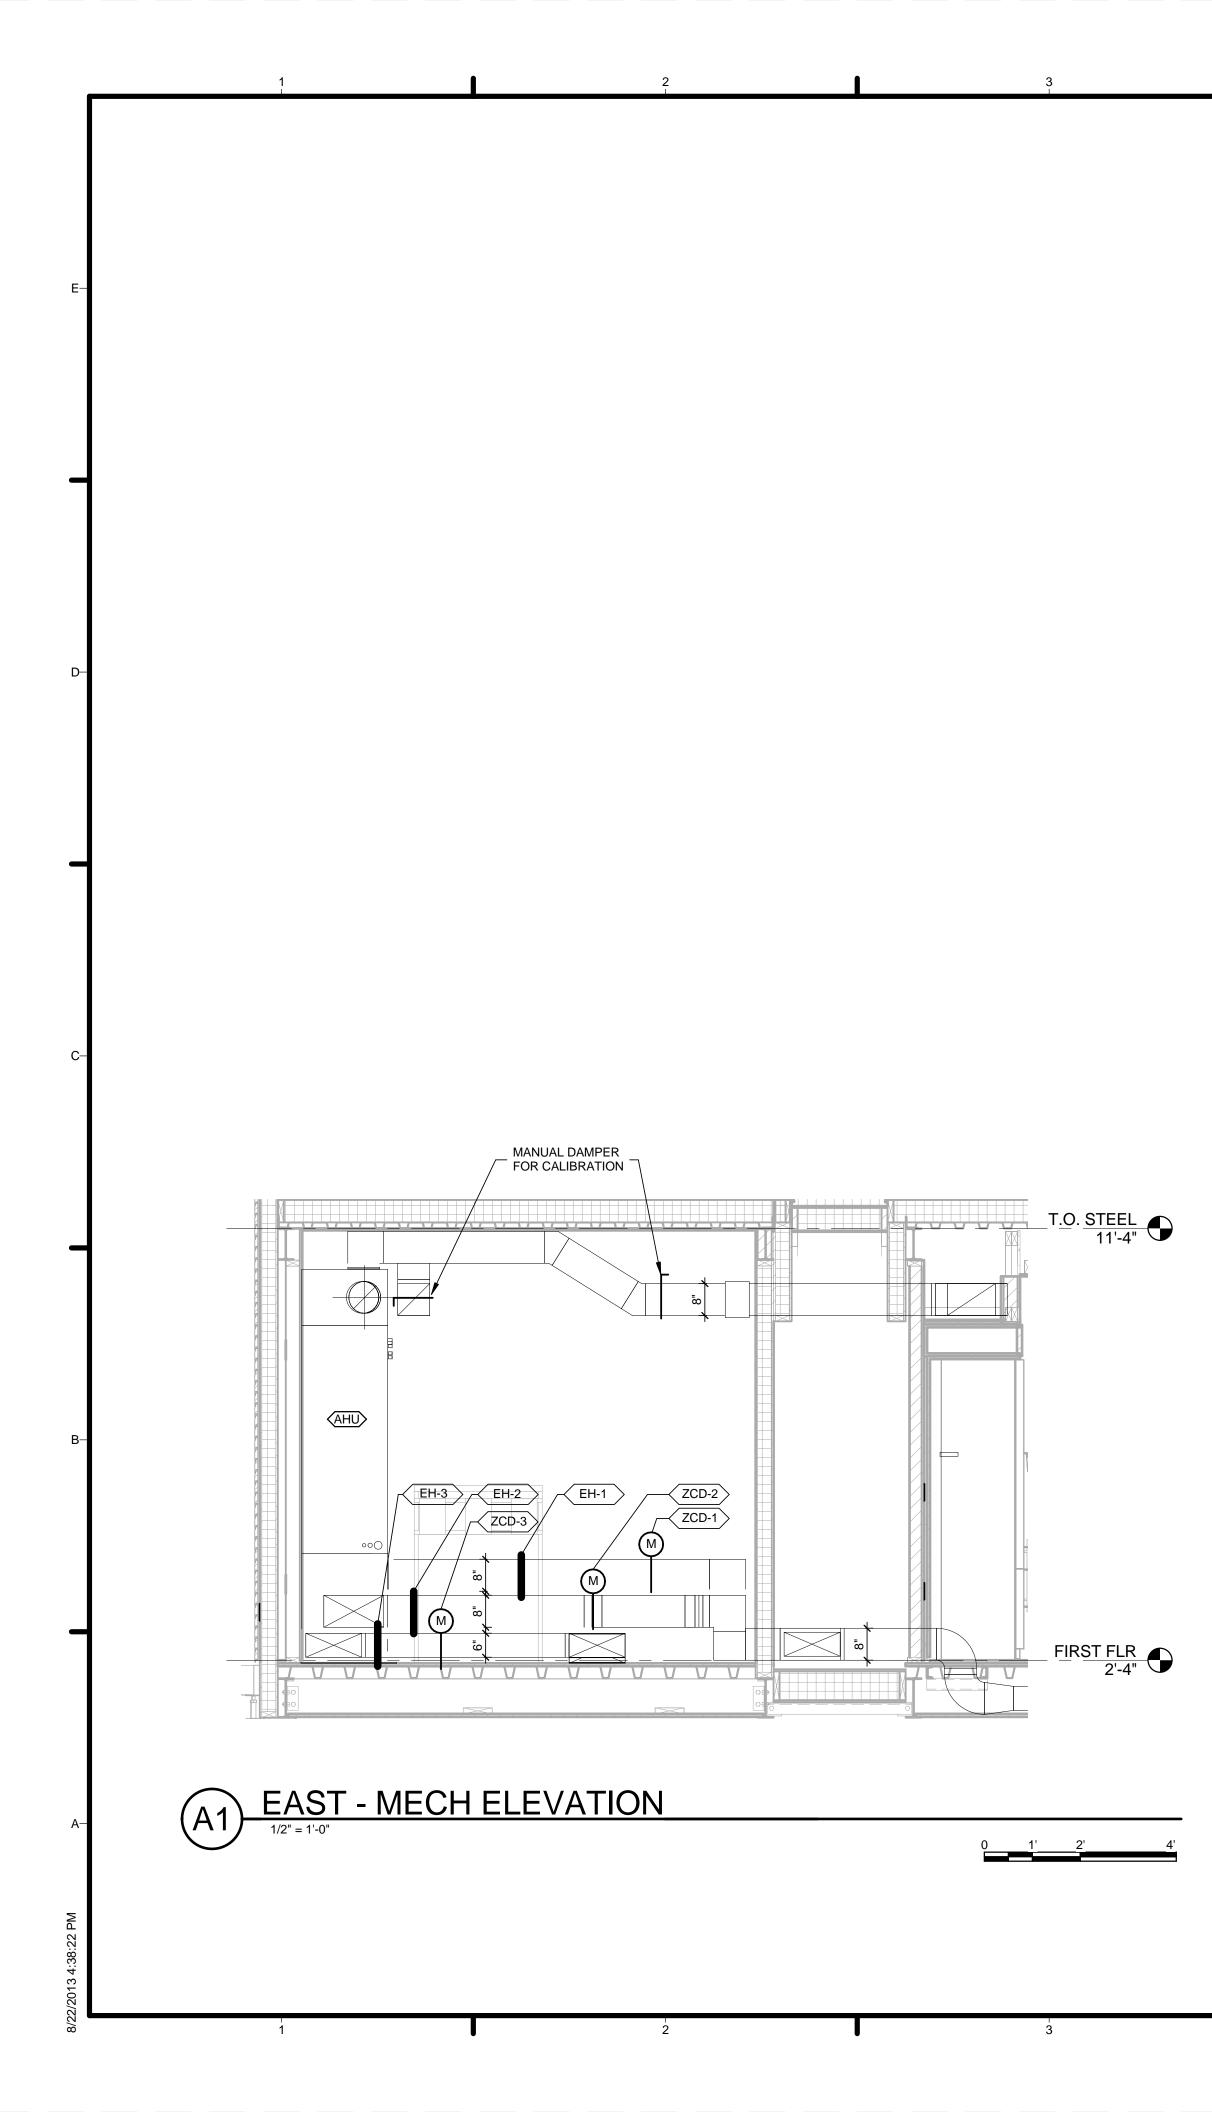


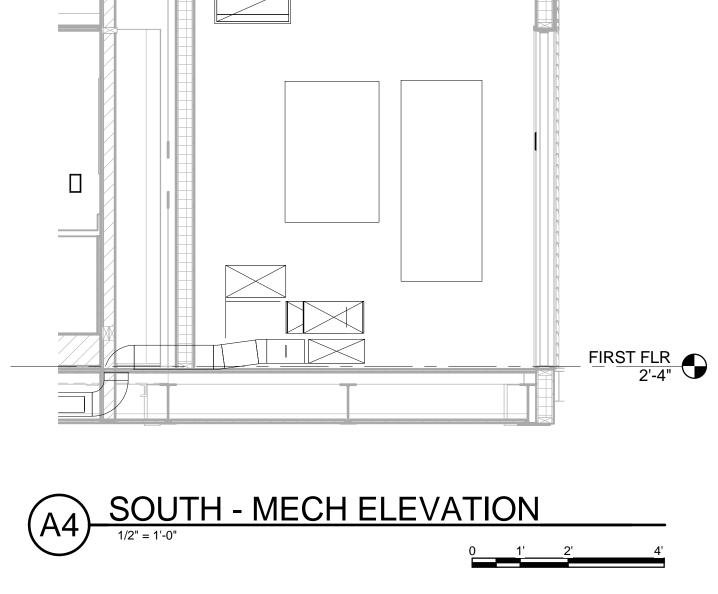


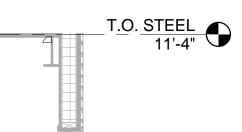
7	
 GENERAL SHEET NOTES 1. CFM TO DIFFUSERS SHALL BE ADJUSTED ATER INSTALLATION. 2. ALL CIRCULAR DIFFUSERS ARE TO BE CONNECTED TO FACTORY MADE DUCT BOXES, A STATED IN SCHEDULE. 	-E HARVEST
REFERENCE KEYNOTES	TEAM NAME: Team Capitol of ADDRESS: THE CATHOLIC UNIVERSITY OF AMERIC SCHOOL OF ARCHITECTUR 620 MICHIGAN AVENUE, N WASHINGTON, DC 2000 STRUCTURAL ENGINEER BOB ALLISON, PE ARUP ENGINEERING 1120 CONNECTICUT AVENUE, NW., SUITE 200 WASHINGTON, DC 20036 TEL: 202.729.8220 MEP ENGINEER ARUP ENGINEERING 1120 CONNECTICUT AVENUE, NW., SUITE 200 WASHINGTON, DC 20036 TEL: 202.729.8220 MEP ENGINEER ARUP ENGINEERING 1120 CONNECTICUT AVENUE, NW., SUITE 200 WASHINGTON, DC 20036 TEL: 202.729.8220 MEP ENGINEER ARUP ENGINEERING 1120 CONNECTICUT AVENUE, NW., SUITE 200 WASHINGTON, DC 20036 TEL: 202.729.8220 ARCHITECT OF RECORD WILLIAM JELEN, AIA 620 MICHIGAN AVE NE CROUGH CENTER
SHEET KEYNOTES 59 90 DEGREE SMOOTH ELBOWS 60 S-1, TYP. 61 4" DIAMETER DRYER EXHAUST DUCT 62 ANGLED TO BATHROOM WALL	C CLIENT U.S. DEPARTMENT OF ENERGY SOLAR DECATHLON.GOV U.S. DEPARTMENT OF ENERGY U.S. DEPARTMENT OF ENERGY SOLAR DECATHLON.GOV
	-B 4 2013.08.22 As-Built Submission 3 2013.02.04 100% CD Submission 2 2012.11.20 80% DD Revisions 1 2012.10.11 80% DD Submission MARK DATE DESCRIPTION LOT NUMBER: 115 DRAWN BY: TEAM CAPITOL DC CHECKED BY: TEAM CAPITOL DC CHECKED BY: TEAM CAPITOL DC COPYRIGHT: NONE: PROJECT IS PUBLIC DOMAIN SHEET TITLE MECHANICAL HVAC PLAN - FLOOR
7	M-101



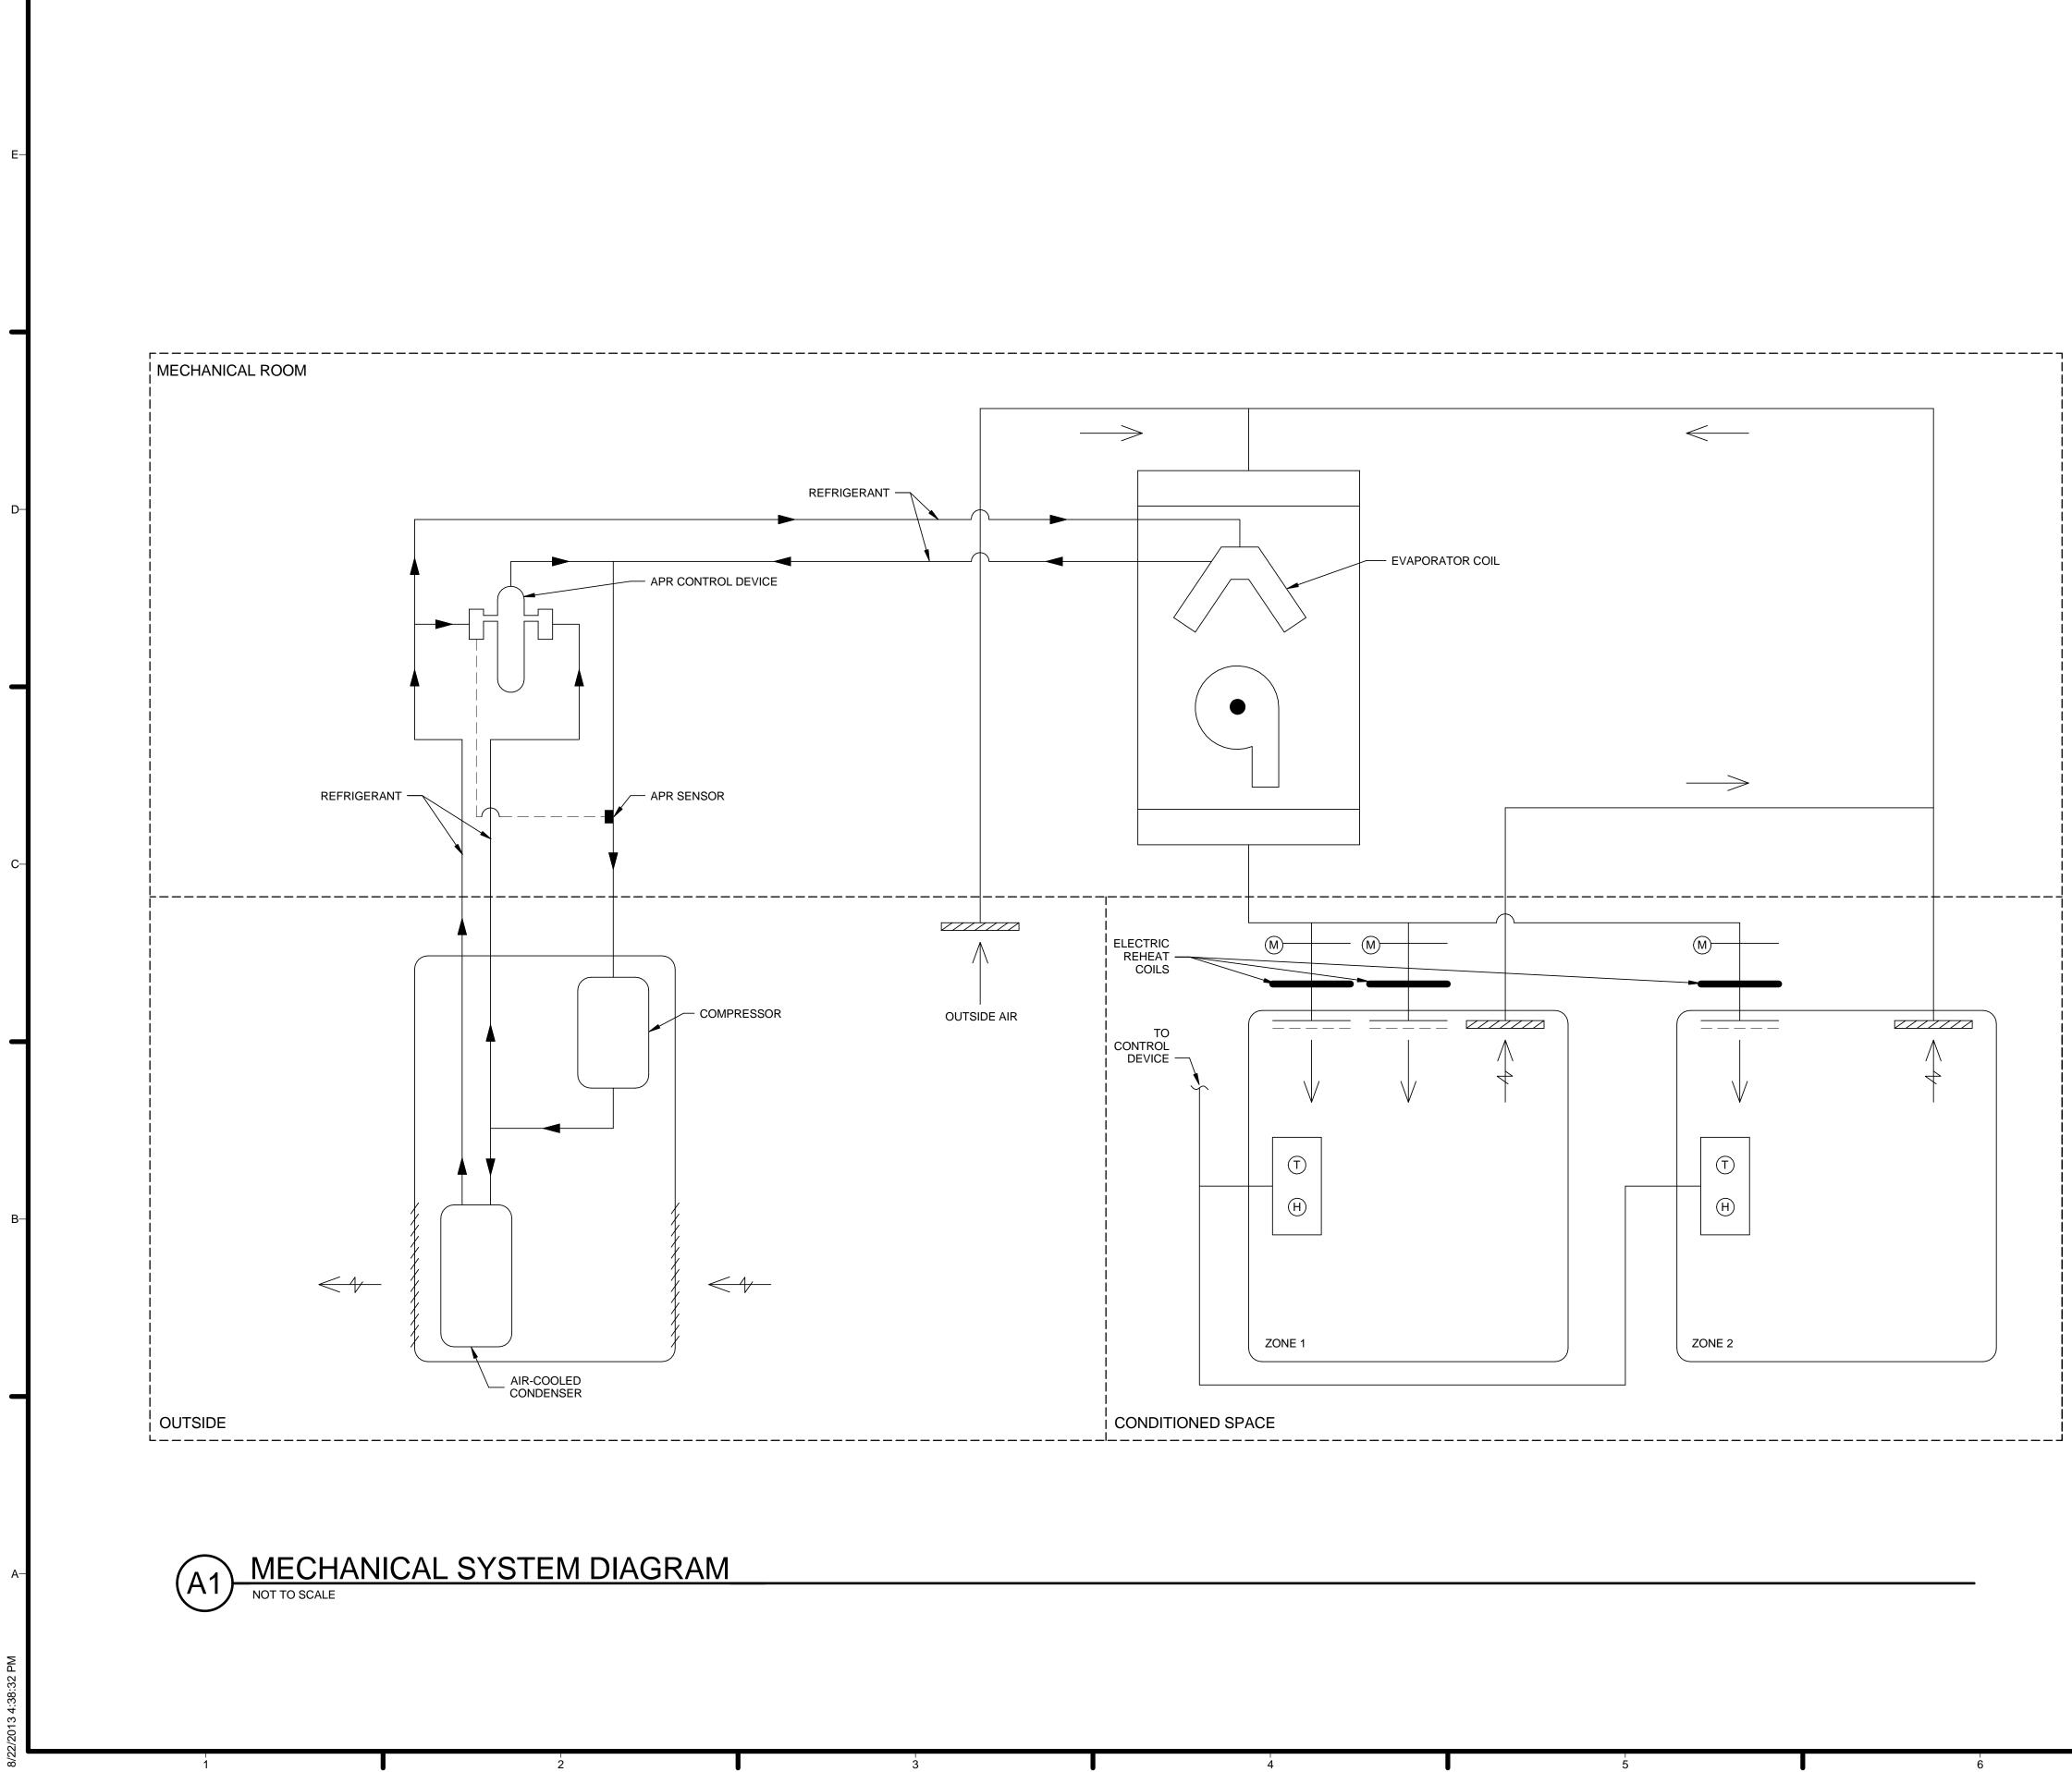
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 1.	ENERAL SHEET NOTES	- -	HARVEST Geodesis
INN OU ⁻	EFERENCE KEYNOTES UER DIAM = 1/2" TER DIAM = 0.83" SULATION = 1"	-D	TEAM NAME:Team Capitol dcADDRESS:THE CATHOLIC UNIVERSITY OF AMERICA SCHOOL OF ARCHITECTURE 620 MICHIGAN AVENUE, NE. WASHINGTON, DC 20064STRUCTURAL ENGINEERBOB ALLISON, PE ARUP ENGINEERING 1120 CONNECTICUT AVENUE, NW., SUITE 200 WASHINGTON, DC 20036 TEL: 202.729.8220MEP ENGINEERARUP ENGINEERING 1120 CONNECTICUT
	SHEET KEYNOTES 63 AHU RETURN DUCT PLENUM 65 MAIN BRANCH 66 SLOPED TO 18 X 6	_C	CLIENT U.S. DEPARTMENT OF ENERGY SOLAR DECATHLON 2013 WWW.SOLARDECATHLON.GOV
		—В	Image: Second system Image: Second system Image: Second
	$\frac{1}{7}$	-A	COPYRIGHT: NONE: PROJECT IS PUBLIC DOMAIN SHEET TITLE MECHANICAL HVAC PLAN - CEILING MO-102







GENERAL SHEET NOTES	TEAM NAME: Team Capitol dc ADDRESS: THE CATHOLIC UNIVERSITY OF AMERICA SCHOOL OF ARCHITECTURE 620 MICHIGAN AVENUE, NE.
REFERENCE KEYNOTES	WASHINGTON, DC 20064 STRUCTURAL ENGINEER BOB ALLISON, PE ARUP ENGINEERING 1120 CONNECTICUT AVENUE, NW., SUITE 200 WASHINGTON, DC 20036 TEL: 202.729.8220 MEP ENGINEER ARUP ENGINEERING 1120 CONNECTICUT AVENUE, NW., SUITE 200 WASHINGTON, DC 20036 TEL: 202.729.8220 MEP ENGINEERR ARUP ENGINEERRING 1120 CONNECTICUT AVENUE, NW., SUITE 200 WASHINGTON, DC 20036 TEL: 202.729.8220 ARCHITECT OF RECORD WILLIAM JELEN, AIA 620 MICHIGAN AVE NE CROUGH CENTER WASHINGTON, DC 20064 TEL: 202.344.5513
SHEET KEYNOTES	C CLIENT U.S. DEPARTMENT OF ENERGY SOLAR DECATHLON 2013 WWW.SOLARDECATHLON.GOV U.S. DEPARTMENT OF ENERGY SOLAR DECATHLON
	-B 4 2013.08.22 As-Built Submission 3 2013.02.04 100% CD Submission 2 2012.11.20 80% DD Revisions 1 2012.10.11 80% DD Submission MARK DATE DESCRIPTION
	LOT NUMBER: 115 DRAWN BY: TEAM CAPITOL DC CHECKED BY: TEAM CAPITOL DC COPYRIGHT: NONE: PROJECT IS PUBLIC DOMAIN SHEET TITLE MECHANICAL ELEVATIONS
	M-201



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GENERAL SHEET NOTES		
1. ALL PIPING SHALL BE 3/4" BETWEEN MECHANICAL EQUIPMENT	-E	HARVEST CAPITOL
		TEAM NAME: Team Capitol dc ADDRESS: THE CATHOLIC UNIVERSITY OF AMERICA SCHOOL OF ARCHITECTURE
		620 MICHIGAN AVENUE, NE. WASHINGTON, DC 20064
REFERENCE KEYNOTES	D	STRUCTURAL ENGINEER BOB ALLISON, PE ARUP ENGINEERING 1120 CONNECTICUT AVENUE, NW., SUITE 200 WASHINGTON, DC 20036 TEL: 202.729.8220 MEP ENGINEER ARUP ENGINEERING 1120 CONNECTICUT AVENUE, NW., SUITE 200 WASHINGTON, DC 20036 TEL: 202.729.8220 ARCHITECT OF RECORD WILLIAM JELEN, AIA 620 MICHIGAN AVE NE CROUGH CENTER WASHINGTON, DC 20064 TEL: 202.344.5513
SHEET KEYNOTES	-c	CLIENT U.S. DEPARTMENT OF ENERGY SOLAR DECATHLON 2013 WWW.SOLARDECATHLON.GOV
		U.S. DEPARTMENT OF ENERGY SOLAR DECATHLON
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		4 2013.08.22 As-Built Submission 3 2013.02.04 100% CD Submission 2 2012.11.20 80% DD Revisions 1 2012.10.11 80% DD Submission MARK DATE DESCRIPTION LOT NUMBER: 115
	—A	DRAWN BY: TEAM CAPITOL DC CHECKED BY: TEAM CAPITOL DC COPYRIGHT: NONE: PROJECT IS PUBLIC DOMAIN SHEET TITLE MECHANICAL SYSTEM DIAGRAM
- 7		M-501

	ABBREVIATIONS
SYMBOL	DESCRIPTION
A, AMP	AMPERE
AC	ALTERNATING CURRENT
AHU	AIR HANDLING UNIT
BMS	BUILDING MANAGEMENT SYSTEM
C, CDT	CONDUIT
СВ	CIRCUIT BREAKER
CP	CONTROL PANEL
СКТ	CIRCUIT
DHW	DOMESTIC HOT WATER
DWG	DRAWING
EF	EXHAUST FAN
EH	ELECTRIC HEAT COIL
ELEC	ELECTRICAL
EP	ELECTRICAL PANEL
G, GND	GROUND
GFCI	GROUND FAULT CIRCUIT INTERRUPTER
JB,J	JUNCTION BOX
LTG	LIGHTING
MER	MECHANICAL EQUIPMENT ROOM
Ν	NEUTRAL
NA, N/A	NOT APPLICABLE
NEMA	NATIONAL ELECTRICAL MANUFACTURERS ASSOCIATION
Р	POLES
PB	PULL BOX
PH,	PHASE
PNL	PANEL
PVC	POLYVINYL CHLORIDE
PWR	POWER
RECPT	RECEPTACLE
SPEC	SPECIFICATIONS
STP	SOLAR THERMAL PUMP
SW	SWITCH
SWBD	SWITCHBOARD
SWGR	SWITCHGEAR
TYP	TYPICAL
UON, U.O.N.	UNLESS OTHERWISE NOTED
V	VOLT
VA	VOLT-AMPERES
VH	VENT HOOD
W	WATT
WBP	
WP	WEATHERPROOF

LIGHTING					
SYMBOL DESCRIPTION					
2,a	CEILING MOUNTED LIGHTING FIXTURE AND OUTLET BOX.				
F 2,a € F	- 'F' DENOTES FIXTURE TYPE - '2' DENOTES BRANCH CIRCUIT NUMBER - 'a' DENOTES SWITCHED CIRCUIT - SHADED AREA FIXTURE ON EMERGENCY CIRCUIT - 'WP' DENOTES WATERPROOF FIXTURE				
F 2 [⊥] a F 2 a	WALL MOUNTED LIGHTING FIXTURE AND OUTLET BOX. - 'F' DENOTES FIXTURE TYPE - '2' DENOTES BRANCH CIRCUIT NUMBER - 'a' DENOTES SWITCHED CIRCUIT - SHADED AREA FIXTURE ON EMERGENCY CIRCUIT - 'WP' DENOTES WATERPROOF FIXTURE				
NOTE: SEE LIGHT FIXTURE SCHEDULE AND SPECIFICATIONS FOR COMPLETE FIXTURE DESCRIPTION.					

VOICE/DATA					
SYMBOL	DESCRIPTION				
К	WALL MOUNTED DATA OUTLET BOX WITH 3/4" EMT STUB UP TO 6" ABOVE HUNG CEILING AND STANDARD OUTLET BOX. BUSHED HOLE COVER-PLATE				
	SINGLE LINE DIAGRAM				
SYMBOL	DESCRIPTION				
PANEL	PANELBOARD, SEE PANEL SCHEDULE FOR RATING				
	FEEDER				
ST 225	ENCLOSED CIRCUIT BREAKER - 'TEXT' DENOTES CB ACCESSORIES - NUMERICAL DENOTES TRIP SIZE				
ST 225	ENCLOSED SAFETY DISCONNECT SWITCH - 'TEXT' DENOTES FUSE ACCESSORIES - NUMERICAL DENOTES SWITCH SIZE				
M	MOTOR				
M	UTILITY METER				
~	INVERTER				

WIRING DEVICES						
SYMBOL	DESCRIPTION					
\$ ^a	20A SPST TOGGLE SWITCH U.O.N.: -LOWER CASE LETTER DENOTES LIGHTING FIXTURE SWITCHING ARRANGEMENT					
\$ ^b \$K4	- '3' DENOTES THREE-WAY - '4' DENOTES FOUR-WAY - 'K' KEY OPERATED					
\$DM	WALL DIMMER SWITCH					
\$WP	WEATHERPROOF SWITCH					
∲a PIR	CEILING MOUNTED VACANCY SENSOR. - 'PIR' DENOTES PASSIVE INFRARED - 'US' DENOTES ULTRASONIC - 'DT' DENOTES DUAL TECHNOLOGY - 'a' DENOTES SWITCHING ARRANGEMENT					
∲b DT	WALL MOUNTED VACANCY SENSOR. - 'PIR' DENOTES PASSIVE INFRARED - 'DT' DENOTES DUAL TECHNOLOGY - 'a' DENOTES SWITCHING ARRANGEMENT					
Ŵ	WALL MOUNTED CABLE OUTLET					
GFI ∯	DUPLEX RECEPTACLE WALL MOUNTED 20A, 125V, 2P, 3W GROUNDING GFI DENOTES GROUND FAULT TYPE					
WP \bigoplus	DUPLEX RECEPTACLE WALL MOUNTED 20A, 125V, 2P, 3W GROUNDING WP DENOTES WEATHERPROOF WHILE IN USE					
Φ	DUPLEX RECEPTACLE CEILING MOUNTED 20A, 125V, 2P, 3W GROUNDING					
\square	DUPLEX RECEPTACLE FLUSH FLOOR MOUNTED 20A, 125V, 2P, 3W GROUNDING					
J	RECESSED CEILING MOUNTED JUNCTION BOX					
J	FLUSH FLOOR MOUNTED JUNCTION BOX					
<u>P</u>	RECESSED WALL MOUNTED JUNCTION BOX					
P	SPECIAL RECEPTACLE WALL MOUNTED NEMA CONFIGURATION AS INDICATED ON PLANS					

SMOKE DETECTOR P - PHOTOELECTRIC I - IONIZATION BR - BEAM RECEIVER ASD - AIR SAMPLING

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SYMBOL 4X F 200

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LIGHTING FIXTURE SCHEDULE

TYPE	DESCRIPTION	WATT	VOLT	LAMP	MOUNT	MANUFACTURER	CATALOG NUMBER
А	OMITTED	-	-	-	-	-	-
В	OMITTED	-	-	-	-	-	-
С	RECESSED LED CAN - 4"	10.5	120	LED	RECESSED	JUNO LIGHTING GROUP	IC1LEDG3-27K
D	RECESSED WET LOCATION LED CAN - 4"	10.5	120	LED	RECESSED	JUNO LIGHTING GROUP	IC1LEDG3-27K
F	OMITTED	-	-	-	-	-	-
G	LED UNDERCABINET LIGHT - 22"	1.0	120	LED	UNDER CABINET/ UNDER SHELF	JUNO LIGHTING GROUP	UPLED22-WH
н	LED UNDERCABINET LIGHT - 9"	3.8	120	LED	UNDER CABINET/ UNDER SHELF	JUNO LIGHTING GROUP	UPLED09-WH
J	CFL WALL SCONCE	24	120	COMPACT FLOURESCENT	WALL	KOHLER	PURIST K-14483-CP
к	EXTERIOR ENTRY SCONCE	25	120	FLUORESCENT	WALL	YLIGHTING	FU018071
L	EXTERIOR LINEAR LED - 35"	18.2	120	LED	WALL	LED LINEAR	XOOLUX SOL W830/900/O/ ENDCAPS + POWER SUPPLY
М	LINEAR FLUORESCENT - 48"	25	120	FLOURESCENT	WALL	JUNO LIGHTING GROUP - DANALITE	F8-48-25-W-RE/ F8-48-25-W-LE
Ν	RECESSED LED CAN - 2 1/4"	4.8	120	LED	RECESSED	JUNO LIGHTING GROUP	MD1L27K-SP-WH
Р	LED PENDANT	5.8	120/12	LED	CEILING	TECH LIGHTING	700-MP-FIRF-CHARTREUSE-CHROME-LED

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120/240, 1-PH	
SERVICE SIZE	

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	ONE BEDROOM UNIT A						
LOAD	SF	VA/SF	PER UNIT	# OF UNITS	TOTAL		<3KVA
LIGHTING	865	3	2.60	1	2.6	7.10	100%
SMALL APPLIANCE			4.50	1	4.50	7.10	3.00
OVEN/RANGE			11.00	1	11.00	11.00	
DISHWASHER			0.79	1	0.79	0.79	
FUTURE DISPOSAL			1.18	1	1.18	1.18	
VENT HOOD (VH)			0.52	1	0.52	0.52	
WATER HEATER (DHW)			4.50	1	4.50	4.50	
FUTURE MICROWAVE			1.50	1	1.50	1.50	
DRYER			5.00	1	5.00	5.00	
WASHER			1.10	1	1.10	1.10	
BATHROOM EXHAUST FAN (EF)			0.05	1	0.05	0.05	
WATER BOOSTER PUMP (WBP)			1.13	1	1.13	1.13	
SOLAR THERMAL PUMP (STP)			0.51	1	0.51	0.51	
HEAT PUMP (HP)			5.43	1	5.43	5.43	
AIR HANDLING UNIT (AHU)			1.13	1	1.13	1.13	
ELECTRIC HEATING COIL (EH-1)			0.50	1	0.50	0.50	
ELECTRIC HEATING COIL (EH-2)			0.50	1	0.50	0.50	
ELECTRIC HEATING COIL (EH-3)			0.50	1	0.50	0.50	

20	PV	DV
-		
 05		

SERVICE EQUIPMENT SHALL BE LISTED AS "SUITABLE FOR USE AS SERVICE EQUIPMENT", IN ACCORDANCE WITH NEC 230.66.

SINGLE-UNIT RESIDENTIAL LOAD CALCULATION SHEET

			ELEC	TRICAL PANEL	SCHEDULE			
PANEL:	SD				VOLTAGE: 120/240			
FED FR	OM:				1 PHASE 3 WIRE + GND			
LOCATI	ON: MECHA	NICAL CLOSET						
BUSAMI	PS = 150A				MIN AIC = 22K AMPS			
Х	МСВ			X	100% RATED NEUTRAL BUS			
	-				-			
Х	-			X	EQUIPMENT GROUND BUS			
	-				-			
#	POLE	TRIP	LOAD DESCRIPTION		LOAD DESCRIPTION	TRIP	POLE	;
1	1	20	BEDROOM RECEPTACLES		LIGHTING	20	1	
3	1	20	LAUNDRY RECEPTACLES		SMOKE AND HEAT DETECTORS	20	1	
5	1	20	RECEPTACLES			20	2	
7	1	20	KITCHEN RECEPTACLES		WATER BOOSTER PUMP (WBP)	-	-	
9	1	20	KITCHEN RECEPTACLES		SOLAR THERMAL PUMP (STP)	20	1	
11	1	20	GFCI BATH		DOMESTIC HOT WATER TANK (DHW)	25	2	
13	1	20	OUTDOOR RECEPTACLES			-	-	
15	1	40	OVEN			30	2	
17	2	50	000//705		HEAT PUMP (HP)	-	-	
19	-	-	COOKTOP				2	2
21	1	20	DISHWASHER		AIR HANDLING UNIT (AHU)	-	-	2
23	1	20	REFRIGERATOR		ELECTRIC HEATING COILS	20	2	2
25	1	20	VENT HOOD (VH)		(EH-1, EH-2, EH-3)	-	-	2
27	1	20	FUTURE DISPOSAL		HOME AUTOMATION SYSTEM	20	1	2
29	2	30			SPARE	15	2	;
31	-	-	DRYER		SPARE		-	;
33	1	20	WASHER		SPARE	20	1	3
35	1	20	SPARE		– PV	15	2	3
37	1	20	GFCI BRAKER		- FV	-	-	3
39	2	20	PV			20	2	2
41	-	-	٣٧		PV		-	4

POWER
DESCRIPTION
FUSED DISCONNECT SWITCH - NUMERICAL DENOTES FUSE SIZE - '4x' DENOTES NEMA ENCLOSURE IF INDICATED
FLEXIBLE CONNECTION
RELAY - NUMERAL DENOTES NUMBER OF POLES
SURFACE MOUNTED POWER PANELBOARD
HOMERUN TO PANELBOARD "LP-3A": - NUMERALS DENOTE CIRCUIT NUMBERS - DESIGNATION DENOTES CIRCUIT NUMBERS, 3#12 + 1#10N-3/4" EMT, U.O.N.
NEW CONDUIT OR EQUIPMENT
CONDUIT TURNING UP
CONDUIT TURNING DOWN
CONDUIT CAPPED
MISCELLANEOUS
DESCRIPTION
FEEDER SIZE, SEE FEEDER SCHEDULE
REFERENCE NOTE

DIGITAL REFERENCE: - DETAIL DESIGNATION - SHEET NUMBER REFERENCE

FIRE ALARM SYMBOLS

BT - BEAM TRANSMITTER

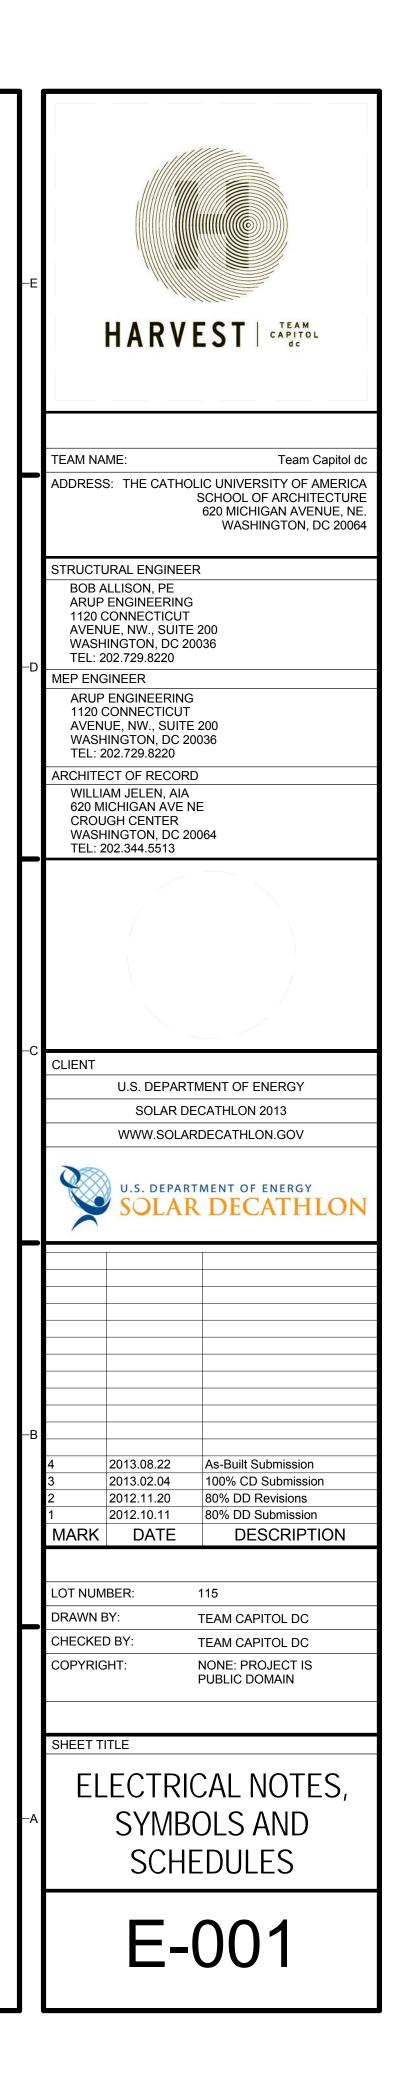
EQUIPMENT REFERENCE. COORDINATE EQUIPMENT

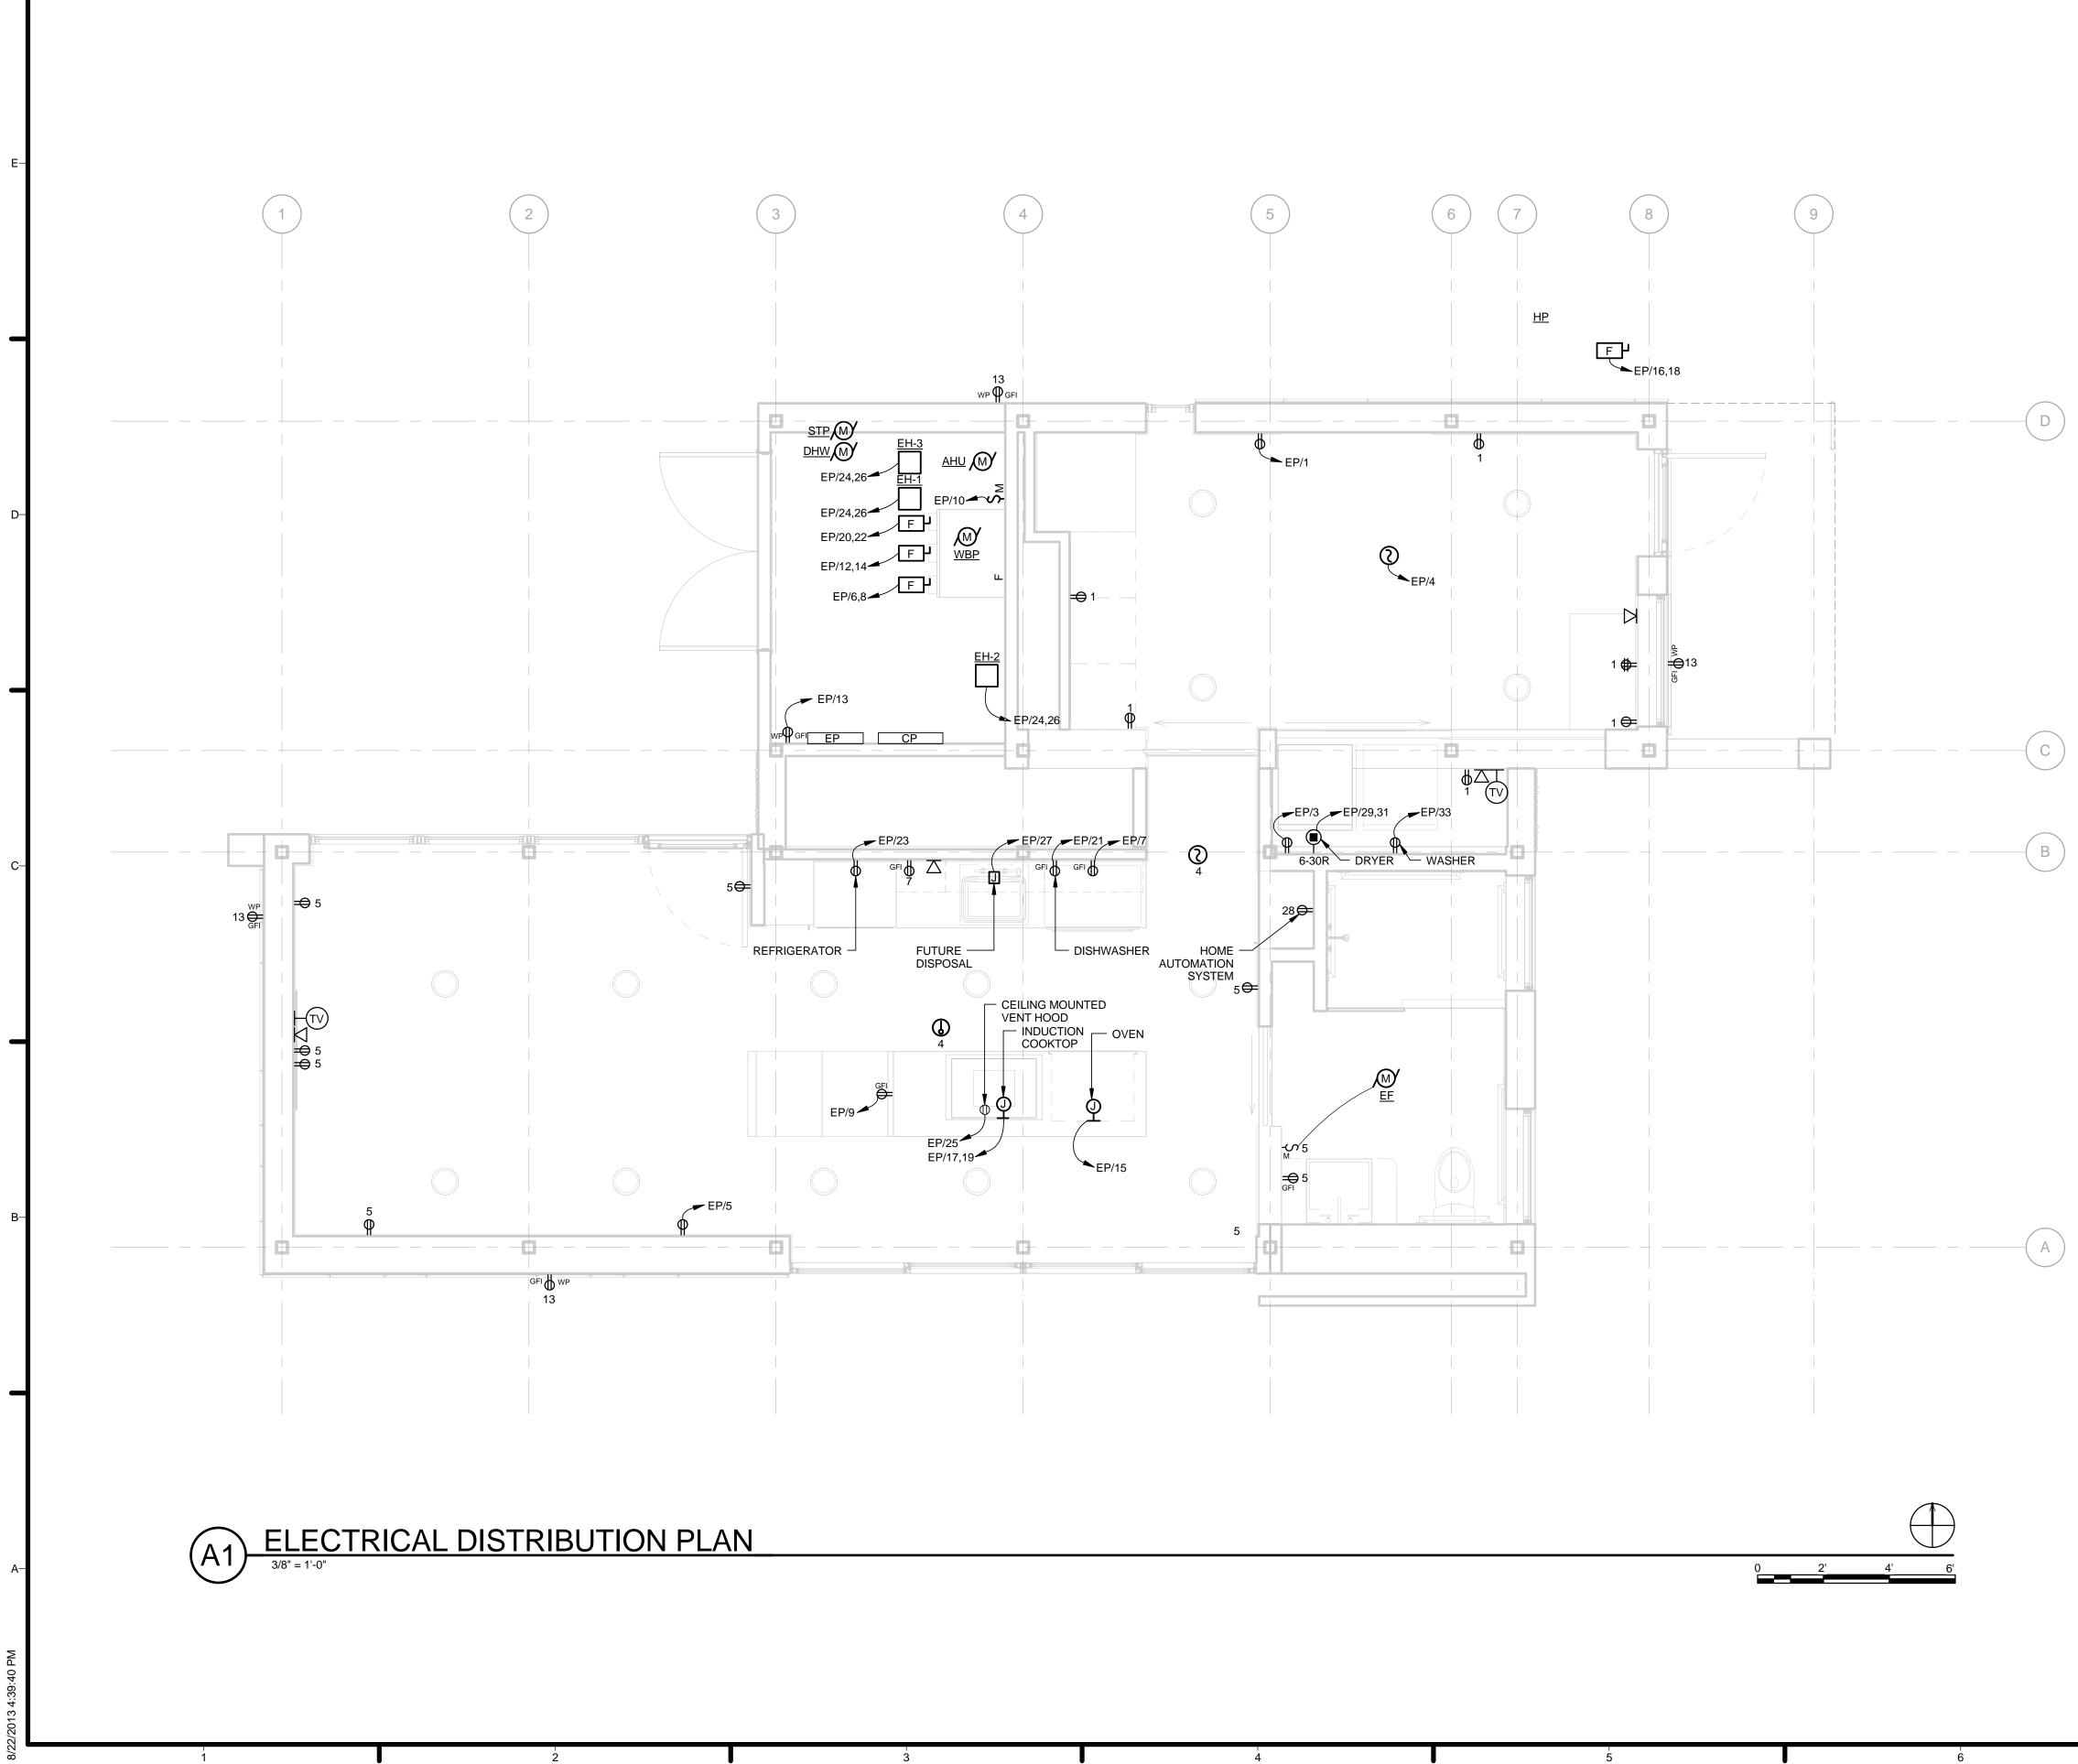
WITH MECHANICAL/PLUMBING TRADES. SEE MECHANICAL/PLUMBING DRAWINGS FOR LOCATIONS.

DESCRIPTION

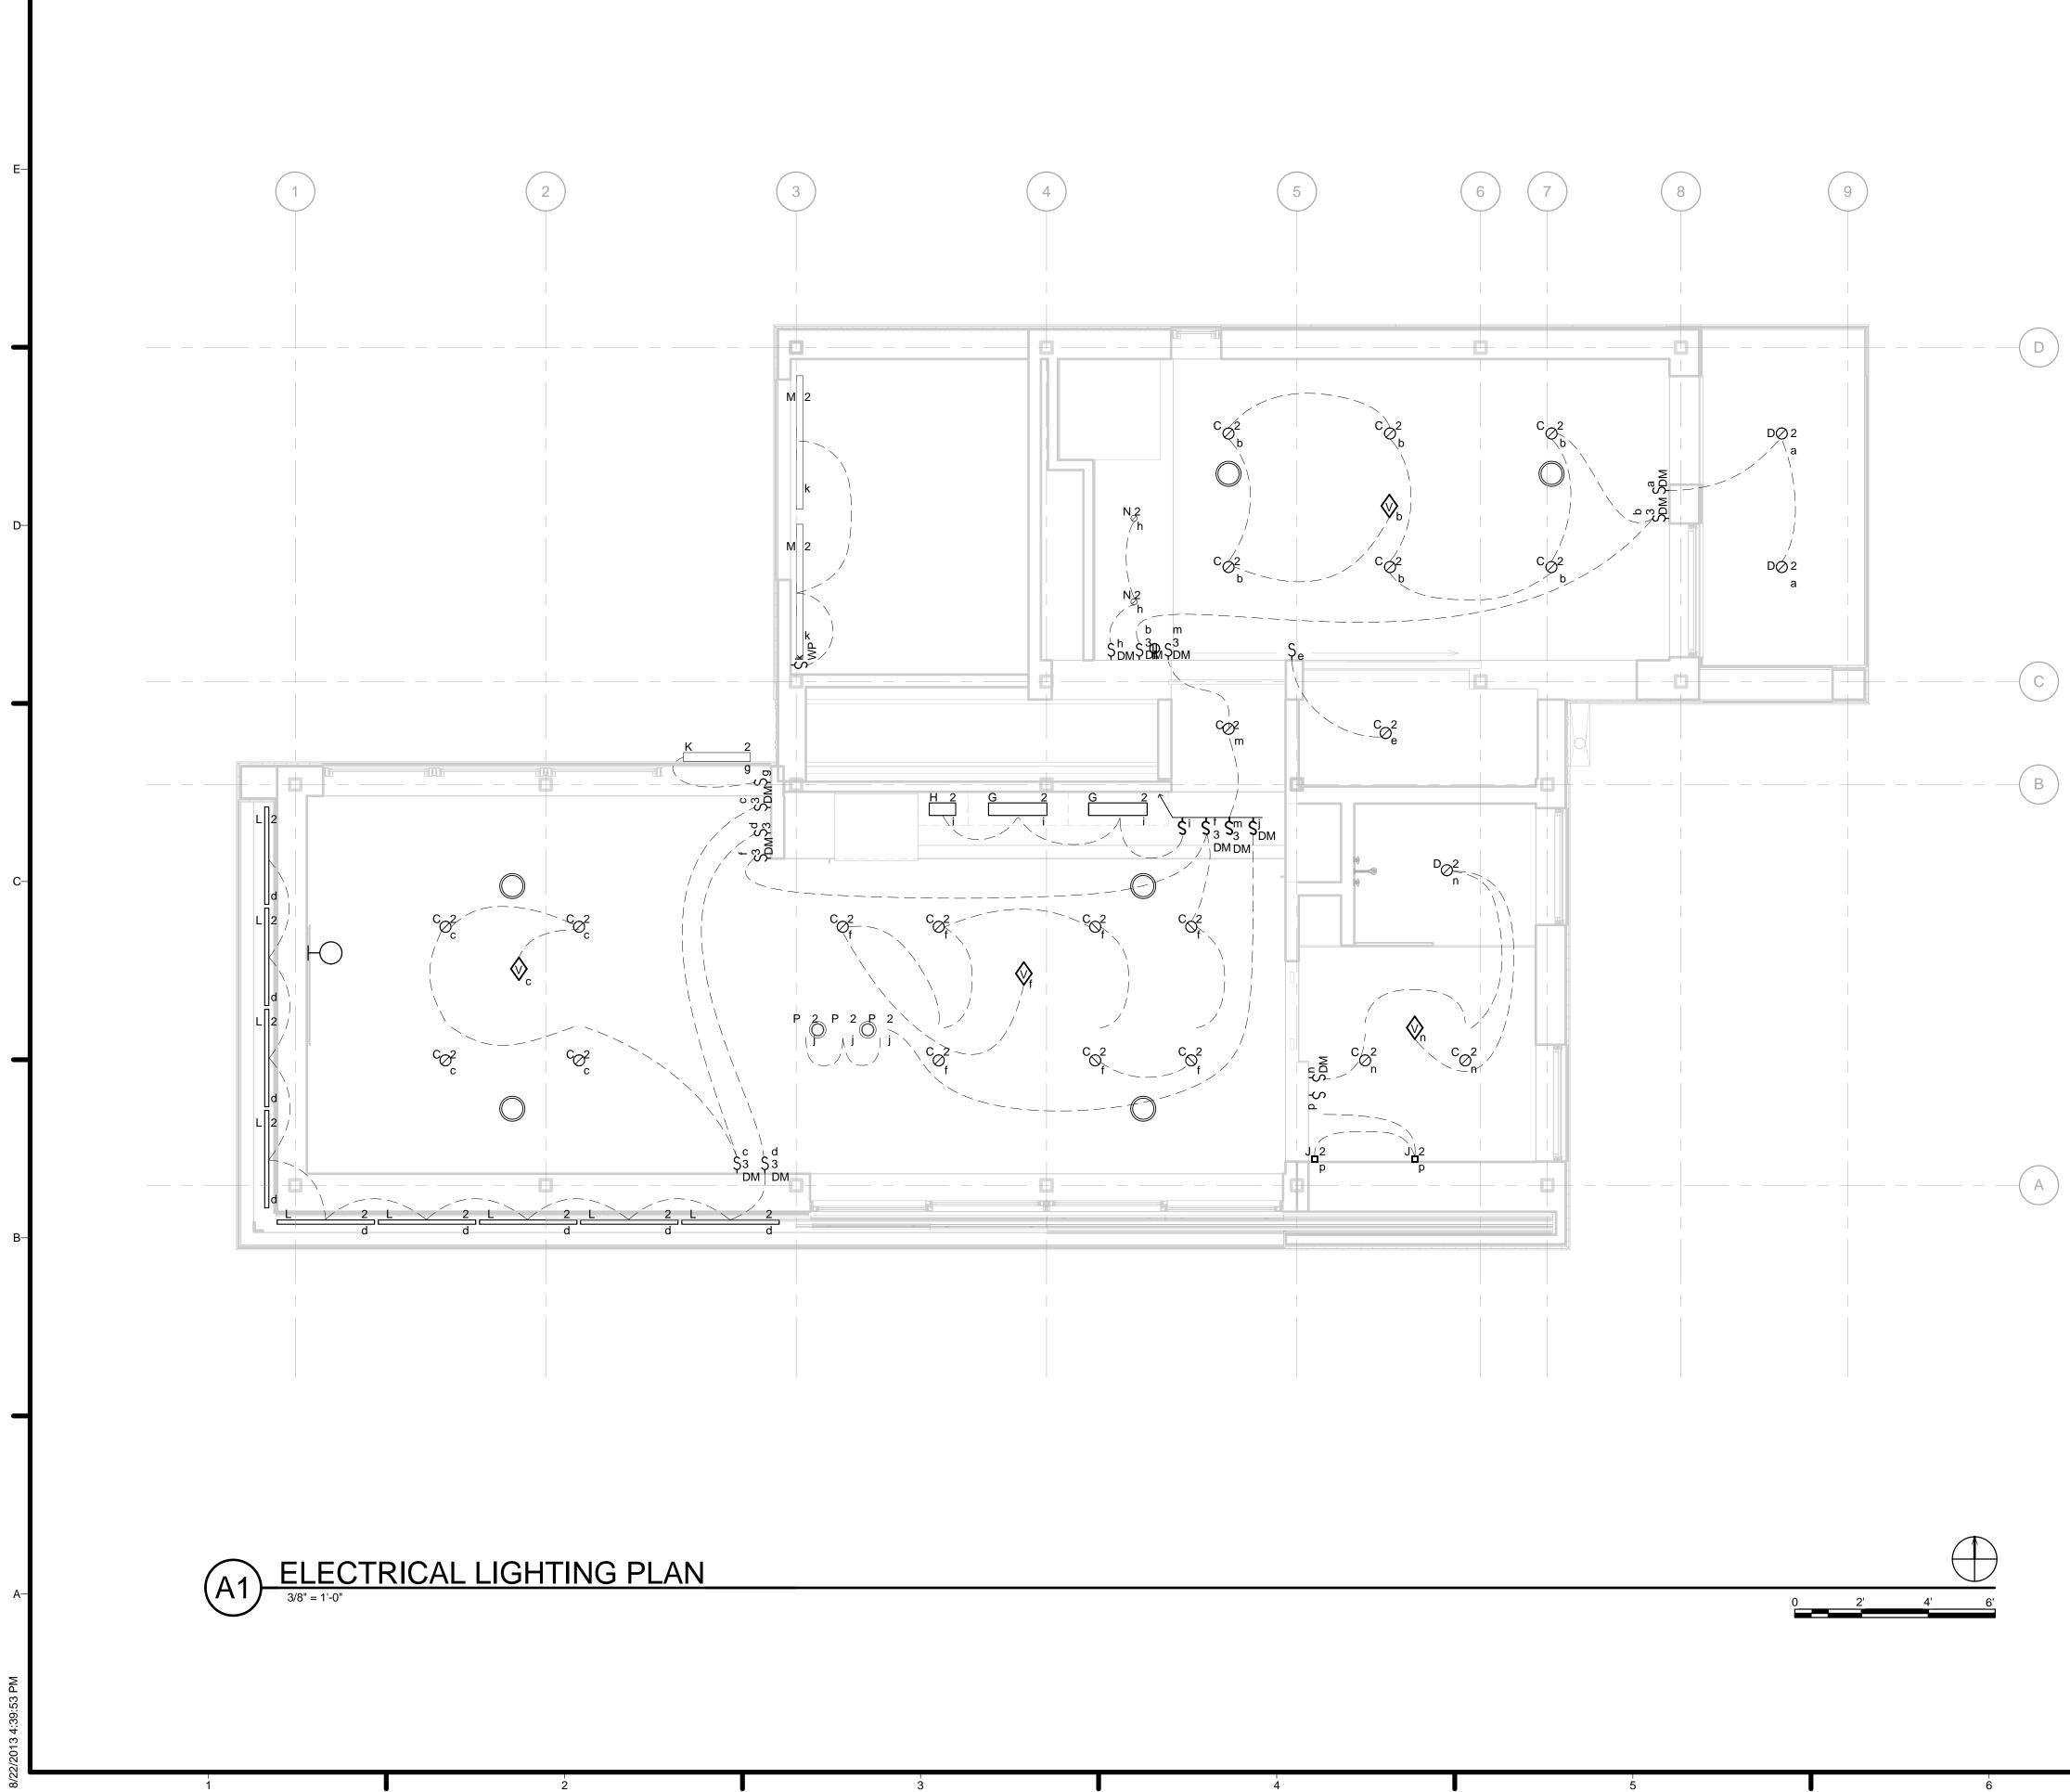
HEAT DETECTOR R/F - RATE OF RISE AND FIXED TEMPERATURE R/C - RATE COMPENSATION F - FIXED TEMPERATURE R - RATE OF RISE ONLY

<x>120</x>	>120	DEMAND			
35%	25%	4.40			
1.43	0.00	- 4.43			
100%		11.00			
75%		0.60			
75%		0.89			
75%		0.39			
75%		3.38			
75%		1.13			
75% 75%		3.75			
		0.83			
75%		0.04			
75%		0.85			
75% 100% 100% 100% 100%		0.38			
		5.43			
		100%		1.13	
		0.50			
		0.50			
		0.50			
		35.71	KVA		
		148.79	AMPS		
		150	AMPS		

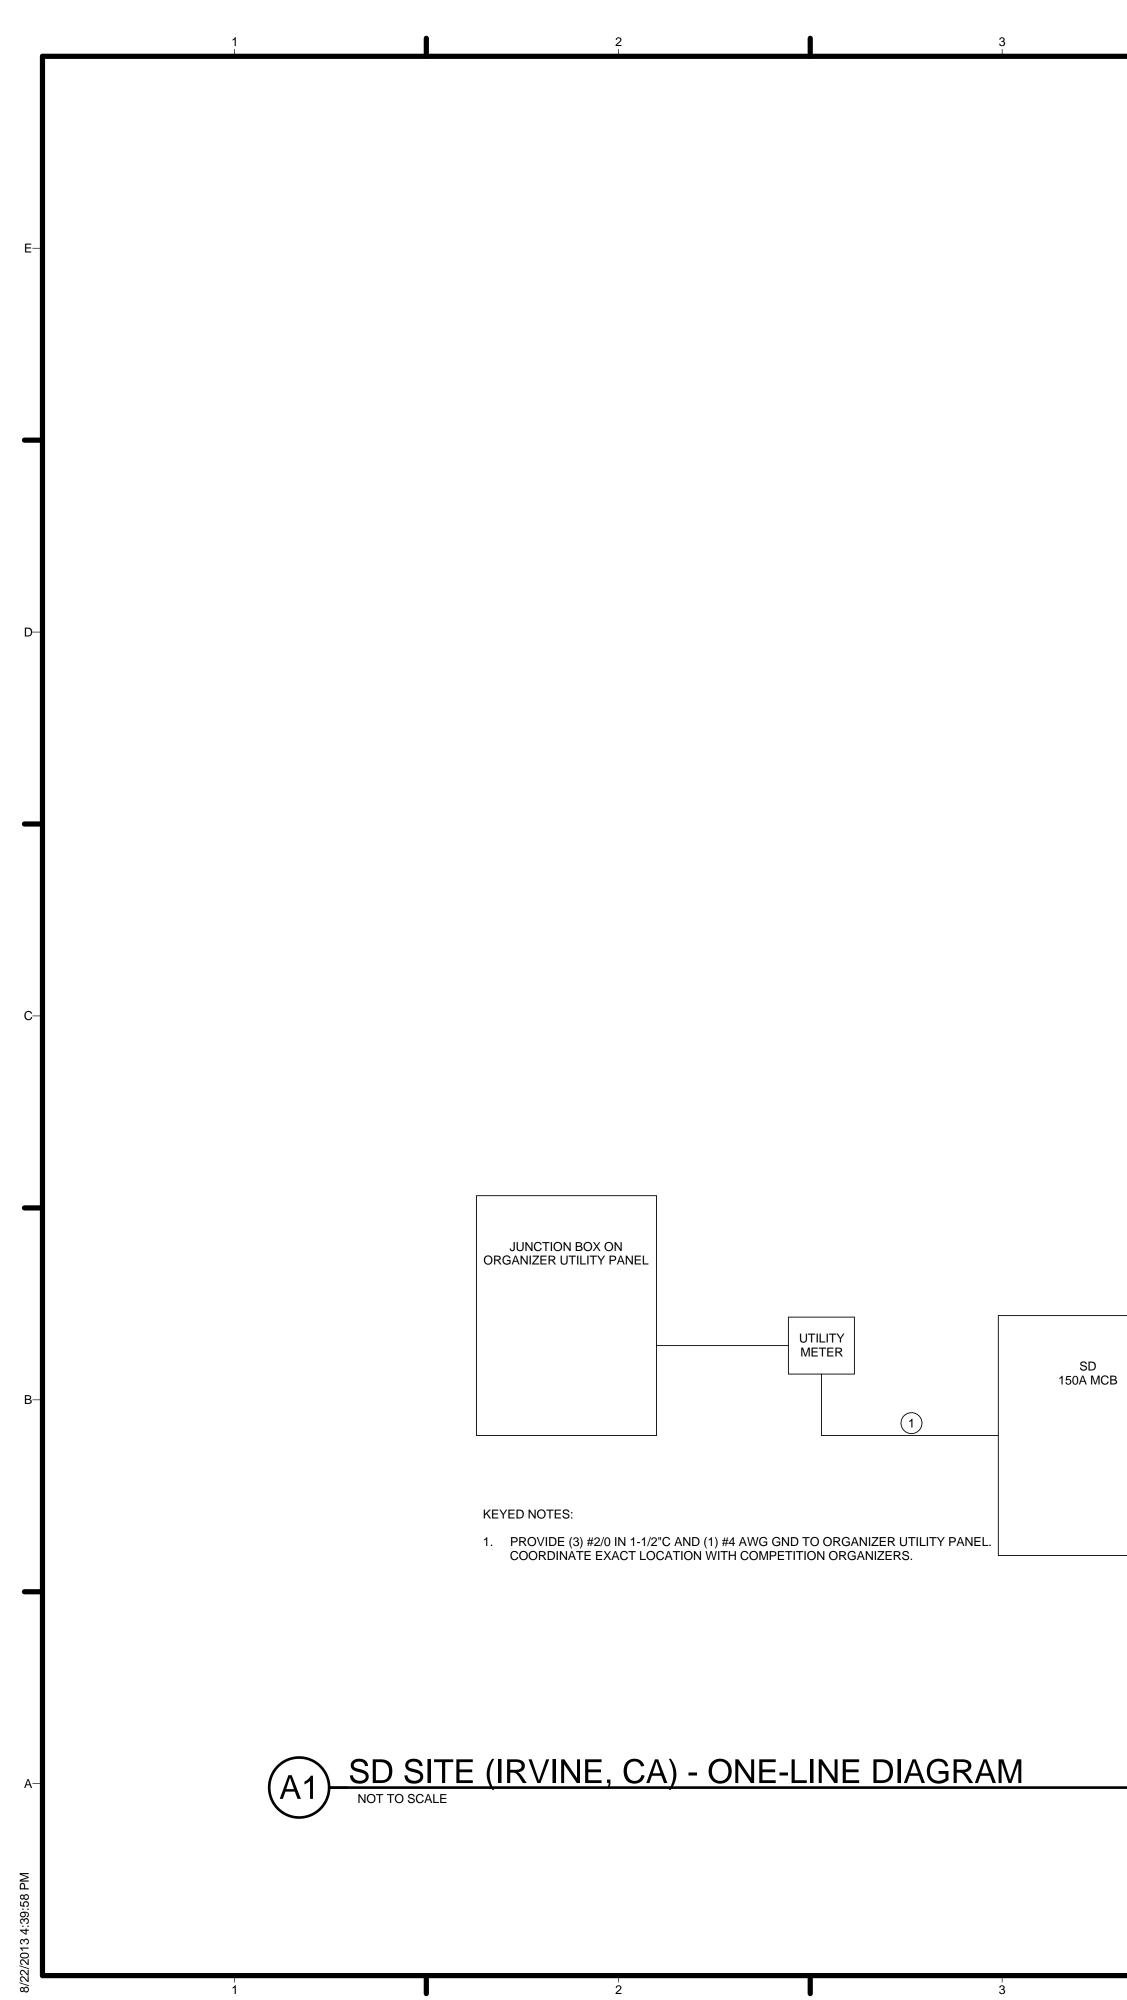




GENERAL SHEET NOTES		
1. SMOKE DETECTORS HARDWIRED FOR BATTERY BACK-UP		
2. AFCI PROTECTION SHALL BE PROVIDED FOR ALL 120V, 15A AND 20A CIRCUITS SUPPLYING THE FOLLOWING AREAS: FAMILY ROOMS, DINING ROOMS, LIVING ROOMS, PARLORS, LIBRARIES, DENS, BEDROOMS, SUNROOMS, RECREATION ROOMS, CLOSETS, HALLWAYS, OR SIMILAR ROOMS OR AREAS (NEC 210.12(A)).	E	
3. ALL NON-LOCKING TYPE 125V, 15A OR 20A RECEPTACLES SHALL BE LISTED "TAMPER RESISTANT" (NEC 406.12)., SUNROOMS, RECREATION ROOMS, CLOSETS, HALLWAYS, OR SIMILAR ROOMS OR AREAS (NEC 210.12(A)).	_	HARVEST
4. ALL 15A, AND 20A, 125V OR 250V RECEPTACLES IN WET LOCATIONS SHALL HAVE AN ENCLOSURE THAT IS WEATHERPROOF WHILE IN USE.		
		TEAM NAME: Team Capitol dc ADDRESS: THE CATHOLIC UNIVERSITY OF AMERICA SCHOOL OF ARCHITECTURE 620 MICHIGAN AVENUE, NE. WASHINGTON, DC 20064
REFERENCE KEYNOTES		STRUCTURAL ENGINEER BOB ALLISON, PE
	-D	ARUP ENGINEERING 1120 CONNECTICUT AVENUE, NW., SUITE 200 WASHINGTON, DC 20036 TEL: 202.729.8220 MEP ENGINEER
		ARUP ENGINEERING 1120 CONNECTICUT AVENUE, NW., SUITE 200 WASHINGTON, DC 20036 TEL: 202.729.8220
		ARCHITECT OF RECORD WILLIAM JELEN, AIA 620 MICHIGAN AVE NE CROUGH CENTER WASHINGTON, DC 20064 TEL: 202.344.5513
	–C	CLIENT U.S. DEPARTMENT OF ENERGY
SHEET KEYNOTES		SOLAR DECATHLON 2013 WWW.SOLARDECATHLON.GOV
		U.S. DEPARTMENT OF ENERGY SOLAR DECATHLON
	—В	4 2013.08.22 As-Built Submission 3 2013.02.04 100% CD Submission 2 2012.11.20 80% DD Revisions 1 2012.10.11 80% DD Submission MARK DATE DESCRIPTION
		LOT NUMBER: 115 DRAWN BY: TEAM CAPITOL DC
		CHECKED BY: TEAM CAPITOL DC COPYRIGHT: NONE: PROJECT IS PUBLIC DOMAIN
		SHEET TITLE
	—A	ELECTRICAL DISTRIBUTION PLAN
		E-101



7		E-102
	—В —А	ELECTRICAL LIGHTING PLAN
		LOT NUMBER: 115 DRAWN BY: TEAM CAPITOL DC CHECKED BY: TEAM CAPITOL DC COPYRIGHT: NONE: PROJECT IS PUBLIC DOMAIN
		4 2013.08.22 As-Built Submission 3 2013.02.04 100% CD Submission 2 2012.11.20 80% DD Revisions 1 2012.10.11 80% DD Submission MARK DATE DESCRIPTION
SHEET KEYNOTES		U.S. DEPARTMENT OF ENERGY SOLAR DECATHLON 2013 WWW.SOLARDECATHLON.GOV
	–C	CLIENT
		WILLIAM JELEN, AIA 620 MICHIGAN AVE NE CROUGH CENTER WASHINGTON, DC 20064 TEL: 202.344.5513
	-D	TEL: 202.729.8220 MEP ENGINEER ARUP ENGINEERING 1120 CONNECTICUT AVENUE, NW., SUITE 200 WASHINGTON, DC 20036 TEL: 202.729.8220 ARCHITECT OF RECORD
REFERENCE KEYNOTES		STRUCTURAL ENGINEER BOB ALLISON, PE ARUP ENGINEERING 1120 CONNECTICUT AVENUE, NW., SUITE 200 WASHINGTON, DC 20036
	┡	TEAM NAME: Team Capitol dc ADDRESS: THE CATHOLIC UNIVERSITY OF AMERICA SCHOOL OF ARCHITECTURE 620 MICHIGAN AVENUE, NE. WASHINGTON, DC 20064
	-Ε	HARVEST
1. SEE SHEET A-121 FOR LIGHTING PLACEMENT DIMENSIONS.		
GENERAL SHEET NOTES		

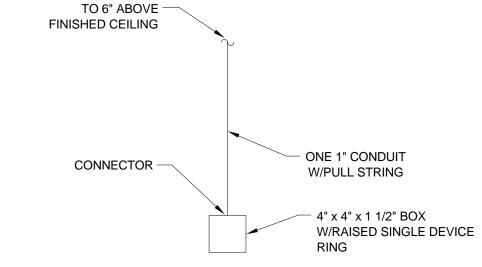


(A5) TYPICAL TELECOMMUNICATIONS DETAIL NOT TO SCALE

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NOTES: 1. TYPICAL FOR ALL WALL TELECOMMUNICATIONS OUTLETS I.E., DATA, VOICE, TELEPHONE, COMBINATION OUTLETS, ETC.

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ARUP ENGINEERING 1120 CONNECTICUT AVENUE, NW., SUITE 200 WASHINGTON, DC 20036 TEL: 202.729.8220 MEP ENGINEER ARUP ENGINEERING 1120 CONNECTICUT AVENUE, NW., SUITE 200 WASHINGTON, DC 20036 TEL: 202.729.8220 ARCHITECT OF RECORD WILLIAM JELEN, AIA 620 MICHIGAN AVE NE CROUGH CENTER WASHINGTON, DC 20064 TEL: 202.344.5513 CLIENT U.S. DEPARTMENT OF ENERGY SOLAR DECATHLON 2013 WWW.SOLARDECATHLON.GOV U.S. DEPARTMENT OF ENERGY SOLAR DECATHLON 2013.08.22 As-Built Submission 2013.02.04 100% CD Submission 80% DD Revisions 2012.11.20 2012.10.11 80% DD Submission DESCRIPTION MARK DATE LOT NUMBER: 115 DRAWN BY: TEAM CAPITOL DC CHECKED BY: TEAM CAPITOL DC NONE: PROJECT IS PUBLIC DOMAIN COPYRIGHT: SHEET TITLE DETAILS AND ONE-LINE DIAGRAM

E-601

HARVEST | CAPITOL

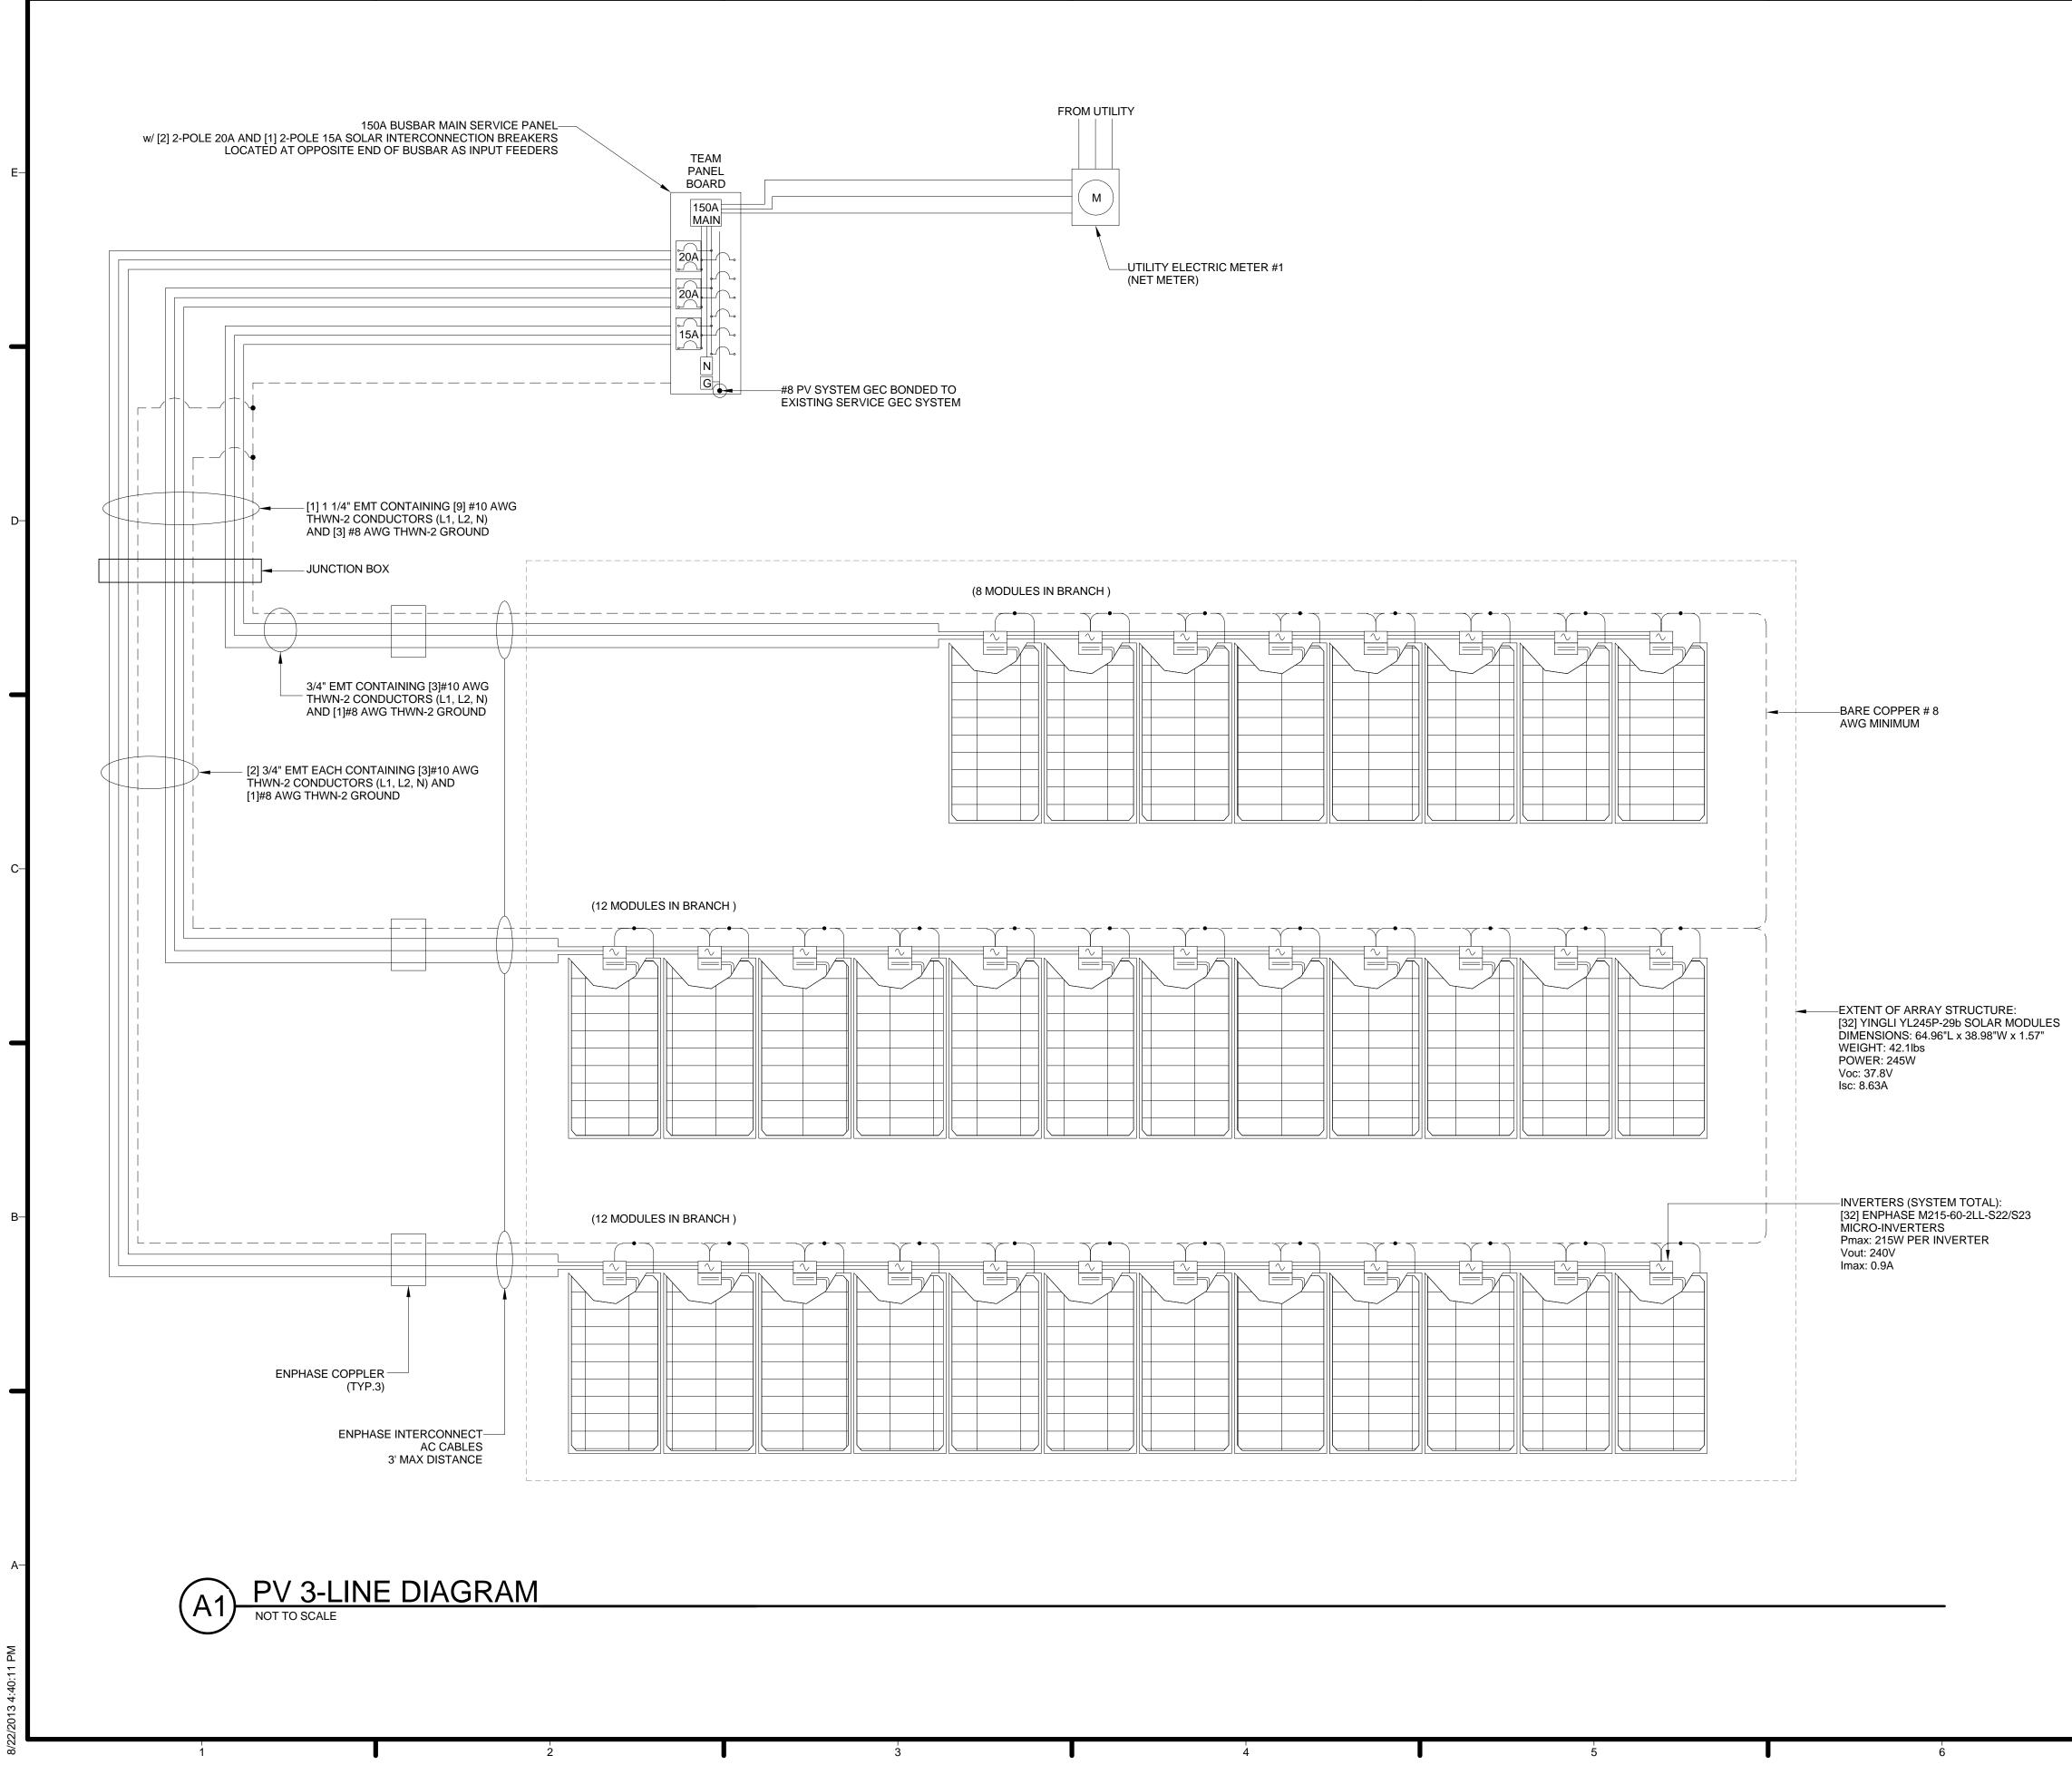
ADDRESS: THE CATHOLIC UNIVERSITY OF AMERICA

Team Capitol dc

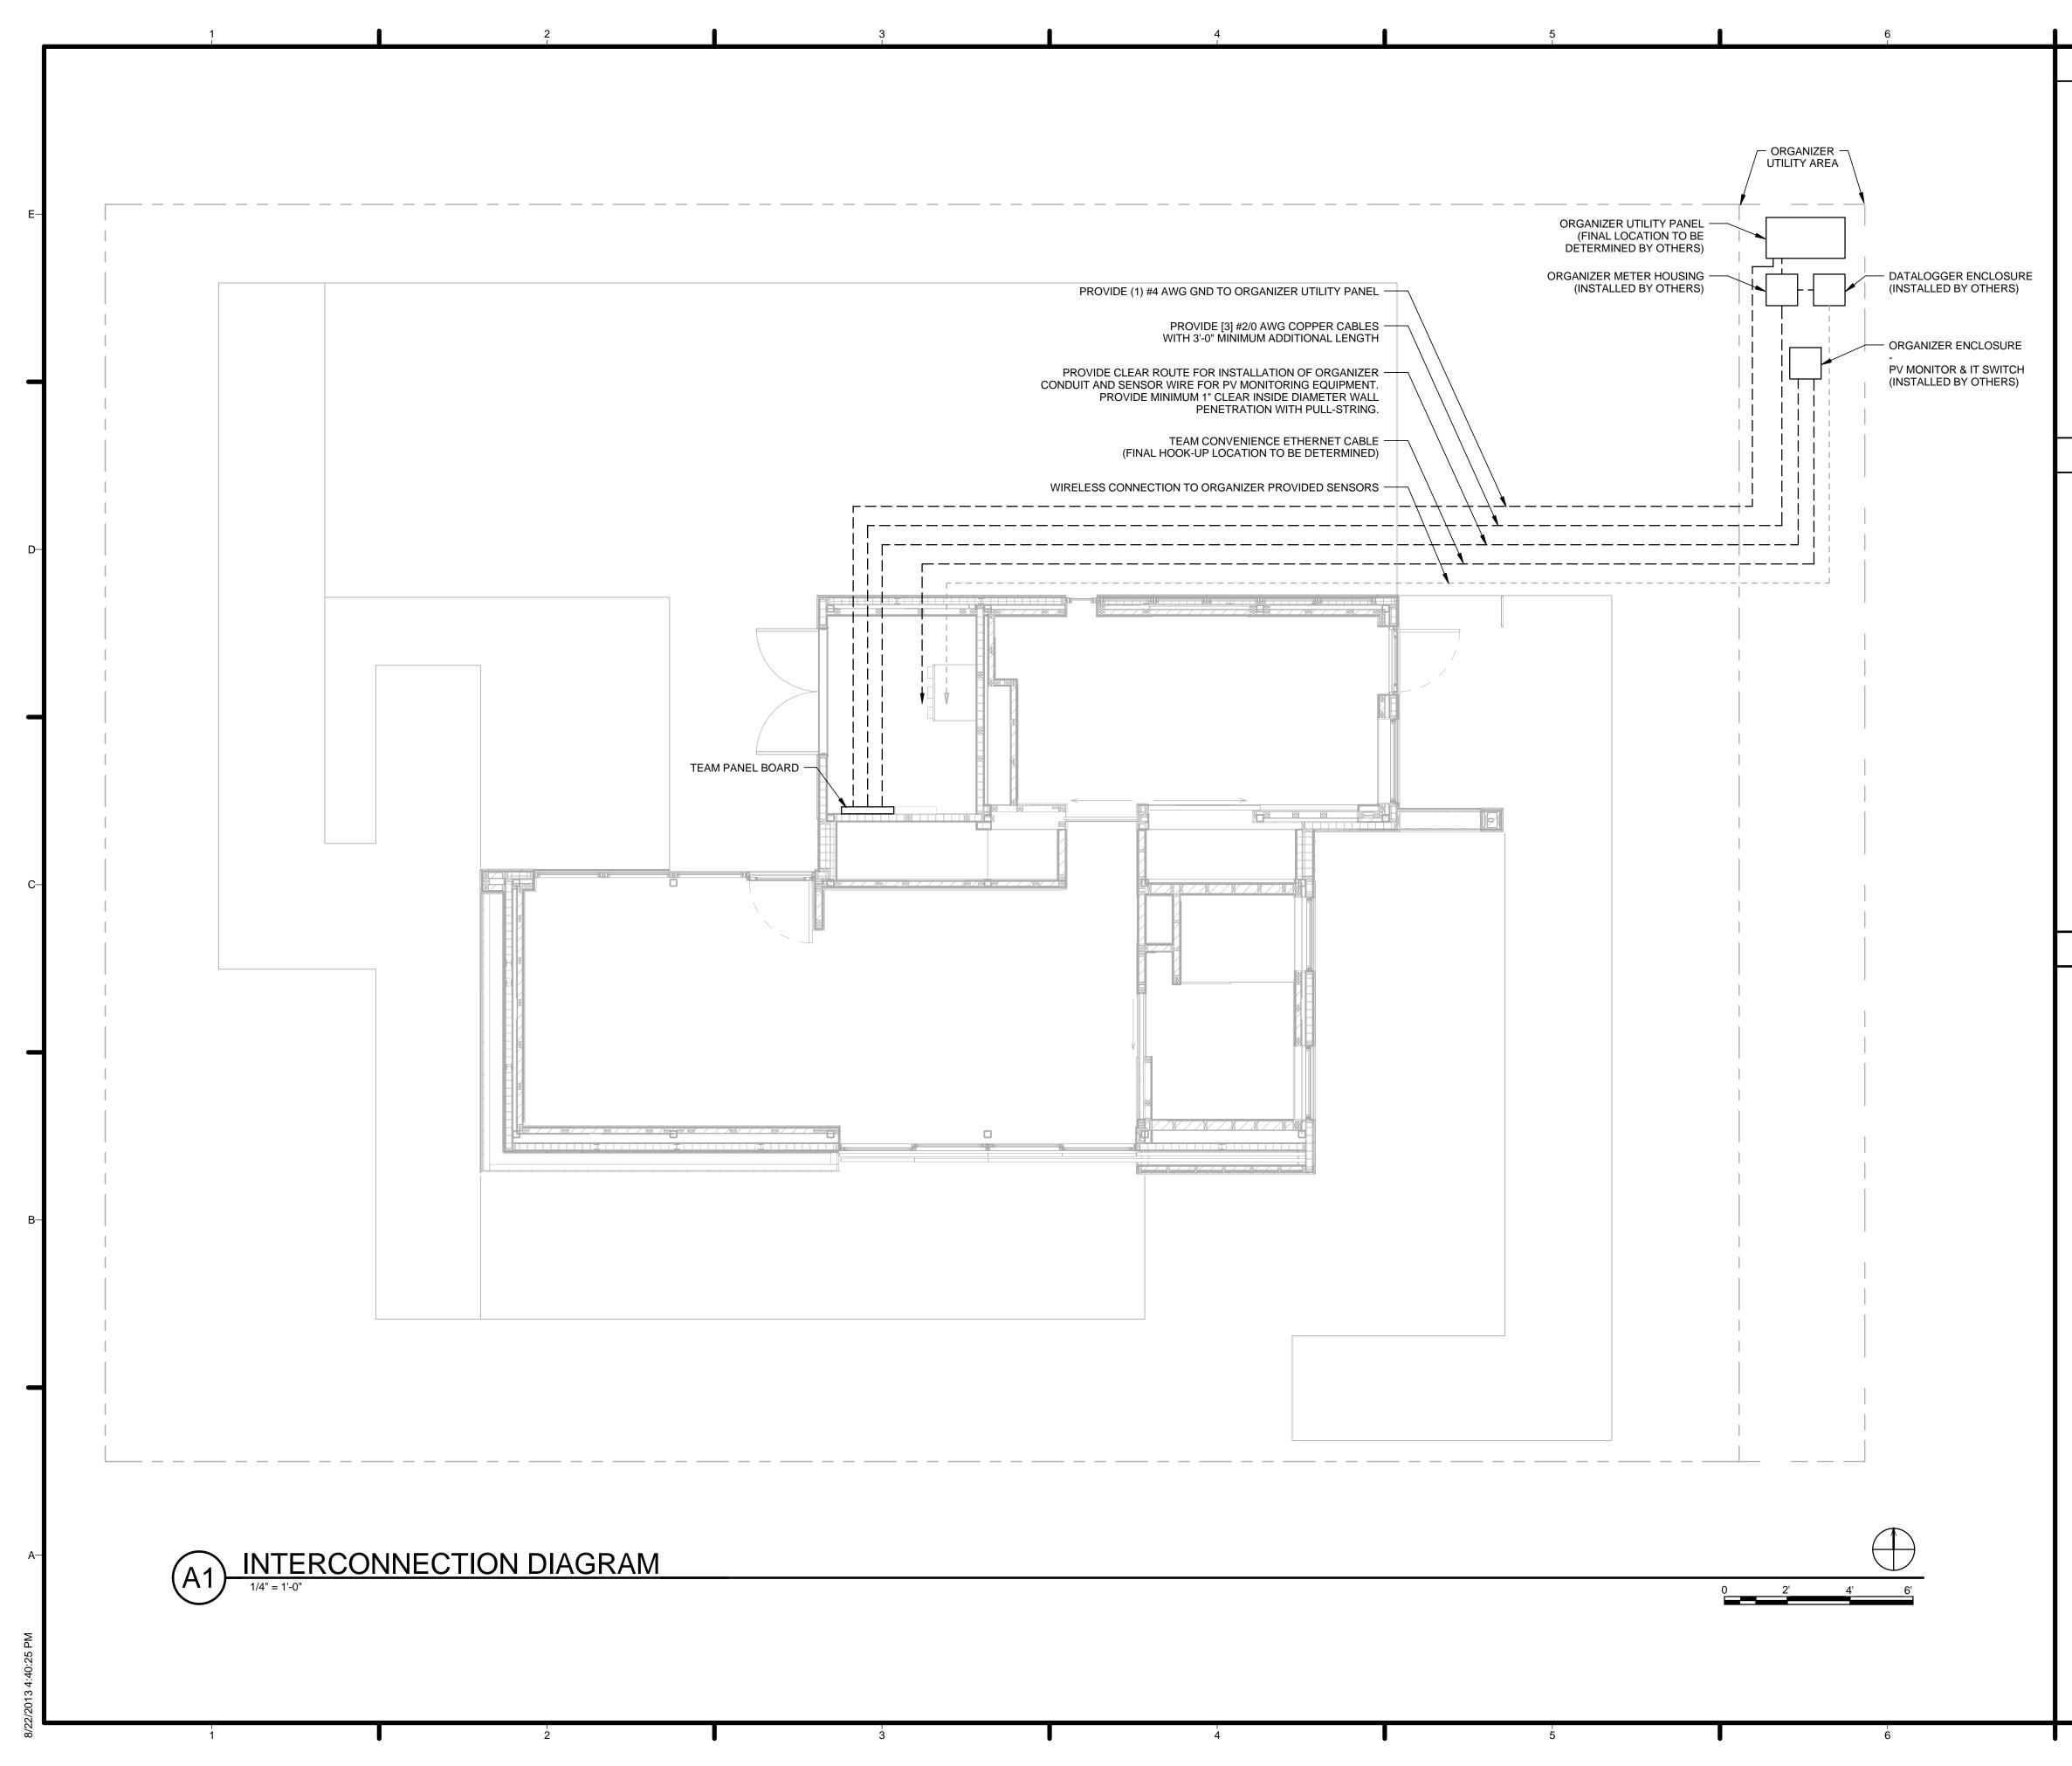
SCHOOL OF ARCHITECTURE 620 MICHIGAN AVENUE, NE. WASHINGTON, DC 20064

TEAM NAME:

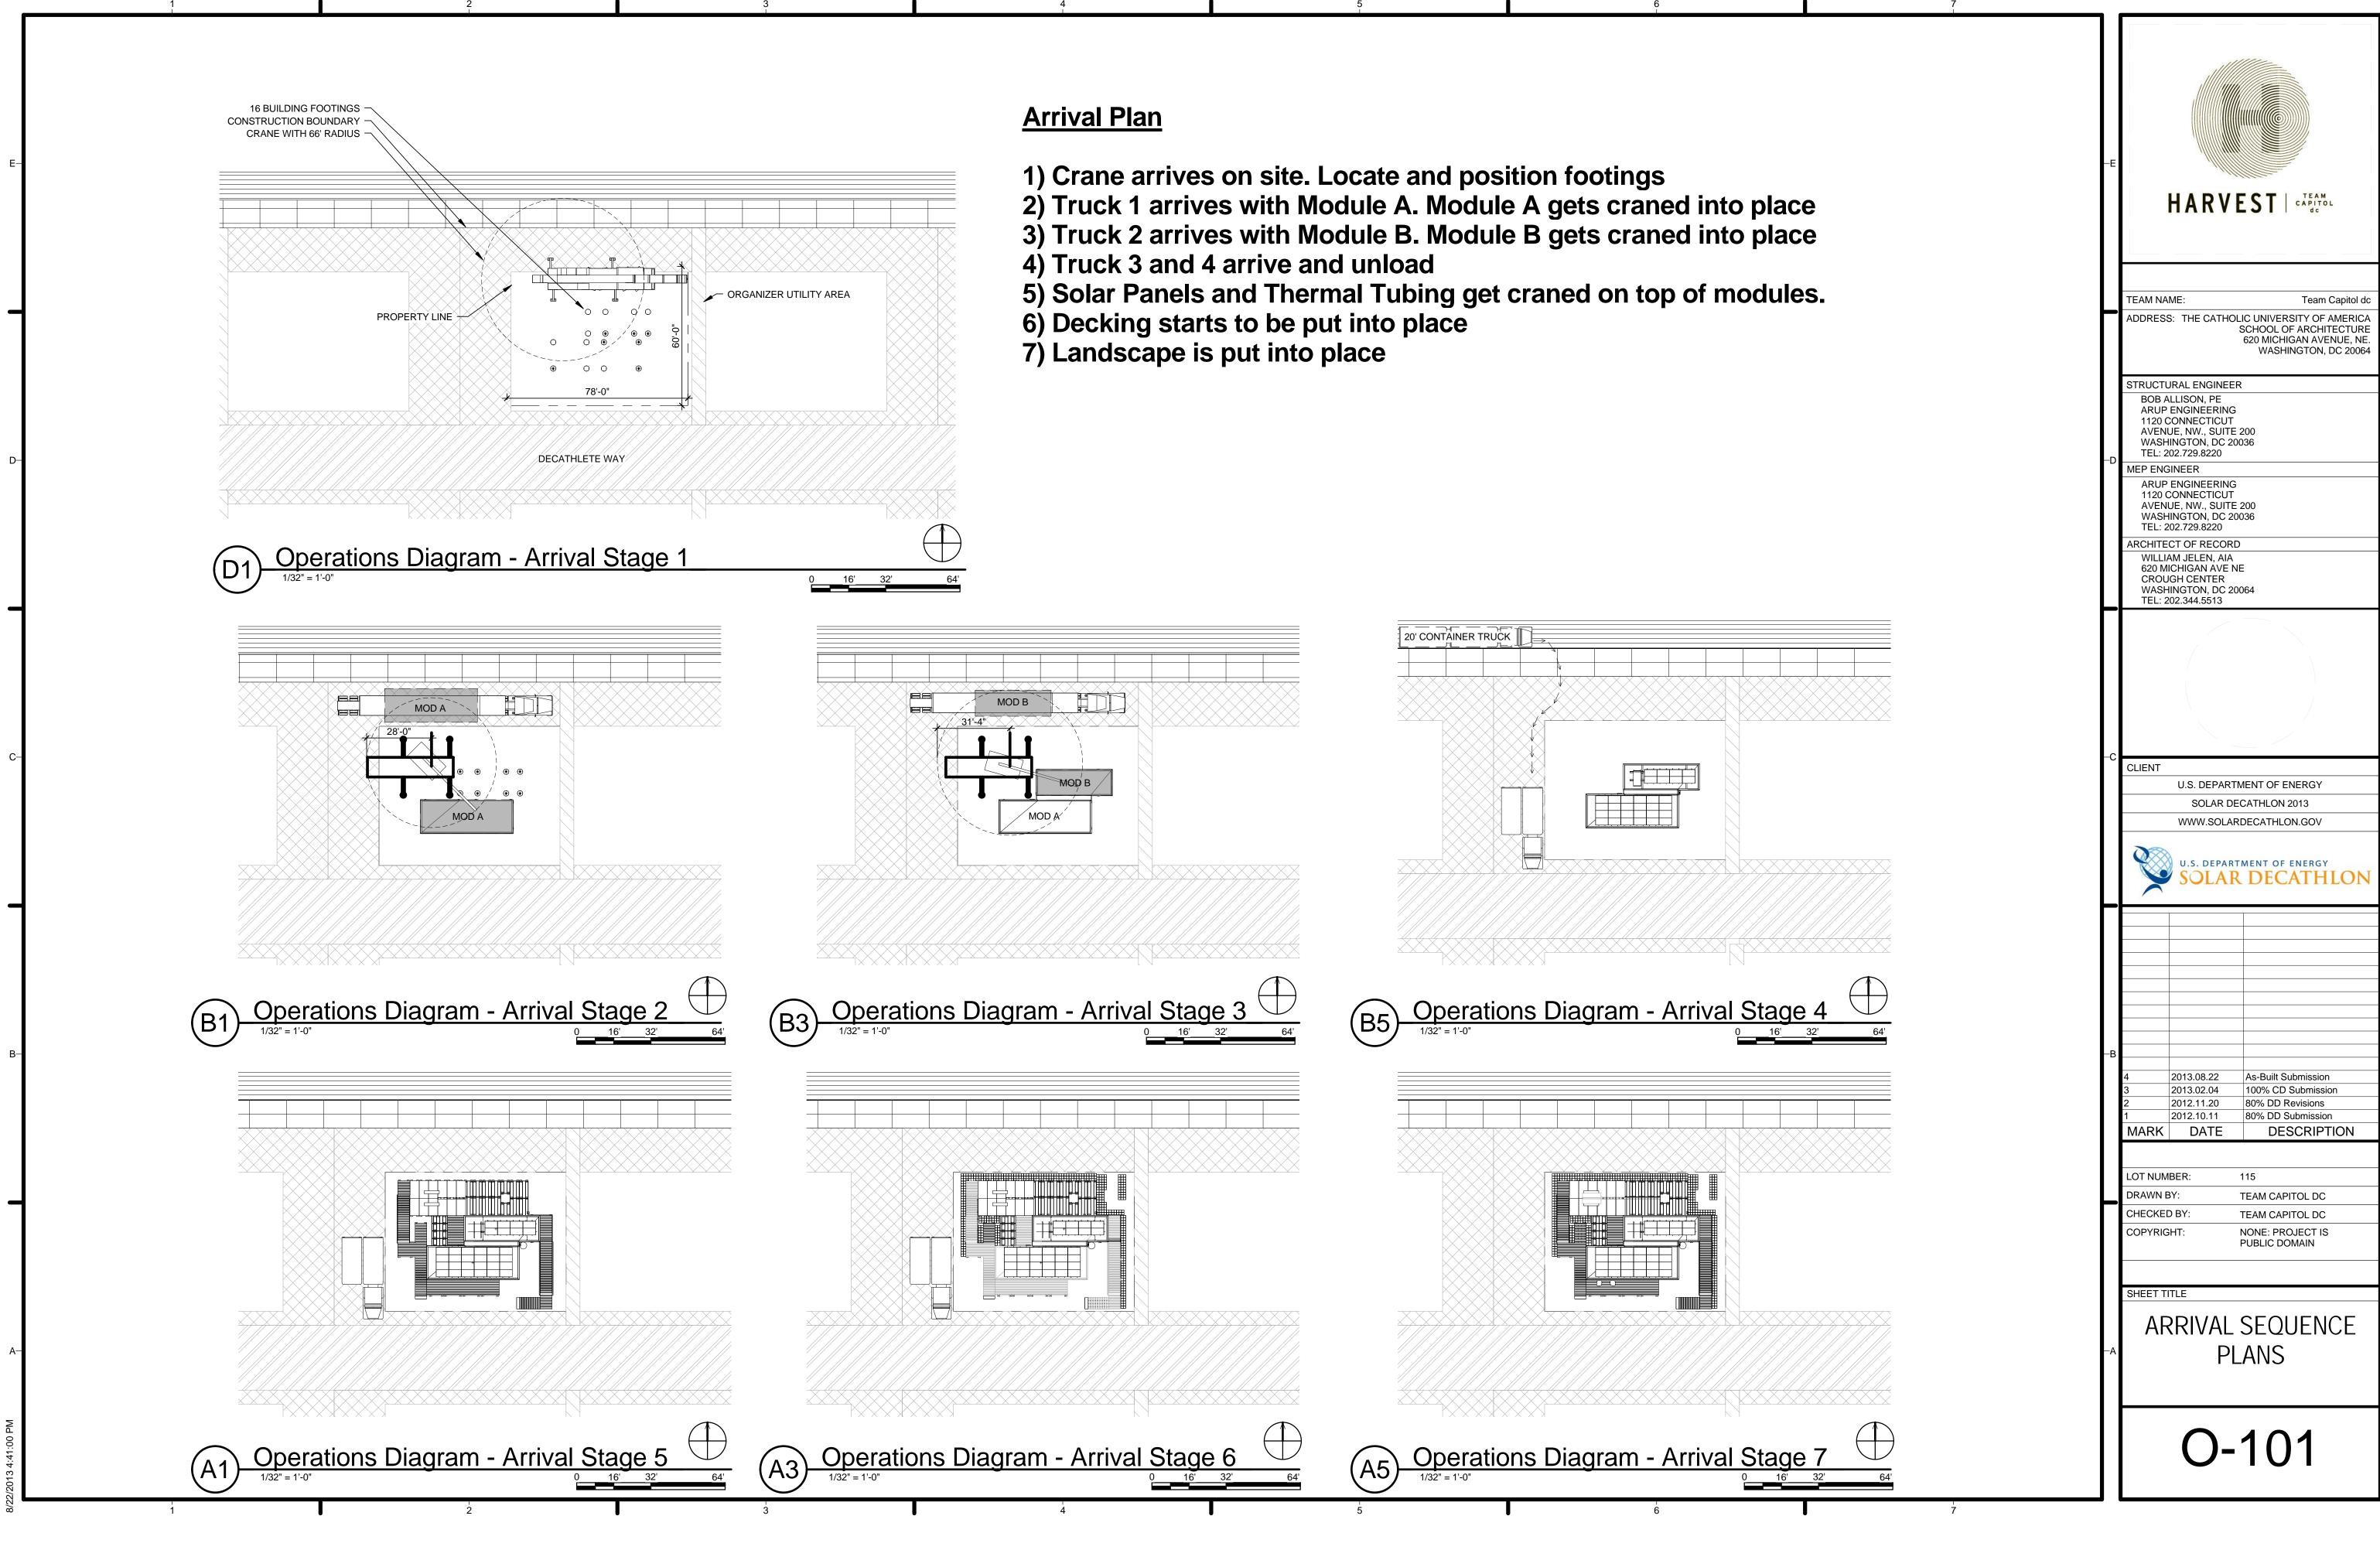
STRUCTURAL ENGINEER BOB ALLISON, PE

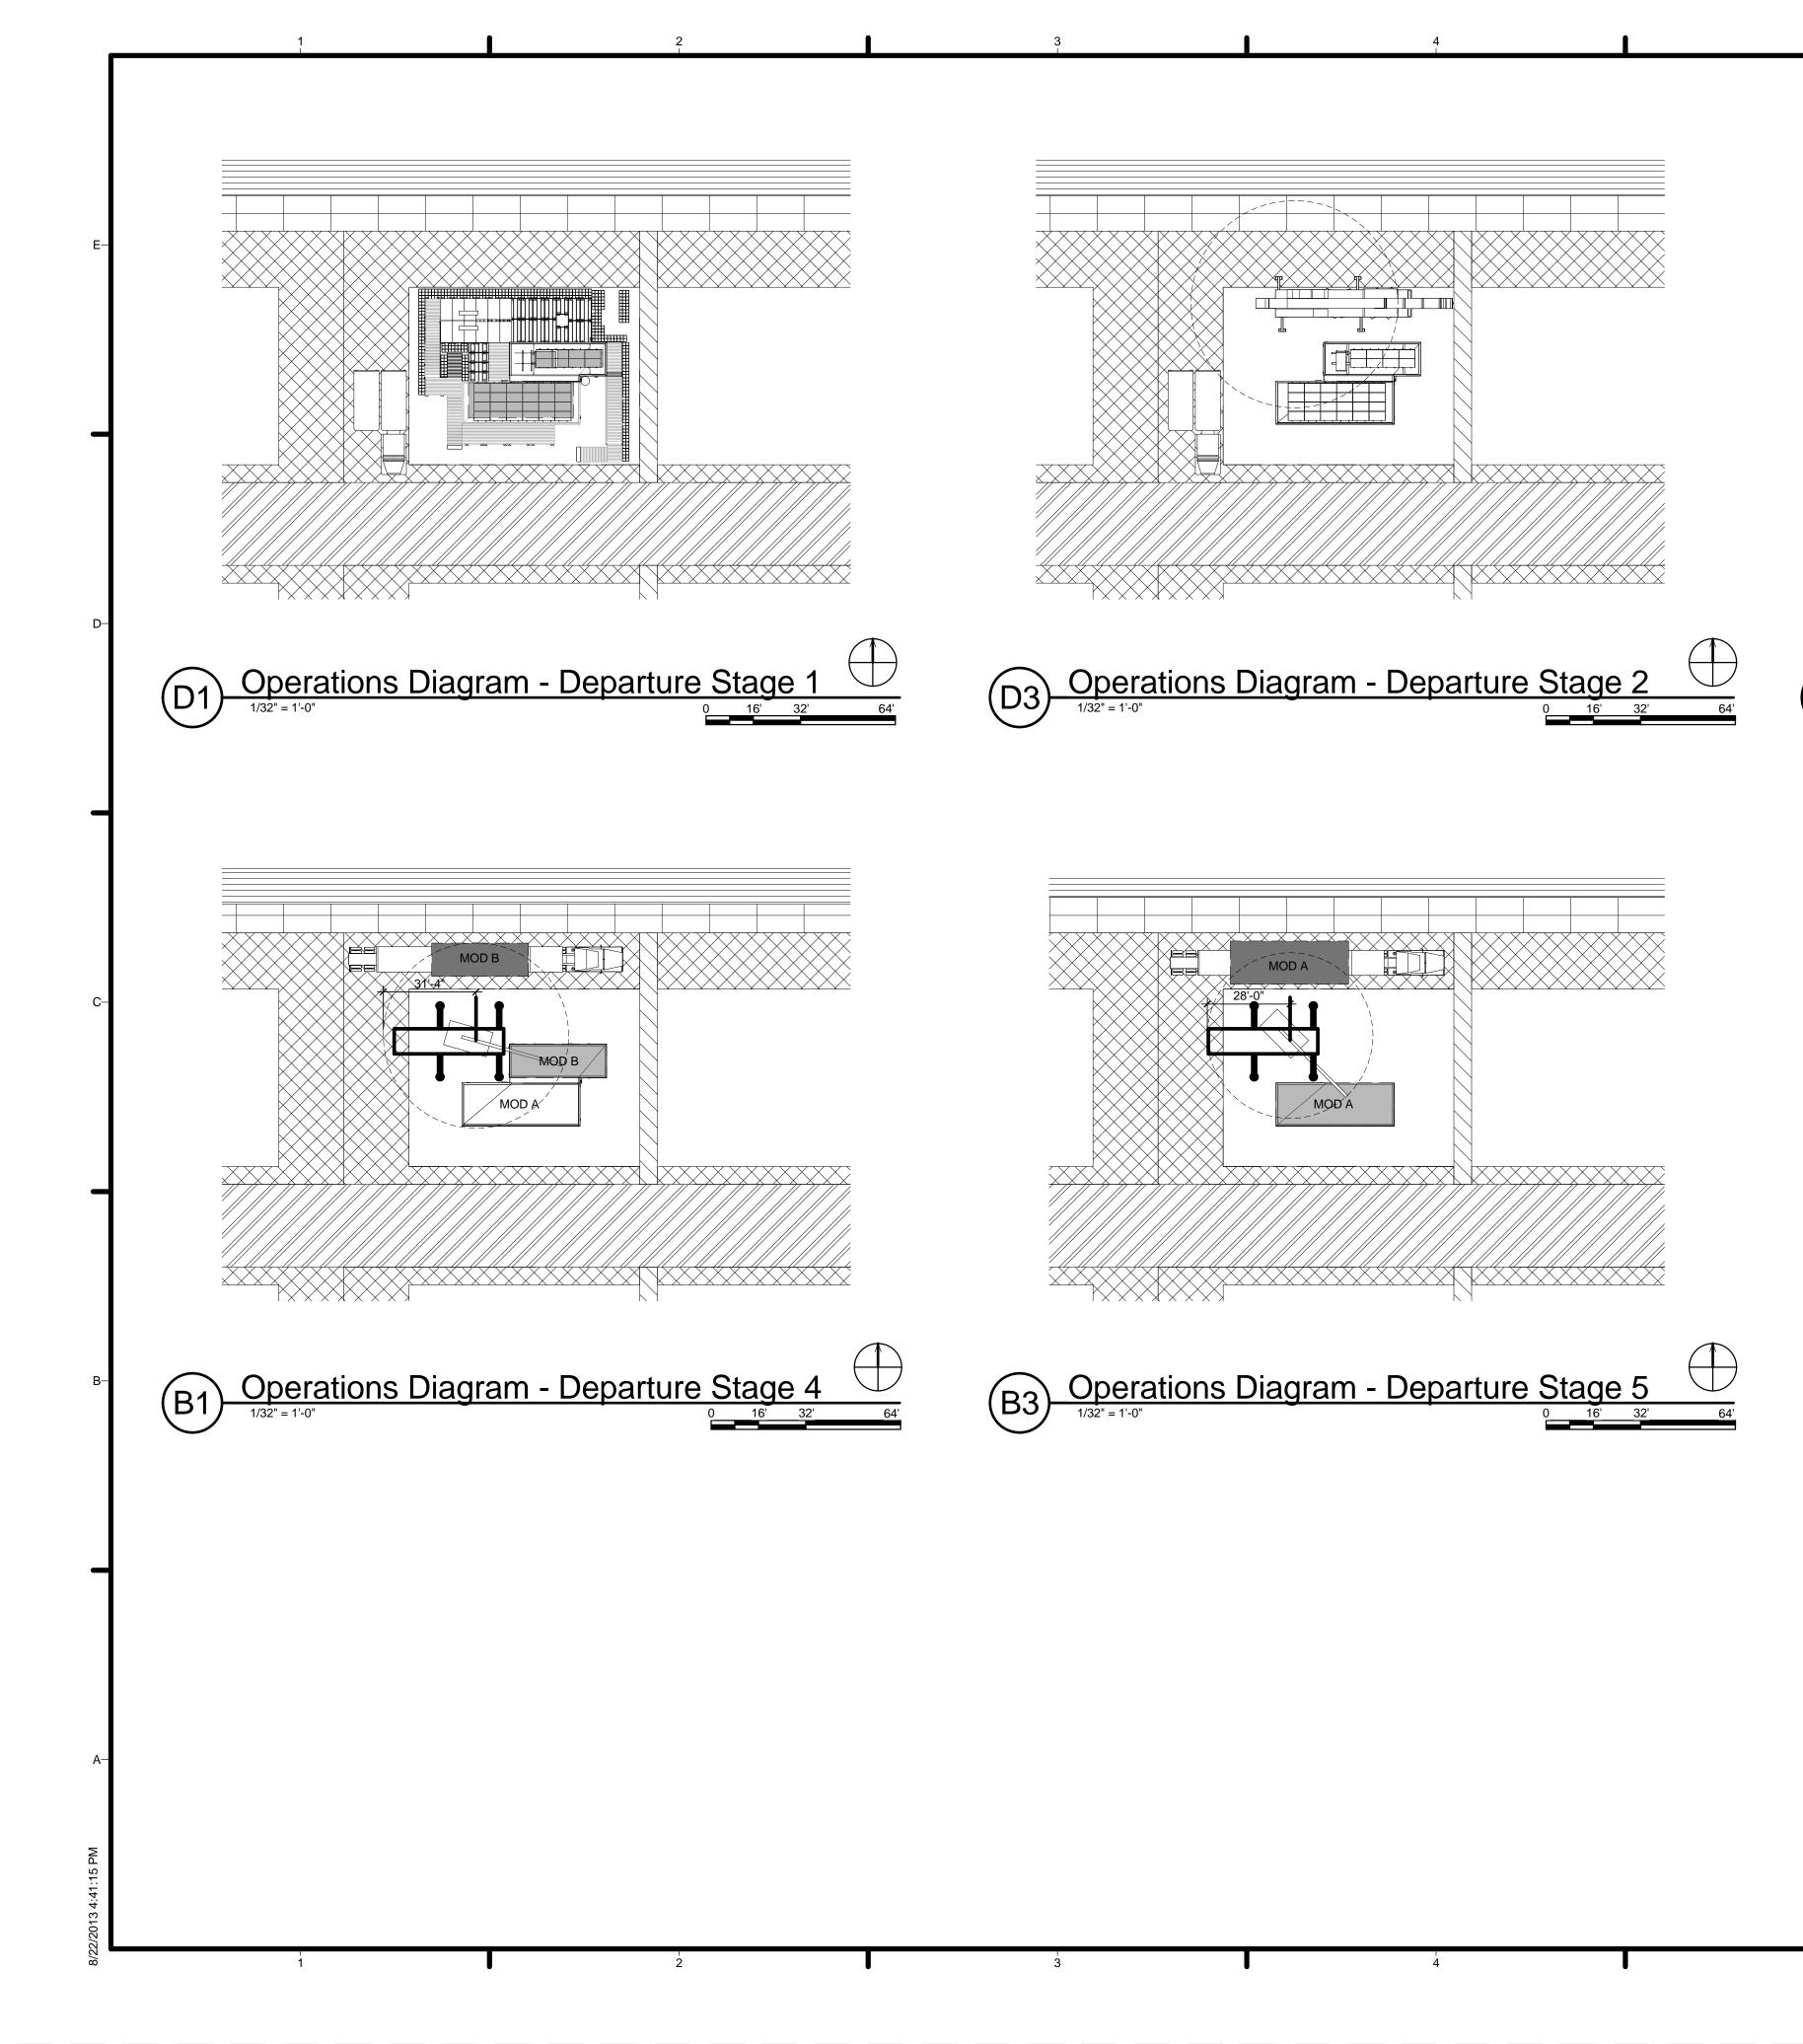


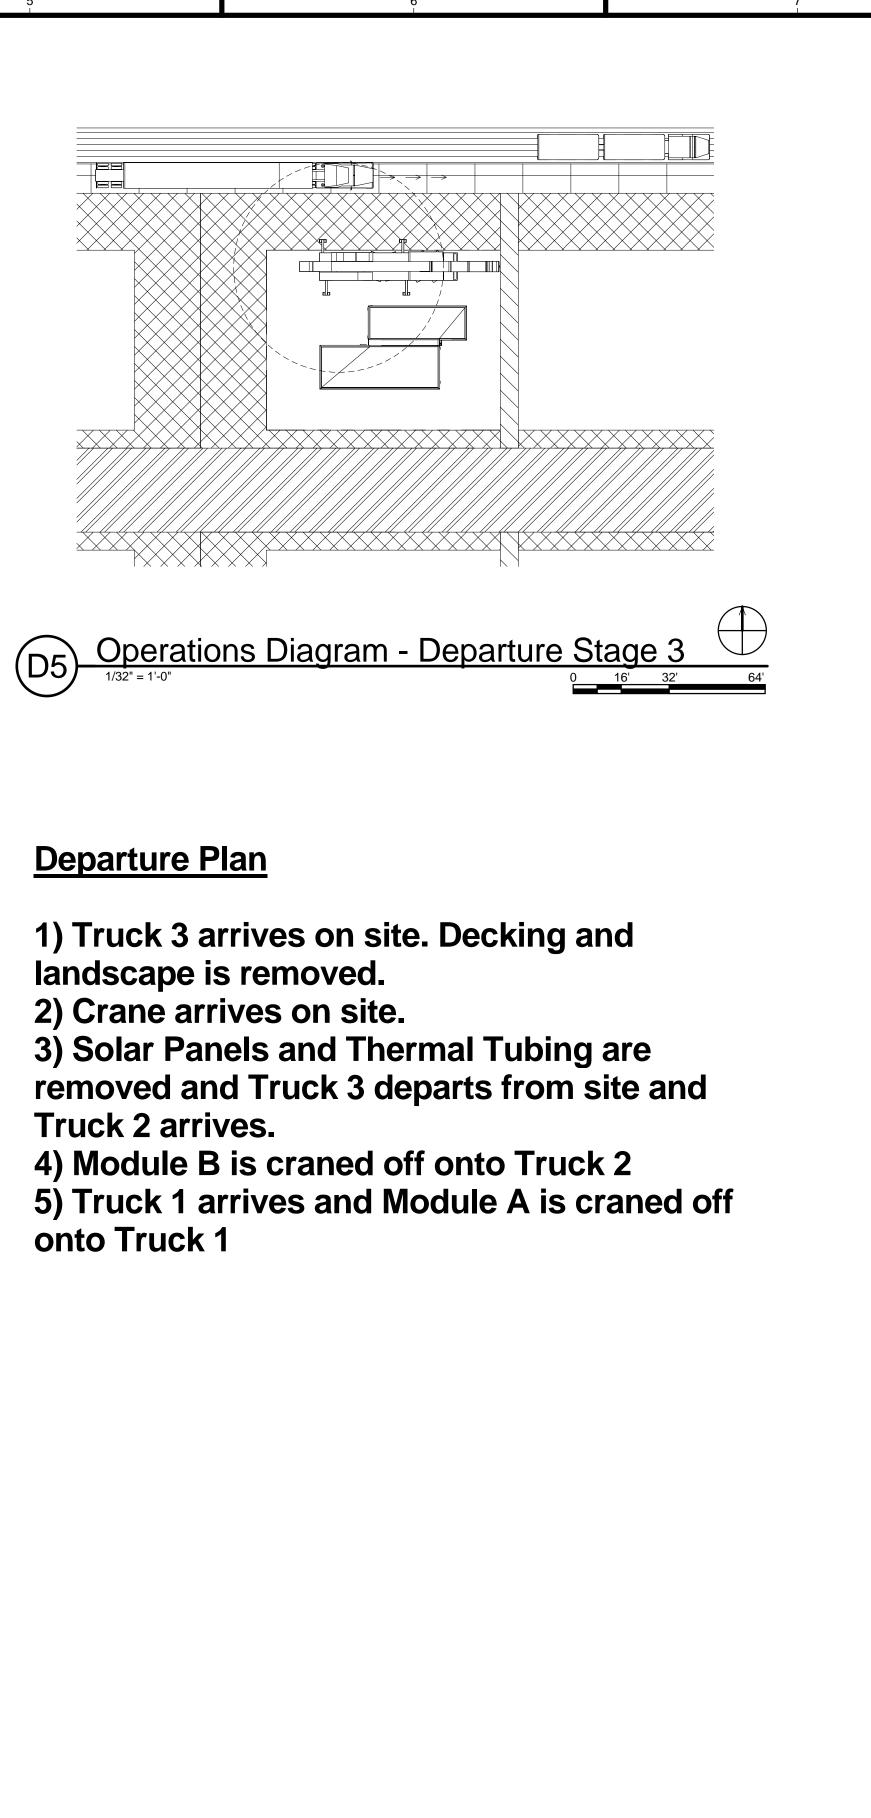
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GENERAL SHEET NOTES	
1. COORDINATE EXACT EQUIPMENT LOCATION WITH ARCHITECT PRIOR TO INSTALATION	-E HARVEST CAPITOL dc
REFERENCE KEYNOTES	TEAM NAME: Team Capitol dc ADDRESS: THE CATHOLIC UNIVERSITY OF AMERICA SCHOOL OF ARCHITECTURE 620 MICHIGAN AVENUE, NE. WASHINGTON, DC 20064 STRUCTURAL ENGINEER BOB ALLISON, PE ARUP ENGINEERING 1120 CONNECTICUT AVENUE, NW., SUITE 200 WASHINGTON, DC 20036 TEL: 202.729.8220
	D MEP ENGINEER ARUP ENGINEERING 1120 CONNECTICUT AVENUE, NW., SUITE 200 WASHINGTON, DC 20036 TEL: 202.729.8220 ARCHITECT OF RECORD WILLIAM JELEN, AIA 620 MICHIGAN AVE NE CROUGH CENTER WASHINGTON, DC 20064 TEL: 202.344.5513
SHEET KEYNOTES	-C CLIENT U.S. DEPARTMENT OF ENERGY SOLAR DECATHLON 2013 WWW.SOLARDECATHLON.GOV
	U.S. DEPARTMENT OF ENERGY SOLAR DECATHLON
	-B 4 2013.08.22 As-Built Submission 3 2013.02.04 100% CD Submission 2 2012.11.20 80% DD Revisions 1 2012.10.11 80% DD Submission MARK DATE DESCRIPTION LOT NUMBER: 115 DRAWN BY: TEAM CAPITOL DC CHECKED BY: TEAM CAPITOL DC COPYRIGHT: NONE: PROJECT IS PUBLIC DOMAIN
	SHEET TITLE PV 3-LINE WIRING DIAGRAM E-602



GENERAL SHEET NOTES				
GENERAL SHEET NUTES				
1. ANY PENETRATIONS THROUGH WALLS AND FLOORS SHALL BE A MINIMUM 1" CLEAR INSIDE				
 DIAMETER PULL-STRINGS SHALL BE PROVIDED TO 				
ENABLE WIRE INSTALLATION WHERE NECESSARY				
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			HARV	EST CAPITOL
		TEAM NA		Team Capitol dc
				DLIC UNIVERSITY OF AMERICA
				SCHOOL OF ARCHITECTURE 620 MICHIGAN AVENUE, NE. WASHINGTON, DC 20064
REFERENCE KEYNOTES				
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		1120 (ENGINEERING	-
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		AVEN	CONNECTICUT UE, NW., SUIT HINGTON, DC 2	E 200
		TEL: 2	202.729.8220	
		WILLI	AM JELEN, AIA	
		WASH	JGH CENTER HINGTON, DC 2 202.344.5513	20064
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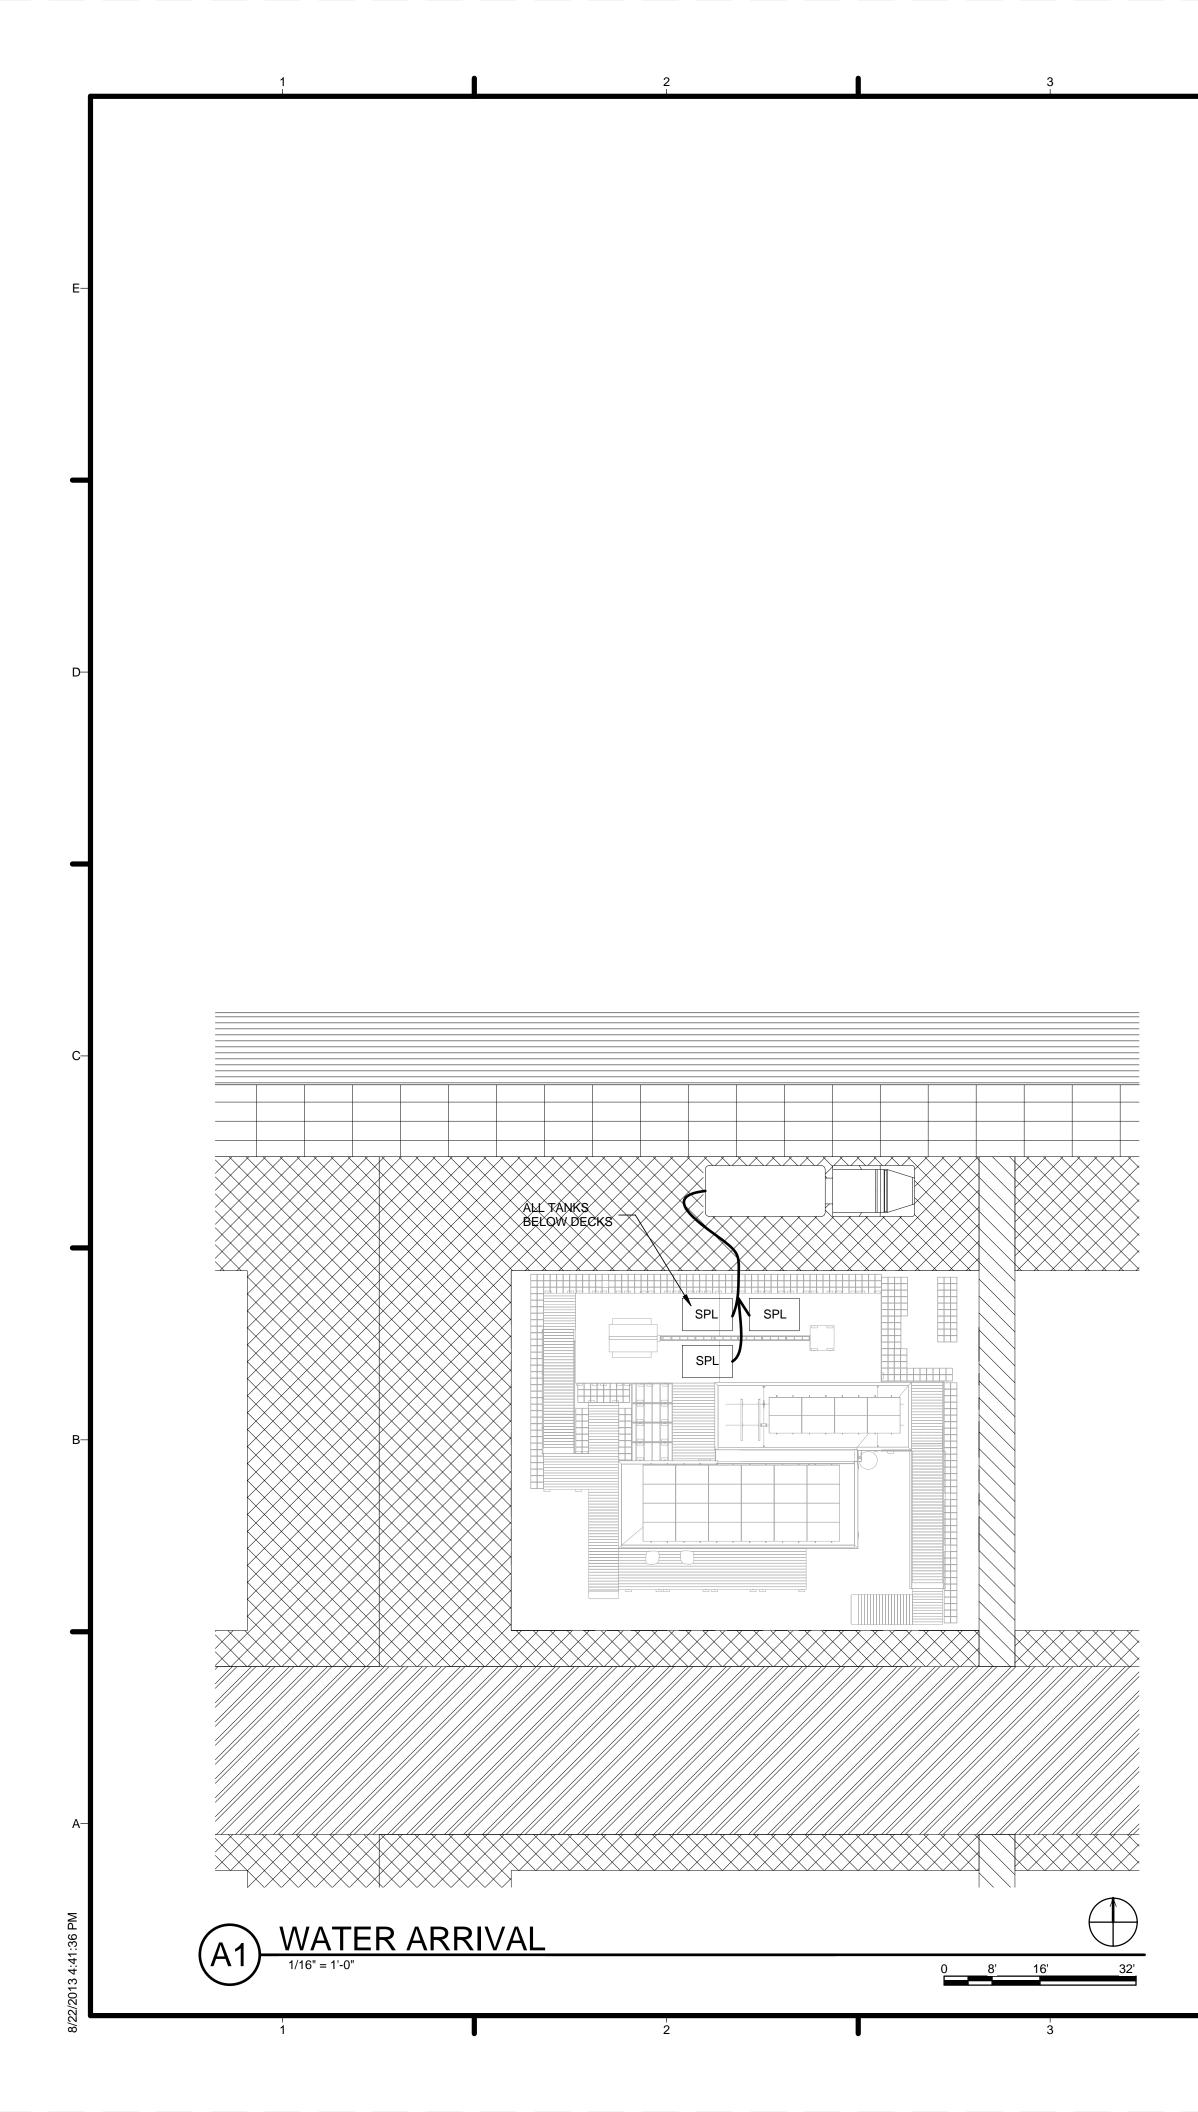
Departure Plan

landscape is removed.

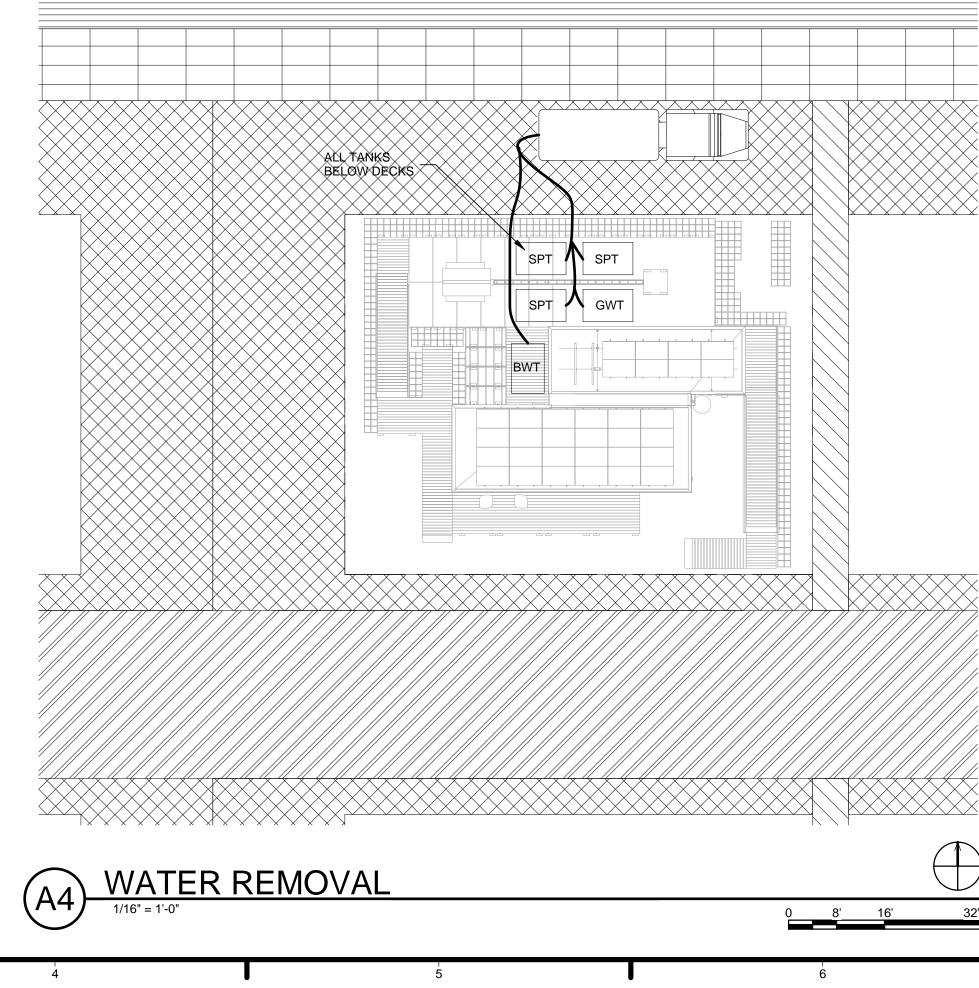
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			WASHINGTON, DC 20064				
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		LLISON, PE					
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B	3 2	U.S. DEPAR SOLAI 2013.08.22 2013.02.04 2012.11.20	As-Built Submission 100% CD Submission 80% DD Revisions				
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ABBREVI	ATIONS
SPL	SUPPLY TANK
GWT	GRAY WATER TANK
BWT	BLACK WATER TANK



	GENERAL SHEET NOTES	–H	TEAM NAME: Team Capitol dc TEAM NAME: Team Capitol dc ADDRESS: THE CATHOLIC UNIVERSITY OF AMERICA SCHOOL OF ARCHITECTURE 620 MICHIGAN AVENUE, NE. WASHINGTON, DC 20064
	REFERENCE KEYNOTES	-D	STRUCTURAL ENGINEER BOB ALLISON, PE ARUP ENGINEERING 1120 CONNECTICUT AVENUE, NW., SUITE 200 WASHINGTON, DC 20036 TEL: 202.729.8220 MEP ENGINEER ARUP ENGINEERING 1120 CONNECTICUT AVENUE, NW., SUITE 200 WASHINGTON, DC 20036 TEL: 202.729.8220 ARCHITECT OF RECORD WILLIAM JELEN, AIA 620 MICHIGAN AVE NE CROUGH CENTER WASHINGTON, DC 20064 TEL: 202.344.5513
	SHEET KEYNOTES	-c	CLIENT U.S. DEPARTMENT OF ENERGY SOLAR DECATHLON 2013 WWW.SOLARDECATHLON.GOV
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